THE FOLLOWING MARYLAND STANDARD (CONSTRUCTION AND TEMPORARY TRAFFIC

MD 104.06-15-19 - PAVEMENT EDGE DROP-OFF MD 104.06-25 - MEDIAN WORK ALL SPEEDS MD 374.51 - PRECAST OR CAST IN PLACE SQUARE AND RECTANGULAR COG INLETS 5', 10', 15', & 20' MD 374.61 - PRECAST OR CAST IN PLACE SQUARE AND

FOR FLEXIBLE PAVEMENT

RECTANGULAR COS INLETS 5', 10', 15', & 20 MD 381.02 - PRECAST YARD INLET MD 384.01 - 48" DIAMETER PRECAST MANHOLE FOR 12" TO 24" PIPES MD 384.03 - 60" DIAMETER PRECAST MANHOLE FOR 27" TO 36" PIPES MD 384.05 - 72" DIAMETER PRECAST MANHOLE FOR 42" & 48" PIPES MD 384.07 - 84" DIAMETER PRECAST MANHOLE FOR 54" & 60" PIPES MD 384.09 - 96" DIAMETER PRECAST MANHOLE FOR 72" PIPES MD 384.11 - 120" DIAMETER PRECAST MANHOLE FOR 78" & 84" PIPES MD 387.11A - LONGITUDIINAL UNDERDRAIN LOCATED AT CURB & GUTTER

MD 620.02-01 - STANDARD TYPES C AND D CONCRETE CURB AND COMBINATION CONCRETE CURB & GUTTER MD 630.02 - STANDARD ENTRANCE CONSTRUCTION RESIDENTIAL AND COMMERCIAL, METHOD NO. 2 MD 645.02 - STANDARD MONOLITHIC CONCRETE MEDIAN TYPE 'B' MD 655.11 - SIDEWALK RAMPS PERPENDICULAR MD 655.12 - SIDEWALK RAMPS PARALLEL MD 655.13 - SIDEWALK RAMPS COMBINATION

MD 655.21 - CUT-THROUGH MEDIAN AND ISLAND OPENINGS MD 655.40 - DETECTABLE WARNING SURFACES

FOR ALL STANDARDS REFERRED TO ON THE PLANS, THE CONTRACTOR MUST GO TO THE BOOK OF STANDARDS WHICH WILL HAVE THE MOST CURRENT VERSION. THE BOOK OF STANDARDS CAN BE ACCESSED AT: http://apps.roads.maryland.gov/businuesswithsha/ bizStdsSpecs/desManualStdPub/publicationsonline/ohd/bookstd/index.asp. ALL ITEMS ARE TO BE CONSTRUCTED IN ACCORDANCE WITH THE CURRENT VERSION OF THE REFERENCED STANDARD AT THE TIME OF CONSTRUCTION.

### OWNER'S CERTIFICATION

I HEREBY CERTIFY THAT ALL CLEARING, GRADING, CONSTRUCTION AND/OR DEVELOPMENT WILL BE DONE PURSUANT TO THIS PLAN AND THAT ANY RESPONSIBLE PERSONNEL INVOLVED IN THE CONSTRUCTION PROJECT WILL HAVE A CERTIFICATE OF ATTENDANCE AT A DEPARTMENT OF NATURAL RESOURCES APPROVED TRAINING PROGRAM FOR THE CONTROL OF SEDIMENT AND EROSION BEFORE BEGINNING THE PROJECT.

DATE

TIMOTHY H. CUPPLES, P.E. CHIEF, DIVISION OF TRANSPORTATION ENGINEERING

### DESIGN CERTIFICATION

I HEREBY CERTIFY THAT THIS PLAN HAS BEEN PREPARED IN ACCORDANCE WITH THE "2011 MARYLAND STANDARDS AND SPECIFICATIONS FOR SOIL EROSION AND SEDIMENT CONTROL", MONTGOMERY COUNTY DEPARTMENT OF PERMITTING SERVICES EXECUTIVE REGULATIONS 5-90, 7-02AM AND 36-90, AND MONTGOMERY COUNTY DEPARTMENT OF TRANSPORTATION "STORM DRAIN DESIGN CRITERIA" DATED AUGUST 1988.

I FURTHER CERTIFY THAT THE ESTIMATED TOTAL AMOUNTS OF EXCAVATION AND FILL AS SHOWN ON THESE PLANS HAS BEEN COMPUTED TO BE XXX,XXX CUBIC YARDS OF EXCAVATION AND XXX,XXX CUBIC YARDS OF FILL AND THAT THE TOTAL AREA TO BE DISTURBED AS SHOWN ON THESE PLANS HAS BEEN DETERMINED TO BE XXX,XXX SQUARE FEET.

XX/XX/XXXX

XXXX XXXX, P.E. MD. REGISTRATION NO. XXXXX




PROFESSIONAL CERTIFICATION:

35% SUBMITTAL DECEMBER 2022

# MONTGOMERY COUNTY, MARYLAND DEPARTMENT OF TRANSPORTATION MD 355 BUS RAPID TRANSIT (BRT) C. I. P. PROJECT NO. 502005

SHA TRACKING NO. XX-XX-XXX-XXX

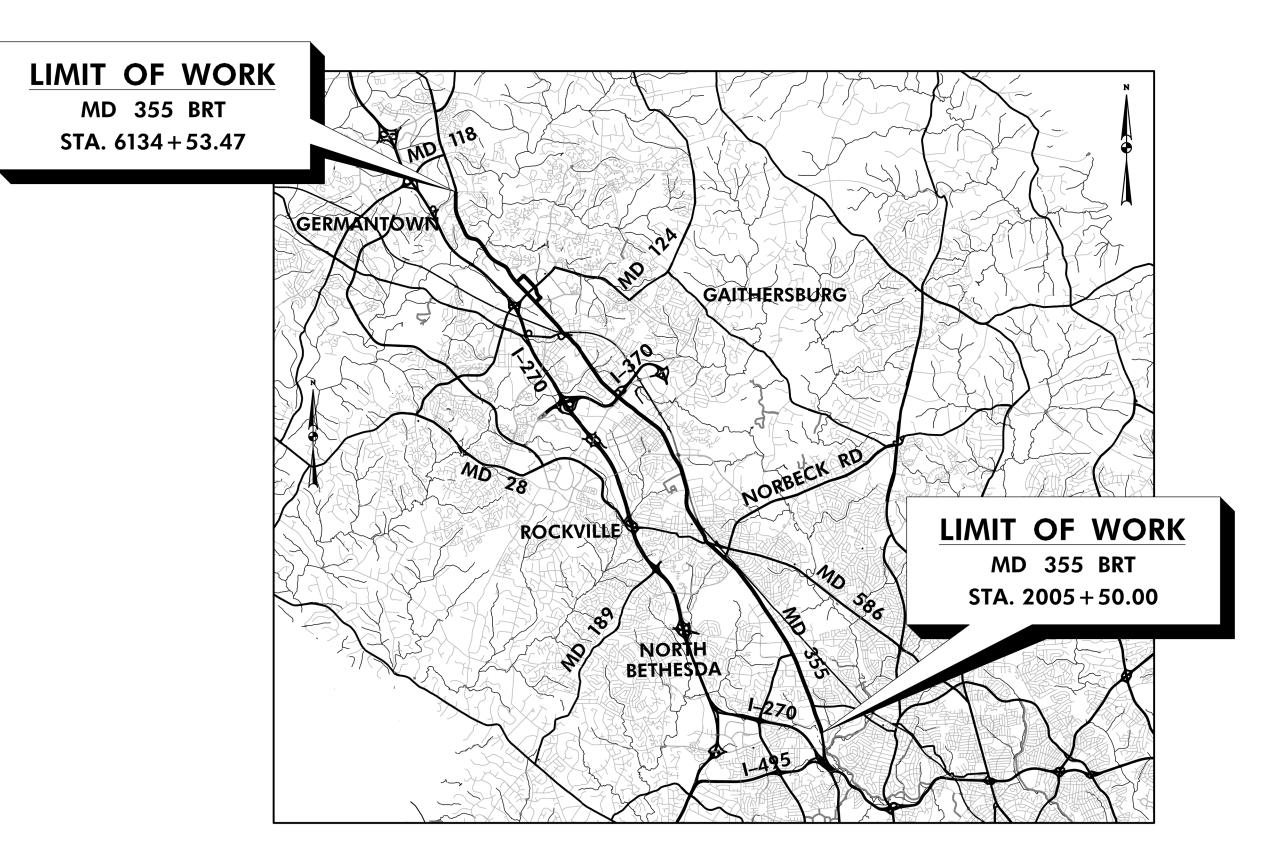

VICINITY MAP SCALE: 1'' = 1000'

ALL AREAS OF SHA PROPERTY AND PROPERTY TO BE DEDICATED TO SHA SHALL BE RESTORED IN CONFORMANCE WITH SHA STANDARD SPECIFICATIONS, EXCEPT AS NECESSARY FOR WORK FOR WHICH THERE ARE NO SHA STANDARD SPECIFICATIONS.

PRIOR TO VEGETATIVE STABILIZATION, ALL DISTURBED AREAS MUST BE TOPSOILED PER THE MONTGOMERY COUNTY "STANDARDS AND SPECIFICATIONS FOR TOPSOIL".

I HEREBY CERTIFY THAT THESE DOCUMENTS WERE PREPARED OR APPROVED BY ME, AND THAT I AM A DULY LICENSED PROFESSIONAL ENGINEER UNDER THE LAWS OF THE STATE OF MARYLAND. LICENSE NO: XXXXX EXPIRATION DATE: XX-XX-XXXX

RECOMMENDED FOR APPROVAL REVISION DATE Chief, Design Section APPROVED Chief, Division of Transportation Engineering Designed by :\_\_\_\_\_

IT IS THE RESPONSIBILTY OF PERMITTEE/OWNER OF THIS SITE TO OBTAIN ALL REQUIRED PERMITS PRIOR TO ISSUANCE OF THE APPROVED SEDIMENT CONTROL PERMIT PERMIT # XPIRATION WORK
DATE RESTRICTION DATES Floodplain District WATERWAYS/WETLAND(S) Corps of Engineers MDE MDE Dom Safety \* DPS Roadside Trees REGISTRATION N XXXXXXX FEMA LOMR (Required Post Construction OTHERS: DPS Erosion XXXXXX MNCPPC Park Permit XXXXX \* A copy of the Roadside Trees Protection Plan must be delivered to the sediment control inspector at the preconstruction meeting

RELATED REQUIRED PERMITS

### OWNER/PERMIT APPLICANT INFORMATION

MONTGOMERY COUNTY DEPARTMENT OF TRANSPORTATION 100 EDISON PARK DRIVE, GAITHERSBURG, MD 20878 PHONE NUMBER: (240) 777-7209

applicable exemption category below this table.

Fee in Lieu (Trees Required - Trees Proposed) x \$250

CONTACT PERSON: TIMOTHY H. CUPPLES, P.E.

TREE CANOPY REQUIREMENTS TABLE To be completed by the consultant and placed on the first sheet of the Sediment Control/Stormwater Management plan set for all projects

Exempt: Yes ■ No ■ If exempt under Section 55-5 of the Code, please list the

Project is subject to Chapter 22A—9 of the Mont. Co. Forest Conservation Law

Total Property Area Total Disturbed Area XX,XXX

Shade Trees Required Shade Trees Proposed to be Planted XX

Total Fee in Lieu

\$ \_\_\_\_\$X,XXX

of Disturbance Trees Required 6,000 8,001 12,000 12,001 14,000 14.001 40.000

If the square footage of the limits of disturbance is more than 40,000, then the number of shade trees required must be calculated using the following formula: (Number of Square Feet in Limits of Disturbance / 40.000) x 15

\*Please list the square footage of each proposed planting area on the first

**EXEMPTION CATEGORIES:** 

55-5(a) any activity that is subject at Article II of Chapter 22A; 55-5(b) any commercial logging or timber harvesting operation

with an approved exemption from Article II of Chapter 22A;

55-5(f) any activity conducted by the County Parks Department: 55-5(a) routine emergency matinenance of an existing stormwater management facility, including an existing access road, if the person performing the maintenance has obtained all required permits;

] 55-5(h) any stream restoration project if the person performing the work has obtained all necessary permits;

] 55-5(i) cutting or clearing any tree to comply with applicable provisions

of any federal, state, or local law governing safety of dams;

OTHER: Specify per Seciton 55-5 of the Code.

APPROVALS:		
TRAFFIC CONTROL PLANS	SIGNATURE	
	SIGIVITORE	DATE
LIGHTING PLANS	SIGNATURE	
SIGNING & PAVEMENT  MARKING PLANS	SIGNATURE	DATE
TRAFFIC SIGNAL PLANS	SIGNATURE	DATE

TI-01

MONTGOMERY COUNTY DEPARTMENT OF TRANSPORTATION MD 355 BUS RAPID TRANSIT (BRT)

TITLE SHEET

SCALE: N.T.S.

DIVISION OF TRANSPORTATION ENGINEERING

GAITHERSBURG, MARYLAND

Drawn by :\_\_\_\_

Checked by :

DATE: DECEMBER 2022 Project No. :502005 SHEET 01 of 887

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I--01



PROFESSIONAL CERTIFICATION:
I HEREBY CERTIFY THAT THESE DOCUMENTS WERE PREPARED
OR APPROVED BY ME, AND THAT I AM A DULY LICENSED
PROFESSIONAL ENGINEER UNDER THE LAWS OF THE STATE
OF MARYLAND.
LICENSE NO: \_\_\_\_\_ EXPIRATION DATE: \_\_\_\_\_

				GAITHERSBURG, MARYLAND	)
NO.	REVISION	DATE	ВҮ	RECOMMENDED FOR APPROVAL  SEE TITLE SHEET FOR SIGNATURES Chief, Design Section	Date
				SEE TITLE SHEET FOR SIGNATURES Chief, Division of Transportation Engineering	Date
				Designed by : Drawn by :	Checked by :

MONTGOMERY COUNTY DEPARTMENT OF TRANSPORTATION DIVISION OF TRANSPORTATION ENGINEERING

MD 355 BUS RAPID TRANSIT (BRT)

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REVISION

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268	PR-419	ROADWAY PROFILE
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		ROADWAY PROFILE
271	PR-501	+
272	PR-502	ROADWAY PROFILE
273	PR-503	ROADWAY PROFILE
274	PR-601	ROADWAY PROFILE
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Stantec 6110 FROST PLACE, LAUREL, MARYLAND 20707 (301) 982-2800 www.stantec.com

PROFESSIONAL CERTIFICATION:
I HEREBY CERTIFY THAT THESE DOCUMENTS WERE PREPARED
OR APPROVED BY ME, AND THAT I AM A DULY LICENSED PROFESSIONAL ENGINEER UNDER THE LAWS OF THE STATE OF MARYLAND. LICENSE NO: \_\_\_\_\_ EXPIRATION DATE: \_\_

DIVISION OF TRANSPORTATION ENGINEERING GAITHERSBURG, MARYLAND RECOMMENDED FOR APPROVAL SEE TITLE SHEET FOR SIGNATURES
Chief, Design Section APPROVED SEE TITLE SHEET FOR SIGNATURES
Chief, Division of Transportation Engineering

Checked by :  $\_$ 

Designed by :\_\_\_\_\_ Drawn by :\_\_\_\_

MONTGOMERY COUNTY DEPARTMENT OF TRANSPORTATION

MD 355 BUS RAPID TRANSIT (BRT)

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SCALE: N.T.S. DATE: DECEMBER 2022

Project No. : 502005

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SHEET NO.	DWG. NO.	DESCRIPTION
301	SW-12	STORMWATER MANAGEMENT PLAN-2
302	SW-13	STORMWATER MANAGEMENT PLAN-2
303	SW-14	STORMWATER MANAGEMENT PLAN-2
304	SW-15	STORMWATER MANAGEMENT PLAN-2
305	SW-16	STORMWATER MANAGEMENT PLAN-2
306	SW-17	STORMWATER MANAGEMENT PLAN-2
307	SW-18	STORMWATER MANAGEMENT PLAN-2
308	SW-19	STORMWATER MANAGEMENT PLAN-2
309	SW-20	STORMWATER MANAGEMENT PLAN-2
310	SW-21	STORMWATER MANAGEMENT PLAN-2
311	SW-22	STORMWATER MANAGEMENT PLAN-2
312	SW-23	STORMWATER MANAGEMENT PLAN-2
313	SW-24	STORMWATER MANAGEMENT PLAN-2
314	SW-25	STORMWATER MANAGEMENT PLAN-2
315	SW-26	STORMWATER MANAGEMENT PLAN-2
316	SW-27	STORMWATER MANAGEMENT PLAN-2
317	SW-28	STORMWATER MANAGEMENT PLAN-2
318	SW-29	STORMWATER MANAGEMENT PLAN-2
319	SW-30	STORMWATER MANAGEMENT PLAN-2
320	SW-31	STORMWATER MANAGEMENT PLAN-2
321	SW-32	STORMWATER MANAGEMENT PLAN-2
322	SW-33	STORMWATER MANAGEMENT PLAN-2
323	SW-34	STORMWATER MANAGEMENT PLAN-2
324	SW-35	STORMWATER MANAGEMENT PLAN-2
325	SW-36	STORMWATER MANAGEMENT PLAN-2
326	SW-37	STORMWATER MANAGEMENT PLAN-2
327	SW-38	STORMWATER MANAGEMENT KEY MAP -3
328	SW-39	STORMWATER MANAGEMENT PLAN-3
329	SW-40	STORMWATER MANAGEMENT PLAN-3
330	SW-41	STORMWATER MANAGEMENT PLAN-3
331	SW-42	STORMWATER MANAGEMENT PLAN-3
332	SW-43	STORMWATER MANAGEMENT PLAN-3
333	SW-44	STORMWATER MANAGEMENT PLAN-3
334	SW-45	STORMWATER MANAGEMENT PLAN-3
335	SW-46	STORMWATER MANAGEMENT PLAN-3
336	SW-47	STORMWATER MANAGEMENT PLAN-3
337	SW-48	STORMWATER MANAGEMENT PLAN-3
338	SW-49	STORMWATER MANAGEMENT PLAN-3
339	SW-50	STORMWATER MANAGEMENT KEY MAP -4
340	SW-51	STORMWATER MANAGEMENT PLAN-4
341	SW-52	STORMWATER MANAGEMENT PLAN-4
342	SW-53	STORMWATER MANAGEMENT PLAN-4
343	SW-54	STORMWATER MANAGEMENT PLAN-4
344	SW-55	STORMWATER MANAGEMENT PLAN-4
345	SW-56	STORMWATER MANAGEMENT PLAN-4
346	SW-57	STORMWATER MANAGEMENT PLAN-4
347	SW-58	STORMWATER MANAGEMENT PLAN-4
348	SW-59	STORMWATER MANAGEMENT PLAN-4
349	SW-60	STORMWATER MANAGEMENT PLAN-4
350	SW-61	STORMWATER MANAGEMENT PLAN-4

SHEET NO.	DWG. NO.	DESCRIPTION
351	SW-62	STORMWATER MANAGEMENT PLAN-4
352	SW-63	STORMWATER MANAGEMENT PLAN-4
353	SW-64	STORMWATER MANAGEMENT PLAN-4
354	SW-65	STORMWATER MANAGEMENT PLAN-4
355	SW-66	STORMWATER MANAGEMENT PLAN-4
356	SW-67	STORMWATER MANAGEMENT PLAN-4
357	SW-68	STORMWATER MANAGEMENT PLAN-4
358	SW-69	STORMWATER MANAGEMENT PLAN-4
359	SW-70	STORMWATER MANAGEMENT PLAN-4
360	SW-71	STORMWATER MANAGEMENT PLAN-4
361	SW-72	STORMWATER MANAGEMENT PLAN-4
362	SW-73	STORMWATER MANAGEMENT PLAN-4
363	SW-74	STORMWATER MANAGEMENT PLAN-4
364	SW-75	STORMWATER MANAGEMENT KEY MAP -5
365	SW-76	STORMWATER MANAGEMENT PLAN-5
366	SW-77	STORMWATER MANAGEMENT PLAN-5
367	SW-78	STORMWATER MANAGEMENT PLAN 5
368	SW-79	STORMWATER MANAGEMENT PLAN-5
369	SW-80	STORMWATER MANAGEMENT PLAN-5
370	SW-81	STORMWATER MANAGEMENT PLAN-5
371	SW-82	STORMWATER MANAGEMENT PLAN-5
372	SW-83	STORMWATER MANAGEMENT PLAN-5
373	SW-84	STORMWATER MANAGEMENT PLAN-5
374	SW-85	STORMWATER MANAGEMENT PLAN-5
375	SW-86	STORMWATER MANAGEMENT PLAN-5
376	SW-87	STORMWATER MANAGEMENT PLAN-5
377	SW-88	STORMWATER MANAGEMENT PLAN-5
378	SW-89	STORMWATER MANAGEMENT PLAN-5
379	SW-90	STORMWATER MANAGEMENT KEY MAP -6
380	SW-91	STORMWATER MANAGEMENT PLAN-6
381	SW-92	STORMWATER MANAGEMENT PLAN-6
382	SW-93	STORMWATER MANAGEMENT PLAN-6
383	SW-94	STORMWATER MANAGEMENT PLAN-6
384	SW-95	STORMWATER MANAGEMENT PLAN-6
385	SW-96	STORMWATER MANAGEMENT PLAN-6
386	SW-97	STORMWATER MANAGEMENT PLAN-6
387	SW-98	STORMWATER MANAGEMENT PLAN-6
388	SW-99	STORMWATER MANAGEMENT PLAN-6
389	SW-100	STORMWATER MANAGEMENT PLAN-6
390	SW-101	STORMWATER MANAGEMENT PLAN-6
391	SW-102	STORMWATER MANAGEMENT PLAN-6
392	SW-103	STORMWATER MANAGEMENT PLAN-6
393	SW-104	STORMWATER MANAGEMENT PLAN-6
394	SW-105	STORMWATER MANAGEMENT PLAN-6
395	SW-106	STORMWATER MANAGEMENT PLAN-6
396	SW-107	STORMWATER MANAGEMENT KEY MAP -7
397	SW-108	STORMWATER MANAGEMENT PLAN-7
398	SW-109	STORMWATER MANAGEMENT PLAN-7
399	SW-110	STORMWATER MANAGEMENT DETAILS
400	SW-111	STORMWATER MANAGEMENT DETAILS

SHEET NO.	DWG. NO.	DESCRIPTION
401	SW-112	STORMWATER MANAGEMENT DETAILS
402	SW-113	STORMWATER MANAGEMENT DETAILS
403	SW-114	STORMWATER MANAGEMENT DETAILS
404	SW-115	Blank
405	DD-01	DRAINAGE PLAN - SEGMENT 1
406	DD-02	DRAINAGE PLAN - SEGMENT 1
407	DD-03	DRAINAGE PLAN - SEGMENT 1
408	DD-04	DRAINAGE PLAN - SEGMENT 1
409	DD-05	DRAINAGE PLAN - SEGMENT 1
410	DD-06	DRAINAGE PLAN - SEGMENT 1 - SEGMENT 2
411	DD-07	DRAINAGE PLAN - SEGMENT 2
412	DD-08	DRAINAGE PLAN - SEGMENT 2
413	DD-08A	DRAINAGE PLAN - SEGMENT 2
414	DD-09	DRAINAGE PLAN - SEGMENT 2
415	DD-10	DRAINAGE PLAN - SEGMENT 2
416	DD-11	DRAINAGE PLAN - SEGMENT 2
417	DD-12	DRAINAGE PLAN - SEGMENT 2
418	DD-13	DRAINAGE PLAN - SEGMENT 2
419	DD-13 DD-14	DRAINAGE PLAN - SEGMENT 2
420	DD-14 DD-15	DRAINAGE PLAN - SEGMENT 2
420	DD-15 DD-16	DRAINAGE PLAN - SEGMENT 2
421	DD-10 DD-17	DRAINAGE PLAN - SEGMENT 2
423	DD-17A	DRAINAGE PLAN - SEGMENT 2
424	DD-18	DRAINAGE PLAN - SEGMENT 2
425	DD-19	DRAINAGE PLAN - SEGMENT 2
426	DD-20	DRAINAGE PLAN - SEGMENT 2
427	DD-21	DRAINAGE PLAN - SEGMENT 2
428	DD-22	DRAINAGE PLAN - SEGMENT 2
429	DD-23	DRAINAGE PLAN - SEGMENT 2
430	DD-24	DRAINAGE PLAN - SEGMENT 2
431	DD-25	DRAINAGE PLAN - SEGMENT 2
432	DD-26	DRAINAGE PLAN - SEGMENT 2
433	DD-27	DRAINAGE PLAN - SEGMENT 2
434	DD-28	DRAINAGE PLAN - SEGMENT 2
435	DD-29	DRAINAGE PLAN - SEGMENT 2
436	DD-30	DRAINAGE PLAN - SEGMENT 2
437	DD-31	DRAINAGE PLAN - SEGMENT 2
438	DD-32	DRAINAGE PLAN - SEGMENT 2
439	DD-33	DRAINAGE PLAN - SEGMENT 2
440	DD-33A	DRAINAGE PLAN - SEGMENT 2
441	DD-34	DRAINAGE PLAN - SEGMENT 2 - SEGMENT 3
442	DD-34A	DRAINAGE PLAN - SEGMENT 3
443	DD-35	DRAINAGE PLAN - SEGMENT 3
444	DD-36	DRAINAGE PLAN - SEGMENT 3
445	DD-37	DRAINAGE PLAN - SEGMENT 3
446	DD-38	DRAINAGE PLAN - SEGMENT 3
447	DD-39	DRAINAGE PLAN - SEGMENT 3
448	DD-40	DRAINAGE PLAN - SEGMENT 3
449	DD-41	DRAINAGE PLAN - SEGMENT 3
450	DD-41A	DRAINAGE PLAN - SEGMENT 3

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PROFESSIONAL CERTIFICATION:
I HEREBY CERTIFY THAT THESE DOCUMENTS WERE PREPARED
OR APPROVED BY ME, AND THAT I AM A DULY LICENSED PROFESSIONAL ENGINEER UNDER THE LAWS OF THE STATE OF MARYLAND. LICENSE NO: \_\_\_\_\_ EXPIRATION DATE: \_\_

DIVISION OF TRANSPORTATION ENGINEERING GAITHERSBURG, MARYLAND RECOMMENDED FOR APPROVAL REVISION SEE TITLE SHEET FOR SIGNATURES
Chief, Design Section APPROVED SEE TITLE SHEET FOR SIGNATURES
Chief, Division of Transportation Engineering

Designed by :\_\_\_\_\_ Drawn by :\_\_\_\_

MONTGOMERY COUNTY DEPARTMENT OF TRANSPORTATION

MD 355 BUS RAPID TRANSIT (BRT)

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DATE: DECEMBER 2022 Project No. : 502005

SCALE: N.T.S.

Checked by :  $\_$ 

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451	DD-42	DRAINAGE PLAN - SEGMENT 3
452	DD-43	DRAINAGE PLAN - SEGMENT 3
453	DD-44	DRAINAGE PLAN - SEGMENT 3
454	DD-45	DRAINAGE PLAN - SEGMENT 3 - SEGMENT 4
455	DD-46	DRAINAGE PLAN - SEGMENT 4
456	DD-46A	DRAINAGE PLAN - SEGMENT 4
457	DD-46B	DRAINAGE PLAN - SEGMENT 4
458	DD-46C	DRAINAGE PLAN - SEGMENT 4
459	DD-47	DRAINAGE PLAN - SEGMENT 4
460	DD-47A	DRAINAGE PLAN - SEGMENT 4
461	DD-48	DRAINAGE PLAN - SEGMENT 4
462	DD-49	DRAINAGE PLAN - SEGMENT 4
463	DD-50	DRAINAGE PLAN - SEGMENT 4
464	DD-51	DRAINAGE PLAN - SEGMENT 4
465	DD-51A	DRAINAGE PLAN - SEGMENT 4
466	DD-51B	DRAINAGE PLAN - SEGMENT 4
467	DD-51C	DRAINAGE PLAN - SEGMENT 4
468	DD-52	DRAINAGE PLAN - SEGMENT 4
469	DD-53	DRAINAGE PLAN - SEGMENT 4
470	DD-54	DRAINAGE PLAN - SEGMENT 4
471	DD-55	DRAINAGE PLAN - SEGMENT 4
472	DD-56	DRAINAGE PLAN - SEGMENT 4
473	DD-57	DRAINAGE PLAN - SEGMENT 4
474	DD-58	DRAINAGE PLAN - SEGMENT 4
475	DD-59	DRAINAGE PLAN - SEGMENT 4
476	DD-60	DRAINAGE PLAN - SEGMENT 4
477	DD-61	DRAINAGE PLAN - SEGMENT 4
478	DD-62	DRAINAGE PLAN - SEGMENT 4
479	DD-63	DRAINAGE PLAN - SEGMENT 4
480	DD-64	DRAINAGE PLAN - SEGMENT 4 - SEGMENT 5
481	DD-65	DRAINAGE PLAN - SEGMENT 5
482	DD-66	DRAINAGE PLAN - SEGMENT 5
483	DD-66A	DRAINAGE PLAN - SEGMENT 5
484	DD-66B	DRAINAGE PLAN - SEGMENT 5
485	DD-66C	DRAINAGE PLAN - SEGMENT 5
486	DD-66D	DRAINAGE PLAN - SEGMENT 5
486A	DD-66E	DRAINAGE PLAN - SEGMENT 5
487	DD-67	DRAINAGE PLAN - SEGMENT 5
488	DD-68	DRAINAGE PLAN - SEGMENT 5
489	DD-69	DRAINAGE PLAN - SEGMENT 5
490	DD-70	DRAINAGE PLAN - SEGMENT 5
491	DD-71	DRAINAGE PLAN - SEGMENT 5
492	DD-71A	DRAINAGE PLAN - SEGMENT 5
493	DD-71B	DRAINAGE PLAN - SEGMENT 5
494	DD-71C	DRAINAGE PLAN - SEGMENT 5
495	DD-71D	DRAINAGE PLAN - SEGMENT 5
496	DD-71E	DRAINAGE PLAN - SEGMENT 5
497	DD-72	DRAINAGE PLAN - SEGMENT 5
498	DD-73	DRAINAGE PLAN - SEGMENT 5 - SEGMENT 6
499	DD-74	DRAINAGE PLAN - SEGMENT 6
500	DD-75	DRAINAGE PLAN - SEGMENT 6

SHEET	DWG.	DESCRIPTION
NO. 501	NO. DD-76	DRAINAGE PLAN - SEGMENT 6
502	DD-70 DD-77	DRAINAGE PLAN - SEGMENT 6
503	DD-77	DRAINAGE PLAN - SEGMENT 6
504	DD 78	DRAINAGE PLAN - SEGMENT 6
505	DD-80	DRAINAGE PLAN - SEGMENT 6
506	DD-81	DRAINAGE PLAN - SEGMENT 6
507	DD-82	DRAINAGE PLAN - SEGMENT 6
508	DD-83	DRAINAGE PLAN - SEGMENT 6
509	DD-84	DRAINAGE PLAN - SEGMENT 6
510	DD-85	DRAINAGE PLAN - SEGMENT 6
511	DD-86	DRAINAGE PLAN - SEGMENT 6
512	DD-87	DRAINAGE PLAN - SEGMENT 6
513	DD-88	DRAINAGE PLAN - SEGMENT 6
514	DD-89	DRAINAGE PLAN - SEGMENT 6 - SEGMENT 7
515	DD-89A	DRAINAGE PLAN - SEGMENT 6 - SEGMENT 7
516	DD-90	DRAINAGE PLAN - SEGMENT 7
517	DD-91	DRAINAGE PLAN - SEGMENT 7
518	ESC-01	EROSION AND SEDIMENT CONTROL PLAN - SEGMENT 1
519	ESC-02	EROSION AND SEDIMENT CONTROL PLAN - SEGMENT 1
520	ESC-03	EROSION AND SEDIMENT CONTROL PLAN - SEGMENT 1
521	ESC-04	EROSION AND SEDIMENT CONTROL PLAN - SEGMENT 1
522	ESC-05	EROSION AND SEDIMENT CONTROL PLAN - SEGMENT 1
523	ESC-06	EROSION AND SEDIMENT CONTROL PLAN - SEGMENT 1 - SEGMENT 2
524	ESC-07	EROSION AND SEDIMENT CONTROL PLAN - SEGMENT 2
525	ESC-08	EROSION AND SEDIMENT CONTROL PLAN - SEGMENT 2
526	ESC-08A	EROSION AND SEDIMENT CONTROL PLAN - SEGMENT 2
527	ESC-09	EROSION AND SEDIMENT CONTROL PLAN - SEGMENT 2
528	ESC-10	EROSION AND SEDIMENT CONTROL PLAN - SEGMENT 2
529	ESC-11	EROSION AND SEDIMENT CONTROL PLAN - SEGMENT 2
530	ESC-12	EROSION AND SEDIMENT CONTROL PLAN - SEGMENT 2
531	ESC-13	EROSION AND SEDIMENT CONTROL PLAN - SEGMENT 2
532	ESC-14	EROSION AND SEDIMENT CONTROL PLAN - SEGMENT 2
533	ESC-15	EROSION AND SEDIMENT CONTROL PLAN - SEGMENT 2
534	ESC-16	EROSION AND SEDIMENT CONTROL PLAN - SEGMENT 2
535	ESC-17	EROSION AND SEDIMENT CONTROL PLAN - SEGMENT 2
536	ESC-17A	EROSION AND SEDIMENT CONTROL PLAN - SEGMENT 2
537	ESC-18	EROSION AND SEDIMENT CONTROL PLAN - SEGMENT 2
538	ESC-19	EROSION AND SEDIMENT CONTROL PLAN - SEGMENT 2
539	ESC-20	EROSION AND SEDIMENT CONTROL PLAN - SEGMENT 2
540	ESC-21	EROSION AND SEDIMENT CONTROL PLAN - SEGMENT 2
541	ESC-22	EROSION AND SEDIMENT CONTROL PLAN - SEGMENT 2
542	ESC-23	EROSION AND SEDIMENT CONTROL PLAN - SEGMENT 2
543	ESC-24	EROSION AND SEDIMENT CONTROL PLAN - SEGMENT 2
544	ESC-25	EROSION AND SEDIMENT CONTROL PLAN - SEGMENT 2
545	ESC-26	EROSION AND SEDIMENT CONTROL PLAN - SEGMENT 2
546	ESC-27	EROSION AND SEDIMENT CONTROL PLAN - SEGMENT 2
547	ESC-28	EROSION AND SEDIMENT CONTROL PLAN - SEGMENT 2
548	ESC-29	EROSION AND SEDIMENT CONTROL PLAN - SEGMENT 2
549	ESC-30	EROSION AND SEDIMENT CONTROL PLAN - SEGMENT 2
550	ESC-31	EROSION AND SEDIMENT CONTROL PLAN - SEGMENT 2

SHEET NO.	DWG. NO.	DESCRIPTION
551	ESC-32	EROSION AND SEDIMENT CONTROL PLAN - SEGMENT 2
552	ESC-33	EROSION AND SEDIMENT CONTROL PLAN - SEGMENT 2
553	ESC-33A	EROSION AND SEDIMENT CONTROL PLAN - SEGMENT 2
554	ESC-34	EROSION AND SEDIMENT CONTROL PLAN - SEGMENT 3
555	ESC-34A	EROSION AND SEDIMENT CONTROL PLAN - SEGMENT 3
556	ESC-35	EROSION AND SEDIMENT CONTROL PLAN - SEGMENT 3
557	ESC-36	EROSION AND SEDIMENT CONTROL PLAN - SEGMENT 3
558	ESC-37	EROSION AND SEDIMENT CONTROL PLAN - SEGMENT 3
559	ESC-38	EROSION AND SEDIMENT CONTROL PLAN - SEGMENT 3
560	ESC-39	EROSION AND SEDIMENT CONTROL PLAN - SEGMENT 3
561	ESC-40	EROSION AND SEDIMENT CONTROL PLAN - SEGMENT 3
	ESC-40 ESC-41	
562		EROSION AND SEDIMENT CONTROL PLAN - SEGMENT 3
563	ESC-41A	EROSION AND SEDIMENT CONTROL PLAN - SEGMENT 3
564	ESC-42	EROSION AND SEDIMENT CONTROL PLAN - SEGMENT 3
565	ESC-43	EROSION AND SEDIMENT CONTROL PLAN - SEGMENT 3
566	ESC-44	EROSION AND SEDIMENT CONTROL PLAN - SEGMENT 3
567	ESC-45	EROSION AND SEDIMENT CONTROL PLAN - SEGMENT 3 - SEGMENT 4
568	ESC-46	EROSION AND SEDIMENT CONTROL PLAN - SEGMENT 4
569	ESC-47	EROSION AND SEDIMENT CONTROL PLAN - SEGMENT 4
570	ESC-48	EROSION AND SEDIMENT CONTROL PLAN - SEGMENT 4
571	ESC-49	EROSION AND SEDIMENT CONTROL PLAN - SEGMENT 4
572	ESC-50	EROSION AND SEDIMENT CONTROL PLAN - SEGMENT 4
573	ESC-51	EROSION AND SEDIMENT CONTROL PLAN - SEGMENT 4
574	ESC-51A	EROSION AND SEDIMENT CONTROL PLAN - SEGMENT 4
575	ESC-51B	EROSION AND SEDIMENT CONTROL PLAN - SEGMENT 4
576	ESC-51C	EROSION AND SEDIMENT CONTROL PLAN - SEGMENT 4
577	ESC-52	EROSION AND SEDIMENT CONTROL PLAN - SEGMENT 4
578	ESC-53	EROSION AND SEDIMENT CONTROL PLAN - SEGMENT 4
579	ESC-54	EROSION AND SEDIMENT CONTROL PLAN - SEGMENT 4
580	ESC-55	EROSION AND SEDIMENT CONTROL PLAN - SEGMENT 4
581	ESC-56	EROSION AND SEDIMENT CONTROL PLAN - SEGMENT 4
582	ESC-57	EROSION AND SEDIMENT CONTROL PLAN - SEGMENT 4
583	ESC-58	EROSION AND SEDIMENT CONTROL PLAN - SEGMENT 4
584	ESC-59	EROSION AND SEDIMENT CONTROL PLAN - SEGMENT 4
585	ESC-60	EROSION AND SEDIMENT CONTROL PLAN - SEGMENT 4
586	ESC-61	EROSION AND SEDIMENT CONTROL PLAN - SEGMENT 4
587	ESC-62	EROSION AND SEDIMENT CONTROL PLAN - SEGMENT 4
588	ESC-62A	EROSION AND SEDIMENT CONTROL PLAN - SEGMENT 4
589	ESC-63	EROSION AND SEDIMENT CONTROL PLAN - SEGMENT 4
590	ESC-64	EROSION AND SEDIMENT CONTROL PLAN - SEGMENT 4 - SEGMENT 5
591	ESC-65	EROSION AND SEDIMENT CONTROL PLAN - SEGMENT 5
592	ESC-66	EROSION AND SEDIMENT CONTROL PLAN - SEGMENT 5
593	ESC-67	EROSION AND SEDIMENT CONTROL PLAN - SEGMENT 5
594	ESC-68	EROSION AND SEDIMENT CONTROL PLAN - SEGMENT 5
595	ESC-69	EROSION AND SEDIMENT CONTROL PLAN - SEGMENT 5
596	ESC-70	EROSION AND SEDIMENT CONTROL PLAN - SEGMENT 5
597	ESC-71	EROSION AND SEDIMENT CONTROL PLAN - SEGMENT 5
598	ESC-71A	EROSION AND SEDIMENT CONTROL PLAN - SEGMENT 5
599	ESC-71B	EROSION AND SEDIMENT CONTROL PLAN - SEGMENT 5
600	ESC-71C	EROSION AND SEDIMENT CONTROL PLAN - SEGMENT 5

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Chief, Design Section APPROVED SEE TITLE SHEET FOR SIGNATURES
Chief, Division of Transportation Engineering Designed by :\_\_\_\_\_ Drawn by :\_\_\_\_ Checked by : \_

MONTGOMERY COUNTY DEPARTMENT OF TRANSPORTATION

DIVISION OF TRANSPORTATION ENGINEERING

MD 355 BUS RAPID TRANSIT (BRT)

I-04

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602	ESC-71E	EROSION AND SEDIMENT CONTROL PLAN - SEGMENT 5
603	ESC-72	EROSION AND SEDIMENT CONTROL PLAN - SEGMENT 5
604	ESC-73	EROSION AND SEDIMENT CONTROL PLAN - SEGMENT 5 - SEGMENT 6
605	ESC-74	EROSION AND SEDIMENT CONTROL PLAN - SEGMENT 6
606	ESC-75	EROSION AND SEDIMENT CONTROL PLAN - SEGMENT 6
607	ESC-76	EROSION AND SEDIMENT CONTROL PLAN - SEGMENT 6
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609	ESC-78	EROSION AND SEDIMENT CONTROL PLAN - SEGMENT 6
610	ESC-79	EROSION AND SEDIMENT CONTROL PLAN - SEGMENT 6
611	ESC-80	EROSION AND SEDIMENT CONTROL PLAN - SEGMENT 6
612	ESC-81	EROSION AND SEDIMENT CONTROL PLAN - SEGMENT 6
613	ESC-82	EROSION AND SEDIMENT CONTROL PLAN - SEGMENT 6
614	ESC-83	EROSION AND SEDIMENT CONTROL PLAN - SEGMENT 6
615	ESC-84	EROSION AND SEDIMENT CONTROL PLAN - SEGMENT 6
616	ESC-85	EROSION AND SEDIMENT CONTROL PLAN - SEGMENT 6
617	ESC-85A	EROSION AND SEDIMENT CONTROL PLAN - SEGMENT 6
618	ESC-86	EROSION AND SEDIMENT CONTROL PLAN - SEGMENT 6
619	ESC-87	EROSION AND SEDIMENT CONTROL PLAN - SEGMENT 6
620	ESC-88	EROSION AND SEDIMENT CONTROL PLAN - SEGMENT 6
621	ESC-89	EROSION AND SEDIMENT CONTROL PLAN - SEGMENT 6 - SEGMENT 7
622	ESC-89A	EROSION AND SEDIMENT CONTROL PLAN - SEGMENT 6 - SEGMENT 7
623	ESC-90	EROSION AND SEDIMENT CONTROL PLAN - SEGMENT 7
624	ESC-91	EROSION AND SEDIMENT CONTROL PLAN - SEGMENT 7
625	ESC-92	EROSION AND SEDIMENT CONTROL PLAN - SEGMENT 7
626	ESC-93	EROSION AND SEDIMENT CONTROL PLAN - SEGMENT 7
627	ESC-94	EROSION AND SEDIMENT CONTROL PLAN - SEGMENT 7
628	ESC-95	EROSION AND SEDIMENT CONTROL PLAN - SEGMENT 7
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631	ES-04	EROSION AND SEDIMENT CONTROL NOTES & DETAILS
632	MT-00	MAINTENANCE OF TRAFFIC GENERAL NOTES
633	MT-01	MAINTENANCE OF TRAFFIC TYPICAL SECTIONS
634	MT-02	MAINTENANCE OF TRAFFIC TYPICAL SECTIONS
635	MT-03	MAINTENANCE OF TRAFFIC TYPICAL SECTIONS
636	MT-04	MAINTENANCE OF TRAFFIC TYPICAL SECTIONS
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639	MT-07	MAINTENANCE OF TRAFFIC TYPICAL SECTIONS
640	MT-08	MAINTENANCE OF TRAFFIC TYPICAL SECTIONS
641	MT-09	MAINTENANCE OF TRAFFIC TYPICAL SECTIONS
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643	SN-2.1	SIGNING AND MARKING PLANS
644	SN-2.2	SIGNING AND MARKING PLANS
645	SN-2.3	SIGNING AND MARKING PLANS
646	SN-2.4	SIGNING AND MARKING PLANS
647	SN-2.5	SIGNING AND MARKING PLANS
648	SN-2.6	SIGNING AND MARKING PLANS
649	SN-2.7	SIGNING AND MARKING PLANS
650	SN-2.8	SIGNING AND MARKING PLANS
650	SN-2.8	SIGNING AND MARKING PLANS

SHEET	DWG.	DESCRIPTION
NO. 651	NO. SN-2.9	SIGNING AND MARKING PLANS
652	SN-2.10	SIGNING AND MARKING PLANS
653	SN-2.10	SIGNING AND MARKING PLANS
654	SN-2.11	SIGNING AND MARKING PLANS
655	SN-2.12	SIGNING AND MARKING PLANS
656	SN-2.14	SIGNING AND MARKING PLANS
657	SN-2.14	SIGNING AND MARKING PLANS
658	SN-2.16	SIGNING AND MARKING PLANS
659	SN-2.17	SIGNING AND MARKING PLANS
660	SN-2.17	SIGNING AND MARKING PLANS
661	SN-2.19	SIGNING AND MARKING PLANS
662	SN-2.20	SIGNING AND MARKING PLANS
663	SN-2.21	SIGNING AND MARKING PLANS
664	SN-2.22	SIGNING AND MARKING PLANS
665	SN-2.23	SIGNING AND MARKING PLANS
666	SN-2.24	SIGNING AND MARKING PLANS
667	SN-2.25	SIGNING AND MARKING PLANS
668	SN-2.26	SIGNING AND MARKING PLANS
669	SN-2.27	SIGNING AND MARKING PLANS
670	SN-2.28	SIGNING AND MARKING PLANS
671	SN-2.29	SIGNING AND MARKING PLANS
672	SN-2.30	SIGNING AND MARKING PLANS
673	SN-2.31	SIGNING AND MARKING PLANS
674	SN-2.32	SIGNING AND MARKING PLANS
675	SN-2.33	SIGNING AND MARKING PLANS
676	SN-2.34	SIGNING AND MARKING PLANS
677	SN-2.35	SIGNING AND MARKING PLANS
678	SN-2.36	SIGNING AND MARKING PLANS
679	SN-2.37	SIGNING AND MARKING PLANS
680	SN-2.38	SIGNING AND MARKING PLANS
681	SN-2.39	SIGNING AND MARKING PLANS
682	SN-2.40	SIGNING AND MARKING PLANS
683	SN-2.41	SIGNING AND MARKING PLANS
684	SN-2.42	SIGNING AND MARKING PLANS
685	SN-2.43	SIGNING AND MARKING PLANS
686	SN-2.44	SIGNING AND MARKING PLANS
687	SN-2.45	SIGNING AND MARKING PLANS
688	SN-2.46	SIGNING AND MARKING PLANS
689	SN-2.46A	SIGNING AND MARKING PLANS
690	SN-2.46B	SIGNING AND MARKING PLANS
691	SN-2.46C	SIGNING AND MARKING PLANS
692	SN-2.47	SIGNING AND MARKING PLANS
693	SN-2.47A	SIGNING AND MARKING PLANS
694	SN-2.48	SIGNING AND MARKING PLANS
695	SN-2.49	SIGNING AND MARKING PLANS
696	SN-2.50	SIGNING AND MARKING PLANS
697	SN-2.51	SIGNING AND MARKING PLANS
698	SN-2.52	SIGNING AND MARKING PLANS
699	SN-2.53	SIGNING AND MARKING PLANS
700	SN-2.54	SIGNING AND MARKING PLANS

SHEET NO.	DWG. NO.	DESCRIPTION
701	SN-2.55	SIGNING AND MARKING PLANS
702	SN-2.56	SIGNING AND MARKING PLANS
703	SN-2.57	SIGNING AND MARKING PLANS
704	SN-2.58	SIGNING AND MARKING PLANS
705	SN-2.59	SIGNING AND MARKING PLANS
706	SN-2.60	SIGNING AND MARKING PLANS
707	SN-2.61	SIGNING AND MARKING PLANS
708	SN-2.62	SIGNING AND MARKING PLANS
709	SN-2.63	SIGNING AND MARKING PLANS
710	SN-2.64	SIGNING AND MARKING PLANS
711	SN-2.65	SIGNING AND MARKING PLANS
712	SN-2.66	SIGNING AND MARKING PLANS
713	SN-2.66A	SIGNING AND MARKING PLANS
714	SN-2.66B	SIGNING AND MARKING PLANS
715	SN-2.66C	SIGNING AND MARKING PLANS
716	SN-2.66D	SIGNING AND MARKING PLANS
717	SN-2.66E	SIGNING AND MARKING PLANS
718	SN-2.67	SIGNING AND MARKING PLANS
719	SN-2.68	SIGNING AND MARKING PLANS
720	SN-2.69	SIGNING AND MARKING PLANS
721	SN-2.70	SIGNING AND MARKING PLANS
721	SN-2.70	SIGNING AND MARKING PLANS
723	SN-2.71	SIGNING AND MARKING PLANS
723	SN-2.72	SIGNING AND MARKING PLANS
724	SN-2.74	SIGNING AND MARKING PLANS
725	SN-2.74	SIGNING AND MARKING PLANS
720	SN-2.75	SIGNING AND MARKING PLANS
727		SIGNING AND MARKING PLANS
	SN-2.77	
729	SN-2.78	SIGNING AND MARKING PLANS
730	SN-2.79	SIGNING AND MARKING PLANS
731	SN-2.80	SIGNING AND MARKING PLANS
732	SN-2.81	SIGNING AND MARKING PLANS
733	SN-2.82	SIGNING AND MARKING PLANS
734	SN-2.83	SIGNING AND MARKING PLANS
735	SN-2.84	SIGNING AND MARKING PLANS
736	SN-3.1	SIGNING & PAVEMENT MARKING SIGN DETAILS
737	SN-3.2	PAVEMENT MARKING DETAIL SHEET
738	SN-3.3	SAMPLE TACTILE GUIDANCE CUES
739	SN-11.1	SIGNING & PAVEMENT MARKING INDEX OF QUANTITIES
740	SN-11.2	SIGNING & PAVEMENT MARKING INDEX OF QUANTITIES
741	S-1	STRUCTURAL GENERAL NOTES
742	S-2	BRIDGE NO. 150055001 TYPICAL SECTION
743	S-3	BRIDGE NO. 150055001 DECK MODIFICATION DETAILS
744	S-4	BRIDGE NO. 150194001 TYPICAL SECTION
745	S-5	BRIDGE NO. 150194001 DECK MODIFICATION DETAILS
746	S-6	CONCRETE REPAIR DETAILS
747	S-7	RETAINING WALL NO. RW-200R PLAN
748	S-8	RETAINING WALL NO. RW-201R PLAN (1 OF 2)
749	S-9	RETAINING WALL NO. RW-201R PLAN (2 OF 2)
750	S-10	RETAINING WALL NO. RW-202L PLAN

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PROFESSIONAL CERTIFICATION:
I HEREBY CERTIFY THAT THESE DOCUMENTS WERE PREPARED
OR APPROVED BY ME, AND THAT I AM A DULY LICENSED PROFESSIONAL ENGINEER UNDER THE LAWS OF THE STATE OF MARYLAND. LICENSE NO: \_\_\_\_\_ EXPIRATION DATE: \_\_

DIVISION OF TRANSPORTATION ENGINEERING GAITHERSBURG, MARYLAND RECOMMENDED FOR APPROVAL SEE TITLE SHEET FOR SIGNATURES
Chief, Design Section APPROVED SEE TITLE SHEET FOR SIGNATURES
Chief, Division of Transportation Engineering

MONTGOMERY COUNTY DEPARTMENT OF TRANSPORTATION

Checked by : \_

MD 355 BUS RAPID TRANSIT (BRT)

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Designed by :\_\_\_\_\_ Drawn by :\_\_\_\_

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SHEET NO.	DWG. NO.	DESCRIPTION
751	S-11	RETAINING WALL NO. RW-203R PLAN (1 OF 2)
752	S-12	RETAINING WALL NO. RW-203R PLAN (2 OF 2)
753	S-13	RETAINING WALL NO. RW-204L PLAN (1 OF 5)
754	S-14	RETAINING WALL NO. RW-204L PLAN (2 OF 5)
755	S-15	RETAINING WALL NO. RW-204L PLAN (3 OF 5)
756	S-16	RETAINING WALL NO. RW-204L PLAN (4 OF 5)
757	S-17	RETAINING WALL NO. RW-204L PLAN (5 OF 5)
758	S-18	RETAINING WALL NO. RW-205R PLAN
759	S-19	RETAINING WALL NO. RW-206R PLAN
760	S-20	RETAINING WALL NO. RW-207R PLAN
761	S-21	RETAINING WALL NO. RW-208R PLAN
762	S-22	RETAINING WALL NO. RW-209R PLAN
763	S-23	RETAINING WALL NO. RW-210R PLAN (1 OF 2)
764	S-24	RETAINING WALL NO. RW-210R PLAN (2 OF 2)
765	S-25	RETAINING WALL NO. RW-211L PLAN
766	S-26	RETAINING WALL NO. RW-212L PLAN
767	S-27	RETAINING WALL NO. RW-213L PLAN
768	S-28	RETAINING WALL NO. RW-301L PLAN
769	S-29	RETAINING WALL NO. RW-302R PLAN (1 OF 2)
770	S-30	RETAINING WALL NO. RW-302R PLAN (2 OF 2)
771	S-31	RETAINING WALL NO. RW-303R PLAN (1 OF 3)
772	S-32	RETAINING WALL NO. RW-303R PLAN (2 OF 3)
773	S-33	RETAINING WALL NO. RW-303R PLAN (3 OF 3)
774	S-34	RETAINING WALL NO. RW-304L PLAN
775	S-35	RETAINING WALL NO. RW-305L PLAN
776	S-36	RETAINING WALL NO. RW-306L PLAN (1 OF 2)
777	S-37	RETAINING WALL NO. RW-306L PLAN (2 OF 2)
778	S-38	RETAINING WALL NO. RW-307L PLAN (1 OF 3)
779	S-39	RETAINING WALL NO. RW-307L PLAN (2 OF 3)
780	S-40	RETAINING WALL NO. RW-307L PLAN (3 OF 3)
781	S-41	RETAINING WALL NO. RW-401R PLAN & RW-402R
782	S-42	THIS SHEET INTENTIONALLY LEFT BLANK
783	S-43	RETAINING WALL NO. RW-403L PLAN
784	S-44	RETAINING WALL NO. RW-404L PLAN (1 OF 2)
785	S-45	RETAINING WALL NO. RW-404L PLAN (2 OF 2)
786	S-46	RETAINING WALL NO. RW-405L PLAN
787	S-47	RETAINING WALL NO. RW-406L PLAN (1 OF 2)
788	S-48	RETAINING WALL NO. RW-406L PLAN (2 OF 2)
789	S-49	THIS SHEET INTENTIONALLY LEFT BLANK
790	S-50	RETAINING WALL NO. RW-408R PLAN (1 OF 2)
791	S-51	RETAINING WALL NO. RW-408R PLAN (2 OF 2)
792	S-52	RETAINING WALL NO. RW-409L PLAN (1 OF 2)
793	S-53	RETAINING WALL NO. RW-409L PLAN (2 OF 2)
794	S-54	RETAINING WALL NO. RW-410L PLAN (1 OF 2)
795	S-55	RETAINING WALL NO. RW-410L PLAN (2 OF 2)
796	S-56	RETAINING WALL NO. RW-501R PLAN
797	S-57	RETAINING WALL NO. RW-601L PLAN
798	S-58	RETAINING WALL NO. RW-602L PLAN
799	S-59	RETAINING WALL NO. RW-603R PLAN
800	S-60	RETAINING WALL NO. RW-604L PLAN

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SHEET NO.	DWG. NO.	DESCRIPTION
801	S-61	RETAINING WALL NO. RW-605R PLAN
802	S-62	RETAINING WALL NO. RW-606R PLAN
803	S-63	RETAINING WALL NO. RW-607R PLAN
804	S-64	RETAINING WALL TYPICAL SECTION (1 OF 2)
805	S-65	RETAINING WALL TYPICAL SECTION (2 OF 2)
806	AR-01	ARCHITECTURAL GENERAL NOTES, LEGEND, AND ABBREVIATIONS
807	AR-02	ARCHITECTURAL STATION LIST
808	AR-03	ARCHITECTURAL STATION TYPICAL SHELTER AND AMENITIES
809	AR-04	ARCHITECTURAL PLATFORM PROTOTYPE 1 PLAN
810	AR-05	ARCHITECTURAL PLATFORM PROTOTYPE 1 ELEVATION AND SECTIONS
811	AR-06	ARCHITECTURAL PLATFORM PROTOTYPE 2 PLAN
812	AR-07	ARCHITECTURAL PLATFORM PROTOTYPE 2 ELEVATION AND SECTIONS
813	AR-08	ARCHITECTURAL PLATFORM PROTOTYPE 3 PLAN
814	AR-09	ARCHITECTURAL PLATFORM PROTOTYPE 3 ELEVATION AND SECTIONS
815	AR-10	ARCHITECTURAL PLATFORM PROTOTYPES 4, 5, AND 6
816	AR-11	ARCHITECTURAL SITE PLAN AND ELEVATION SEG 2 GROSVENOR METRO
817	AR-12	ARCHITECTURAL SITE PLAN AND ELEVATION SEG 2 GROSVENOR METRO
818	AR-13	ARCHITECTURAL SITE PLAN SEG 2 SECURITY LANE
819	AR-14	ARCHITECTURAL ELEVATION SEG 2 SECURITY LANE
820	AR-15	ARCHITECTURAL SITE PLAN SEG 2 WHITE FLINT METRO
821	AR-16	ARCHITECTURAL ELEVATION SEG 2 WHITE FLINT METRO
822	AR-17	ARCHITECTURAL SITE PLAN SEG 2 BOU AVENUE
823	AR-18	ARCHITECTURAL ELEVATION SEG 2 BOU AVENUE
824	AR-19	ARCHITECTURAL SITE PLAN SEG 2 TWINBROOK METRO
825	AR-20	ARCHITECTURAL ELEVATION SEG 2 TWINBROOK METRO
826	AR-21	ARCHITECTURAL SITE PLAN SEG 2 EDMONSTON DRIVE
827	AR-22	ARCHITECTURAL ELEVATION SEG 2 EDMONSTON DRIVE
828	AR-23	ARCHITECTURAL SITE PLAN SEG 2 MOUNT VERNON PLACE
829	AR-24	ARCHITECTURAL ELEVATION SEG 2 MOUNT VERNON PLACE
830	AR-25	ARCHITECTURAL SITE PLAN AND ELEVATION SEG 3 ROCKVILLE METRO
831	AR-26	ARCHITECTURAL SITE PLAN AND ELEVATION SEG 3 ROCKVILLE METRO
832	AR-27	ARCHITECTURAL SITE PLAN AND ELEVATION SEG 3 MONTGOMERY COLLEGE
833	AR-28	ARCHITECTURAL SITE PLAN AND ELEVATION SEG 3 MONTGOMERY COLLEGE
834	AR-29	ARCHITECTURAL SITE PLAN SEG 4 SOMERVILLE DRIVE
835	AR-30	ARCHITECTURAL ELEVATION SEG 4 SOMERVILLE DRIVE
836	AR-31	ARCHITECTURAL SITE PLAN SEG 4 SOUTH WESTLAND DRIVE
837	AR-32	ARCHITECTURAL ELEVATION SEG 4 SOUTH WESTLAND DRIVE
838	AR-33	ARCHITECTURAL SITE PLAN SEG 4 EDUCATION BOULEVARD
839	AR-34	ARCHITECTURAL ELEVATION SEG 4 EDUCATION BOULEVARD
840	AR-35	ARCHITECTURAL SITE PLAN SEG 5 CEDAR AVENUE
841	AR-36	ARCHITECTURAL ELEVATION SEG 5 CEDAR AVENUE
842	AR-37	ARCHITECTURAL SITE PLAN SEG 5 ODENDHAL AVENUE
843	AR-38	ARCHITECTURAL ELEVATION SEG 5 ODENDHAL AVENUE
844	AR-39	ARCHITECTURAL SITE PLAN SEG 6 CHRISTOPHER AVENUE
845	AR-40	ARCHITECTURAL ELEVATION SEG 6 CHRISTOPHER AVENUE
846	AR-41	ARCHITECTURAL SITE PLAN SEG 6 WATKINS MILL ROAD
847	AR-42	ARCHITECTURAL ELEVATION SEG 6 WATKINS MILL ROAD
848	AR-43	ARCHITECTURAL SITE PLAN SEG 6 GUNNERS BRANCH ROAD
849	AR-44	ARCHITECTURAL ELEVATION SEG 6 GUNNERS BRANCH ROAD
850	AR-45	SHADY GROVE TRANSIT CENTER - CONCEPTUAL DESIGN
050	/ III TJ	OTHER SHOVE THATAGET CONTOLL TORE DESIGN

REVISION

DATE

APPROVED

SHEET NO.	DWG. NO.	DESCRIPTION
851	AR-46	LOT 13 TRANSIT CENTER - CONCEPTUAL DESIGN
852	AR-47	GROSVENOR TRANSIT CENTER - CONCEPTUAL DESIGN
853	TS-1	ITS NOTES AND LEGEND
854	TS-2	ITS STATION - GROSVENOR SOUTH
855	TS-3	ITS STATION - GROSVENOR NORTH
856	TS-4	ITS STATION - SECURITY LANE SOUTH
857	TS-5	ITS STATION - SECURITY LINE NORTH
858	TS-6	ITS STATION - WHITE FLINT METRO
859	TS-7	ITS STATION - BOU AVENUE SOUTH
860	TS-8	ITS STATION - BOU AVENUE NORTH
861	TS-9	ITS STATION - TWINBROOK METRO SB
862	TS-10	ITS STATION - TWINBROOK METRO NB
863	TS-11	ITS STATION - EDMONSTON DRIVE SB
864	TS-12	ITS STATION - EDMONSTON DRIVE NB
865	TS-13	ITS STATION - MOUNT VERNON PLACE
866	TS-14	ITS STATION - ROCKVILLE METRO NB
867	TS-15	ITS STATION - ROCKVILLE METRO SB
868	TS-16	ITS STATION - MONTGOMERY COLLEGE ROCKVILLE
869	TS-17	ITS STATION - KING FARM BLVD
870	TS-18	ITS STATION - SOUTH WESTLAND DRIVE SB
871	TS-19	ITS STATION - SOUTH WESTLAND DRIVE NB
872	TS-20	ITS STATION - EDUCATION BLVD SB
873	TS-21	ITS STATION - EDUCATION BLVD NB
874	TS-22	ITS STATION - ODENHAL AVENUE SB
875	TS-23	ITS STATION - ODENHAL AVENUE NB
876	TS-24	ITS STATION - LAKEFOREST TRANSIT CENTER - SB
877	TS-25	ITS STATION - LAKEFOREST TRANSIT CENTER - NB
878	TS-26	ITS STATION - CHRISTOPHER AVENUE - SB
879	TS-27	ITS STATION - CHRISTOPHER AVENUE - NB
880	TS-28	ITS STATION - MIDDLEBROOK ROAD SB
881	TS-29	ITS STATION - MIDDLEBROOK ROAD NB
882	TS-30	ITS STATION - WATKINS MILL ROAD SB
883	TS-31	ITS STATION - WATKINS MILL ROAD NB
883A	TS-32	ITS DETAILS
883B	TS-33	ITS STATION - COMMUNICATION ONE-LINE
884	LT-01	LIGHTING GENERAL NOTES
885	LT-02	CONCEPT LIGHTING PLAN
886	LT-03	CONCEPT LIGHTING PLAN
887	LT-04	PEDESTRIAN LIGHT POLE DETAILS

		MONTGOMERY COUNTY DEPARTMENT OF TRANSPORTATION
		DIVISION OF TRANSPORTATION ENGINEERING
		GAITHERSBURG, MARYLAND
_		RECOMMENDED FOR APPROVAL
	ВҮ	SEE TITLE SHEET FOR SIGNATURES
		Chief, Design Section Date

Checked by :  $\_$ 

SEE TITLE SHEET FOR SIGNATURES
Chief, Division of Transportation Engineering

Designed by :\_\_\_\_\_ Drawn by :\_\_\_\_

MD 355 BUS RAPID TRANSIT (BRT)

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SCALE : N.T.S.

DATE: DECEMBER 2022 Project No. : 502005 SHEET 07 of 887

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