ARTIST'S IMPRESSION - NOT FOR BIDDING PURPOSES

111101 0	IVII 112331011 - 1101 1 011 010011	id i oni c	JOLO
ABBRE	VIATIONS:		
ANG AB ACT ADD AESS AFF ALS ANOD BD BLDG	ANGLE AND ANCHOR BOLT ACOUSTICAL CEILING TILE ADDENDUM ARCHITECTURAL EXPOSED STRUCTURAL STEEL ABOVE FINISH FLOOR AREA LIGHT STANDARD ALUMINUM ANODIZED BOARD BUILDING BLOCKING	EL ELEC EOS ENGR	EACH EXHAUST FAN EXPANSION JOINT ELEVATION ELECTRICAL EDGE OF SLAB ENGINEER EQUAL EQUIPMENT EACH SIDE EACH WAY EXPANSION
BLKG BM BOT BTWN CCTV CG CLP CLG CMU CONT CORR CSJ CSMT CT	BENCH MARK BOTTOM BETWEEN CHANNEL CLOSED CIRCUIT TV CORNER GUARD CAST IN PLACE CONCRETE CENTERLINE CEILING CLEAR CONTROL JOINT CONCRETE MASONRY UNIT CONTINUOUS CORRIDOR CONSTRUCTION JOINT CASEMENT CERAMIC TILE	FL FO FOC FOF	FURNISHED BY OTHERS FLOOR DRAIN FOUNDATION FIRE EXTINGUISHER FIRE EXTINGUISHER CABINET FINISH FLOOR FINISH FLOOR FACE OF FACE OF FACE OF CONCRETE FACE OF FINISH FACE OF MASONRY FACE OF STUD
OTR OBL OTL OIA OIAG OIM OISP ON	CENTER DOUBLE DETAIL DIAMETER DIAGONAL DIMENSION DISPENSER DOWN	GA GALV GB GC GL GND GVP GWB	GAUGE GALVANIZED GRAB BAR GENERAL CONTRACTOR GLASS GROUND GYPSUM VENEER PLASTER GYPSUM WALL BOARD
DP DR DS DWG	DAMPPROOFING DOOR DOWN SPOUT DRAWING	HB HM HPC HVAC	HOSE BIB HOLLOW METAL HIGH PERFORMANCE COATING HEATING, VENTILATION AND AIR CONDITIONING

HOT WATER

INSULATION

INTERIOR

INT

JAN JT JST	JANITOR JOINT JOIST	R RD REF REQ'D	RADIUS ROOF DRAIN REFERENCE REQUIRED
L	LENGTH	REV	REVISE OR REVISION
LB	LAG BOLT	RM	ROOM
LFS	LOW FLOOR SERIES	RO	ROUGH OPENING
LS	LANDSCAPING	RCP	REFLECTED CEILING PLAN
LVR	LOUVER	0.0	00115 0055
		SC	SOLID CORE
MATL	MATERIAL	SEG SF	SEGMENT SQUARE FOOT
MAX MECH	MAXIMUM MECHANICAL	SHTG	SHEATHING
MED	MEDIUM	SHT	
MFR	MANUFACTURER	SIM	SIMILAR
MIN	MINIMUM	SJ	SEISMIC JOINT
MISC	MISCELLANEOUS	SM	
MTD	MOUNTED	SQ	
MTL	METAL	SS	
(N)	NEW	STD STL	STANDARD STEEL
NA	NOT APPLICABLE	STRUCT	
NIC	NOT IN CONTRACT	SUSP	
NOM	NOMINAL		
NS	NELSON STUD	T/M	TO MATCH
NTS	NOT TO SCALE	T	TEMPERED GLAZING
Ω Λ	OVEDALL	TC	TOP OF CURB
OA OC	OVERALL ON CENTER	TEL THK	TELEPHONE THICK
OD	OVERFLOW DRAIN	TO	TOP OF
OD	OUTSIDE DIAMETER	TOD	TOP OF DECK
OFCI	OWNER FURNISHED	TOS	TOP OF STRUCTURE
	CONTRACTOR INSTALLED	TJ	TOOL JOINT
OFOI	OWNER FURNISED OWNER	TS TVA	TUBE STEEL
	INSTALLED	TVM TYP	TICKET VENDING MACHINE TYPICAL
OH OPNG	OVERHEAD OPENING		11110/12
OPP	OPPOSITE	UNFIN	UNFINISHED
OS	OUTSIDE	UNO	UNLESS NOTED OTHERWISE
		\	VAROR RAPPIER
PL	PROPERTY LINE	VB VERT	VAPOR BARRIER VERTICAL
PLAS	PLASTER	VENI	VERIFY
PLYWD	PLYWOOD	VII	V LT (III T
PSF PT	PER SQUARE FOOT PRESSURE TREATED	W/	WITH
PVMT	PAVEMENT	W/O	WITHOUT
		WD WF	WOOD WIDE FLANGE
		wh WH	WATER HEATER
		WP	WATER REALER WATERPROOFING
		V V I	WATER DECICE DADDIED

WEATHER-RESISTIVE BARRIER

WEIGHT

GENERAL NOTES:

- 1. SEE ROADWAY AND PAVEMENT MARKING PLANS FOR CURBS, SIDEWALK, AND STRIPPING DESIGN.
- 2. SEE GRADING AND DRAINAGE PLANS FOR STORMWATER IMPROVEMENTS.
- 3. SEE ELECTRICAL PLANS FOR POWER SERVICE CONNECTION DESIGN.
- 4. SEE ITS PLANS FOR COMMUNICATIONS SERVICE CONNECTION DESIGN.
- 5. SEE UTILITY PLANS FOR UTILITY CONNECTION DESIGN.
- 6. DO NOT SCALE THE DRAWINGS.
- 7. DIMENSIONS ARE TO GRID LINES OR THE FACE OF STRUCTURE (CONCRETE FOUNDATION, CONCRETE WALL, OR COLUMN) UNLESS OTHERWISE NOTED.
- 8. REPETITIVE FEATURES ARE OFTEN DRAWN OR REFERENCED ONLY ONCE AND SHALL BE COMPLETED PROVIDED AS IF
- 9. 3D VIEWS ARE PROVIDED FOR REFERENCE INFORMATION AND ARE SUPPLEMENTAL INFORMATION IN CONJUNCTION WITH OTHER CONTRACT DOCUMENTS. MATERIALS, FINISHES, AND THE EXTENT OF STATION AMENITIES WILL BE DEVELOPED IN THE NEXT SUBMISSION.
- 10. PLATFORM SLOPES AND SLOPED WALKWAY SLOPES SHALL COMPLY WITH THE MAXIMUM REQUIREMENTS IN PLATFORM PROTOTYPE PLANS. FINAL GRADING SHALL BE FURTHER DEVELOPED WITH CIVIL DURING FINAL DESIGN.

MONTGOMERY COUNTY DEPARTMENT OF TRANSPORTATION

SYMBOLS:	
STATION	AMENITIES
SYMBOL	DESCRIPTION
	STATION MARKER
	LEAN RAIL
	TVM MACHINE
	MEDIA DISPLAY/ AD PANEL
	BENCH
	CARD READER
	MOSAIC ART PAVER
	WINDSCREEN
	GUARD RAIL
	TACTILE PAVER
	OPTIONAL PLANTER
	TRASH /RECYCLING RECEPTACLES
	OPTIONAL
	WINDSCREEN
	OPTIONAL BENCH
DRAWING REF SHEET REF	SECTION MARKER
DRAWING REF SHEET REF	ELEVATION MARKER

AR-01

DATE: DECEMBER 2022

SHEET <u>806</u> of <u>887</u>

MD 355 BUS RAPID TRANSIT (BRT)

ARCHITECTURAL

GENERAL NOTES, LEGEND,

AND ABBREVIATIONS

]				DIVISION OF TRANSPORTATION ENGINE GAITHERSBURG, MARYLAND	ERING	MD 355 Bl
		NO.	REVISION	DA	ATE B	RECOMMENDED FOR APPROVAL Y		A GENEF
GROUP 5 15th Street – Suite 800	PROFESSIONAL CERTIFICATION: I HEREBY CERTIFY THAT THESE DOCUMENTS WERE PREPARED					Chief, Design Section APPROVED	Date	AN
shington DC 20005 USA 703 836 9600 group.com	OR APPROVED BY ME, AND THAT I AM A DULY LICENSED PROFESSIONAL ENGINEER UNDER THE LAWS OF THE STATE OF MARYLAND.					Chief, Division of Transportation Engineering	Date	SCALE : NTS
noup.com	LICENSE NO: EXPIRATION DATE:					Designed by : Drawn by :	Checked by :	Project No. : <u>502005</u>

STATION INVENTORY

DIRECTION	STATION NAME	SEGMENT	CROSS STREET	RUNNINGWAY TYPE	LOCATION WITHIN RUNNINGWAY	LOCATION AT INTERSECTION	PLATFORM PROTOTYP
	BETHESDA METRO STATION	1	ELM ST	TBD	TBD	TBD	PROTOTYPE 2
	WEST VIRIGINA AVENUE	1	WEST VIRGINIA AVE	MIXED-TRAFFIC	SIDE	TBD	PROTOTYPE 1
	MEDICAL CENTER METRO	1	SOUTH DR	MIXED-TRAFFIC	SIDE	TBD	PROTOTYPE 1
	GROSVENOR METRO	2	TUCKERMAN LN	MIXED-TRAFFIC	SIDE (IN EXISTING BUS TURNOUT)	N/A (ADJACENT TO METRO STN)	PROTOTYPE 2
	SECURITY LANE	2	SECURITY LN	CENTER	SIDE (CENTER OF RUNNING WAY)	FARSIDE	PROTOTYPE 3
	WHITE FLINT METRO	2	OLD GEORGETOWN RD	CENTER	SIDE (CENTER OF RUNNING WAY)	FARSIDE	PROTOTYPE 3
	BOU AVENUE	2	BOU AVE	CENTER	SIDE (CENTER OF RUNNING WAY)	FARSIDE	PROTOTYPE 3
	TWNBROOK METRO	2	HALPINE RD	CENTER	SIDE (CENTER OF RUNNING WAY)	FARSIDE	PROTOTYPE 3
	EDMONSTON DRIVE	2	EDMONSTON DR	CENTER	SIDE (CENTER OF RUNNING WAY)	FARSIDE	PROTOTYPE 3
	MOUNT VERNON PLACE	2	MOUNT VERNON PL	CENTER	SIDE (CENTER OF RUNNING WAY)	NEARSIDE	PROTOTYPE 3
	ROCKVILLE METRO	3	PARK RD/MIDDLE LN	MIXED-TRAFFIC	SIDE	FARSIDE	PROTOTYPE 6
NORTHBOUND	MONTGOMERY COLLEGE - ROCKVILLE	3	MANNAKEE ST	CENTER	TBD	TBD	PROTOTYPE 1
	SHADY GROVE METRO	4	TBD	TBD	TBD	TBD	PROTOTYPE 1
	SOUTH WESTLAND DRIVE	4	SOUTH WESTLAND DR	CENTER	SIDE (CENTER OF RUNNING WAY)	FARSIDE	PROTOTYPE 3
	EDUCATION BLVD	4	EDUCATION BLVD	CENTER	SIDE (CENTER OF RUNNING WAY)	FARSIDE	PROTOTYPE 3
	CEDARAVENUE	5	CEDARAVE	CENTER	SIDE (CENTER OF RUNNING WAY)		PROTOTYPE 3
	ODENDHAL AVENUE	5	ODENDHAL AVE	MIXED-TRAFFIC	SIDE	NEARSIDE	PROTOTYPE 2
	LAKEFOREST TRANSIT CENTER	6	LOST KNIFE RD	MIXED-TRAFFIC	N/A (AT EXISTING TRANSIT CTR)	N.A (AT EXISTING TRANSIT CENTER)	PROTOTYPE 1
	CHRISTOPHER AVENUE	6	CHRISTOPHER AVE	MIXED-TRAFFIC	TBD	TBD	PROTOTYPE 1
	WATKINS MILL ROAD	6	WATKINS MILL RD	CENTER	TBD	TBD	PROTOTYPE 3
	GUNNERS BRANCH ROAD	6	GUNNERS BRANCH RD	CENTER	TBD	TBD	PROTOTYPE 3
	OBSERVATION DRIVE	7	HOLY CROSS HOSPITAL	MIXED-TRAFFIC	TBD	TBD	PROTOTYPE 1
	GIOLDENROD LANE	7	MONTGOMERY COLLEGE GERMANTOWN	MIXED-TRAFFIC	TBD	TBD	PROTOTYPE 1
	GIOLDENROD LANE	7	MONTGOMERY COLLEGE GERMANTOWN	MIXED-TRAFFIC	TBD	TBD	PROTOTYPE 1
	OBSERVATION DRIVE	7	HOLY CROSS HOSPITAL	MIXED-TRAFFIC	TBD	TBD	PROTOTYPE 1
	GUNNERS BRANCH ROAD	6	GUNNERS BRANCH RD	CENTER	TBD	TBD	PROTOTYPE 3
	WATKINS MILL ROAD	6	WATKINS MILL RD	CENTER	TBD	TBD	PROTOTYPE 3
	CHRISTOPHER AVENUE	6	CHRISTOPHER AVE	MIXED-TRAFFIC	TBD	TBD	PROTOTYPE 1
	LAKEFOREST TRANSIT CENTER	6	LOST KNIFE RD	MIXED-TRAFFIC	N/A (AT EXISTING TRANSIT CTR)	N.A (AT EXISTING TRANSIT CENTER)	PROTOTYPE 1
	ODENDHAL AVENUE	5	ODENDHAL AVE	MIXED-TRAFFIC	SIDE	NEARSIDE	PROTOTYPE 2
	CEDARAVENUE	5	CEDARAVE	CENTER	SIDE (CENTER OF RUNNING WAY)		PROTOTYPE 3
	EDUCATION BLVD	4	EDUCATION BLVD	CENTER	SIDE (CENTER OF RUNNING WAY)	FARSIDE	PROTOTYPE 3
	SOUTH WESTLAND DRIVE	4	SOUTH WESTLAND DR	CENTER	SIDE (CENTER OF RUNNING WAY)	FARSIDE	PROTOTYPE 3
	SHADY GROVE METRO	4	TBD	TBD	TBD	TBD	PROTOTYPE 1
SOUTHBOUND	MONTGOMERY COLLEGE - ROCKVILLE	3	MANNAKEE ST	CENTER	TBD	TBD	PROTOTYPE 3
	ROCKVILLE METRO	3	PARK RD/MIDDLE LN	MIXED-TRAFFIC	SIDE	FARSIDE	PROTOTYPE 5
	MOUNT VERNON PLACE	2	MOUNT VERNON PL	CENTER	SIDE (CENTER OF RUNNING WAY)	NEARSIDE	PROTOTYPE 3
	EDMONSTON DRIVE	2	EDMONSTON DR	CENTER	SIDE (CENTER OF RUNNING WAY)	FARSIDE	PROTOTYPE 3
	TWNBROOK METRO	2	HALPINE RD	CENTER	SIDE (CENTER OF RUNNING WAY)	FARSIDE	PROTOTYPE 3
	BOU AVENUE	2	BOU AVE	CENTER	SIDE (CENTER OF RUNNING WAY)	FARSIDE	PROTOTYPE 3
	WHITE FLINT METRO	2	OLD GEORGETOWN RD	CENTER	SIDE (CENTER OF RUNNING WAY)	FARSIDE	PROTOTYPE 3
	SECURITY LANE	2	SECURITY LN	CENTER	SIDE (CENTER OF RUNNING WAY)	FARSIDE	PROTOTYPE 3
	GROSVENOR METRO	2	TUCKERMAN LN	MIXED-TRAFFIC	SIDE (IN EXISTING BUS TURNOUT)	N/A (ADJACENT TO METRO STN)	PROTOTYPE 2
	MEDICAL CENTER METRO	1	SOUTH DR	MIXED-TRAFFIC	SIDE	TBD	PROTOTYPE 1
	WEST VIRIGINA AVENUE	1	WEST VIRGINIA AVE	MIXED-TRAFFIC	SIDE	TBD	PROTOTYPE 1
	BETHESDA METRO STATION	1	ELM ST	TBD	TBD	TBD	PROTOTYPE 2

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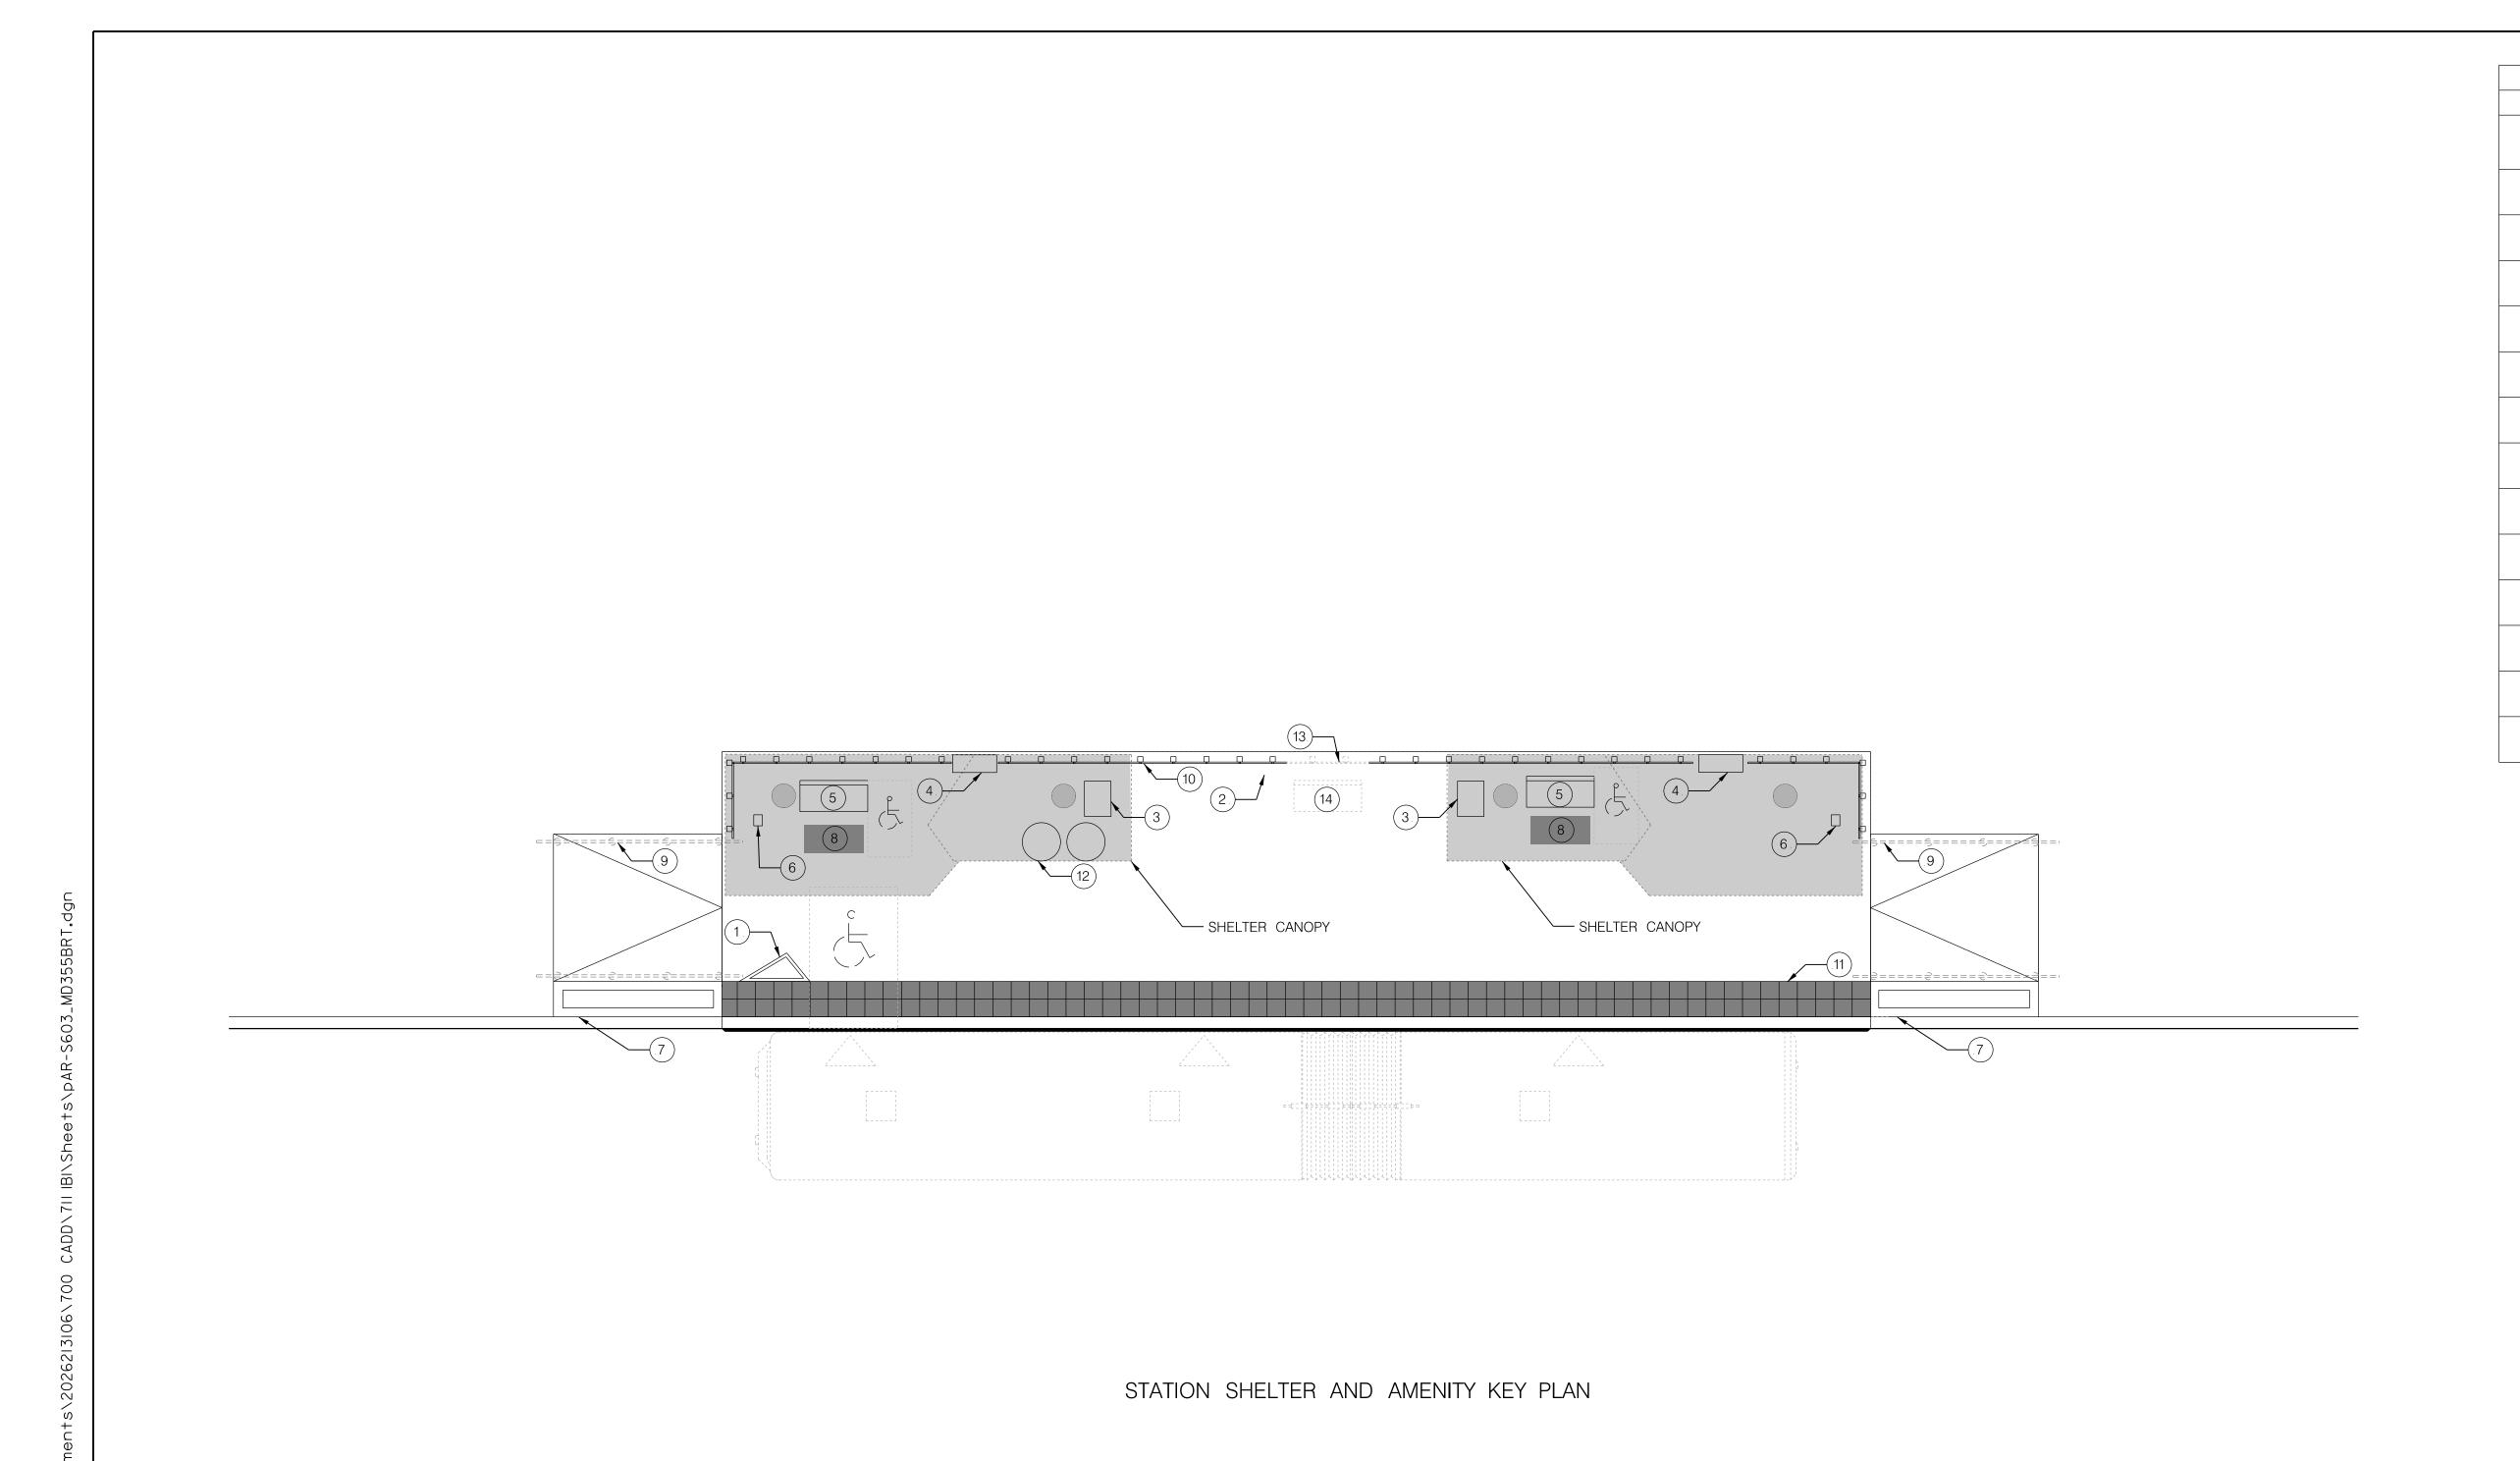
PROFESSIONAL CERTIFICATION:
I HEREBY CERTIFY THAT THESE DOCUMENTS WERE PREPARED OR APPROVED BY ME, AND THAT I AM A DULY LICENSED PROFESSIONAL ENGINEER UNDER THE LAWS OF THE STATE OF MARYLAND. LICENSE NO: ___ EXPIRATION DATE: ___

DATE BY REVISION Designed by :_____ Drawn by :____

MONTGOMERY COUNTY DEPARTMENT OF TRANSPORTATION MD 355 BUS RAPID TRANSIT (BRT) DIVISION OF TRANSPORTATION ENGINEERING GAITHERSBURG, MARYLAND ARCHITECTURAL RECOMMENDED FOR APPROVAL STATION LIST Chief, Design Section APPROVED SCALE : NTS DATE: DECEMBER 2022 Chief, Division of Transportation Engineering Project No. : 502005 SHEET 807 of 887

Checked by : _

AR-02



AR-03

MONTGOMERY COUNTY DEPARTMENT OF TRANSPORTATION DIVISION OF TRANSPORTATION ENGINEERING GAITHERSBURG, MARYLAND RECOMMENDED FOR APPROVAL DATE BY Chief, Design Section APPROVED Chief, Division of Transportation Engineering

Checked by : _

Designed by :_____ Drawn by :____

MD 355 BUS RAPID TRANSIT (BRT) ARCHITECTURAL STATION SHELTER AND AMENITIES

STATION AMENITIES

DESCRIPTION

STATION MARKER

LEAN RAIL

TVM

MEDIA DISPLAY/ AD PANEL

BENCH

CARD READER

OPTIONAL PLANTER

MOSAIC ART PAVER

GUARD RAIL

(MEDIAN PLATFORM)

WINDSCREEN

TACTILE PAVER

TRASH / RECYCLING

RECEPTACLES OPTIONAL

WINDSCREEN

OPTIONAL

BENCH

SYMBOL

KEY NOTE

3

4

5

6

8

9

(10)

11

(12)

(13)

14

SCALE : 3/16" = 1'-0" DATE : DECEMBER 2022 SHEET 808 of 887 Project No. : 502005

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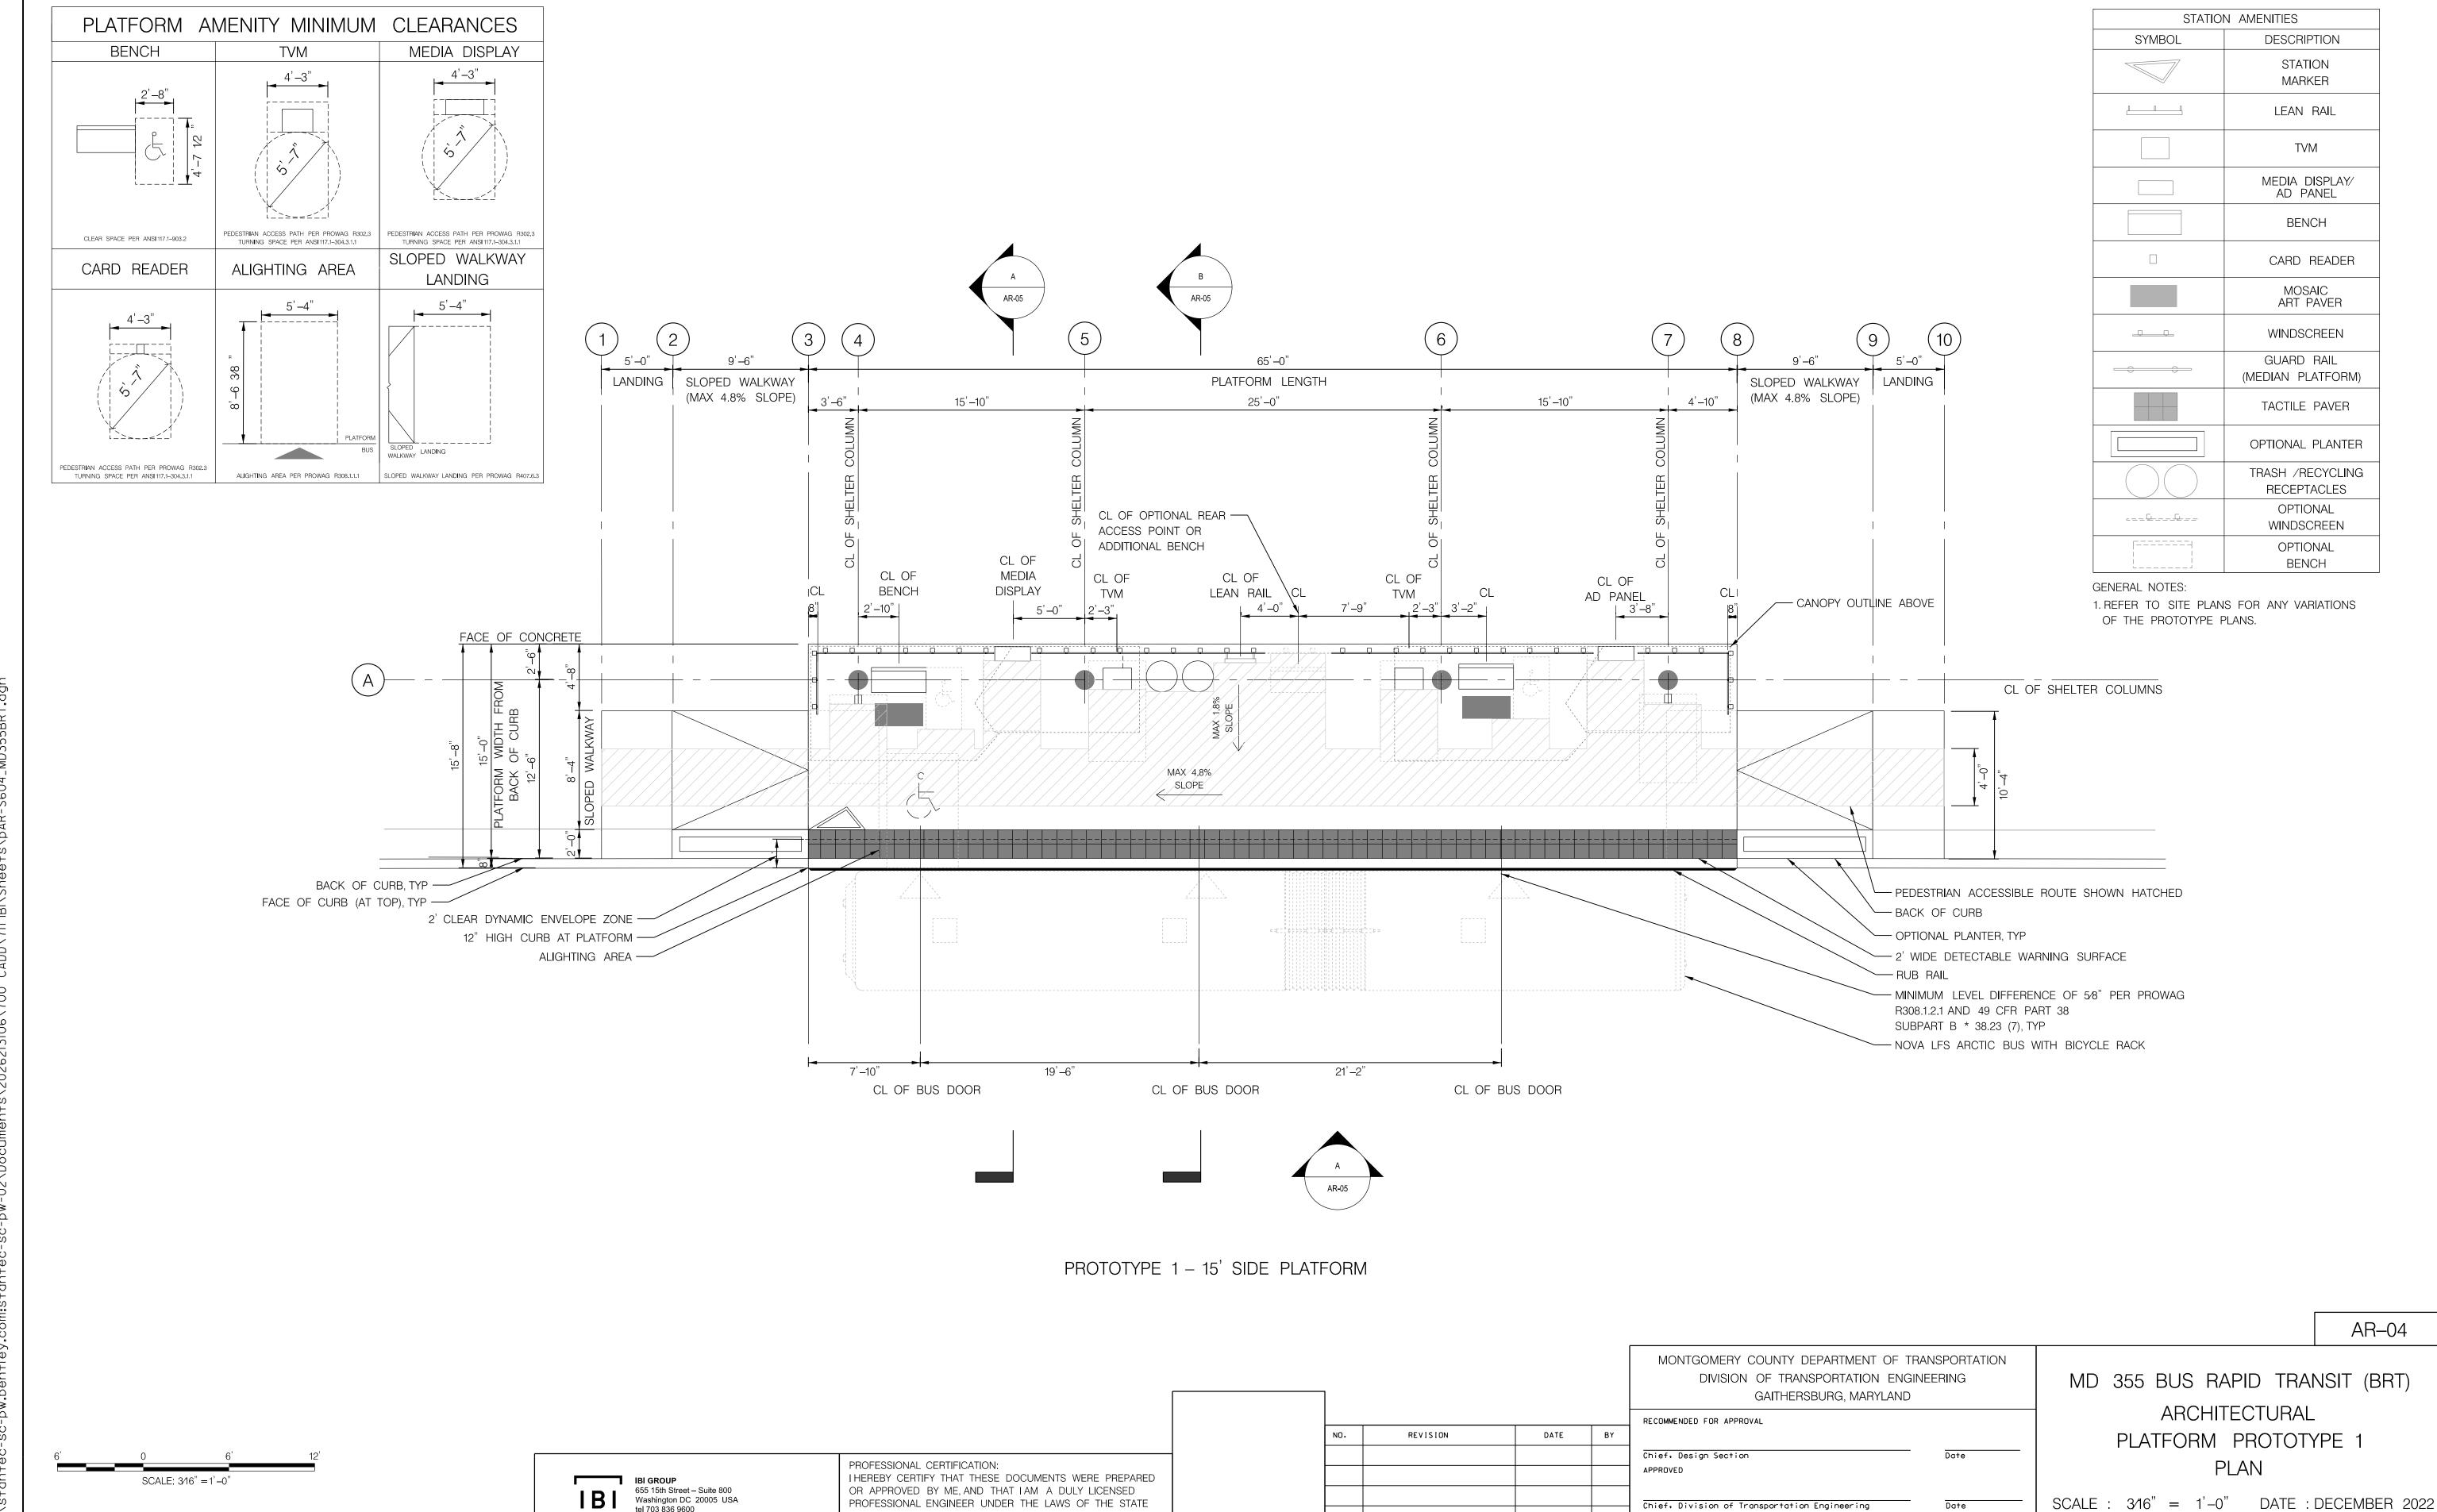
PROFESSIONAL CERTIFICATION: OF MARYLAND. LICENSE NO: _____

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___ EXPIRATION DATE: _

REVISION

SCALE: 3/16" = 1'-0"



SHEET <u>809</u> of <u>887</u>

Project No. :502005

Checked by : _


Designed by :_____ Drawn by :____

OF MARYLAND.

LICENSE NO: _____ EXPIRATION DATE: _

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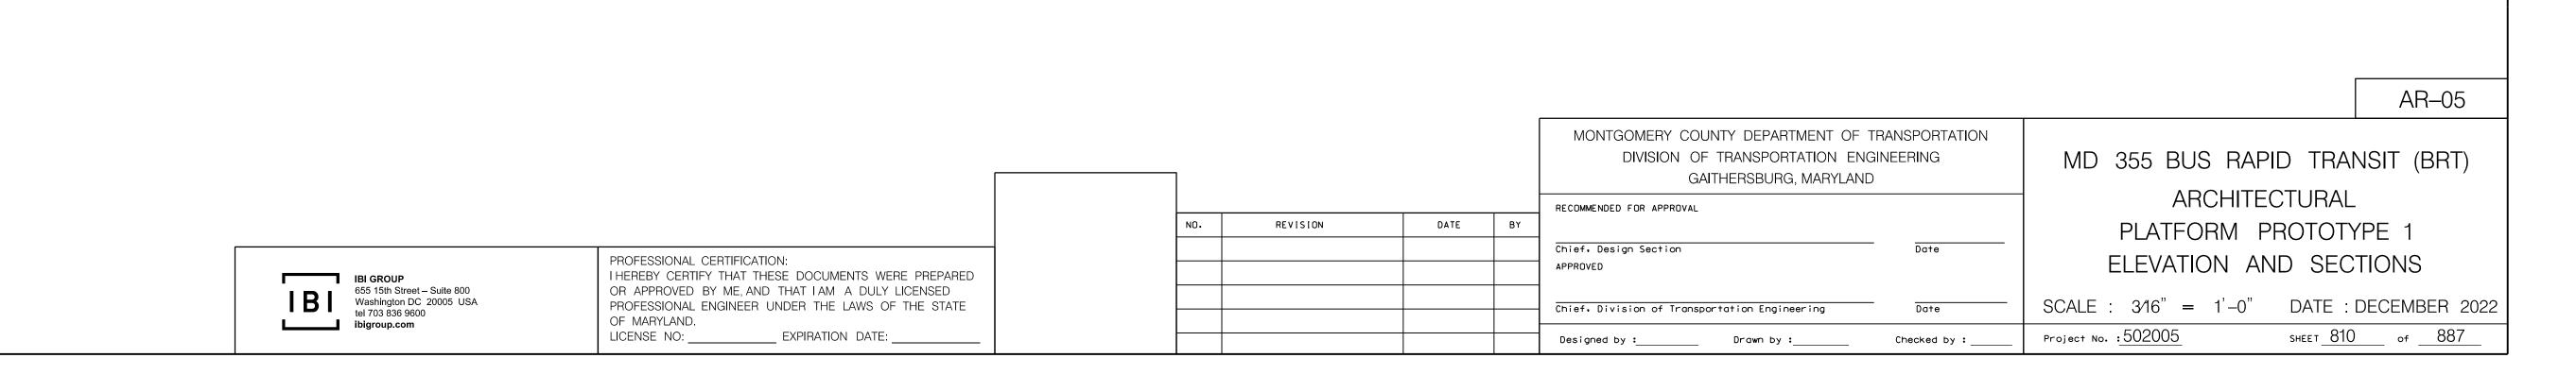
2022-11-03

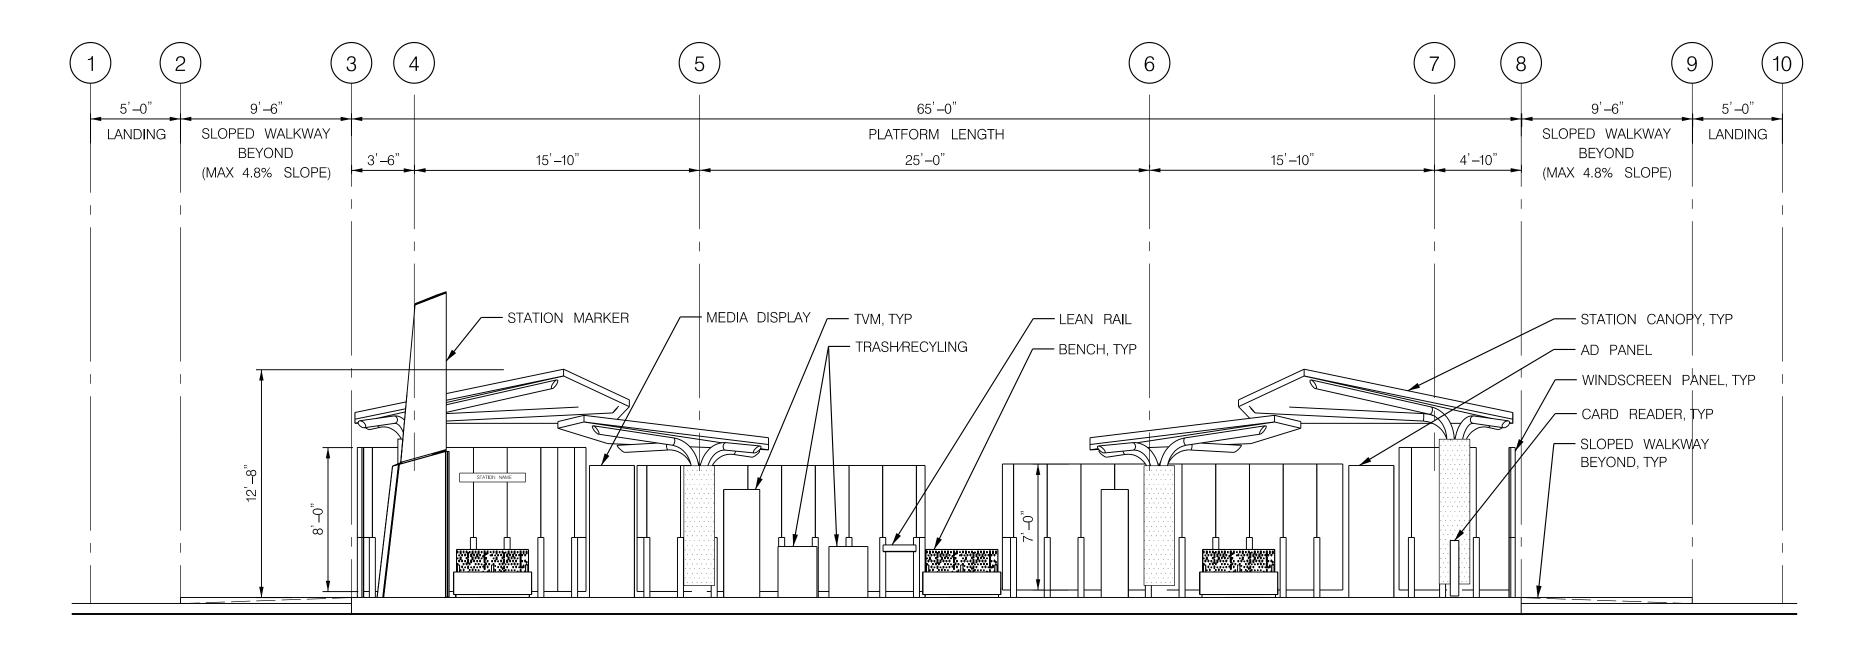

ELEVATION A




SECTION A SECTION B




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2022-11-03

SCALE: 3/16" = 1'-0"

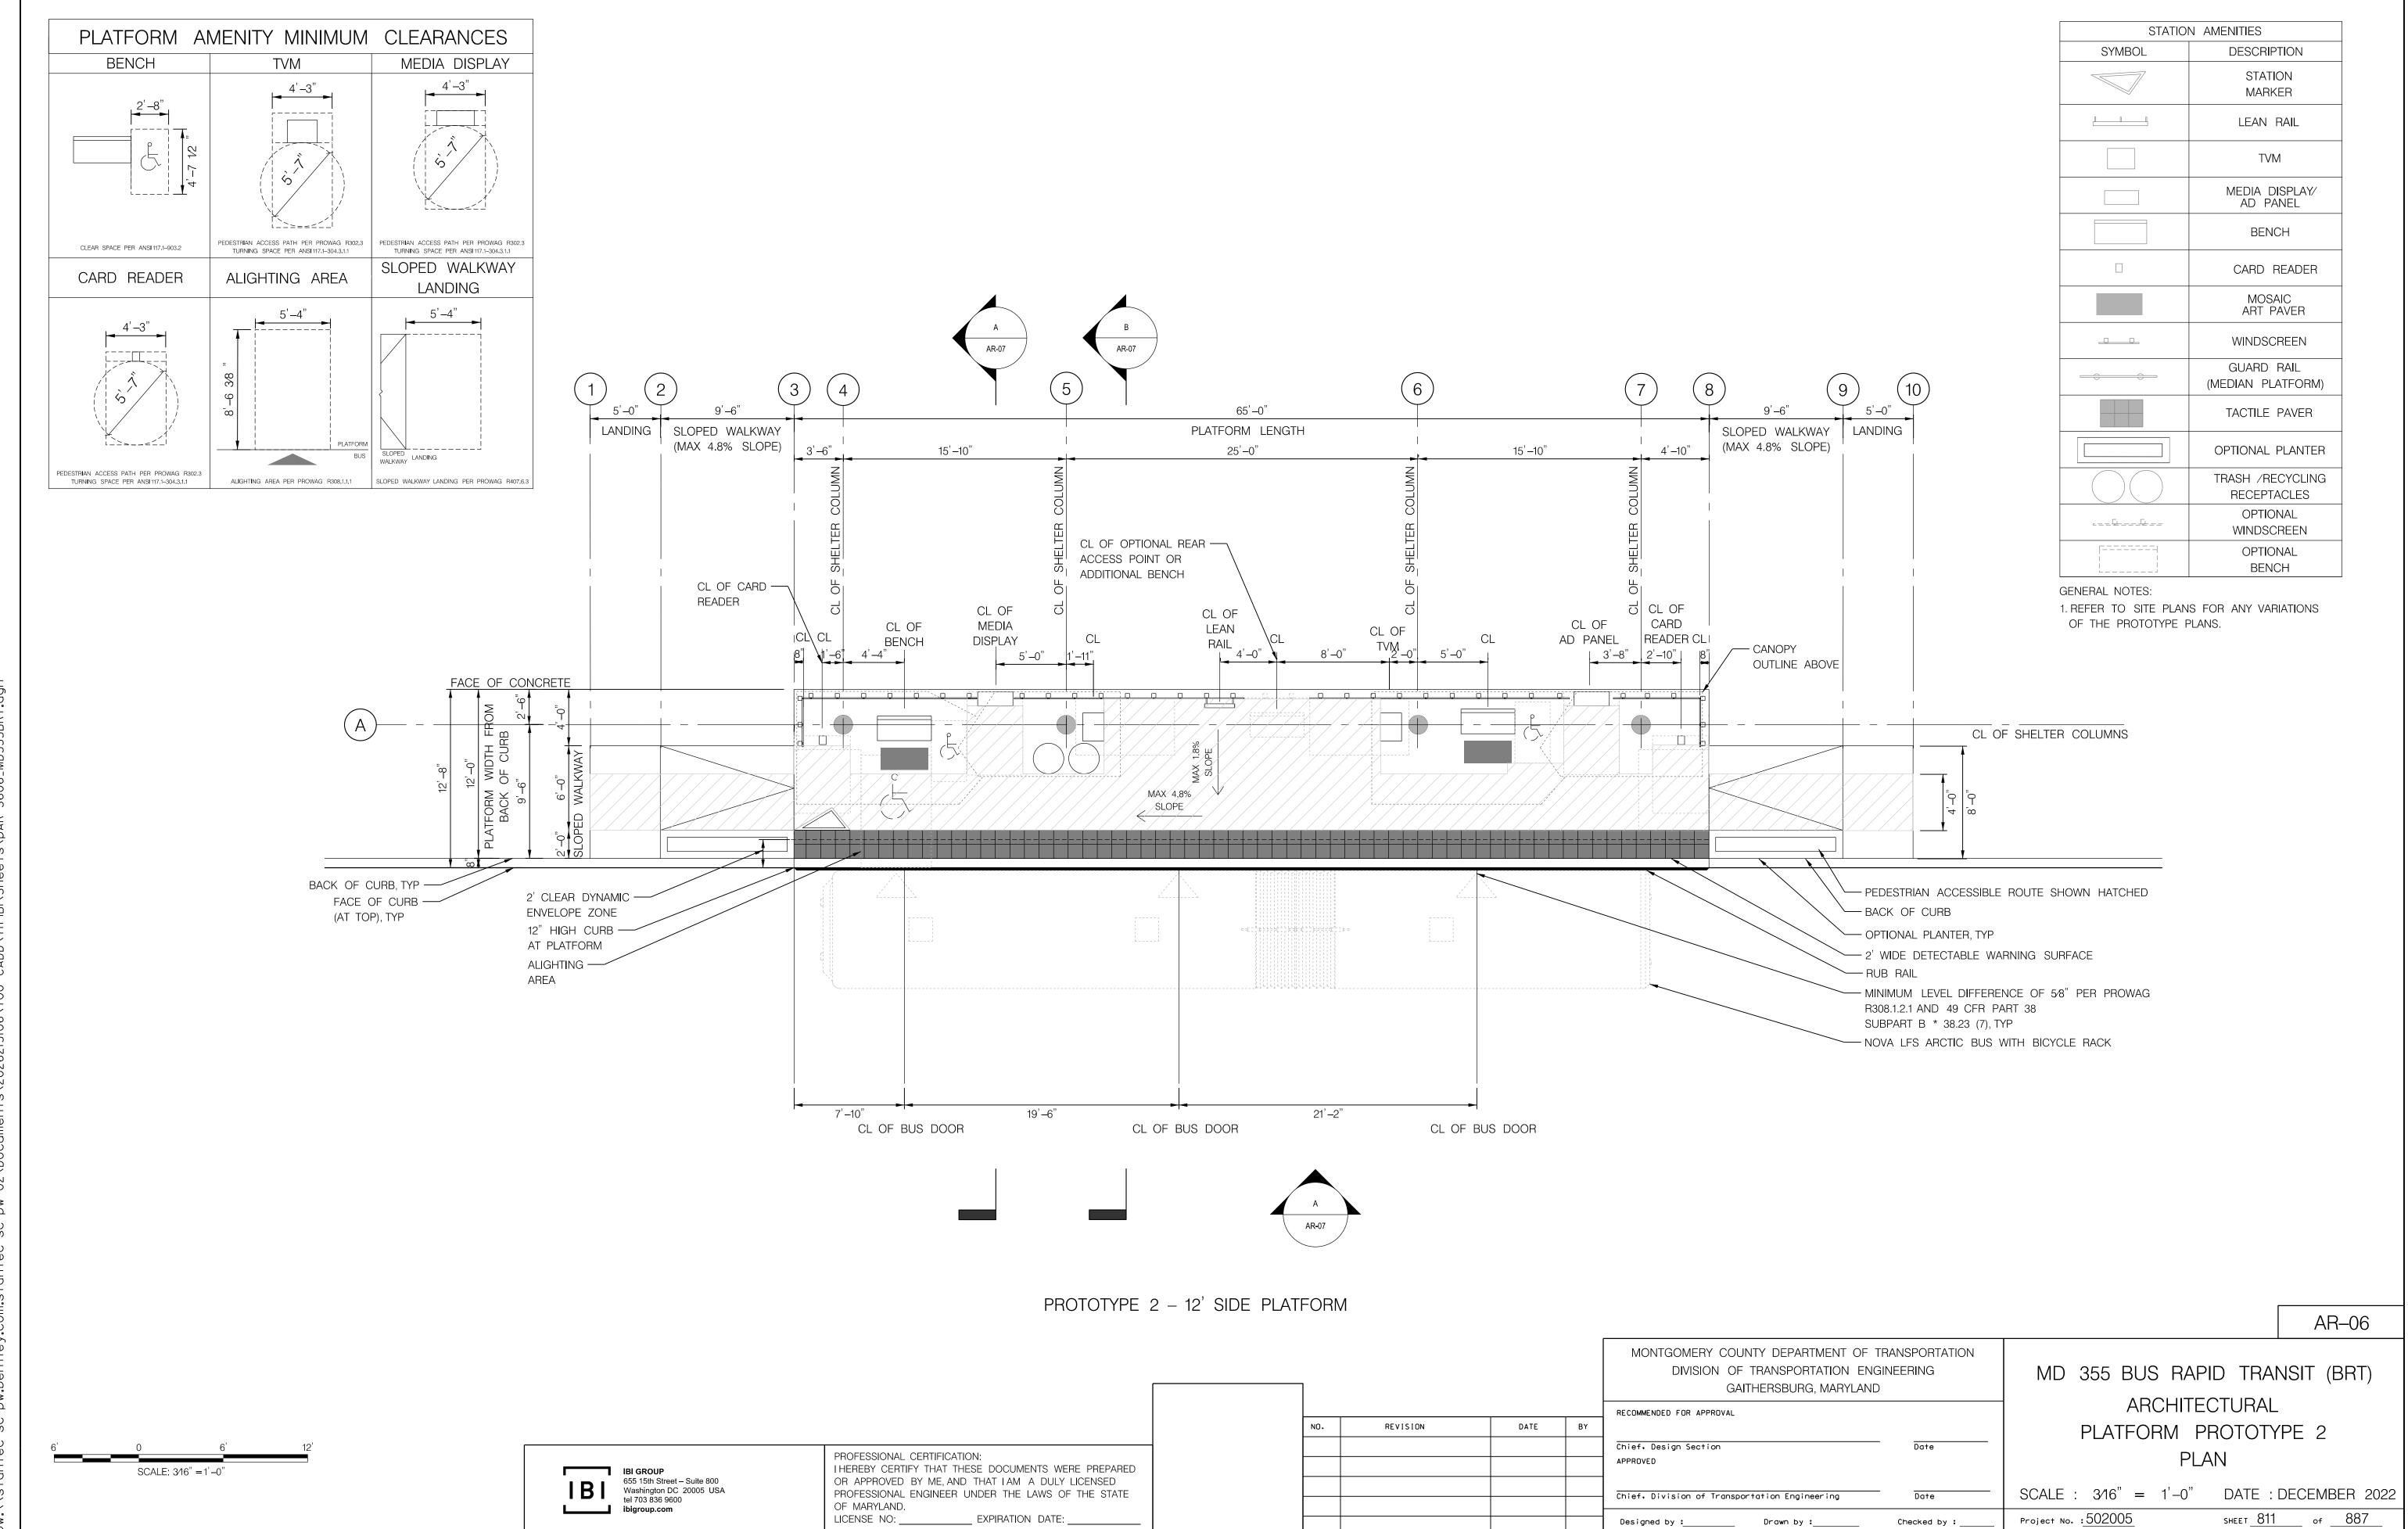

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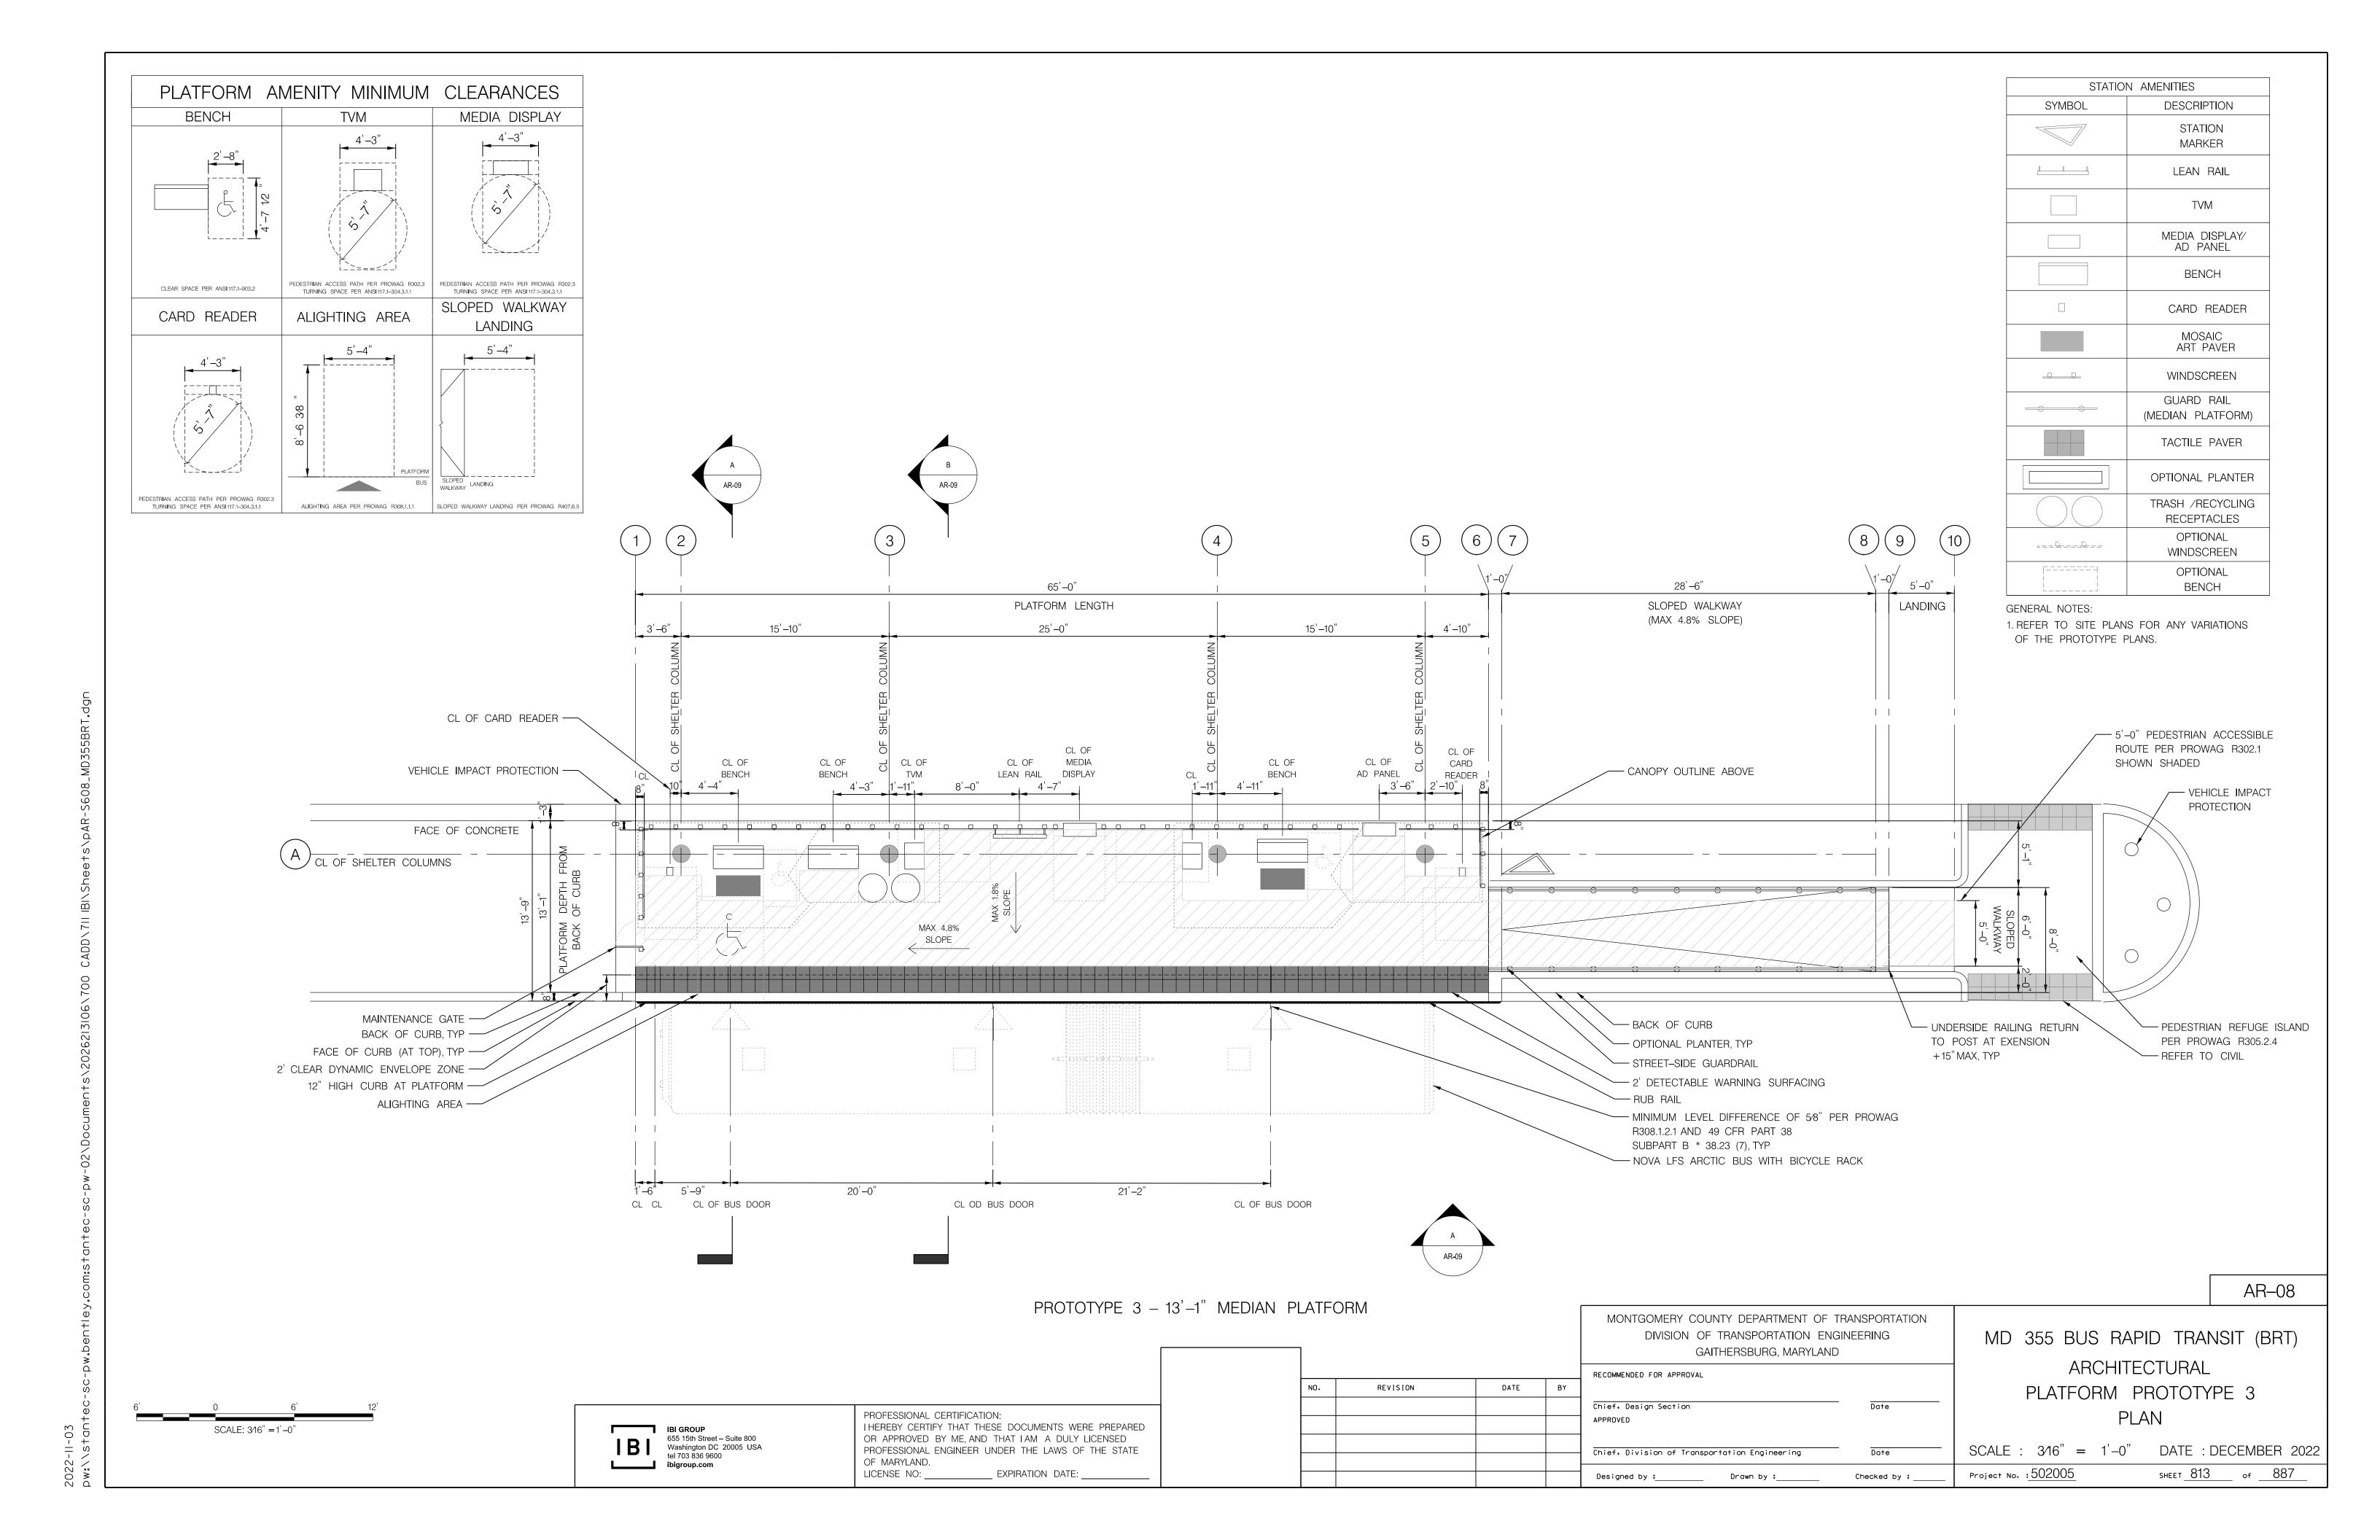



ELEVATION A

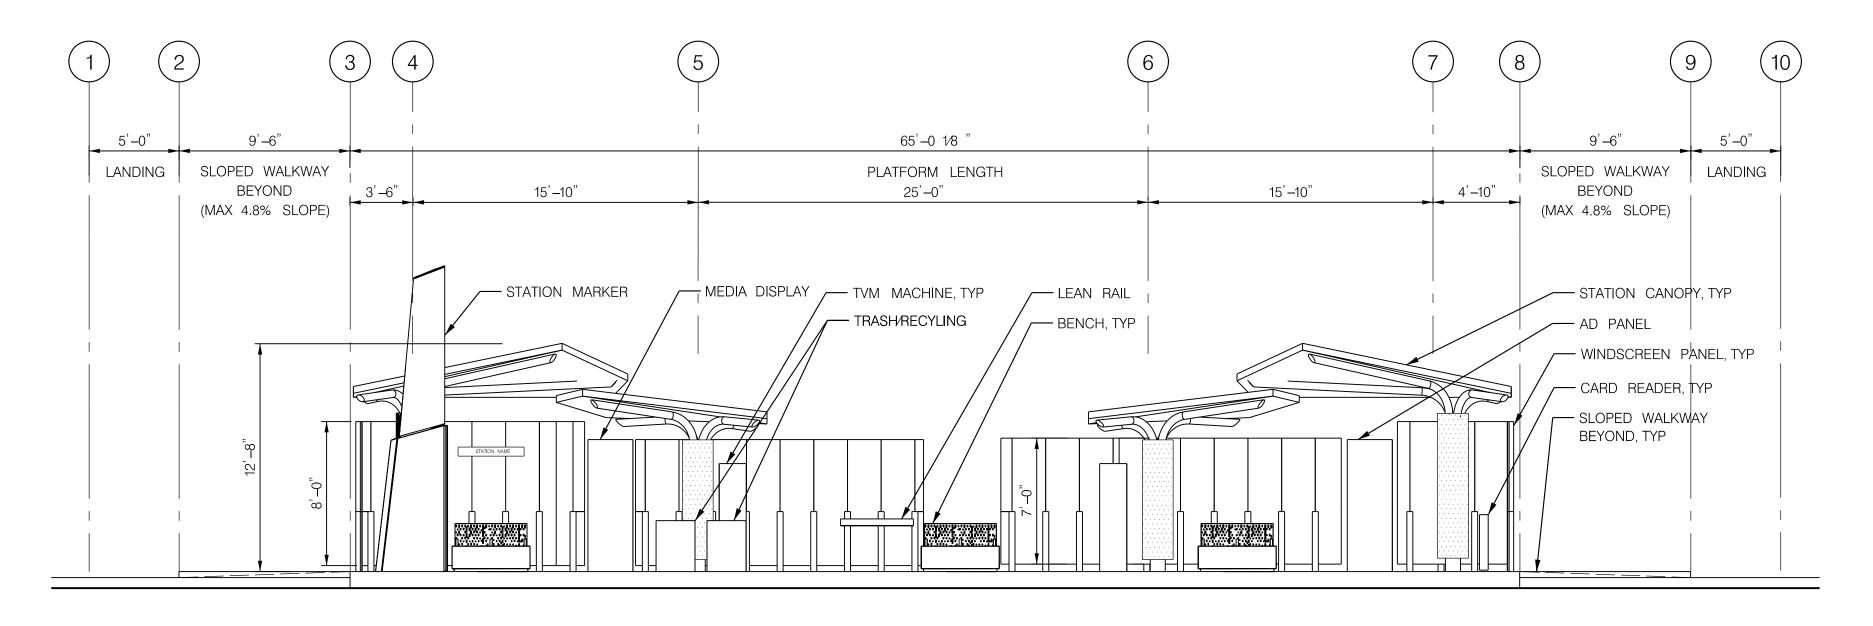

SCALE: 3/16" = 1'-0"

SECTION A AR-07 MONTGOMERY COUNTY DEPARTMENT OF TRANSPORTATION MD 355 BUS RAPID TRANSIT (BRT) DIVISION OF TRANSPORTATION ENGINEERING GAITHERSBURG, MARYLAND ARCHITECTURAL RECOMMENDED FOR APPROVAL DATE BY REVISION PLATFORM PROTOTYPE 2 Chief, Design Section PROFESSIONAL CERTIFICATION: I HEREBY CERTIFY THAT THESE DOCUMENTS WERE PREPARED ELEVATION AND SECTIONS APPROVED IBI GROUP
655 15th Street – Suite 800
Washington DC 20005 USA
tel 703 836 9600 OR APPROVED BY ME, AND THAT I AM A DULY LICENSED SCALE : 3/16" = 1'-0" DATE : DECEMBER 2022 PROFESSIONAL ENGINEER UNDER THE LAWS OF THE STATE Chief. Division of Transportation Engineering OF MARYLAND. ibigroup.com SHEET <u>812</u> of <u>887</u> Project No. : 502005 LICENSE NO: ____ ___ EXPIRATION DATE: _ Designed by :_____ Drawn by :____ Checked by : _




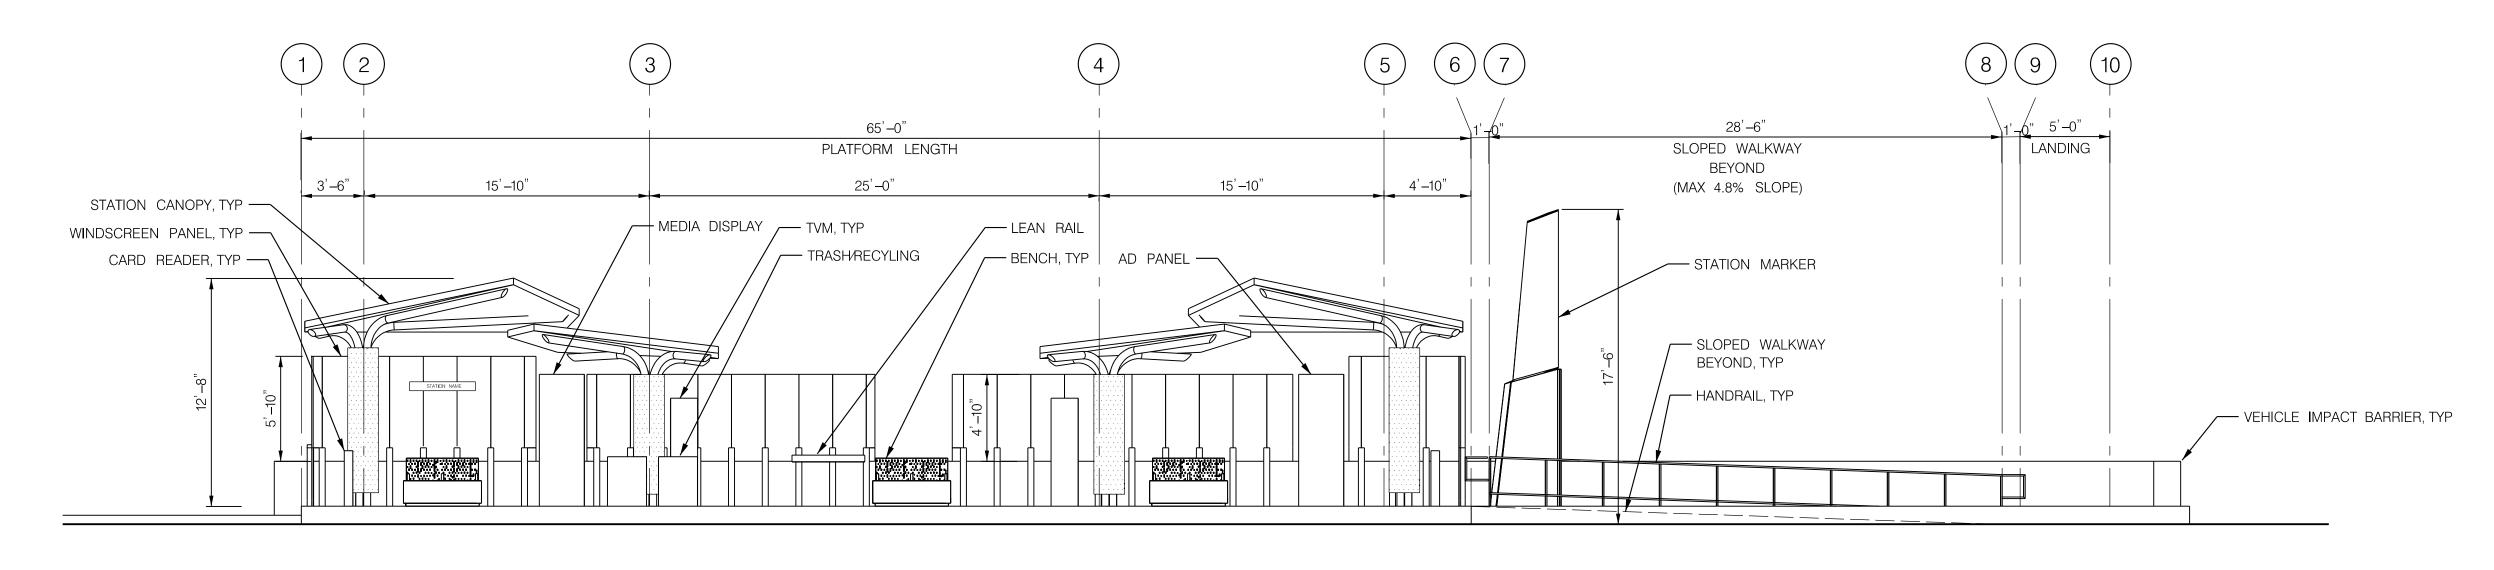


ELEVATION A



AR-09 MONTGOMERY COUNTY DEPARTMENT OF TRANSPORTATION MD 355 BUS RAPID TRANSIT (BRT) DIVISION OF TRANSPORTATION ENGINEERING GAITHERSBURG, MARYLAND ARCHITECTURAL RECOMMENDED FOR APPROVAL DATE BY REVISION PLATFORM PROTOTYPE 3 Chief, Design Section ELEVATION AND SECTIONS PROFESSIONAL CERTIFICATION: APPROVED THEREBY CERTIFY THAT THESE DOCUMENTS WERE PREPARED IBI GROUP 655 15th Street – Suite 800 Washington DC 20005 USA tel 703 836 9600 SCALE: 3/16" = 1'-0" OR APPROVED BY ME, AND THAT I AM A DULY LICENSED SCALE : 3/16" = 1'-0" DATE : DECEMBER 2022 PROFESSIONAL ENGINEER UNDER THE LAWS OF THE STATE Chief. Division of Transportation Engineering OF MARYLAND. ibigroup.com SHEET 814 of 887 Project No. : 502005 LICENSE NO: ___ __ EXPIRATION DATE: _ Designed by :_____ Drawn by :____ Checked by : _

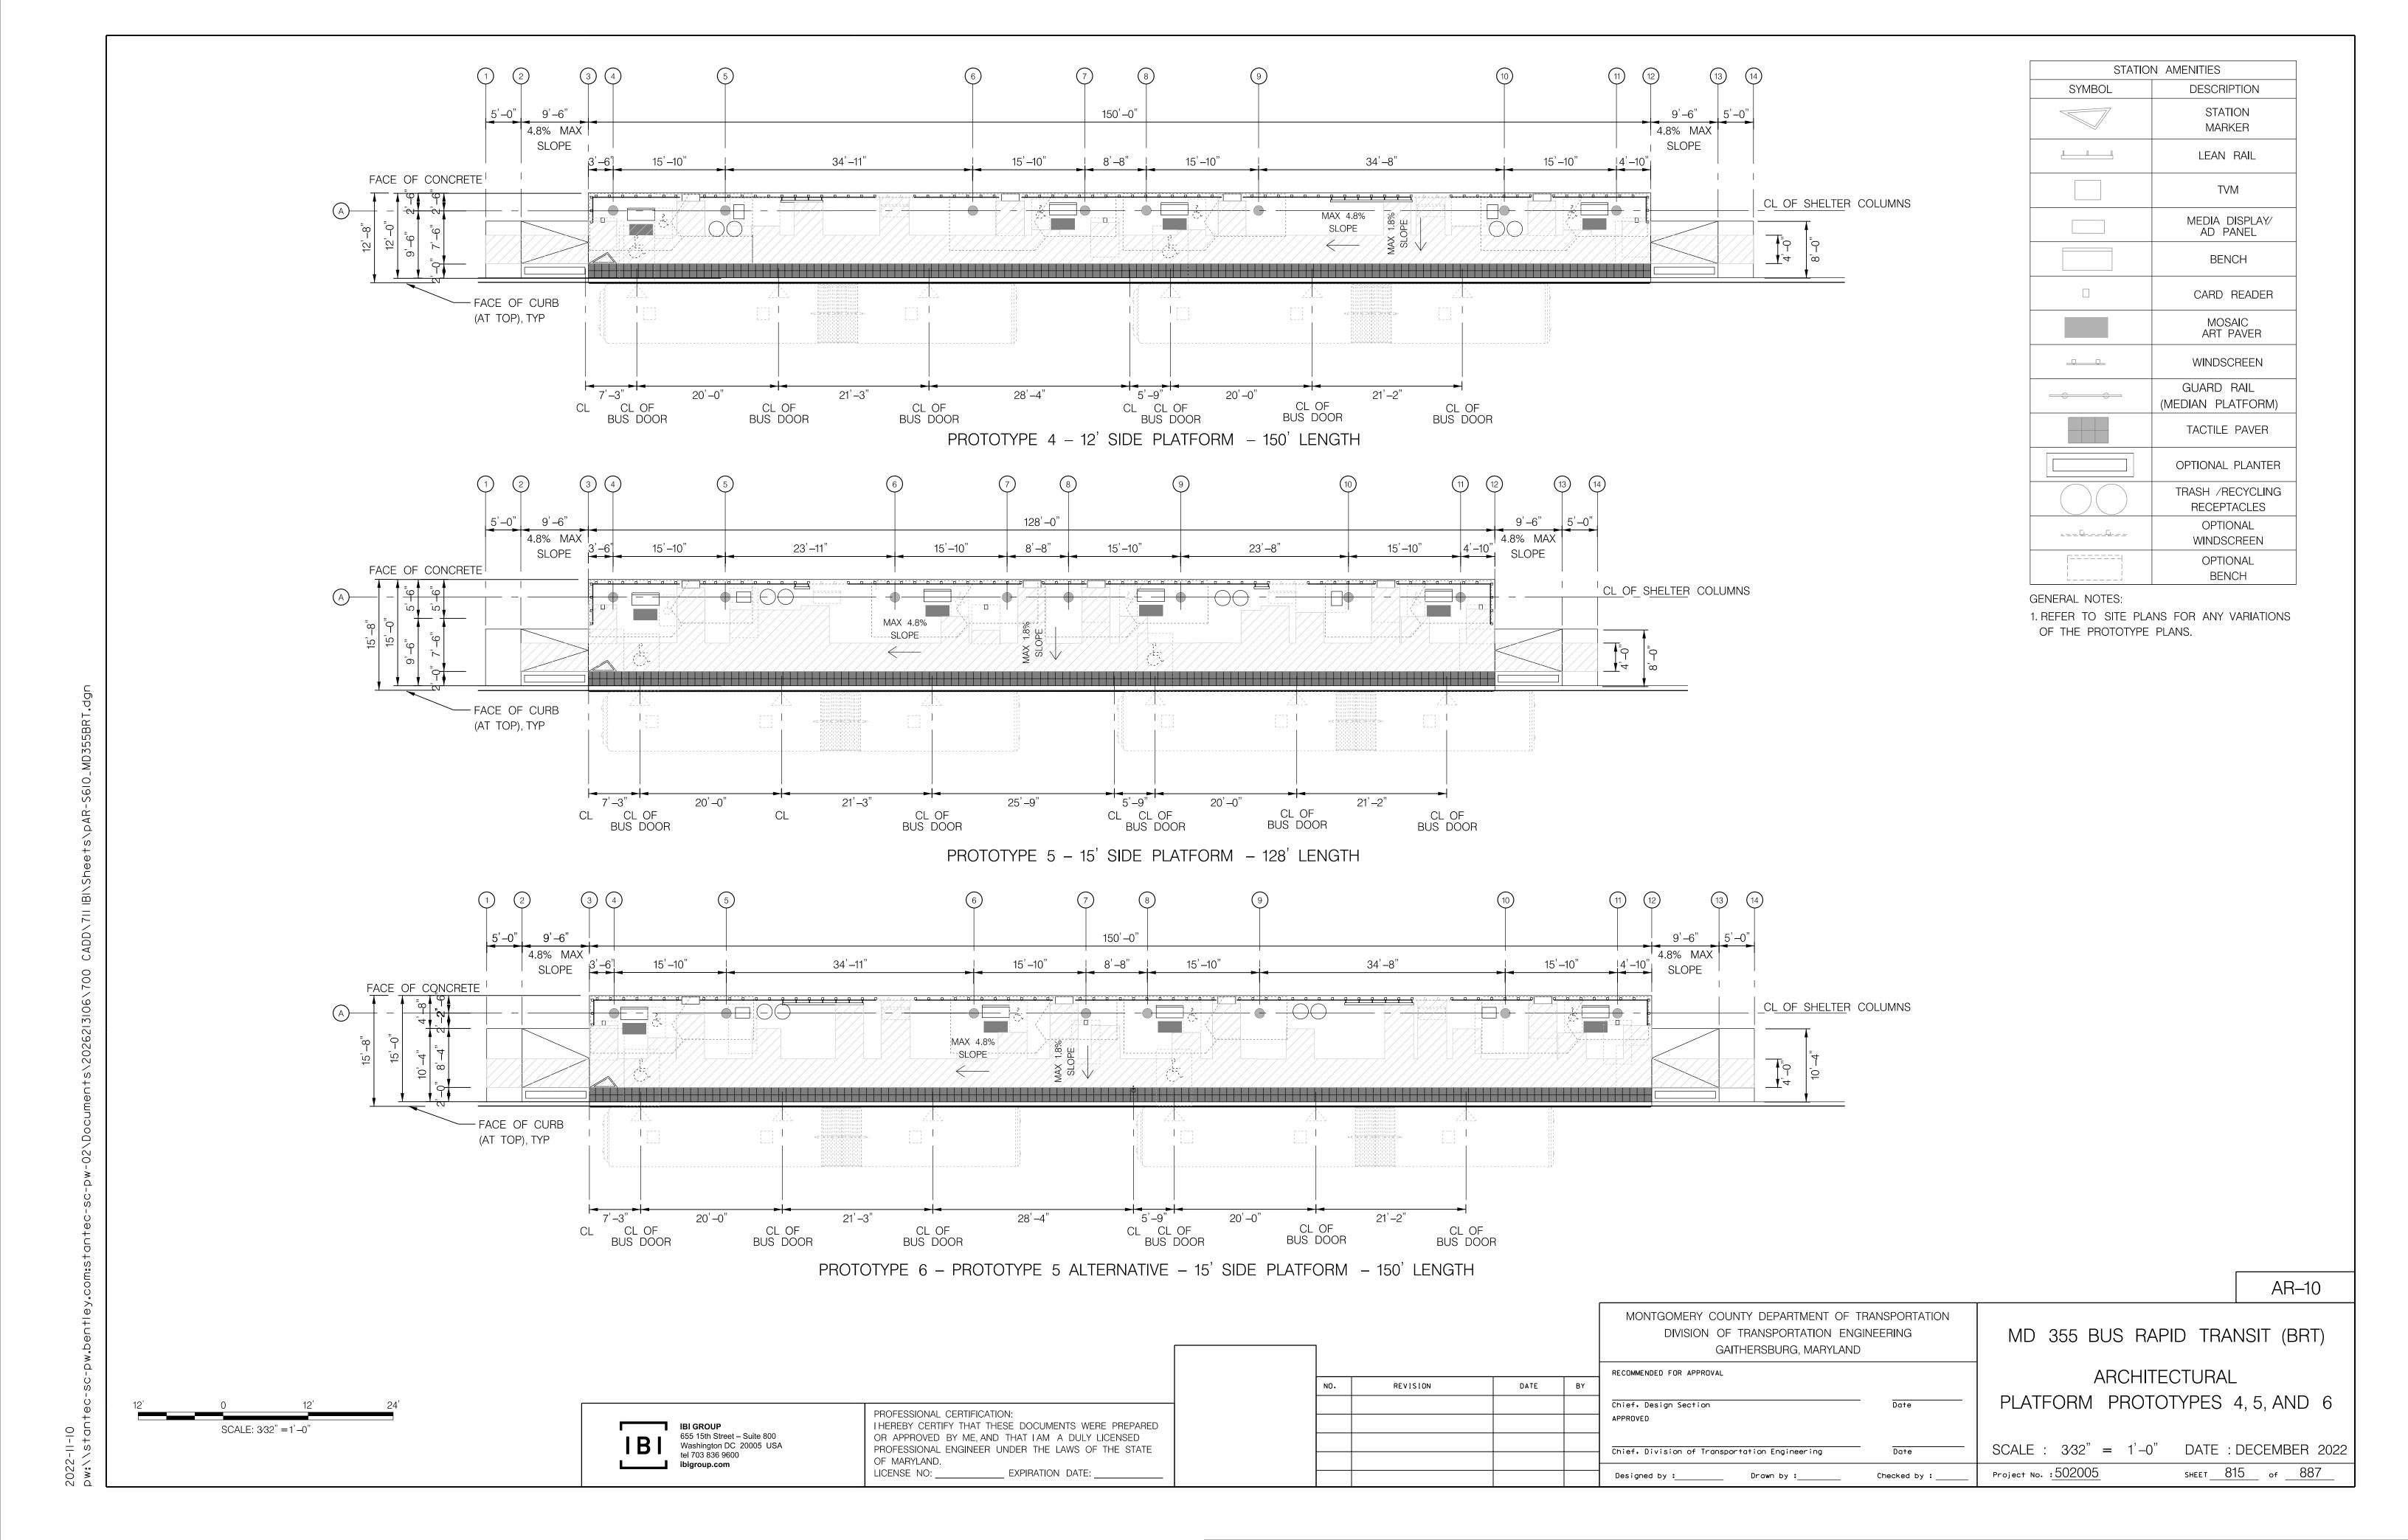

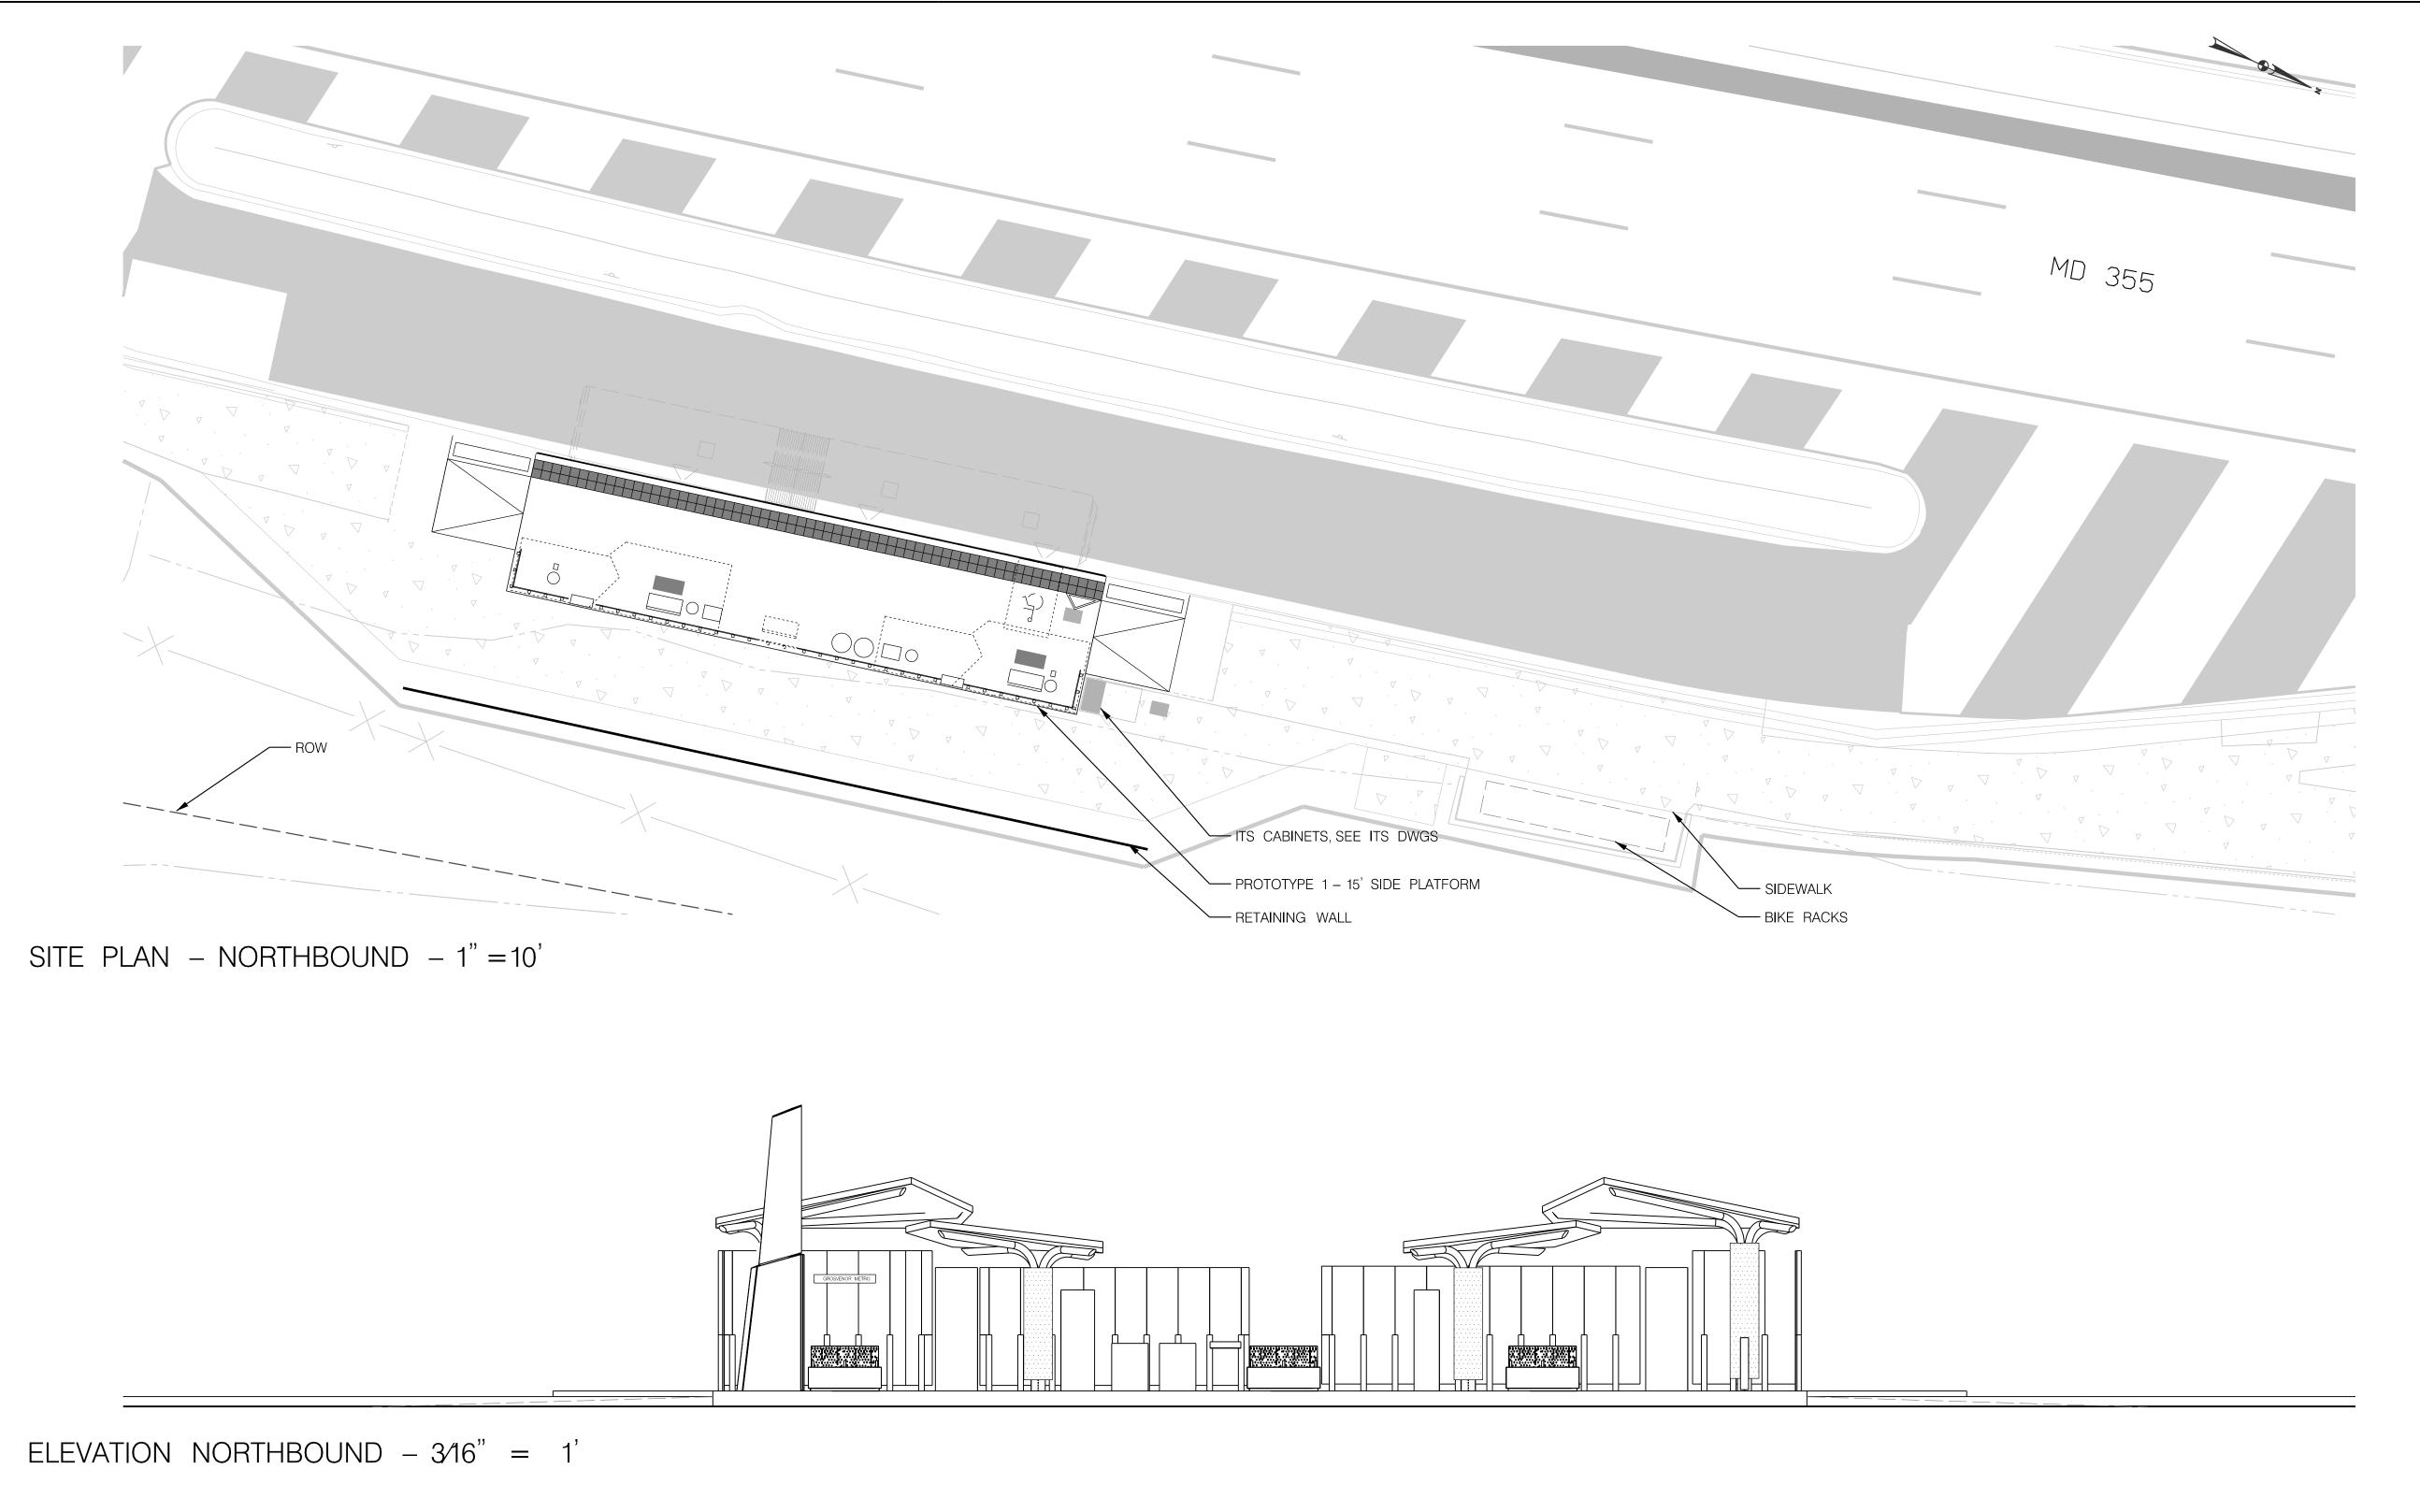

STATION AMENITIES SYMBOL DESCRIPTION STATION MARKER LEAN RAIL TVM MEDIA DISPLAY/ AD PANEL BENCH CARD READER MOSAIC ART PAVER WINDSCREEN GUARD RAIL (MEDIAN PLATFORM) TACTILE PAVER OPTIONAL PLANTER TRASH /RECYCLING RECEPTACLES OPTIONAL WINDSCREEN OPTIONAL BENCH

GENERAL NOTES: 1. ARCHITECTURAL SITE PLANS SHALL BE READ IN CONJUNCTION WITH THE PLATFORM PLANS AND ELEVATIONS.

2. THE PLATFORM SLOPES AND SLOPED WALKWAY SLOPES SHALL COMPLY WITH THE MAXIMUM REQUIREMENTS IN THE PLATFORM PROTOTYPE PLANS. FINAL GRADING SHALL BE FURTHER DEVELOPED WITH CIVIL DURING FINAL DESIGN.

MONTGOMERY COUNTY DEPARTMENT OF TRANSPORTATION DIVISION OF TRANSPORTATION ENGINEERING GAITHERSBURG, MARYLAND RECOMMENDED FOR APPROVAL DATE BY Chief, Design Section APPROVED Chief, Division of Transportation Engineering

Checked by : _

Designed by :_____ Drawn by :____

REVISION

MD 355 BUS RAPID TRANSIT (BRT) ARCHITECTURAL

AR-11

SITE PLAN AND ELEVATION SEG 2 GROSVENOR METRO


DATE: DECEMBER 2022 SCALE: VARIES SHEET 816 of 887 Project No. :502005

10'	0	10'	20'
	SCALE	: 1" =10'	
6'	0'	6'	12'
	SCALE: 3/	16" = 1'-0"	

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OF MARYLAND.




STATION AMENITIES SYMBOL DESCRIPTION STATION MARKER LEAN RAIL TVM MEDIA DISPLAY/ AD PANEL BENCH CARD READER MOSAIC ART PAVER WINDSCREEN GUARD RAIL (MEDIAN PLATFORM) TACTILE PAVER OPTIONAL PLANTER TRASH /RECYCLING RECEPTACLES OPTIONAL WINDSCREEN [-----OPTIONAL BENCH

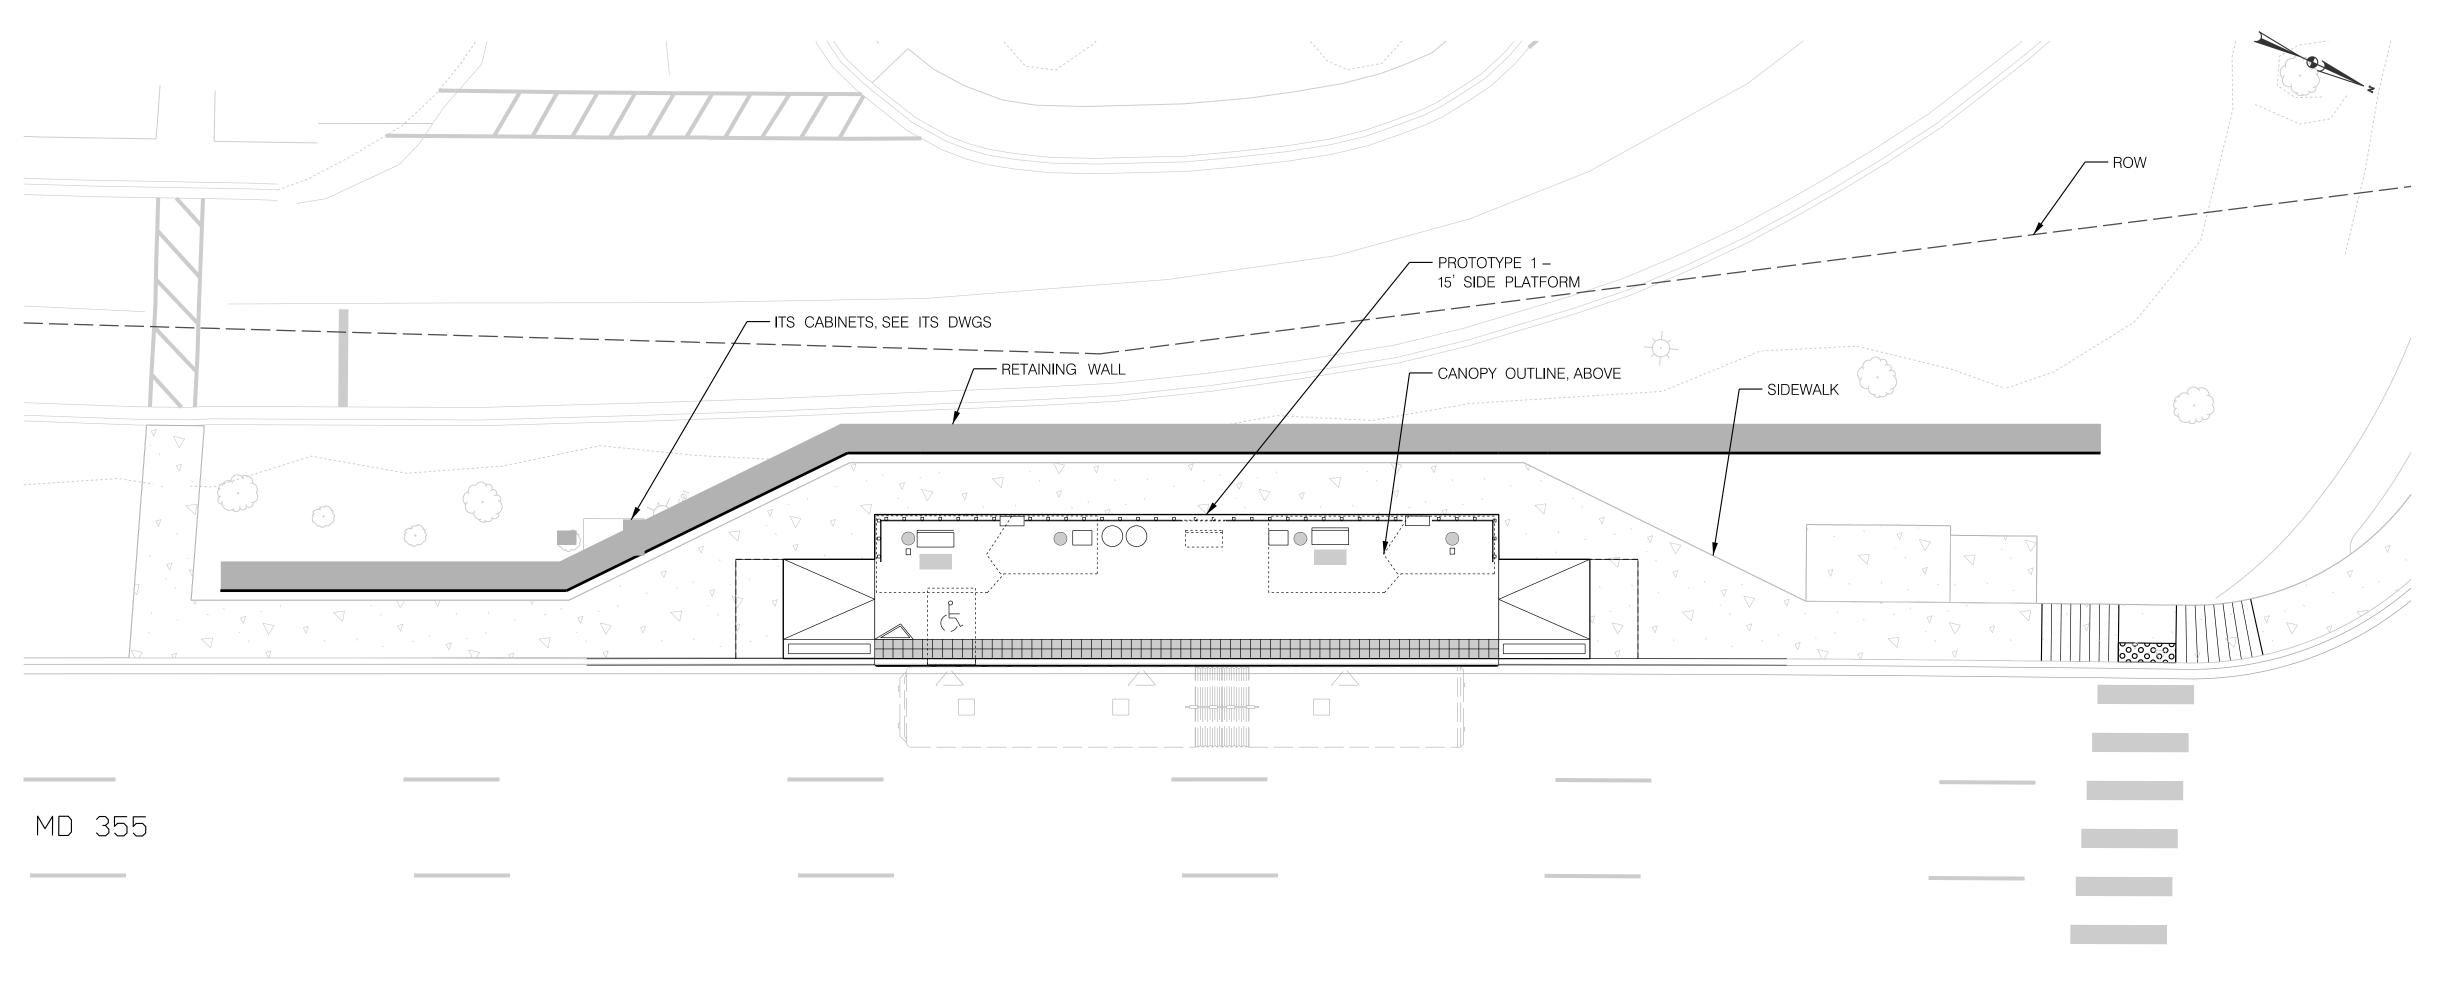GENERAL NOTES:

1. ARCHITECTURAL SITE PLANS SHALL BE READ IN CONJUNCTION WITH THE PLATFORM PLANS AND ELEVATIONS.

2. THE PLATFORM SLOPES AND SLOPED WALKWAY SLOPES SHALL COMPLY WITH THE MAXIMUM REQUIREMENTS IN THE PLATFORM PROTOTYPE PLANS. FINAL GRADING SHALL BE FURTHER DEVELOPED WITH CIVIL DURING FINAL DESIGN.

SITE PLAN - SOUTHBOUND - 1'' = 10'

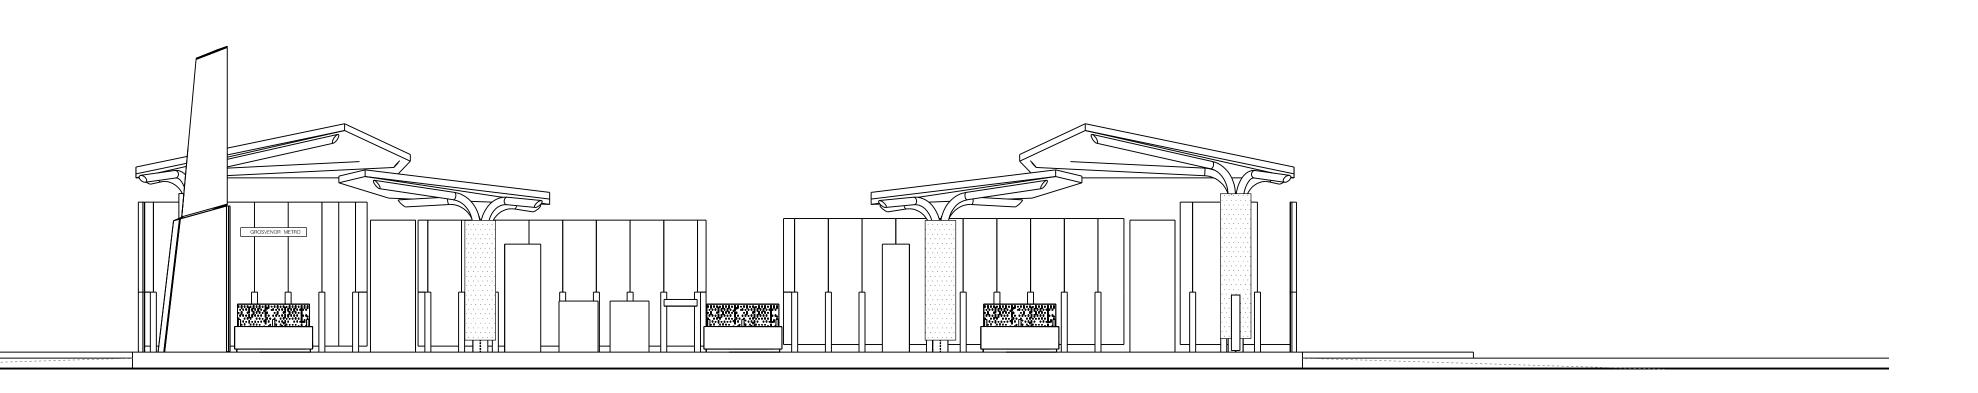

ELEVATION $- \frac{3}{16}$ " = 1

AR-12

SCALE: 1" = 10'

SCALE: 1" = 10'

SCALE: 3/16" = 1'-0"

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PROFESSIONAL ENGINEER UNDER THE LAWS OF THE STATE
OF MARYLAND.
LICENSE NO: ______ EXPIRATION DATE: ______

]				DIVISION OF TRANSPORTATION ENGINEERING GAITHERSBURG, MARYLAND	
NO.	REVISION	DATE	ВУ	RECOMMENDED FOR APPROVAL	
				Chief, Design Section Date APPROVED	-
				Chief, Division of Transportation Engineering Date	-
				Designed by : Drawn by : Checked by :	_

MONTGOMERY COUNTY DEPARTMENT OF TRANSPORTATION

MD 355 BUS RAPID TRANSIT (BRT)


ARCHITECTURAL

SITE PLAN AND ELEVATION

SEG 2 GROSVENOR METRO

 SCALE : VARIES
 DATE : DECEMBER 2022

 Project No. : 502005
 SHEET 817 of 887

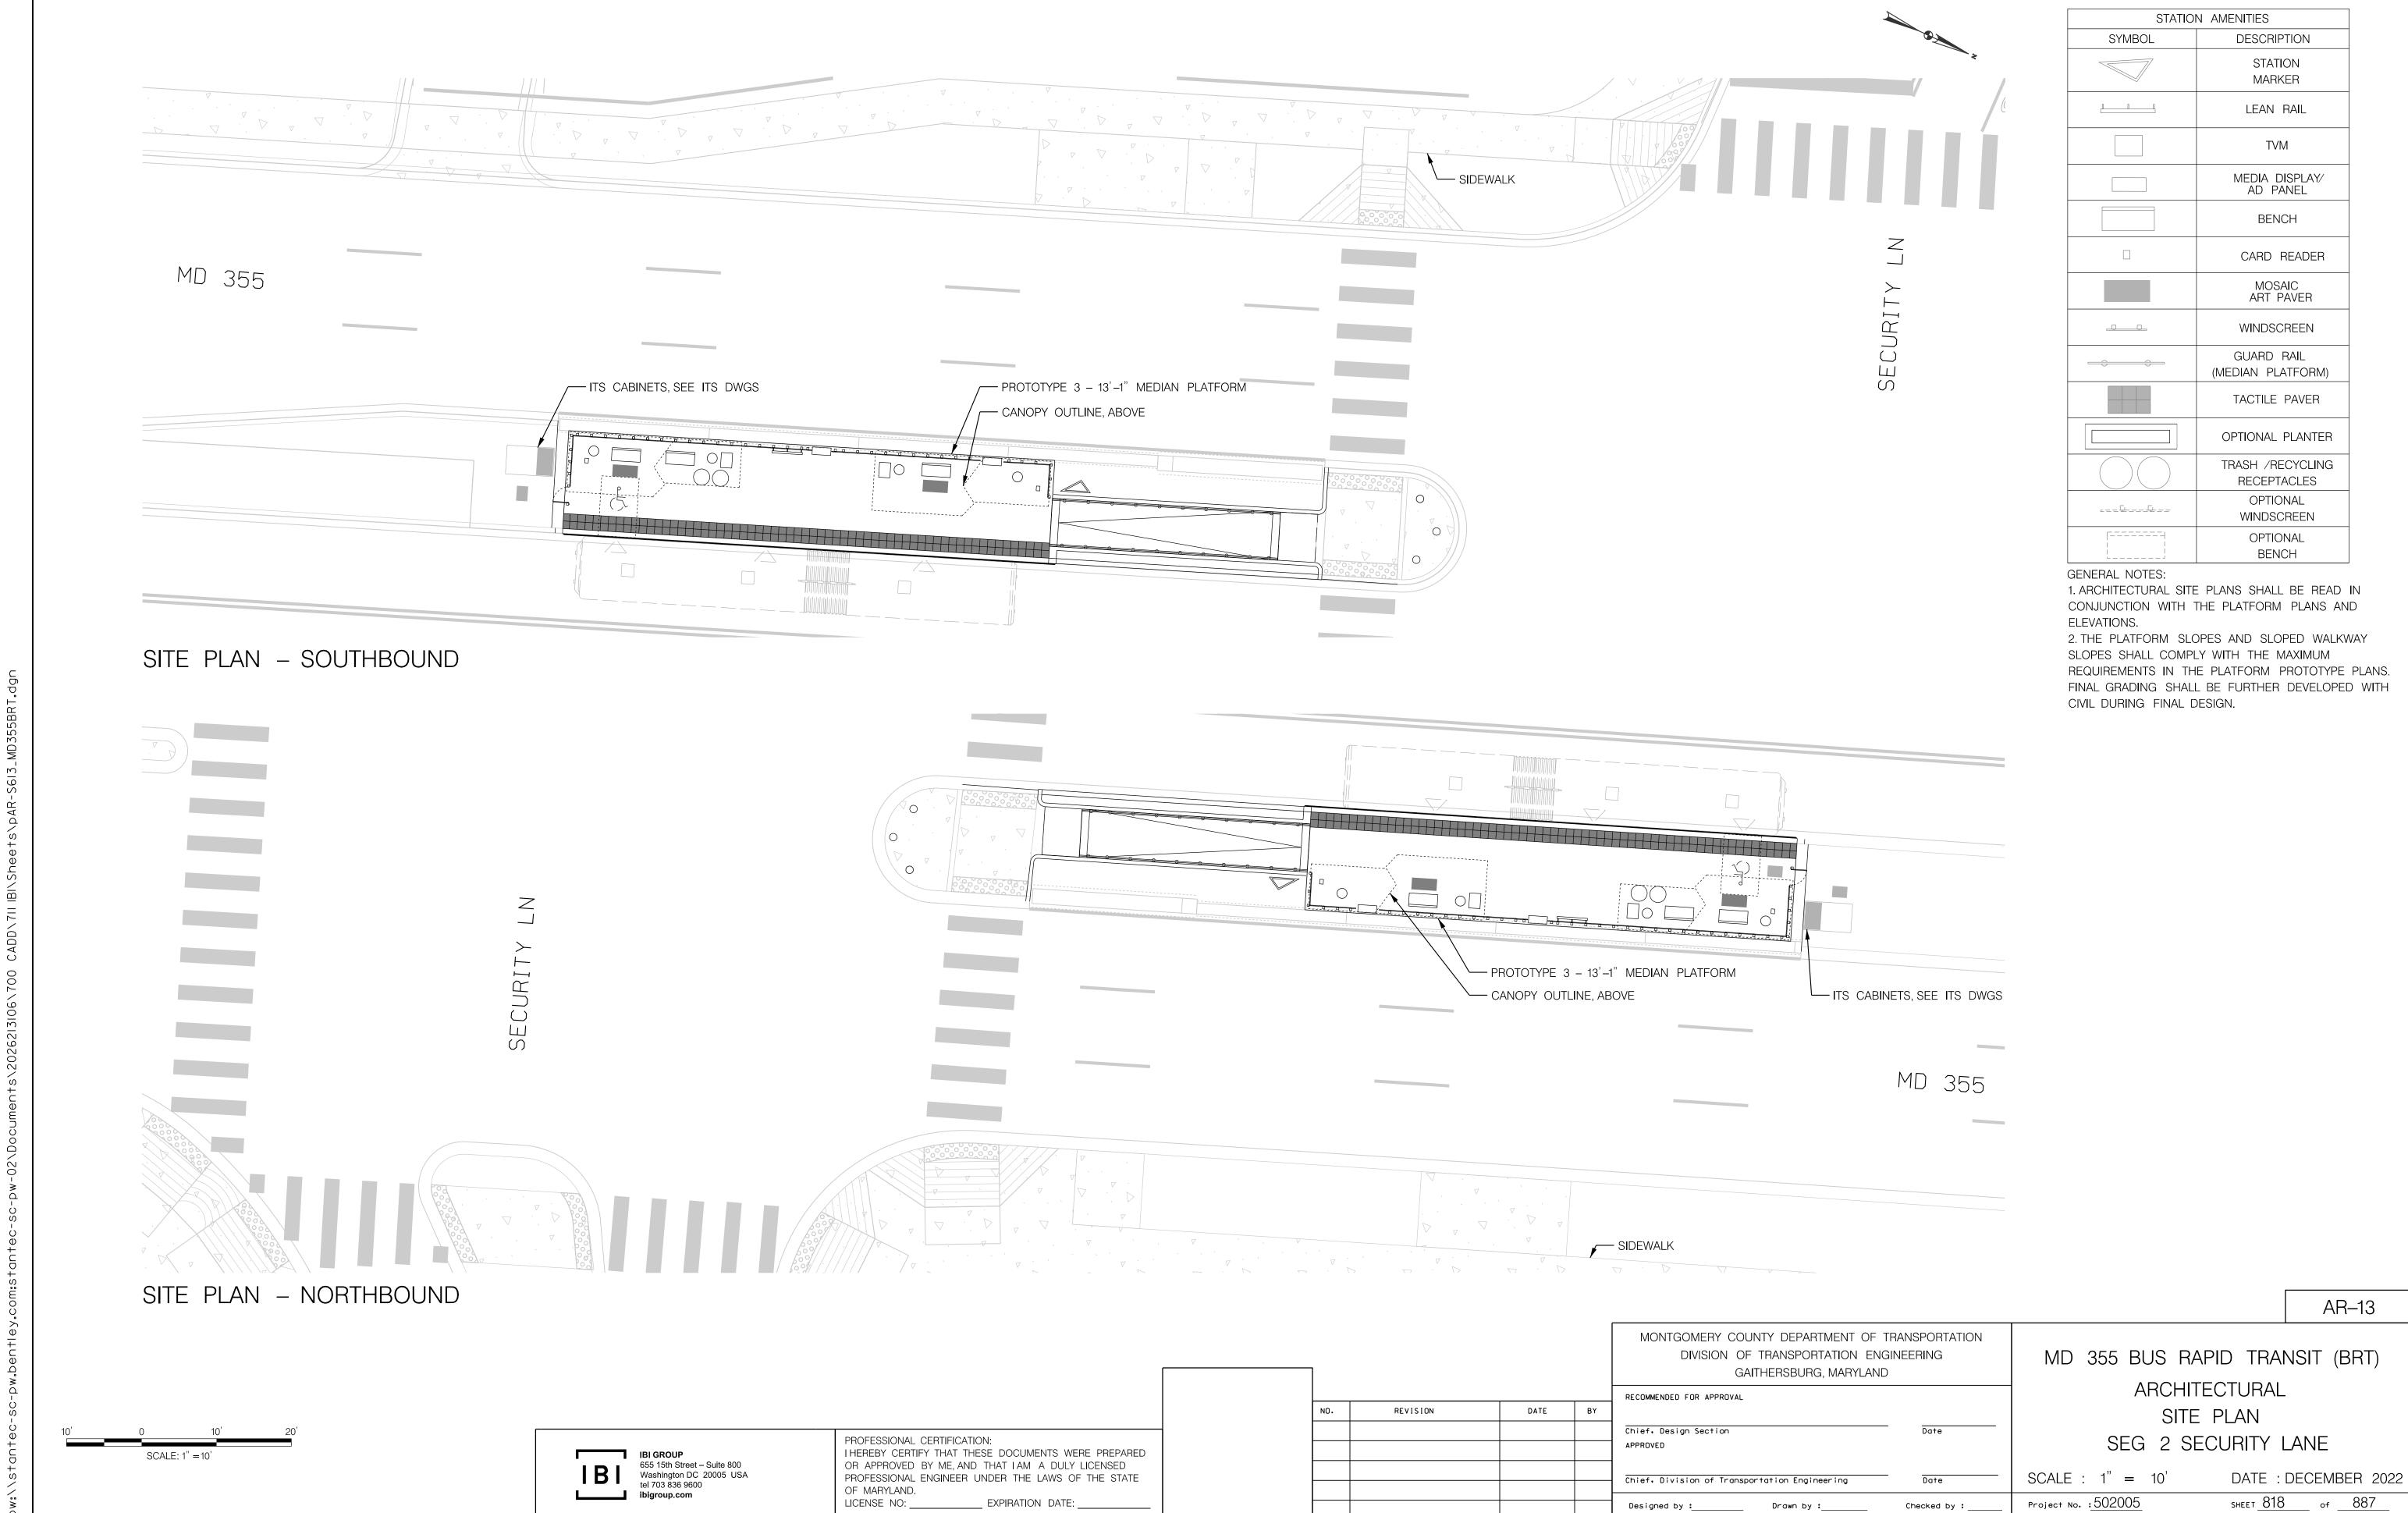

LICENSE NO: ___

__ EXPIRATION DATE: _

Project No. : 502005

Designed by :_____

Drawn by :____

Checked by : _

ELEVATION - NORTHBOUND

REVISION

AR-14

MONTGOMERY COUNTY DEPARTMENT OF TRANSPORTATION DIVISION OF TRANSPORTATION ENGINEERING GAITHERSBURG, MARYLAND RECOMMENDED FOR APPROVAL DATE BY Chief. Design Section APPROVED

Checked by : $_$

Chief. Division of Transportation Engineering

Designed by :_____ Drawn by :____

MD 355 BUS RAPID TRANSIT (BRT) ARCHITECTURAL ELEVATION SEG 2 SECURITY LANE

DATE: DECEMBER 2022 SCALE : 1" = 5"SHEET 819 of 887 Project No. : 502005

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LICENSE NO: _____ EXPIRATION DATE: ___

SCALE: 1'' = 5'

GENERAL NOTES:

CIVIL DURING FINAL DESIGN.


ELEVATIONS.

1. ARCHITECTURAL SITE PLANS SHALL BE READ IN CONJUNCTION WITH THE PLATFORM PLANS AND

2. THE PLATFORM SLOPES AND SLOPED WALKWAY

REQUIREMENTS IN THE PLATFORM PROTOTYPE PLANS. FINAL GRADING SHALL BE FURTHER DEVELOPED WITH

SLOPES SHALL COMPLY WITH THE MAXIMUM

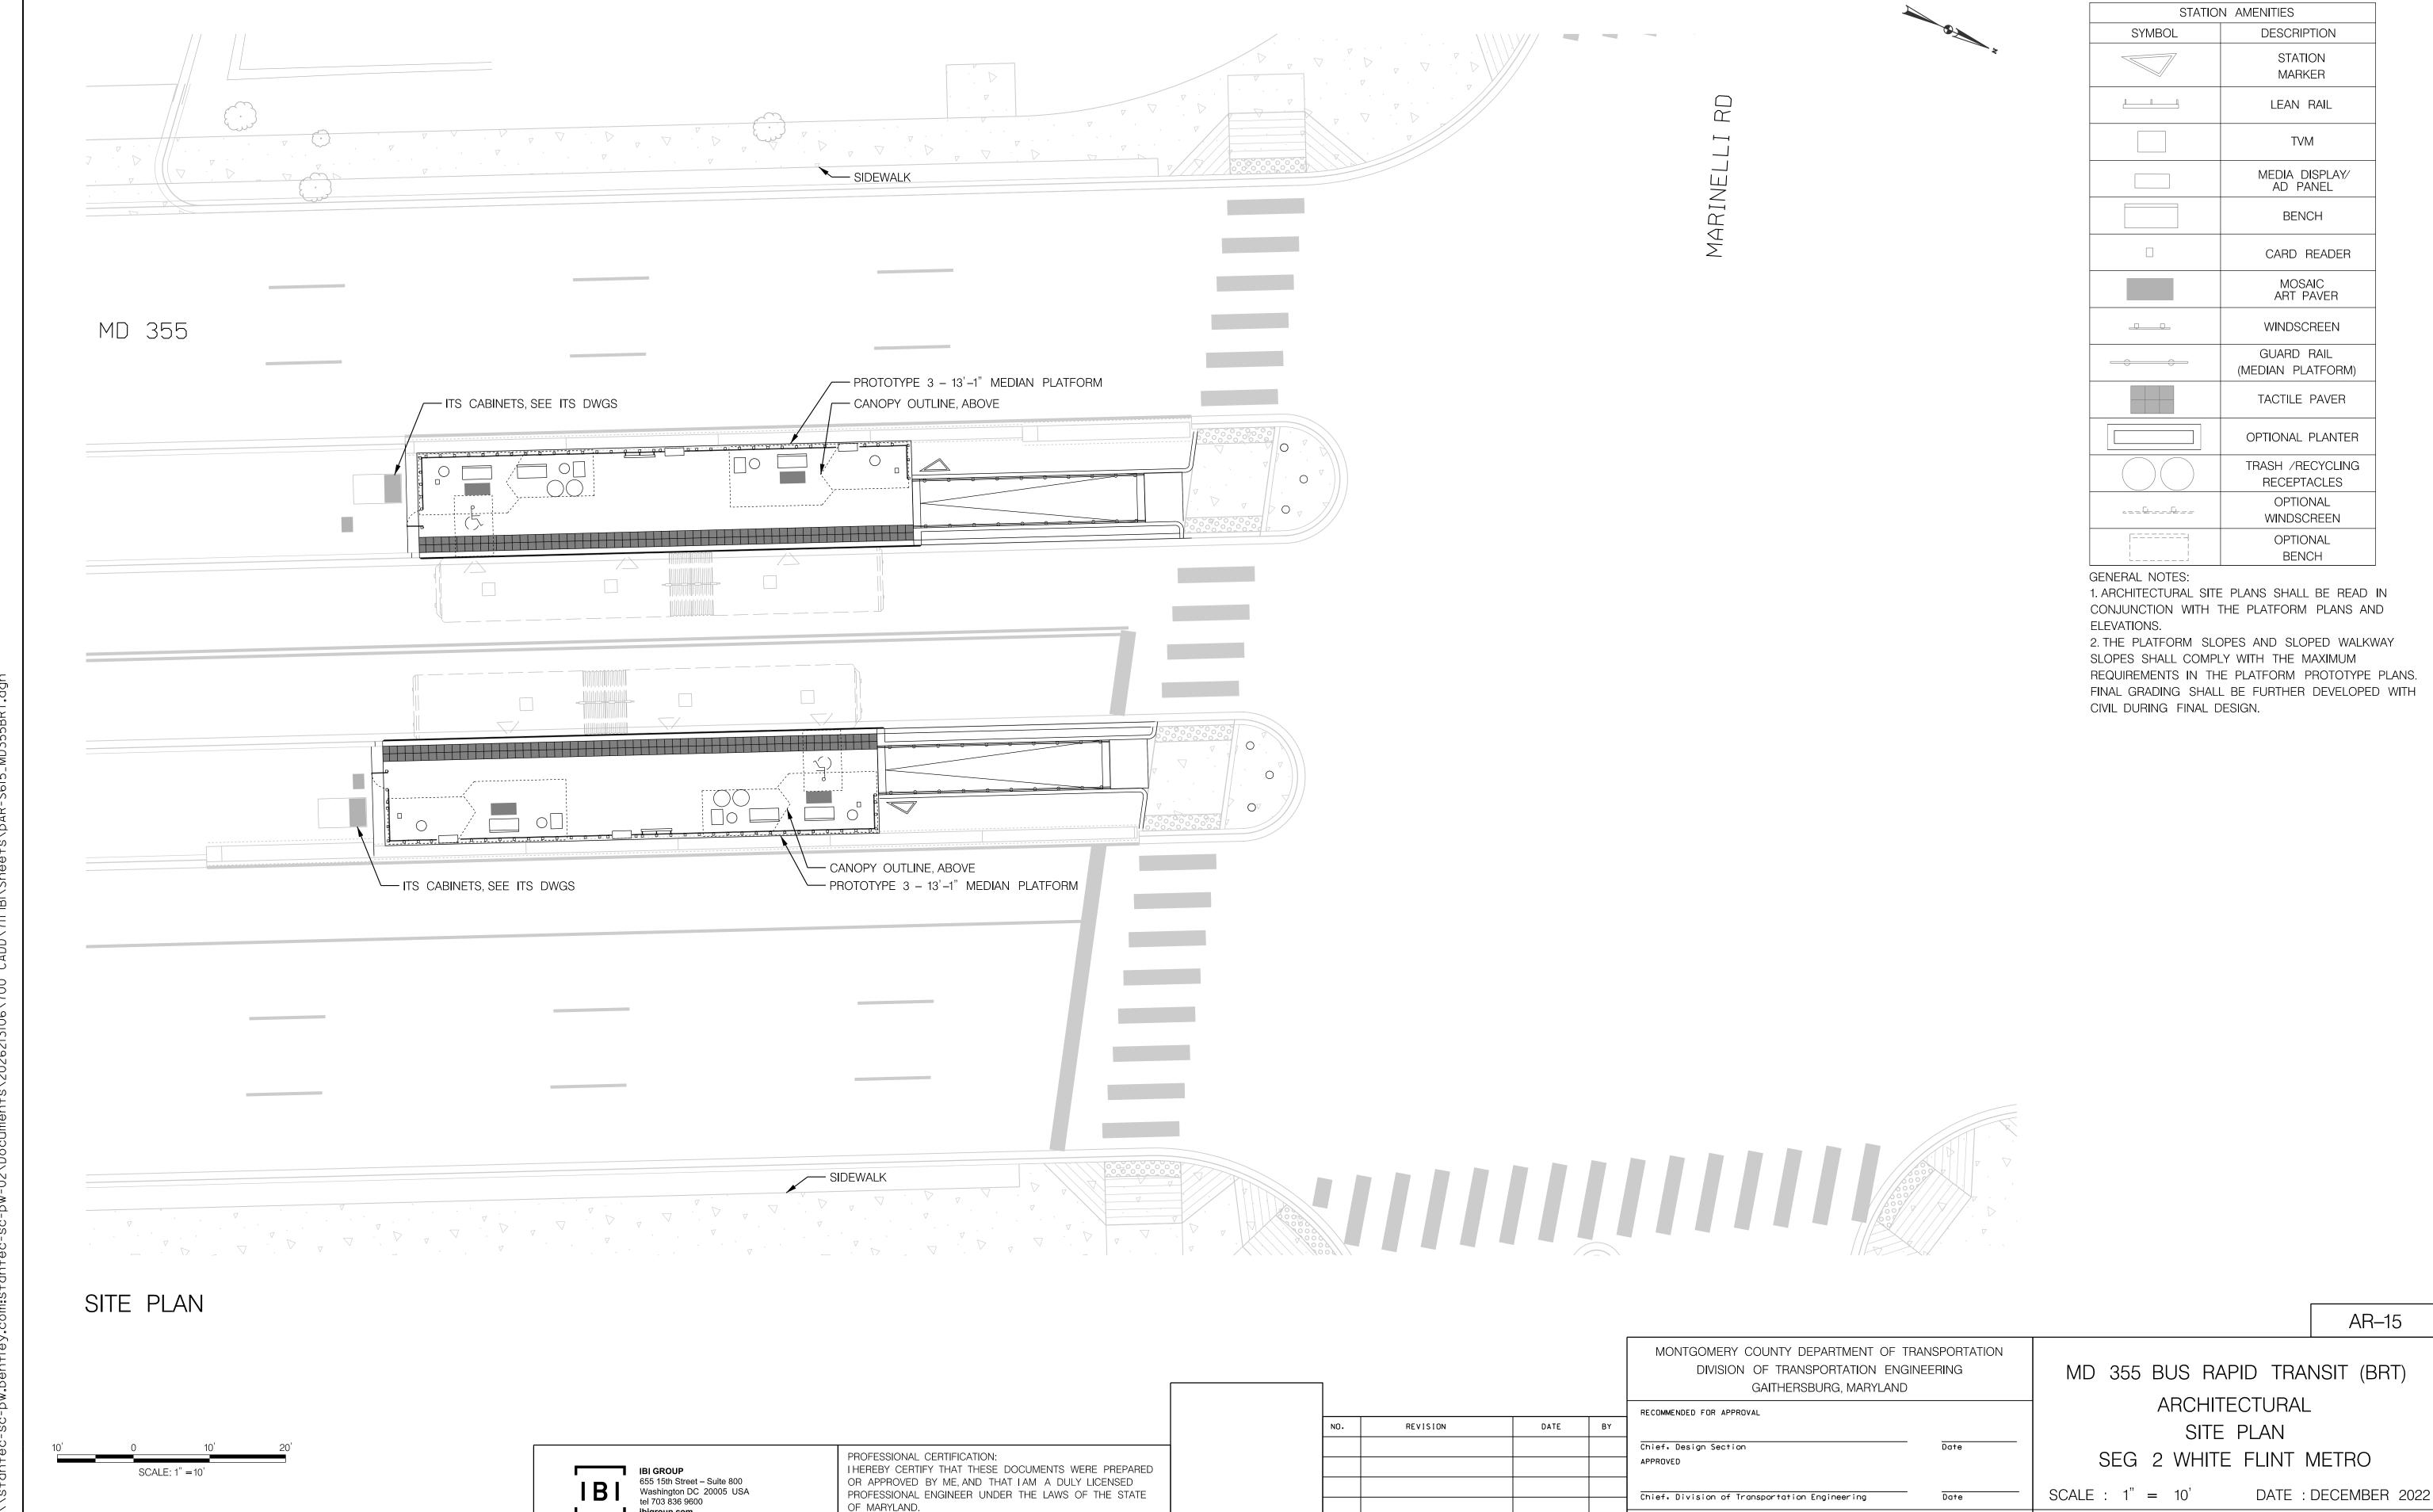

SHEET <u>820</u> of <u>887</u>

Project No. :502005

Checked by : _

Drawn by :____


Designed by :____

2022-II-03

ibigroup.com

LICENSE NO: ___

_ EXPIRATION DATE:

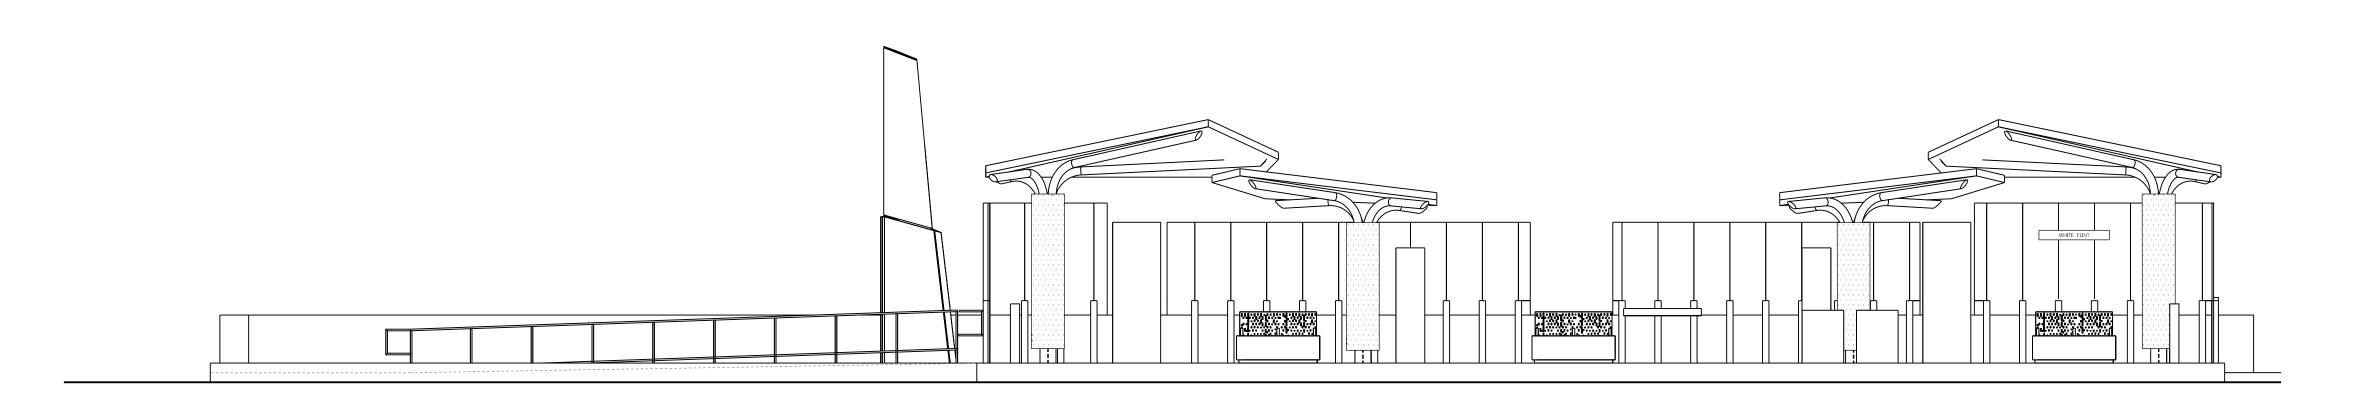

ELEVATION - NORTHBOUND

AR-16

MONTGOMERY COUNTY DEPARTMENT OF TRANSPORTATION DIVISION OF TRANSPORTATION ENGINEERING GAITHERSBURG, MARYLAND RECOMMENDED FOR APPROVAL DATE BY Chief. Design Section APPROVED

Checked by : $_$

Chief, Division of Transportation Engineering

Designed by :_____ Drawn by :____

REVISION

MD 355 BUS RAPID TRANSIT (BRT) ARCHITECTURAL ELEVATION SEG 2 WHITE FLINT METRO

GENERAL NOTES:

CIVIL DURING FINAL DESIGN.

ELEVATIONS.

1. ARCHITECTURAL SITE PLANS SHALL BE READ IN CONJUNCTION WITH THE PLATFORM PLANS AND

2. THE PLATFORM SLOPES AND SLOPED WALKWAY

REQUIREMENTS IN THE PLATFORM PROTOTYPE PLANS. FINAL GRADING SHALL BE FURTHER DEVELOPED WITH

SLOPES SHALL COMPLY WITH THE MAXIMUM


SCALE: 1'' = 5'DATE: DECEMBER 2022 SHEET <u>821</u> of <u>887</u> Project No. : 502005

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PROFESSIONAL CERTIFICATION:
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LICENSE NO: _____ EXPIRATION DATE: ___

SCALE: 1'' = 5'



GENERAL NOTES: 1. ARCHITECTURAL SITE PLANS SHALL BE READ IN CONJUNCTION WITH THE PLATFORM PLANS AND ELEVATIONS.

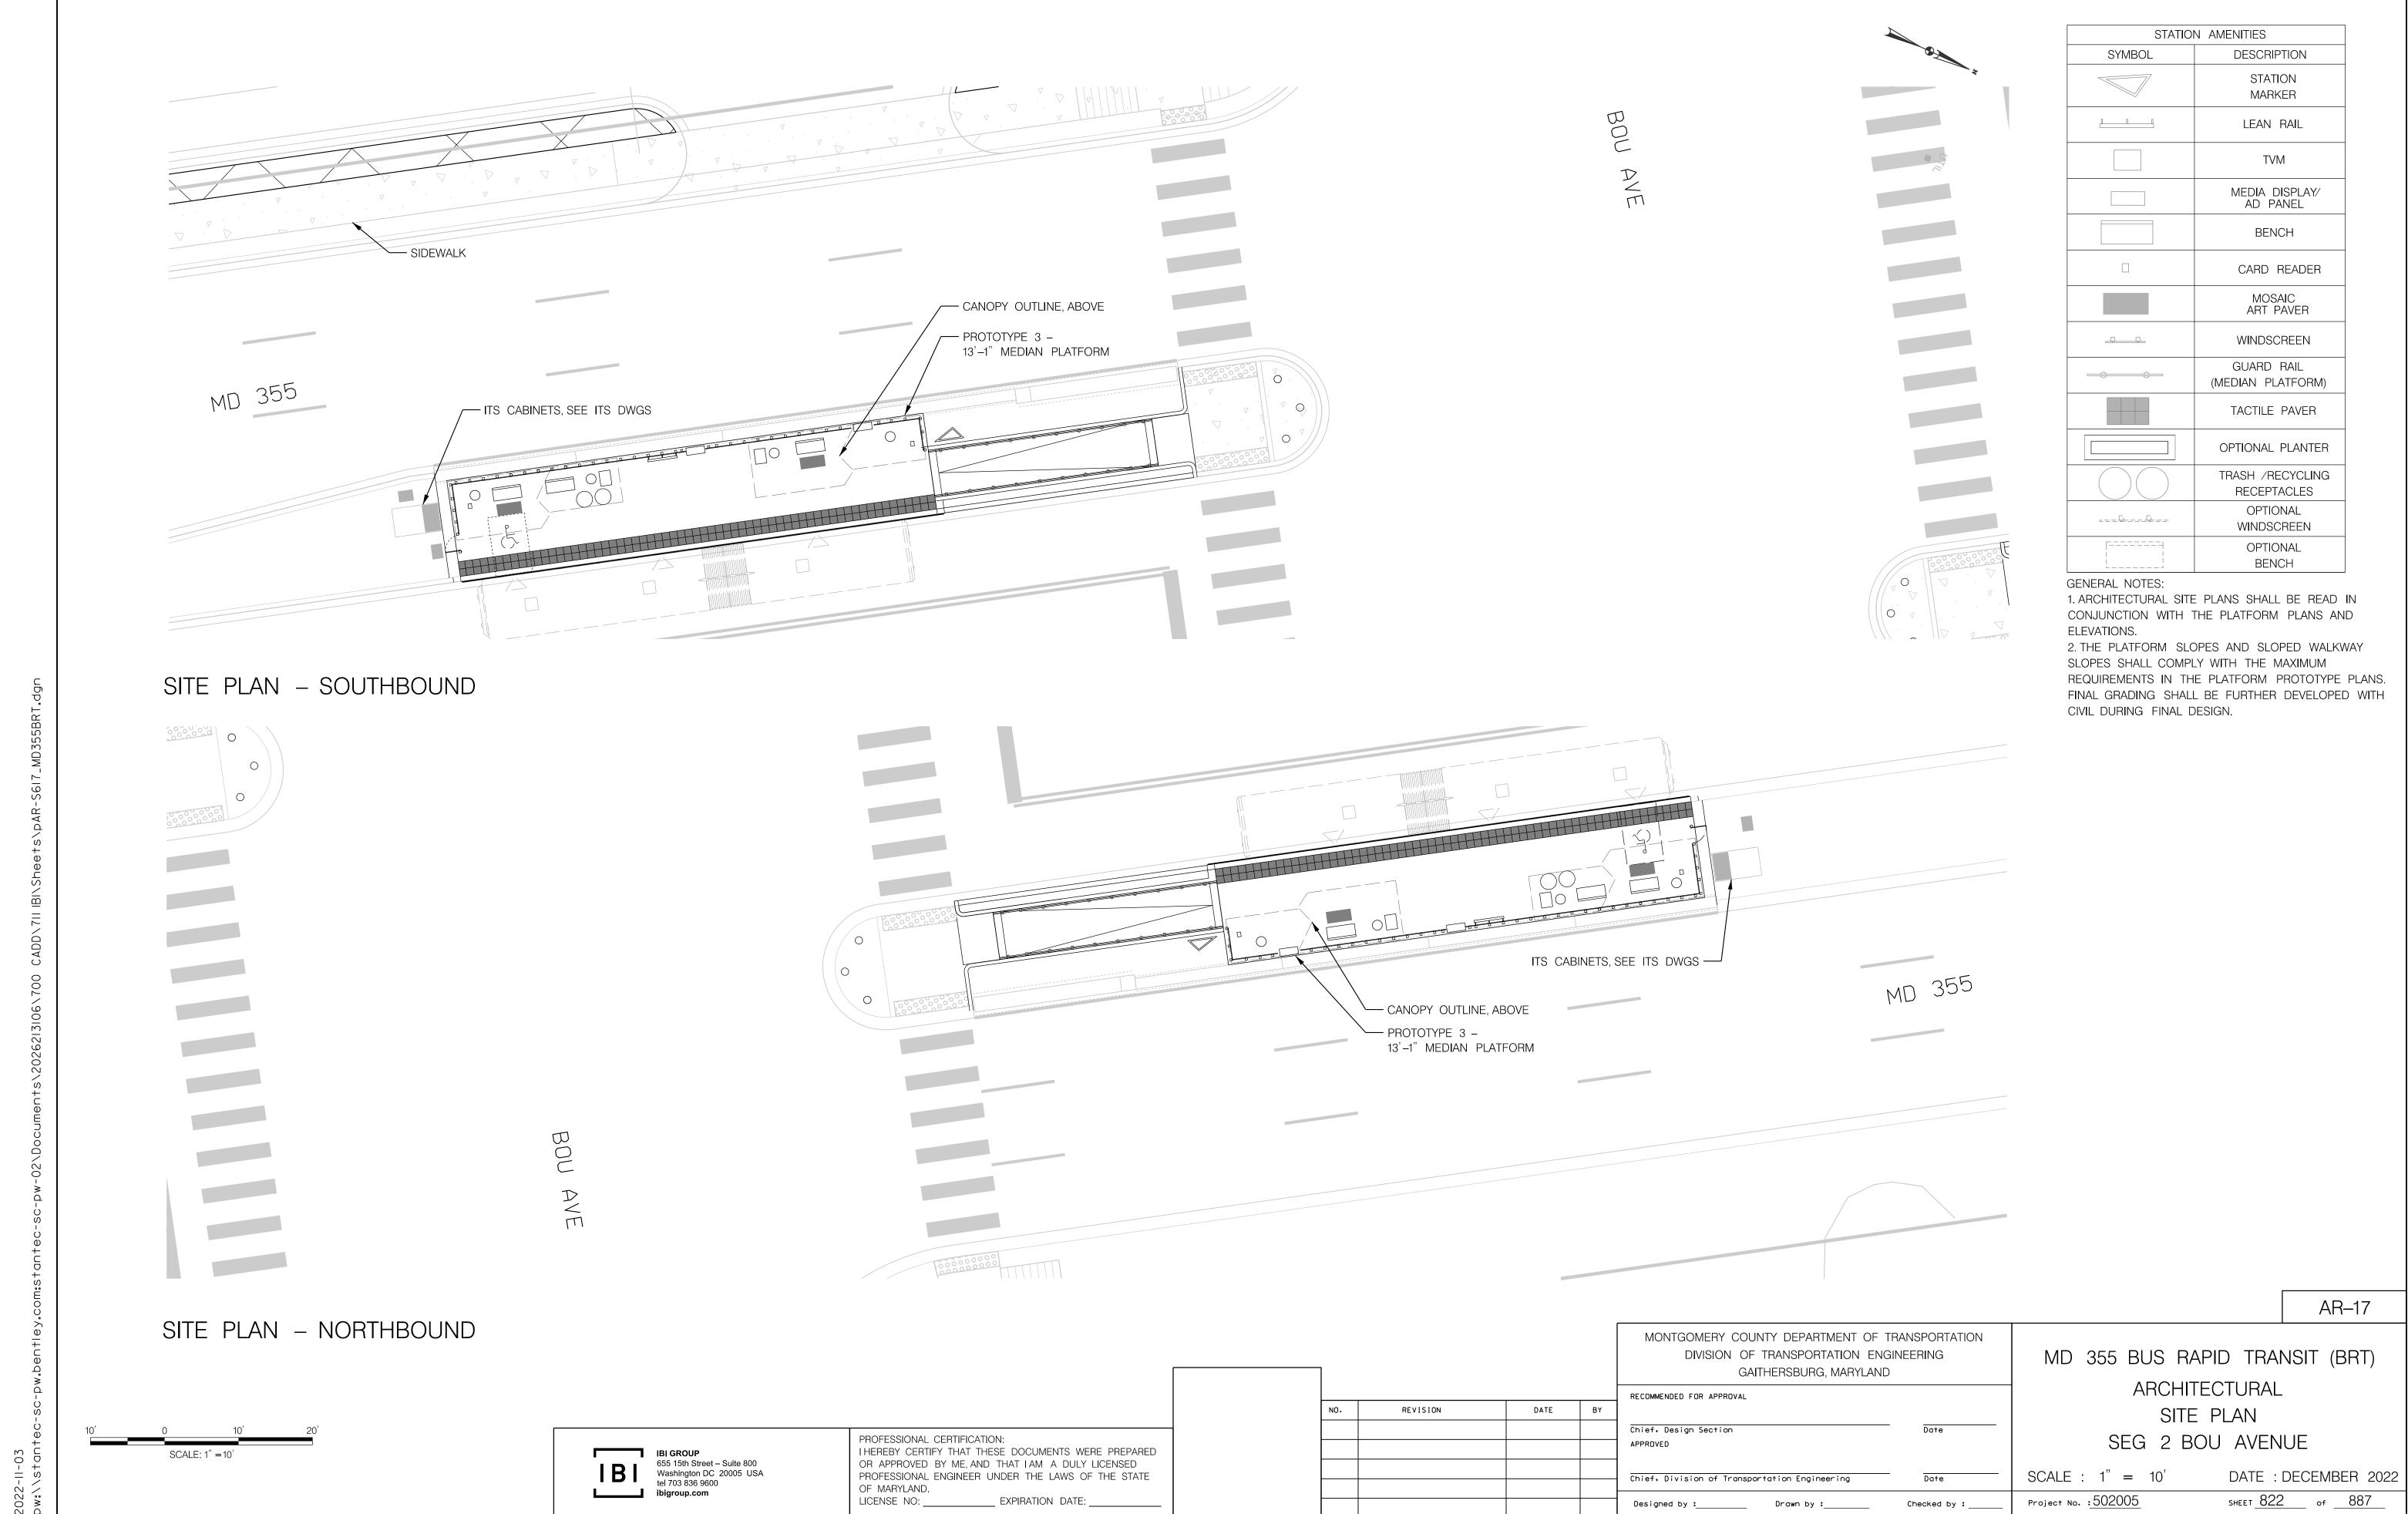2. THE PLATFORM SLOPES AND SLOPED WALKWAY SLOPES SHALL COMPLY WITH THE MAXIMUM REQUIREMENTS IN THE PLATFORM PROTOTYPE PLANS. FINAL GRADING SHALL BE FURTHER DEVELOPED WITH CIVIL DURING FINAL DESIGN.

AR-18

MONTGOMERY COUNTY DEPARTMENT OF TRANSPORTATION DIVISION OF TRANSPORTATION ENGINEERING GAITHERSBURG, MARYLAND RECOMMENDED FOR APPROVAL DATE BY Chief. Design Section APPROVED Chief. Division of Transportation Engineering

MD 355 BUS RAPID TRANSIT (BRT) ARCHITECTURAL ELEVATION SEG 2 BOU AVENUE

DATE: DECEMBER 2022 SCALE : 1" = 5"

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LICENSE NO: _____ EXPIRATION DATE: ___

OF MARYLAND.


REVISION

Designed by :_____ Drawn by :____ Checked by : $_$

Project No. : 502005

SHEET <u>823</u> of <u>887</u>

SCALE: 1'' = 5'

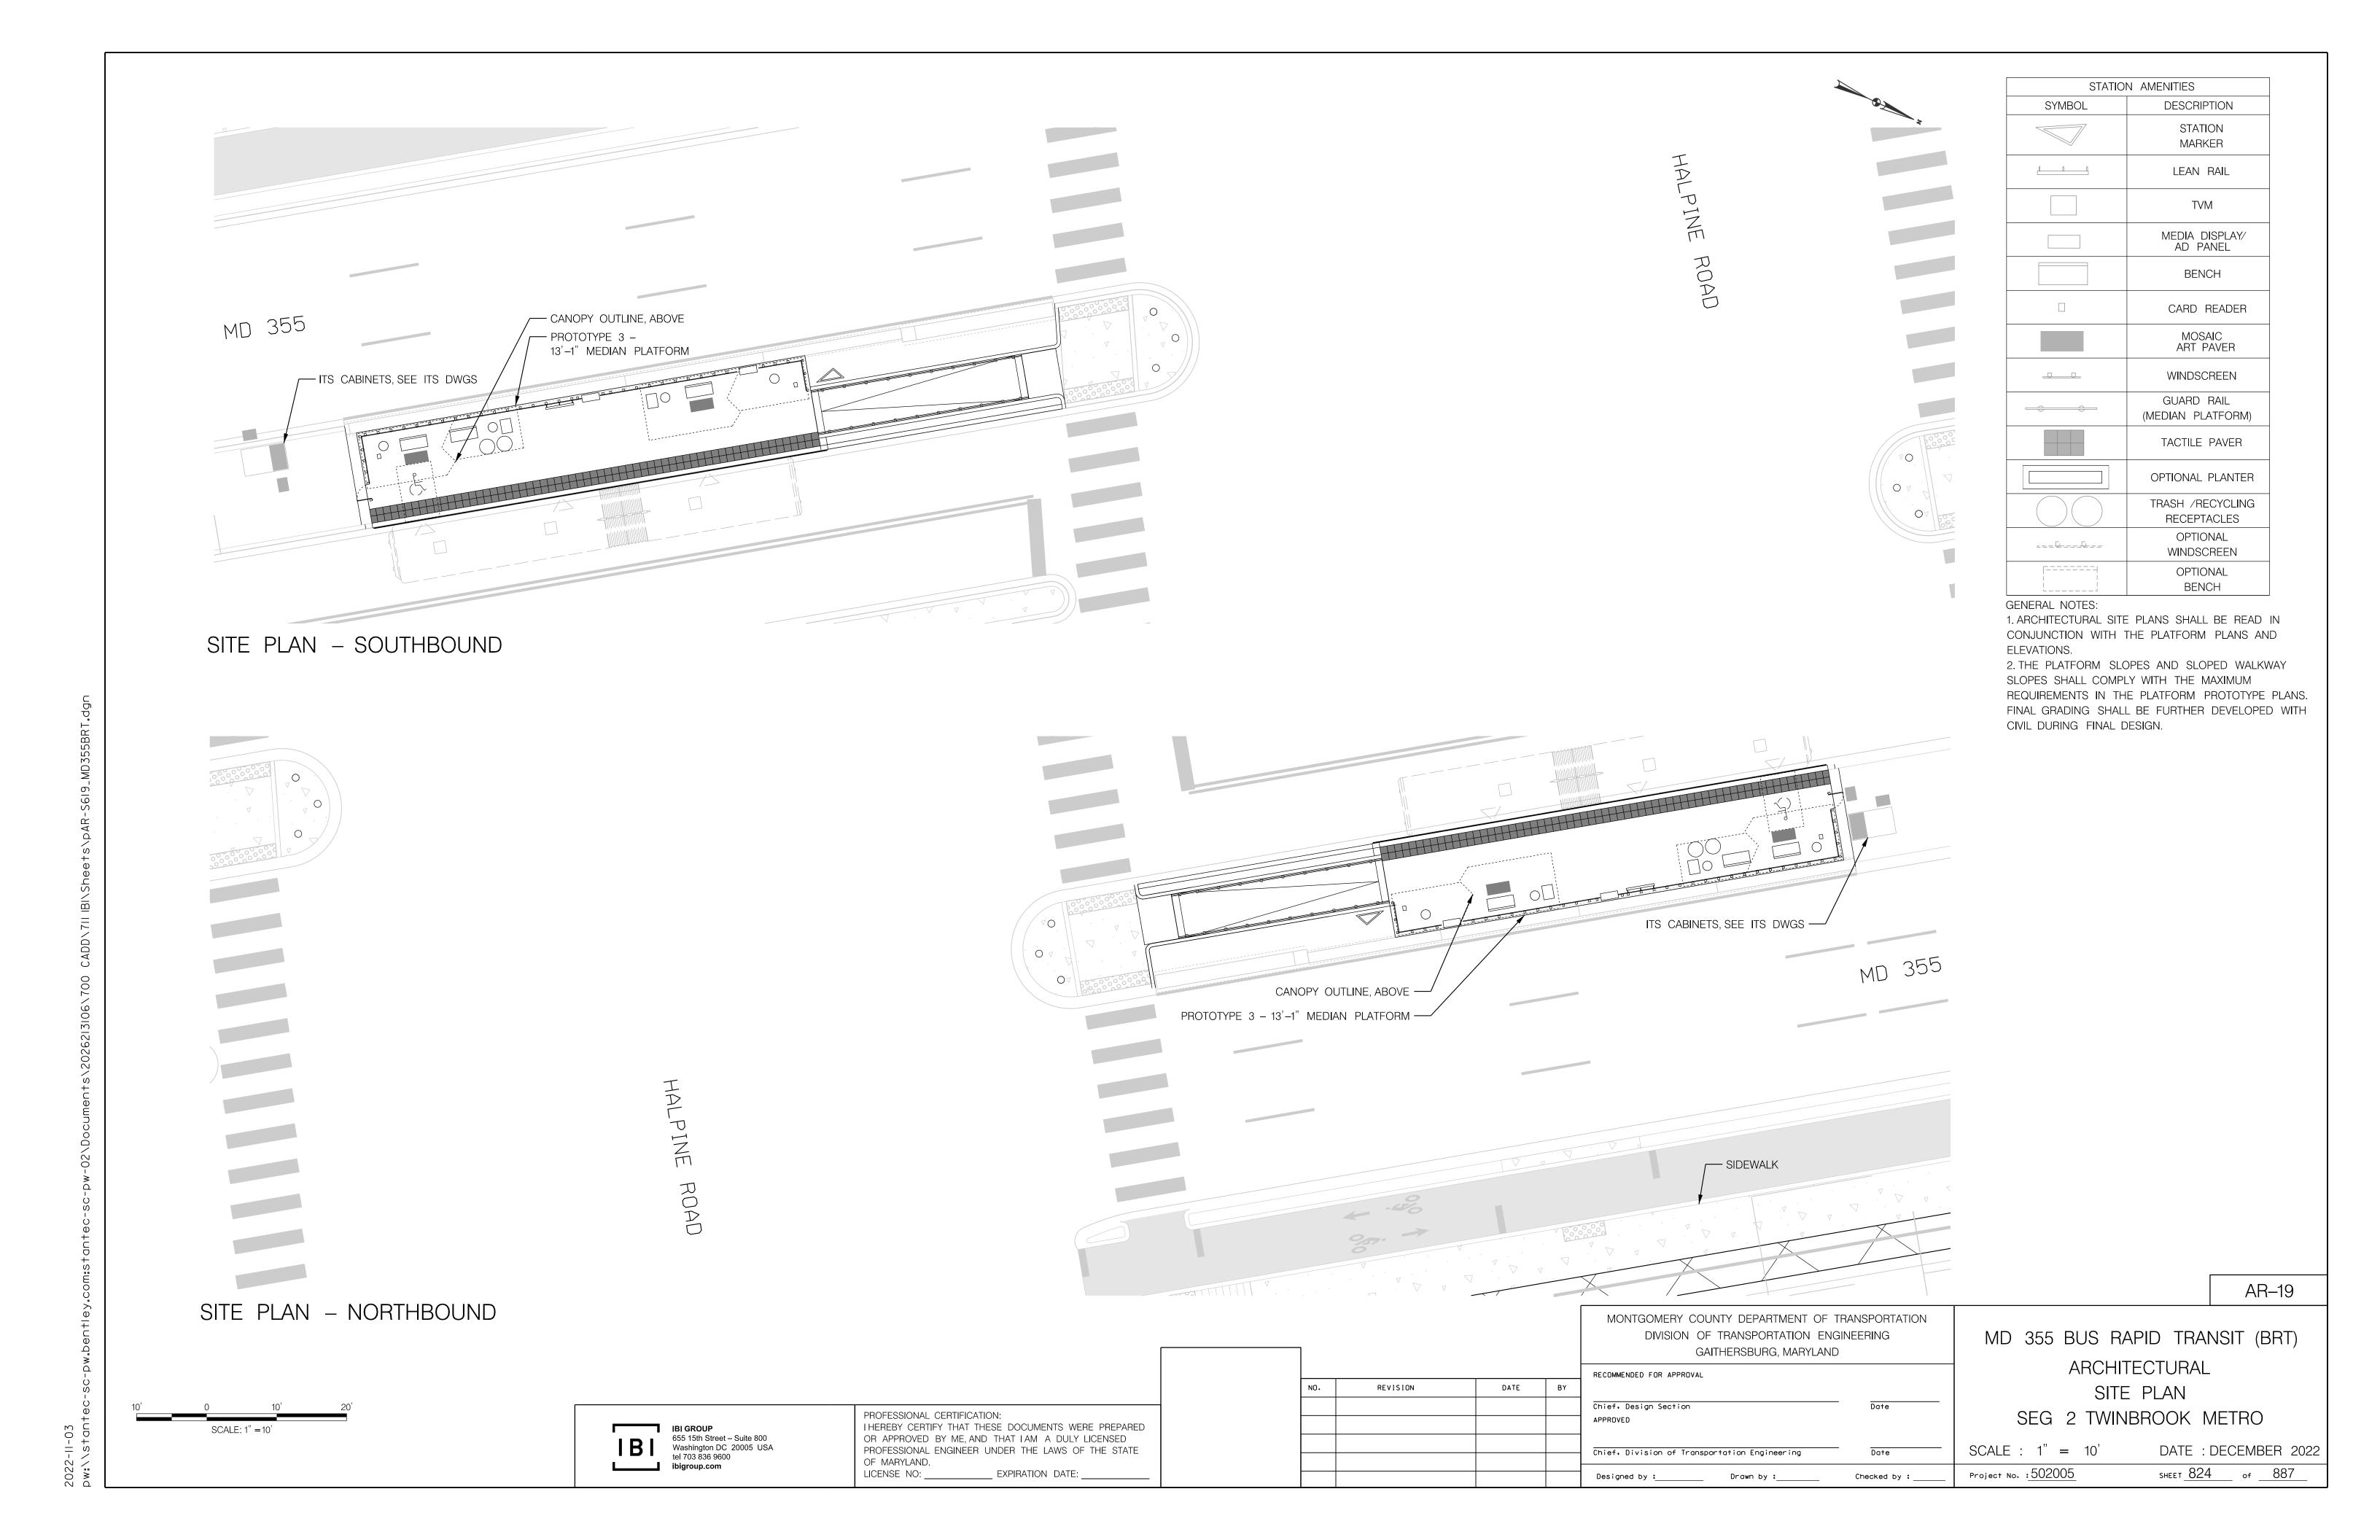

ELEVATION - NORTHBOUND

AR-20

MONTGOMERY COUNTY DEPARTMENT OF TRANSPORTATION MD 355 BUS RAPID TRANSIT (BRT) DIVISION OF TRANSPORTATION ENGINEERING GAITHERSBURG, MARYLAND RECOMMENDED FOR APPROVAL DATE BY Chief. Design Section APPROVED

ARCHITECTURAL ELEVATION

GENERAL NOTES:

CIVIL DURING FINAL DESIGN.

ELEVATIONS.

1. ARCHITECTURAL SITE PLANS SHALL BE READ IN CONJUNCTION WITH THE PLATFORM PLANS AND

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REQUIREMENTS IN THE PLATFORM PROTOTYPE PLANS. FINAL GRADING SHALL BE FURTHER DEVELOPED WITH

SLOPES SHALL COMPLY WITH THE MAXIMUM

SEG 2 TWINBROOK METRO

DATE: DECEMBER 2022 SCALE : 1" = 5'SHEET <u>825</u> of <u>887</u> Project No. : 502005

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Washington DC 20005 USA
tel 703 836 9600 ibigroup.com

PROFESSIONAL CERTIFICATION:
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SCALE: 1'' = 5'


OF MARYLAND.


LICENSE NO: _____ EXPIRATION DATE: ___

REVISION

Chief, Division of Transportation Engineering Designed by :_____ Drawn by :____

Checked by : $_$

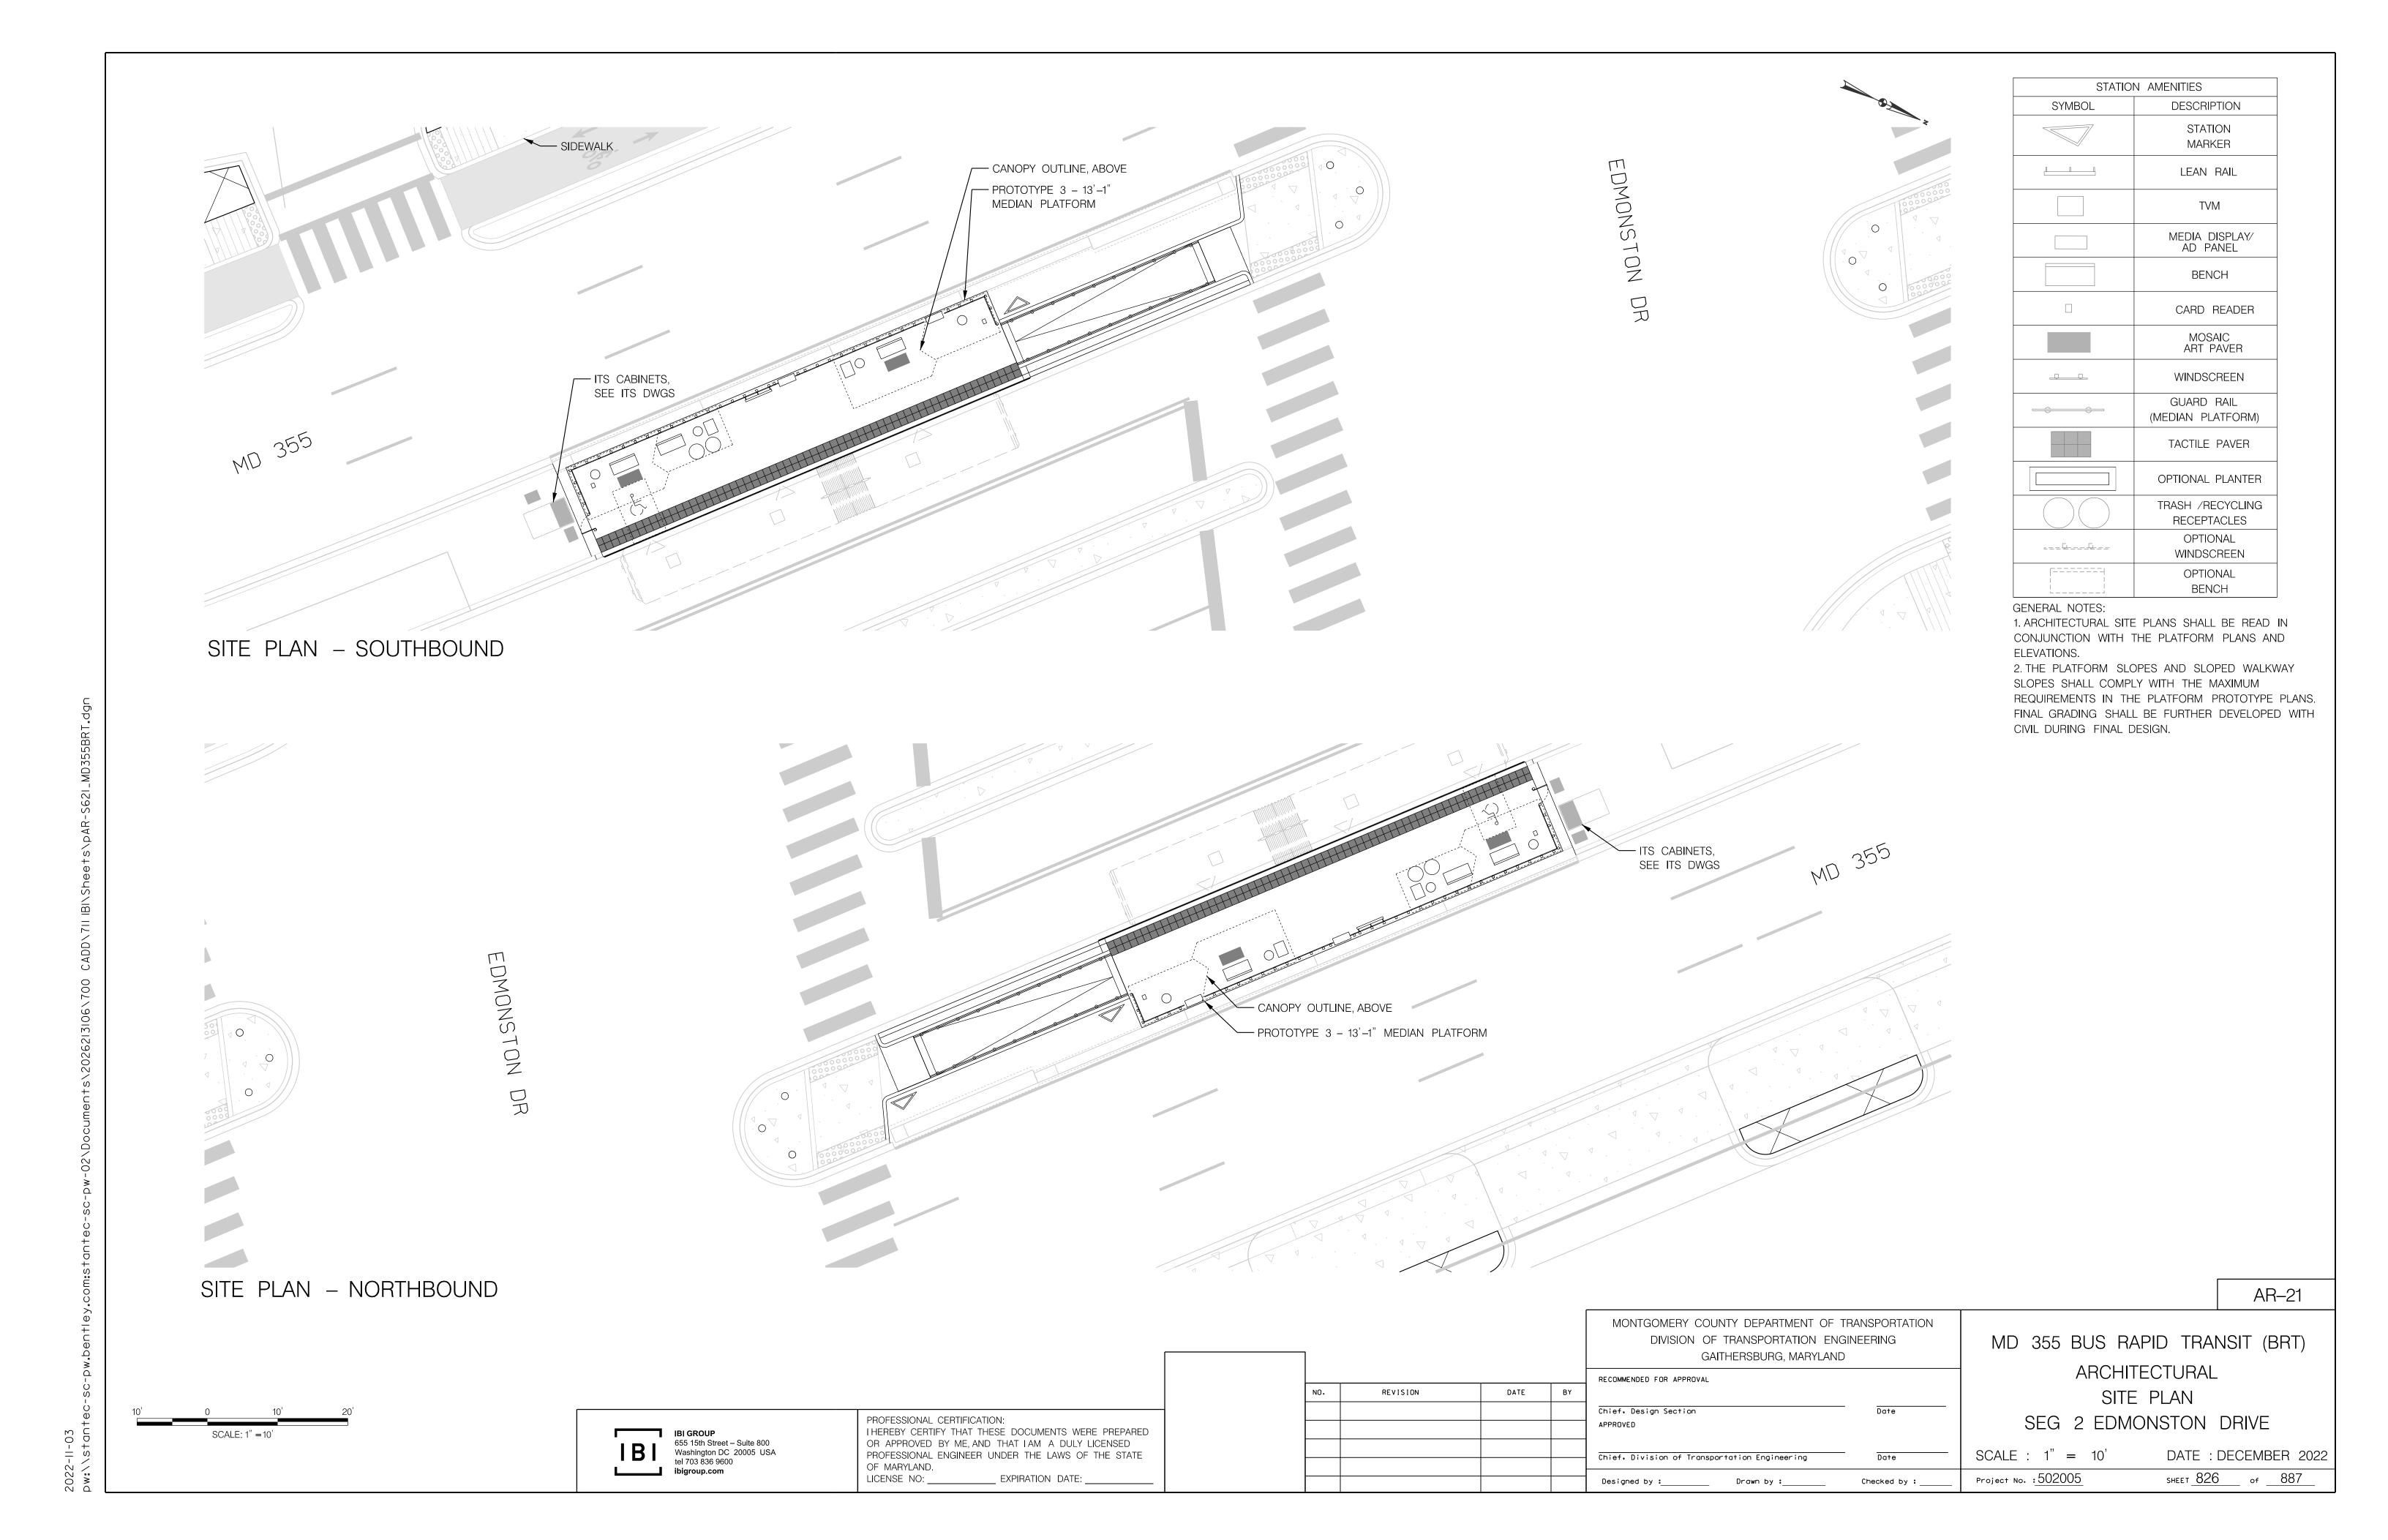

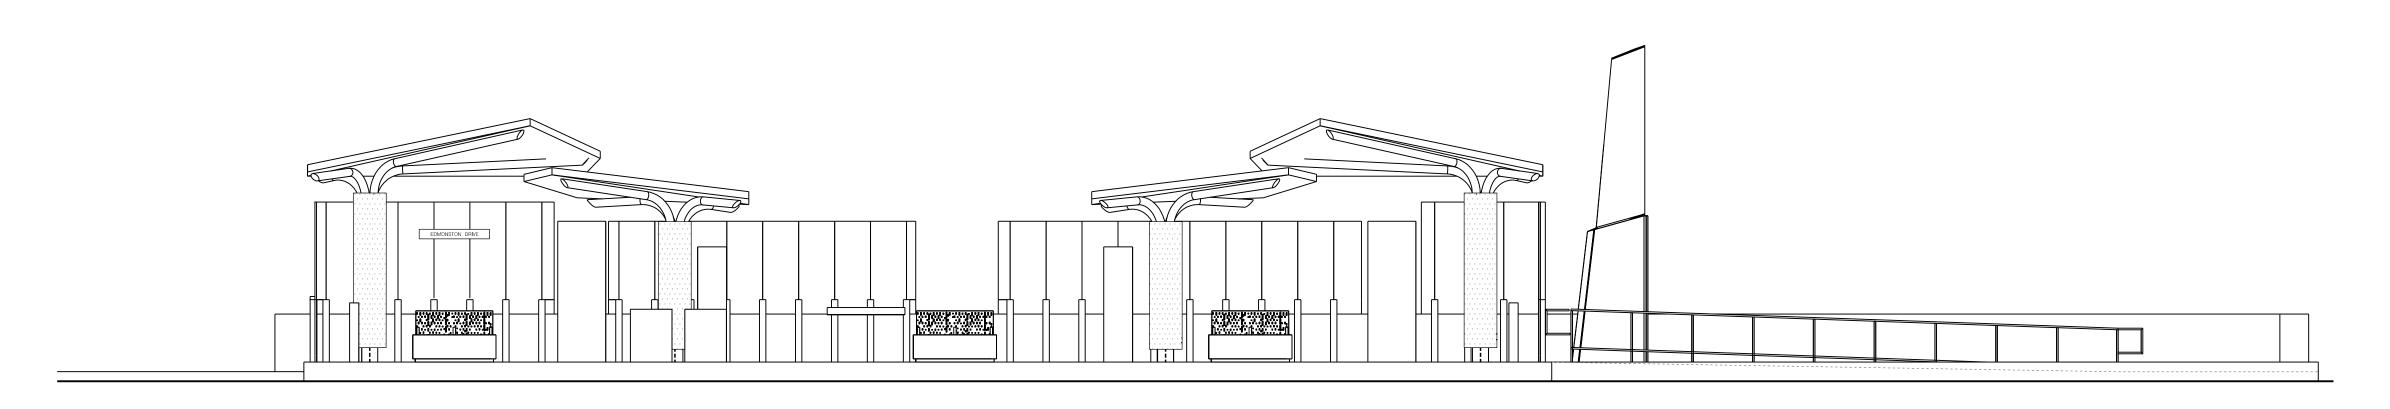

ELEVATION - NORTHBOUND

REVISION

AR-22

MONTGOMERY COUNTY DEPARTMENT OF TRANSPORTATION DIVISION OF TRANSPORTATION ENGINEERING GAITHERSBURG, MARYLAND RECOMMENDED FOR APPROVAL DATE BY Chief. Design Section APPROVED

Checked by : $_$

Chief. Division of Transportation Engineering

Designed by :_____ Drawn by :____

ARCHITECTURAL ELEVATION

MD 355 BUS RAPID TRANSIT (BRT)

SEG 2 EDMONSTON DRIVE

GENERAL NOTES:

CIVIL DURING FINAL DESIGN.

ELEVATIONS.

1. ARCHITECTURAL SITE PLANS SHALL BE READ IN CONJUNCTION WITH THE PLATFORM PLANS AND

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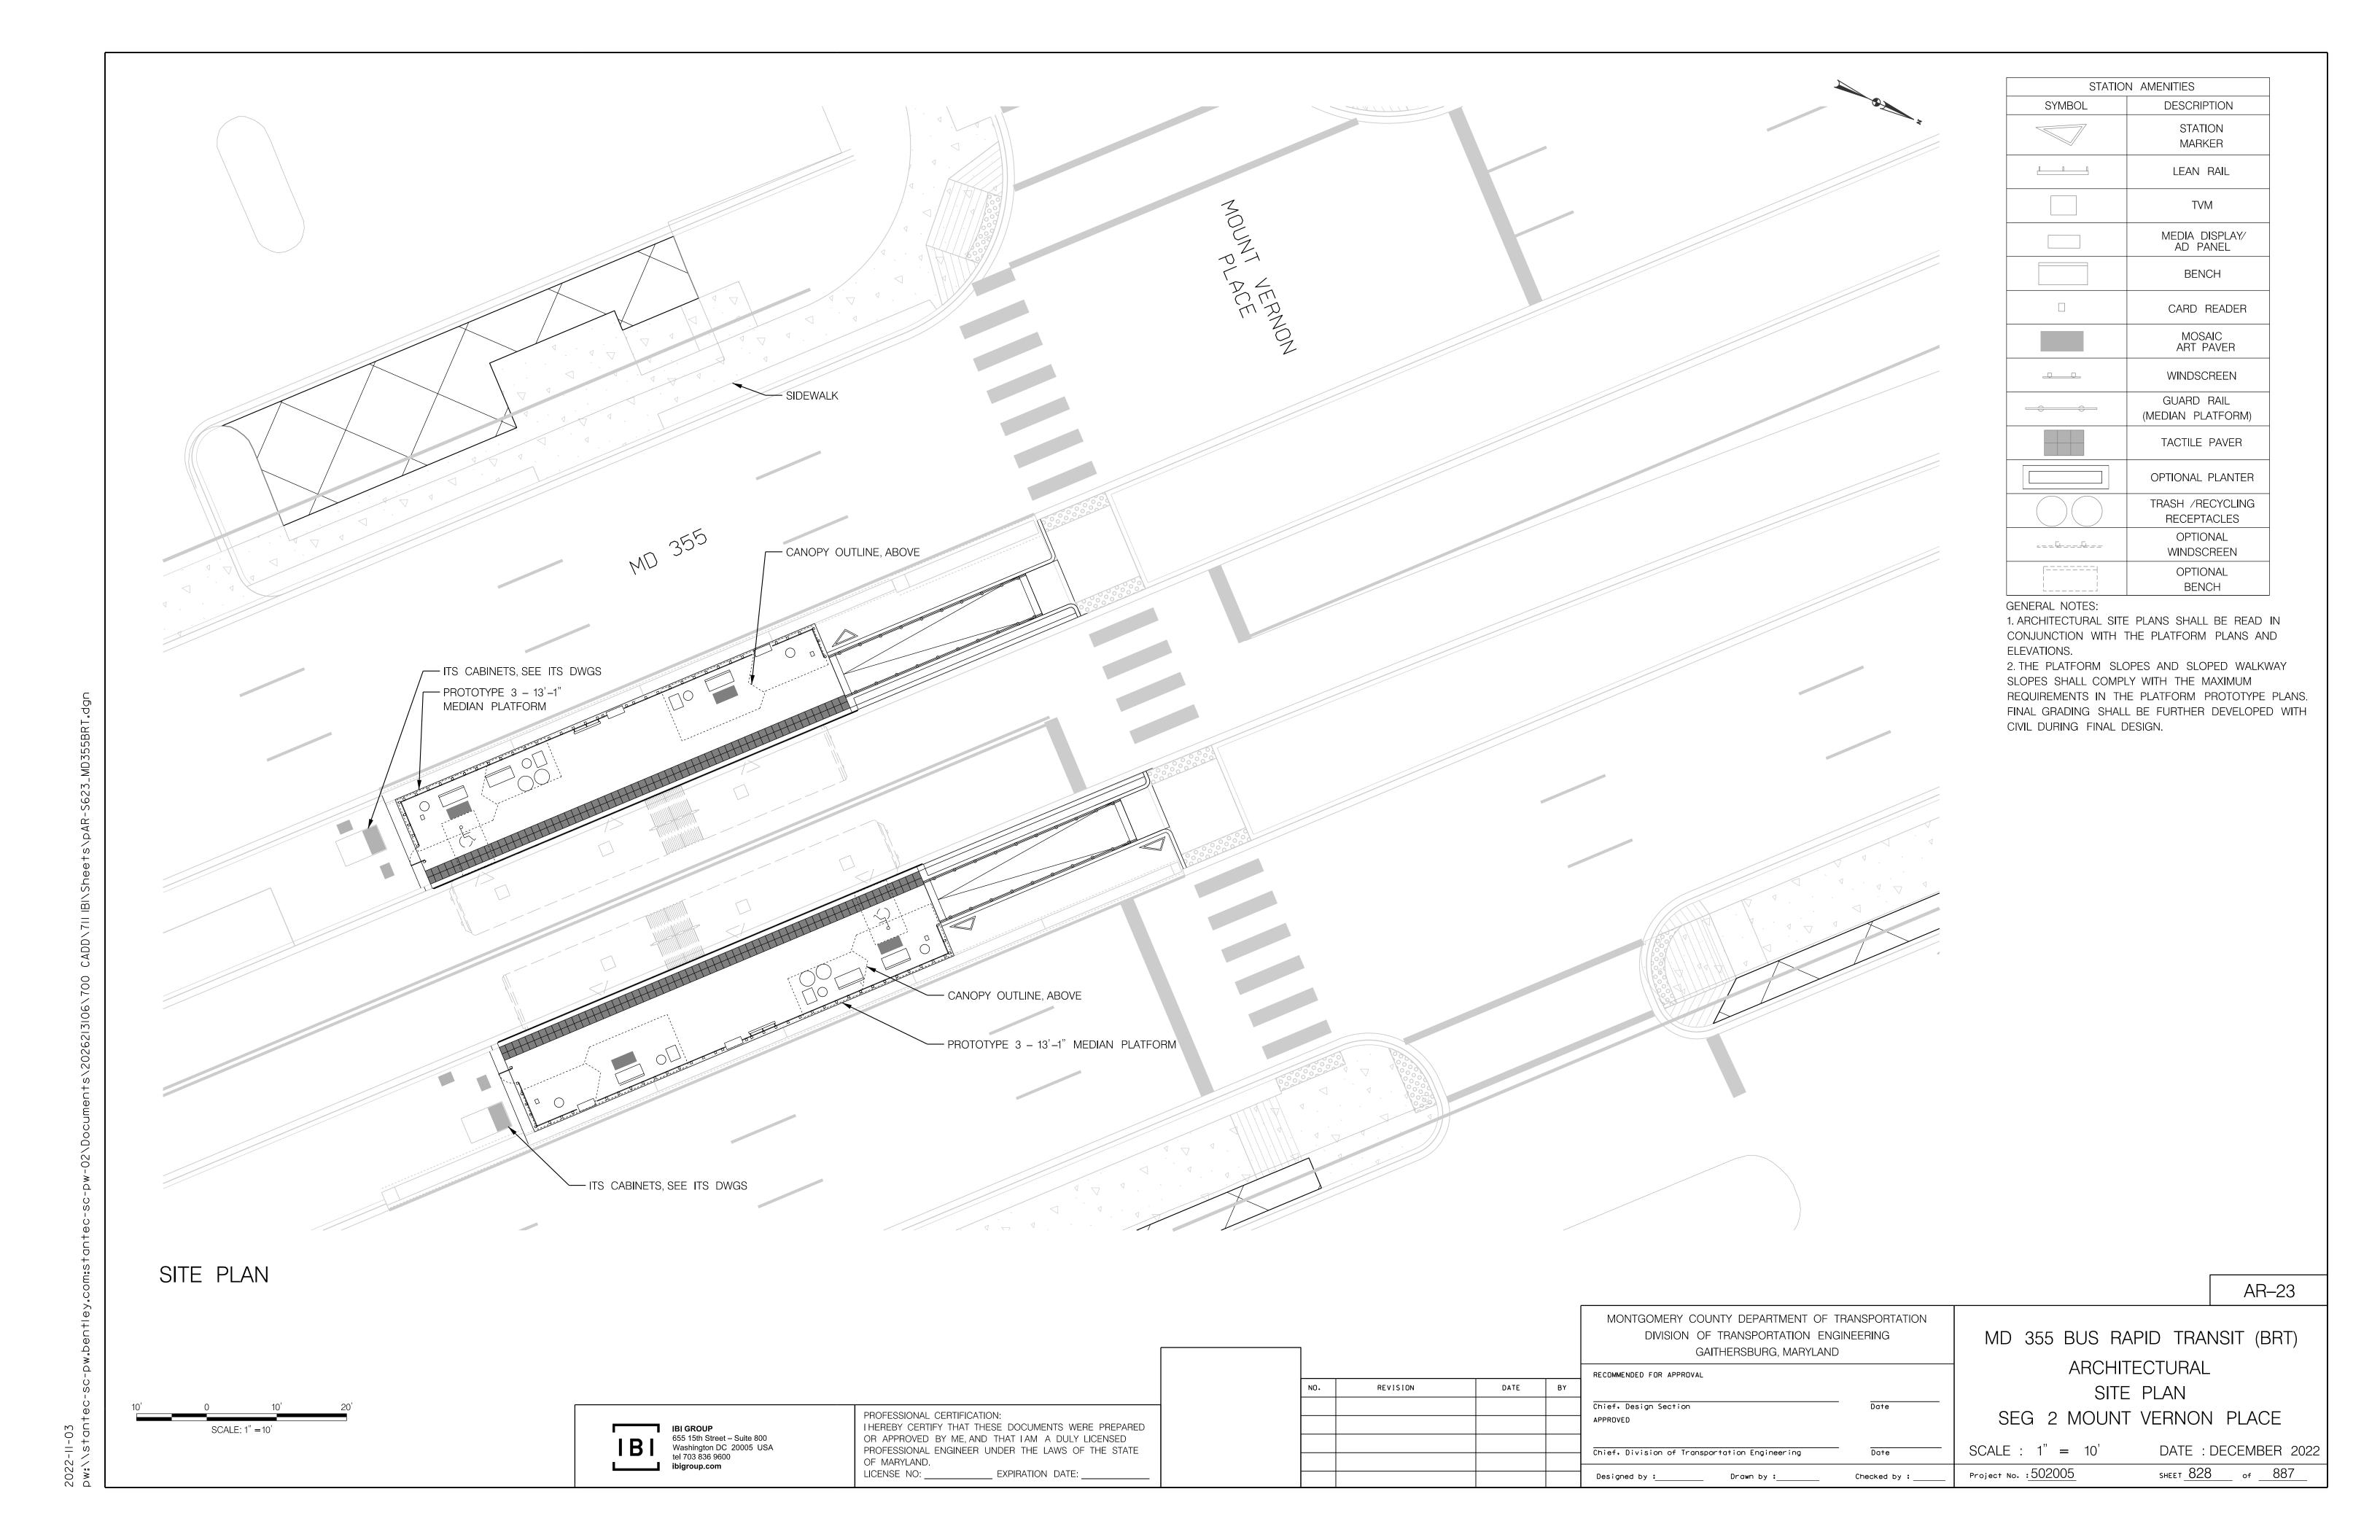
SCALE: 1'' = 5'DATE: DECEMBER 2022 SHEET <u>827</u> of <u>887</u> Project No. : 502005


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Washington DC 20005 USA
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PROFESSIONAL CERTIFICATION:
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OF MARYLAND.

SCALE: 1'' = 5'





ELEVATION - NORTHBOUND

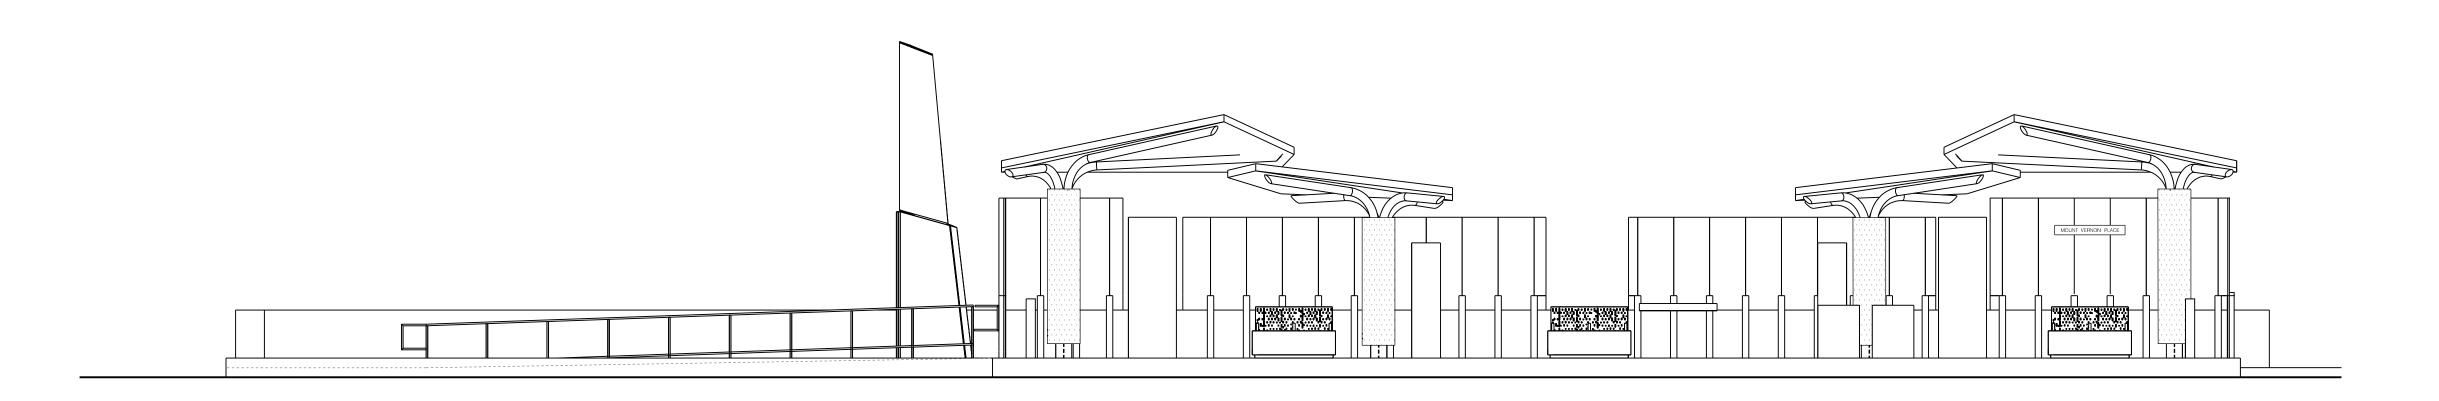AR-24

MONTGOMERY COUNTY DEPARTMENT OF TRANSPORTATION MD 355 BUS RAPID TRANSIT (BRT) DIVISION OF TRANSPORTATION ENGINEERING GAITHERSBURG, MARYLAND RECOMMENDED FOR APPROVAL DATE BY Chief. Design Section APPROVED Chief. Division of Transportation Engineering

Checked by : $_$

Designed by :_____ Drawn by :____

ARCHITECTURAL ELEVATION SEG 2 MOUNT VERNON PLACE

GENERAL NOTES:

CIVIL DURING FINAL DESIGN.

ELEVATIONS.

1. ARCHITECTURAL SITE PLANS SHALL BE READ IN CONJUNCTION WITH THE PLATFORM PLANS AND

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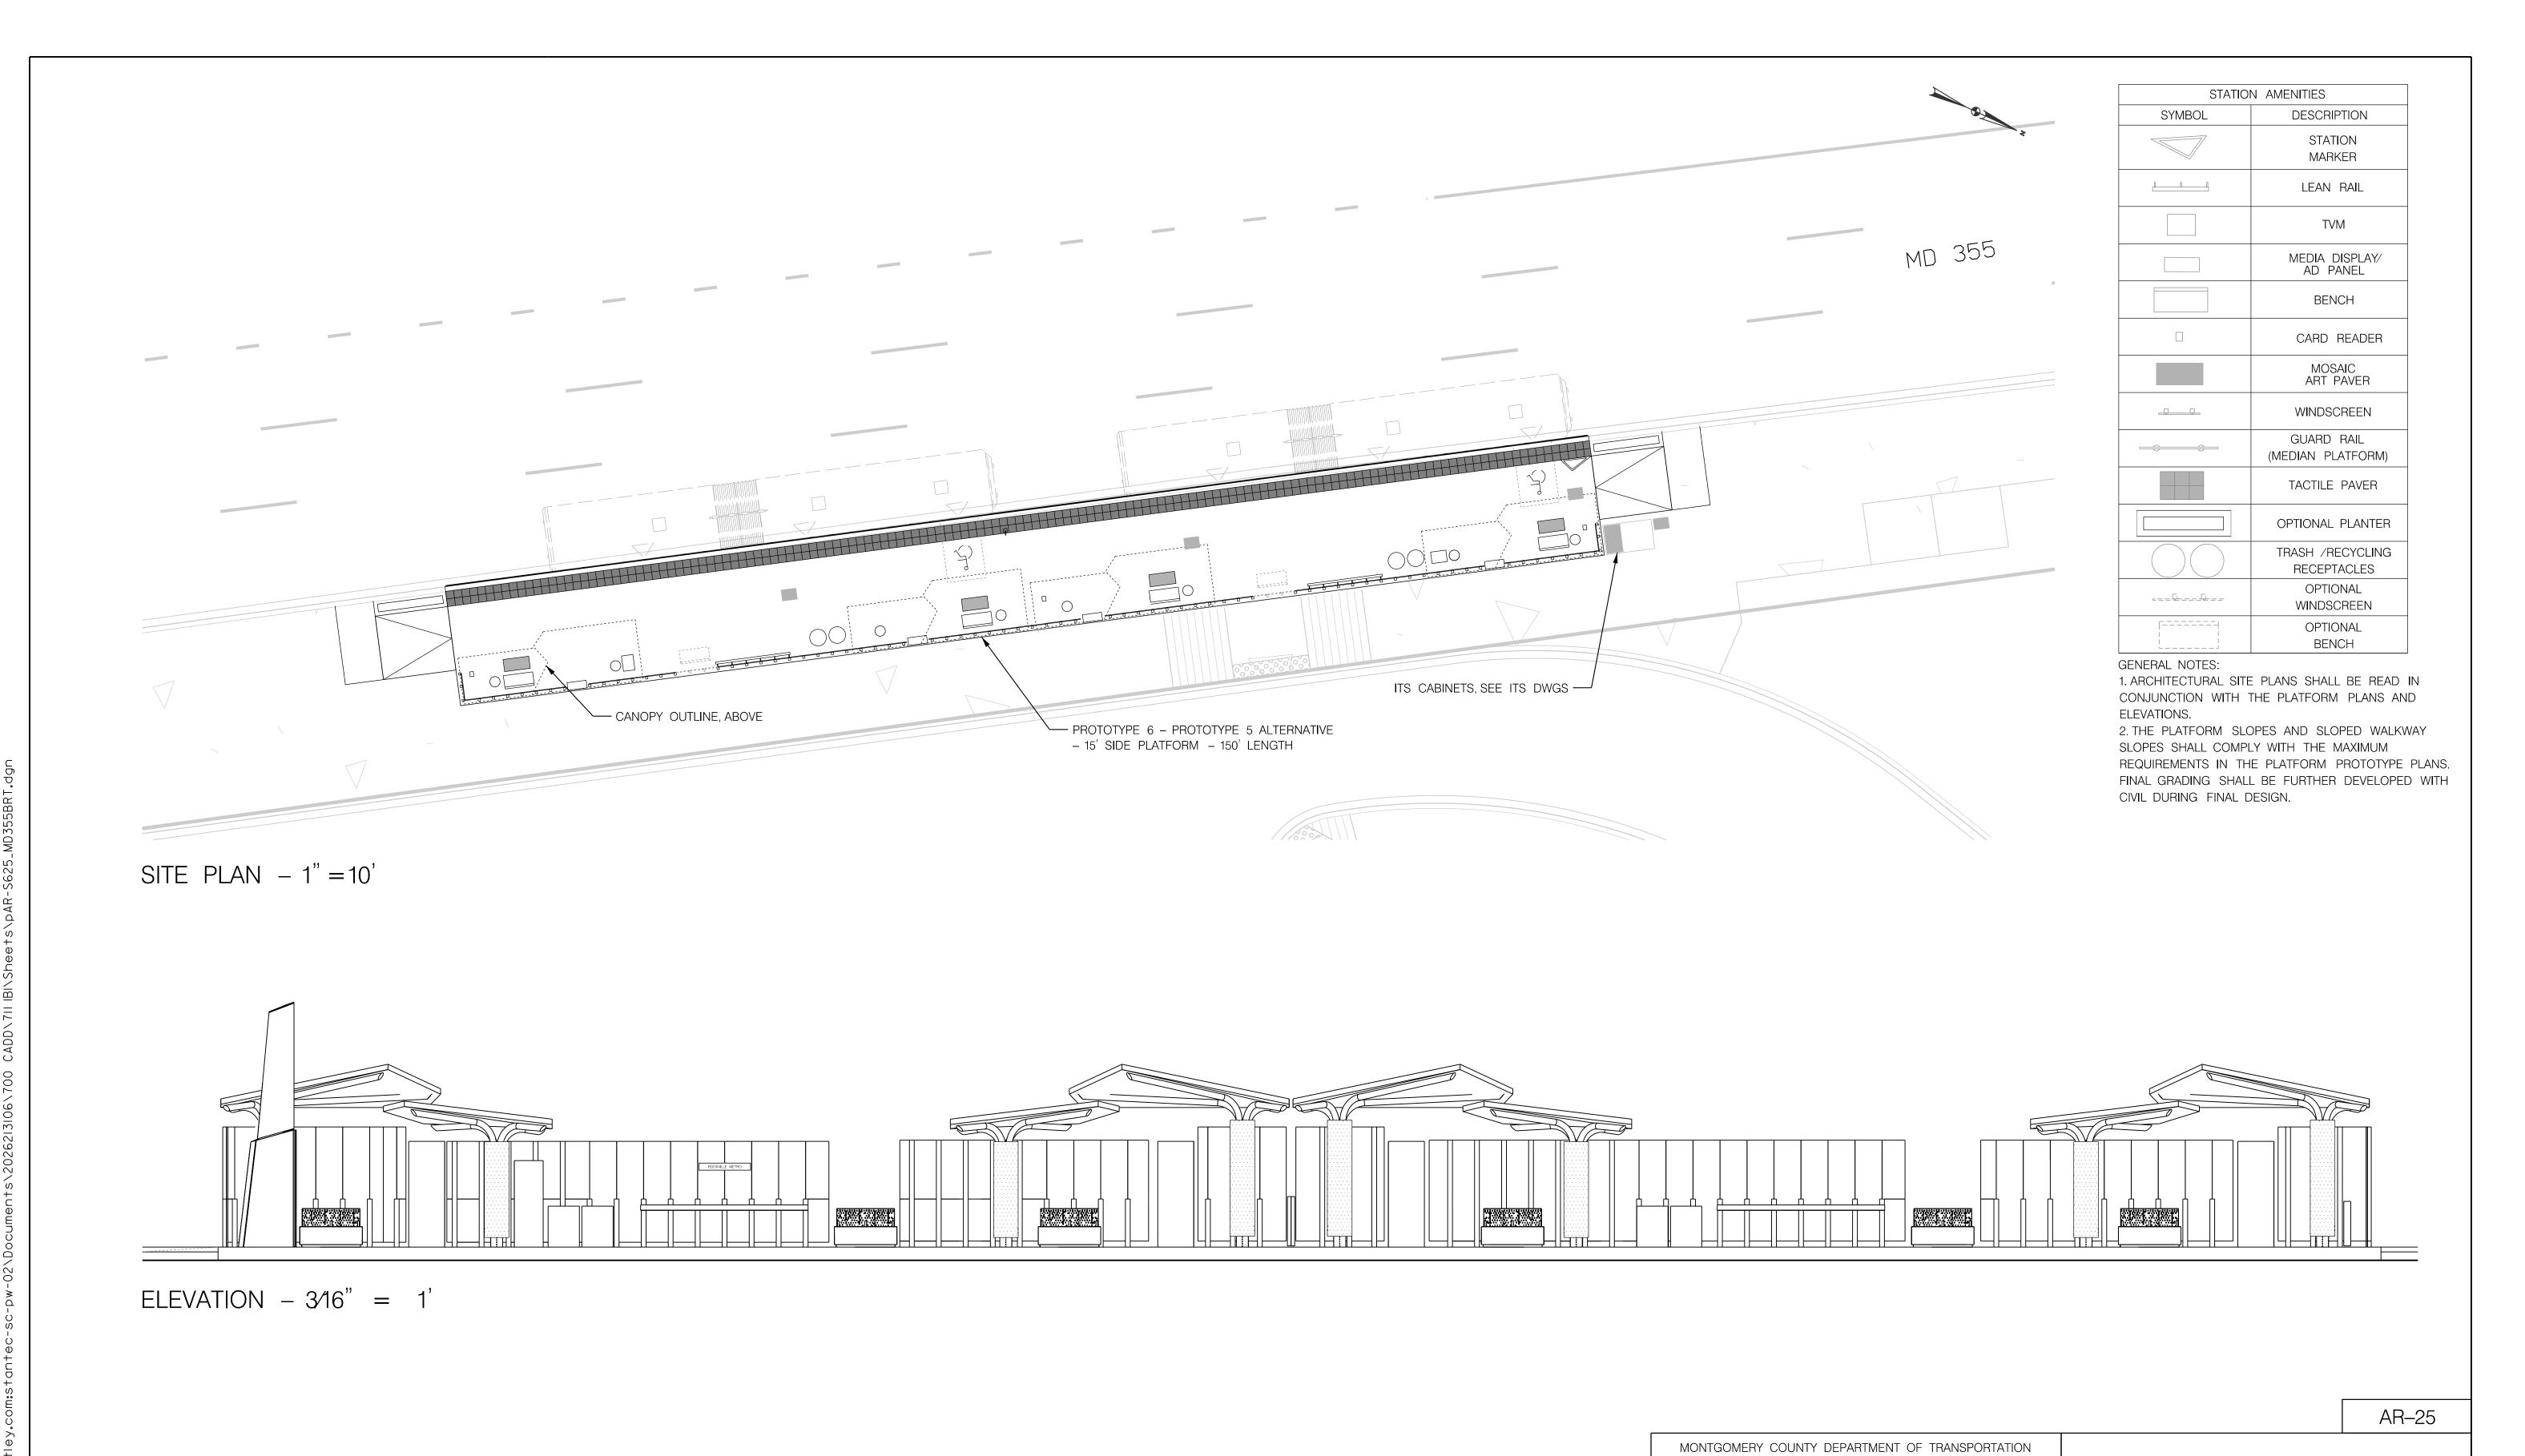
SCALE: 1'' = 5'DATE: DECEMBER 2022 SHEET <u>829</u> of <u>887</u> Project No. : 502005


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PROFESSIONAL CERTIFICATION:
I HEREBY CERTIFY THAT THESE DOCUMENTS WERE PREPARED OR APPROVED BY ME, AND THAT I AM A DULY LICENSED PROFESSIONAL ENGINEER UNDER THE LAWS OF THE STATE OF MARYLAND.

REVISION

LICENSE NO: _____ EXPIRATION DATE: ___



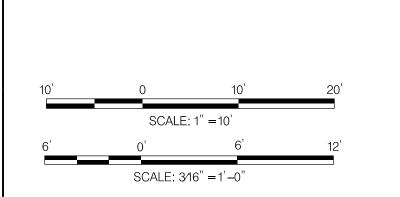

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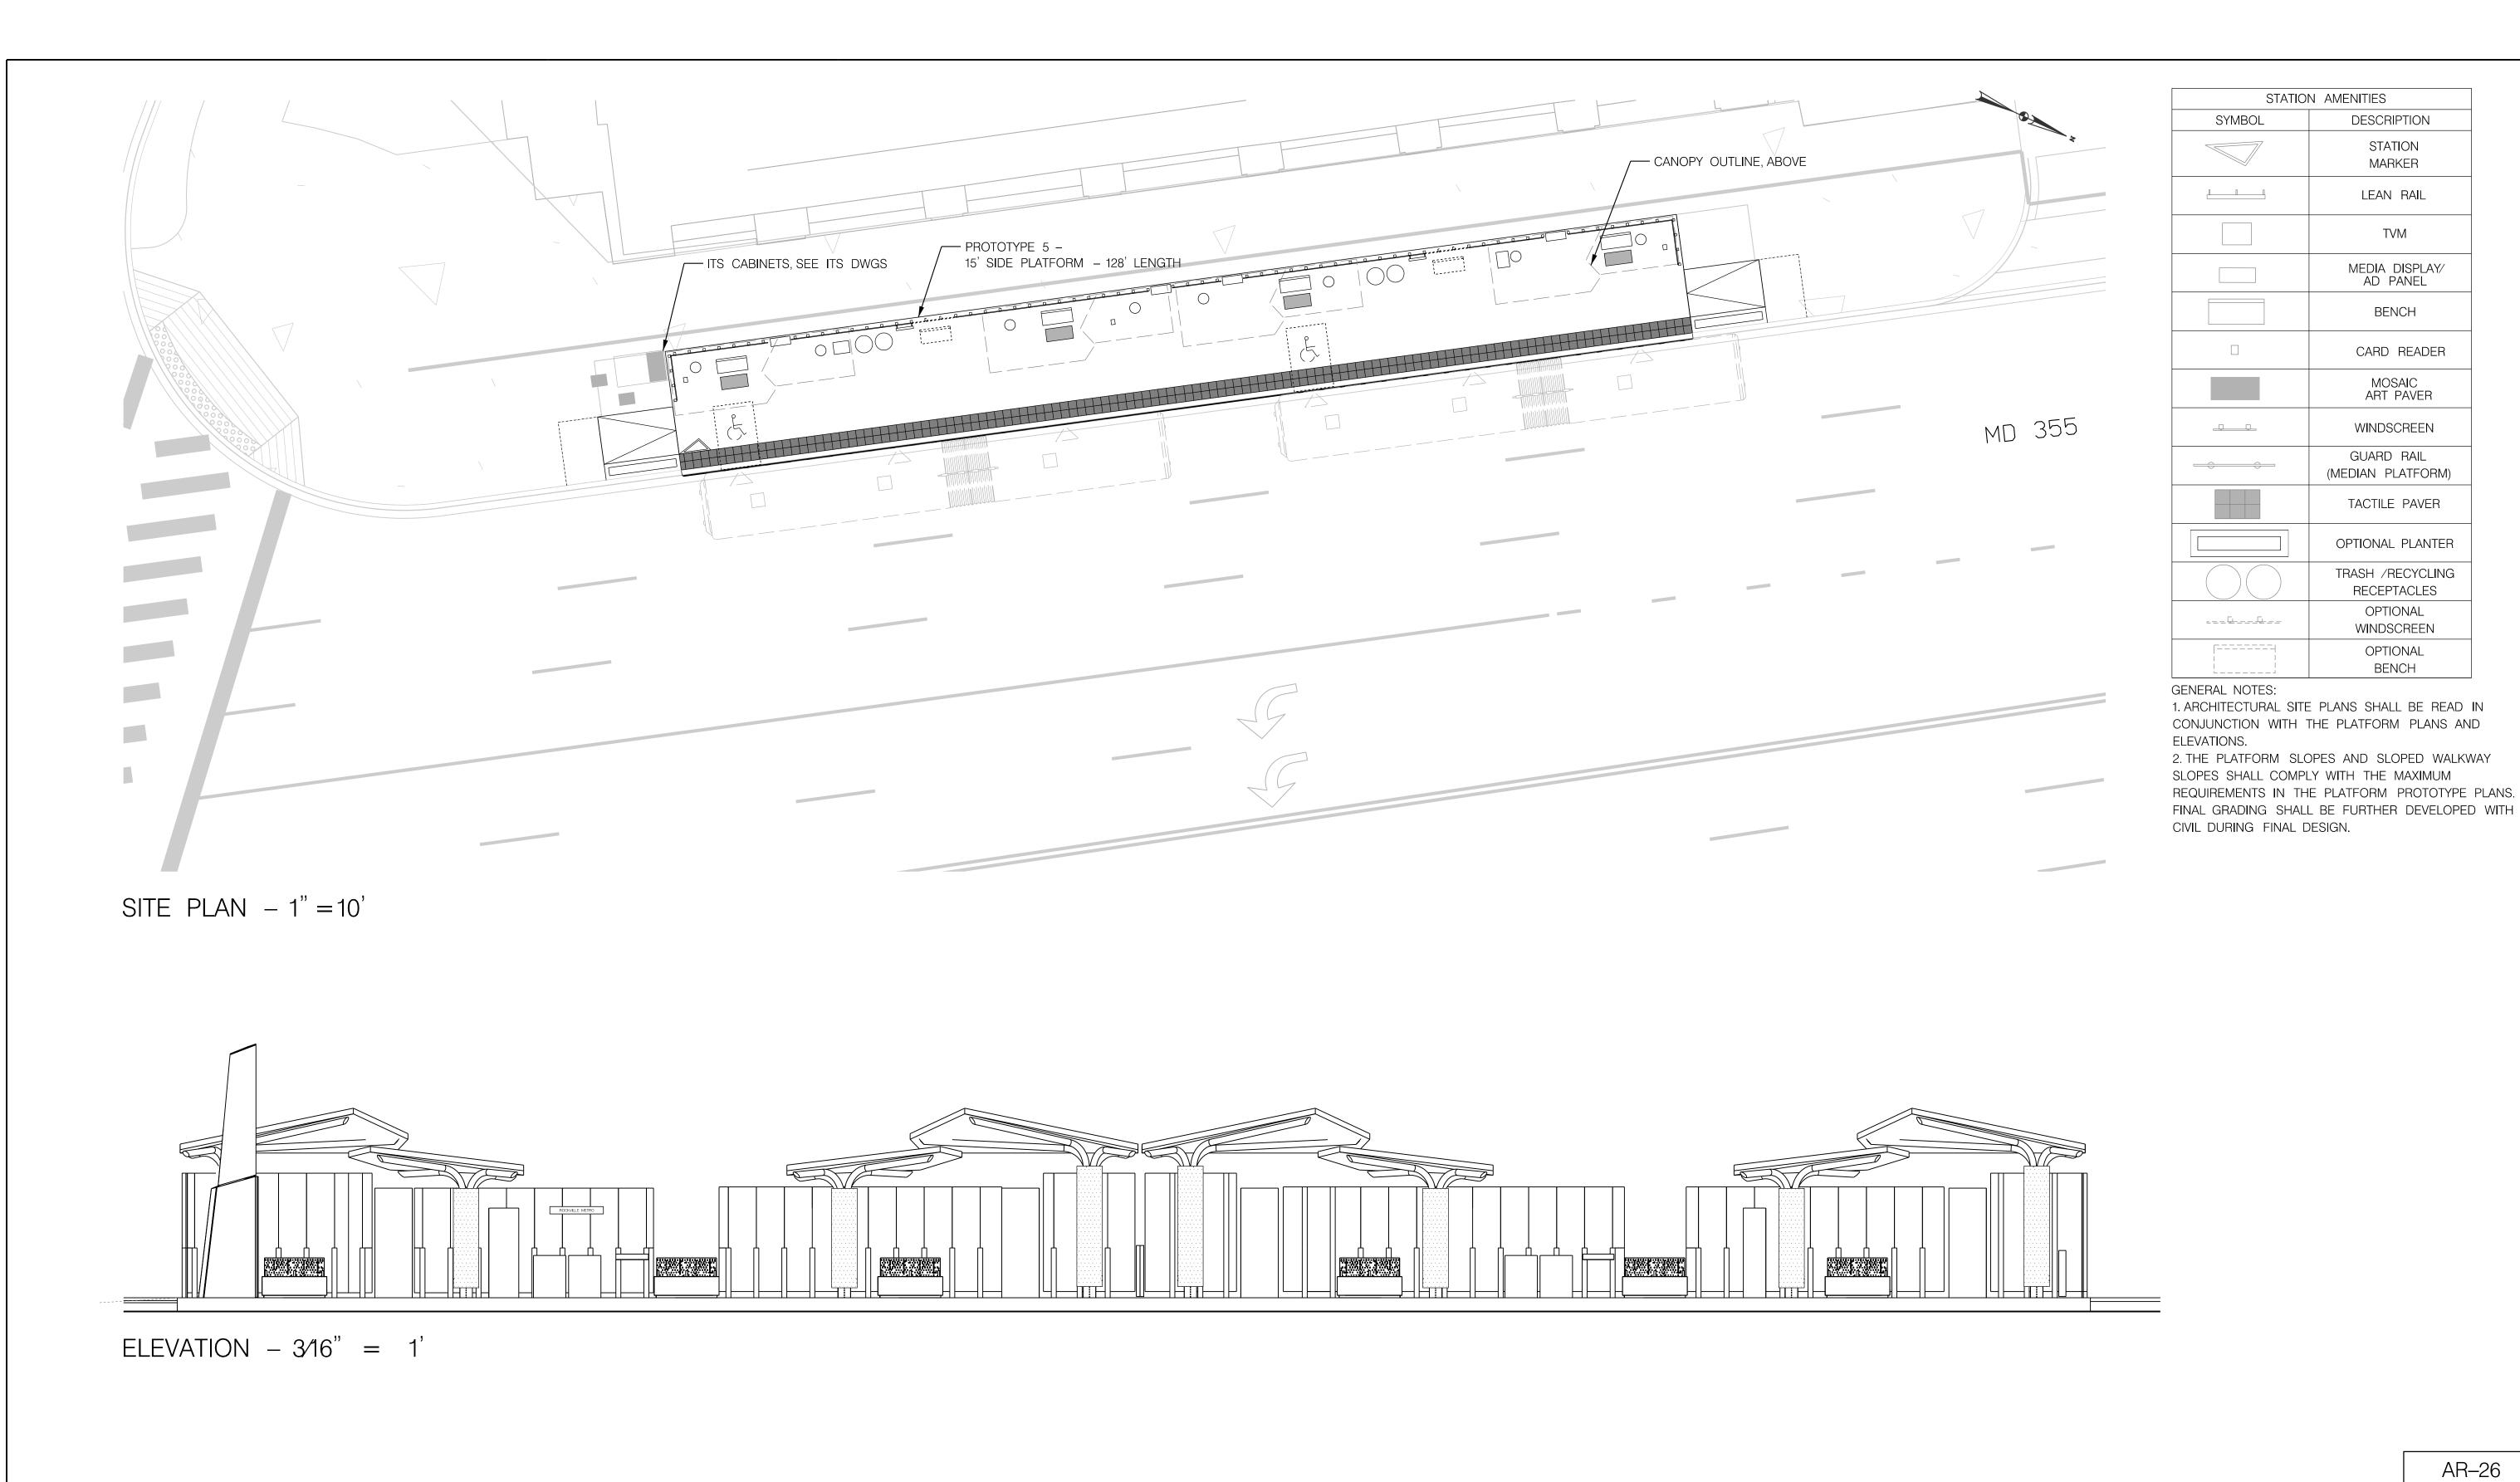
ROFESSIONAL CERTIFICATION:
HEREBY CERTIFY THAT THESE DOCUMENTS WERE PREPARED
R APPROVED BY ME, AND THAT I AM A DULY LICENSED
ROFESSIONAL ENGINEER UNDER THE LAWS OF THE STATE
F MARYLAND.
CENSE NO: EXPIRATION DATE:

				DIVISION OF TRANSPORTATION EN GAITHERSBURG, MARYLAN		
NO.	REVISION	DATE	ВУ	RECOMMENDED FOR APPROVAL		
				Chief, Design Section APPROVED	Date	
				Chief, Division of Transportation Engineering	Date	SO
				Designed by : Drawn by :	Checked by :	Pro

MD 355 BUS RAPID TRANSIT (BRT) ARCHITECTURAL SITE PLAN AND ELEVATION SEG 3 ROCKVILLE METRO

DATE: DECEMBER 2022 SCALE: VARIES Project No. : 502005

SHEET 830 of 887



	MONTGOMERY COUNTY DEPARTMENT OF TRANSPORTATION DIVISION OF TRANSPORTATION ENGINEERING GAITHERSBURG, MARYLAND	MI					
BY	RECOMMENDED FOR APPROVAL						
ВТ	Chief, Design Section Date APPROVED						
	Chief, Division of Transportation Engineering Date	SCAL					
	Designed by : Drawn by : Checked by :	Project					

REVISION

DATE

MD 355 BUS RAPID TRANSIT (BRT) ARCHITECTURAL SITE PLAN AND ELEVATION SEG 3 ROCKVILLE METRO

AR-26

DESCRIPTION

STATION

MARKER

LEAN RAIL

TVM

MEDIA DISPLAY/ AD PANEL

BENCH

CARD READER

MOSAIC ART PAVER

WINDSCREEN

GUARD RAIL

(MEDIAN PLATFORM)

TACTILE PAVER

OPTIONAL PLANTER

TRASH /RECYCLING RECEPTACLES OPTIONAL WINDSCREEN

> OPTIONAL BENCH


DATE: DECEMBER 2022 ALE : VARIES ect No. :502005 SHEET <u>831</u> of <u>887</u>

SCALE: 3/16" = 1'-0"

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PROFESSIONAL CERTIFICATION:
I HEREBY CERTIFY THAT THESE DOCUMENTS WERE PREPARED OR APPROVED BY ME, AND THAT I AM A DULY LICENSED PROFESSIONAL ENGINEER UNDER THE LAWS OF THE STATE

OF MARYLAND. LICENSE NO: ___ __ EXPIRATION DATE:

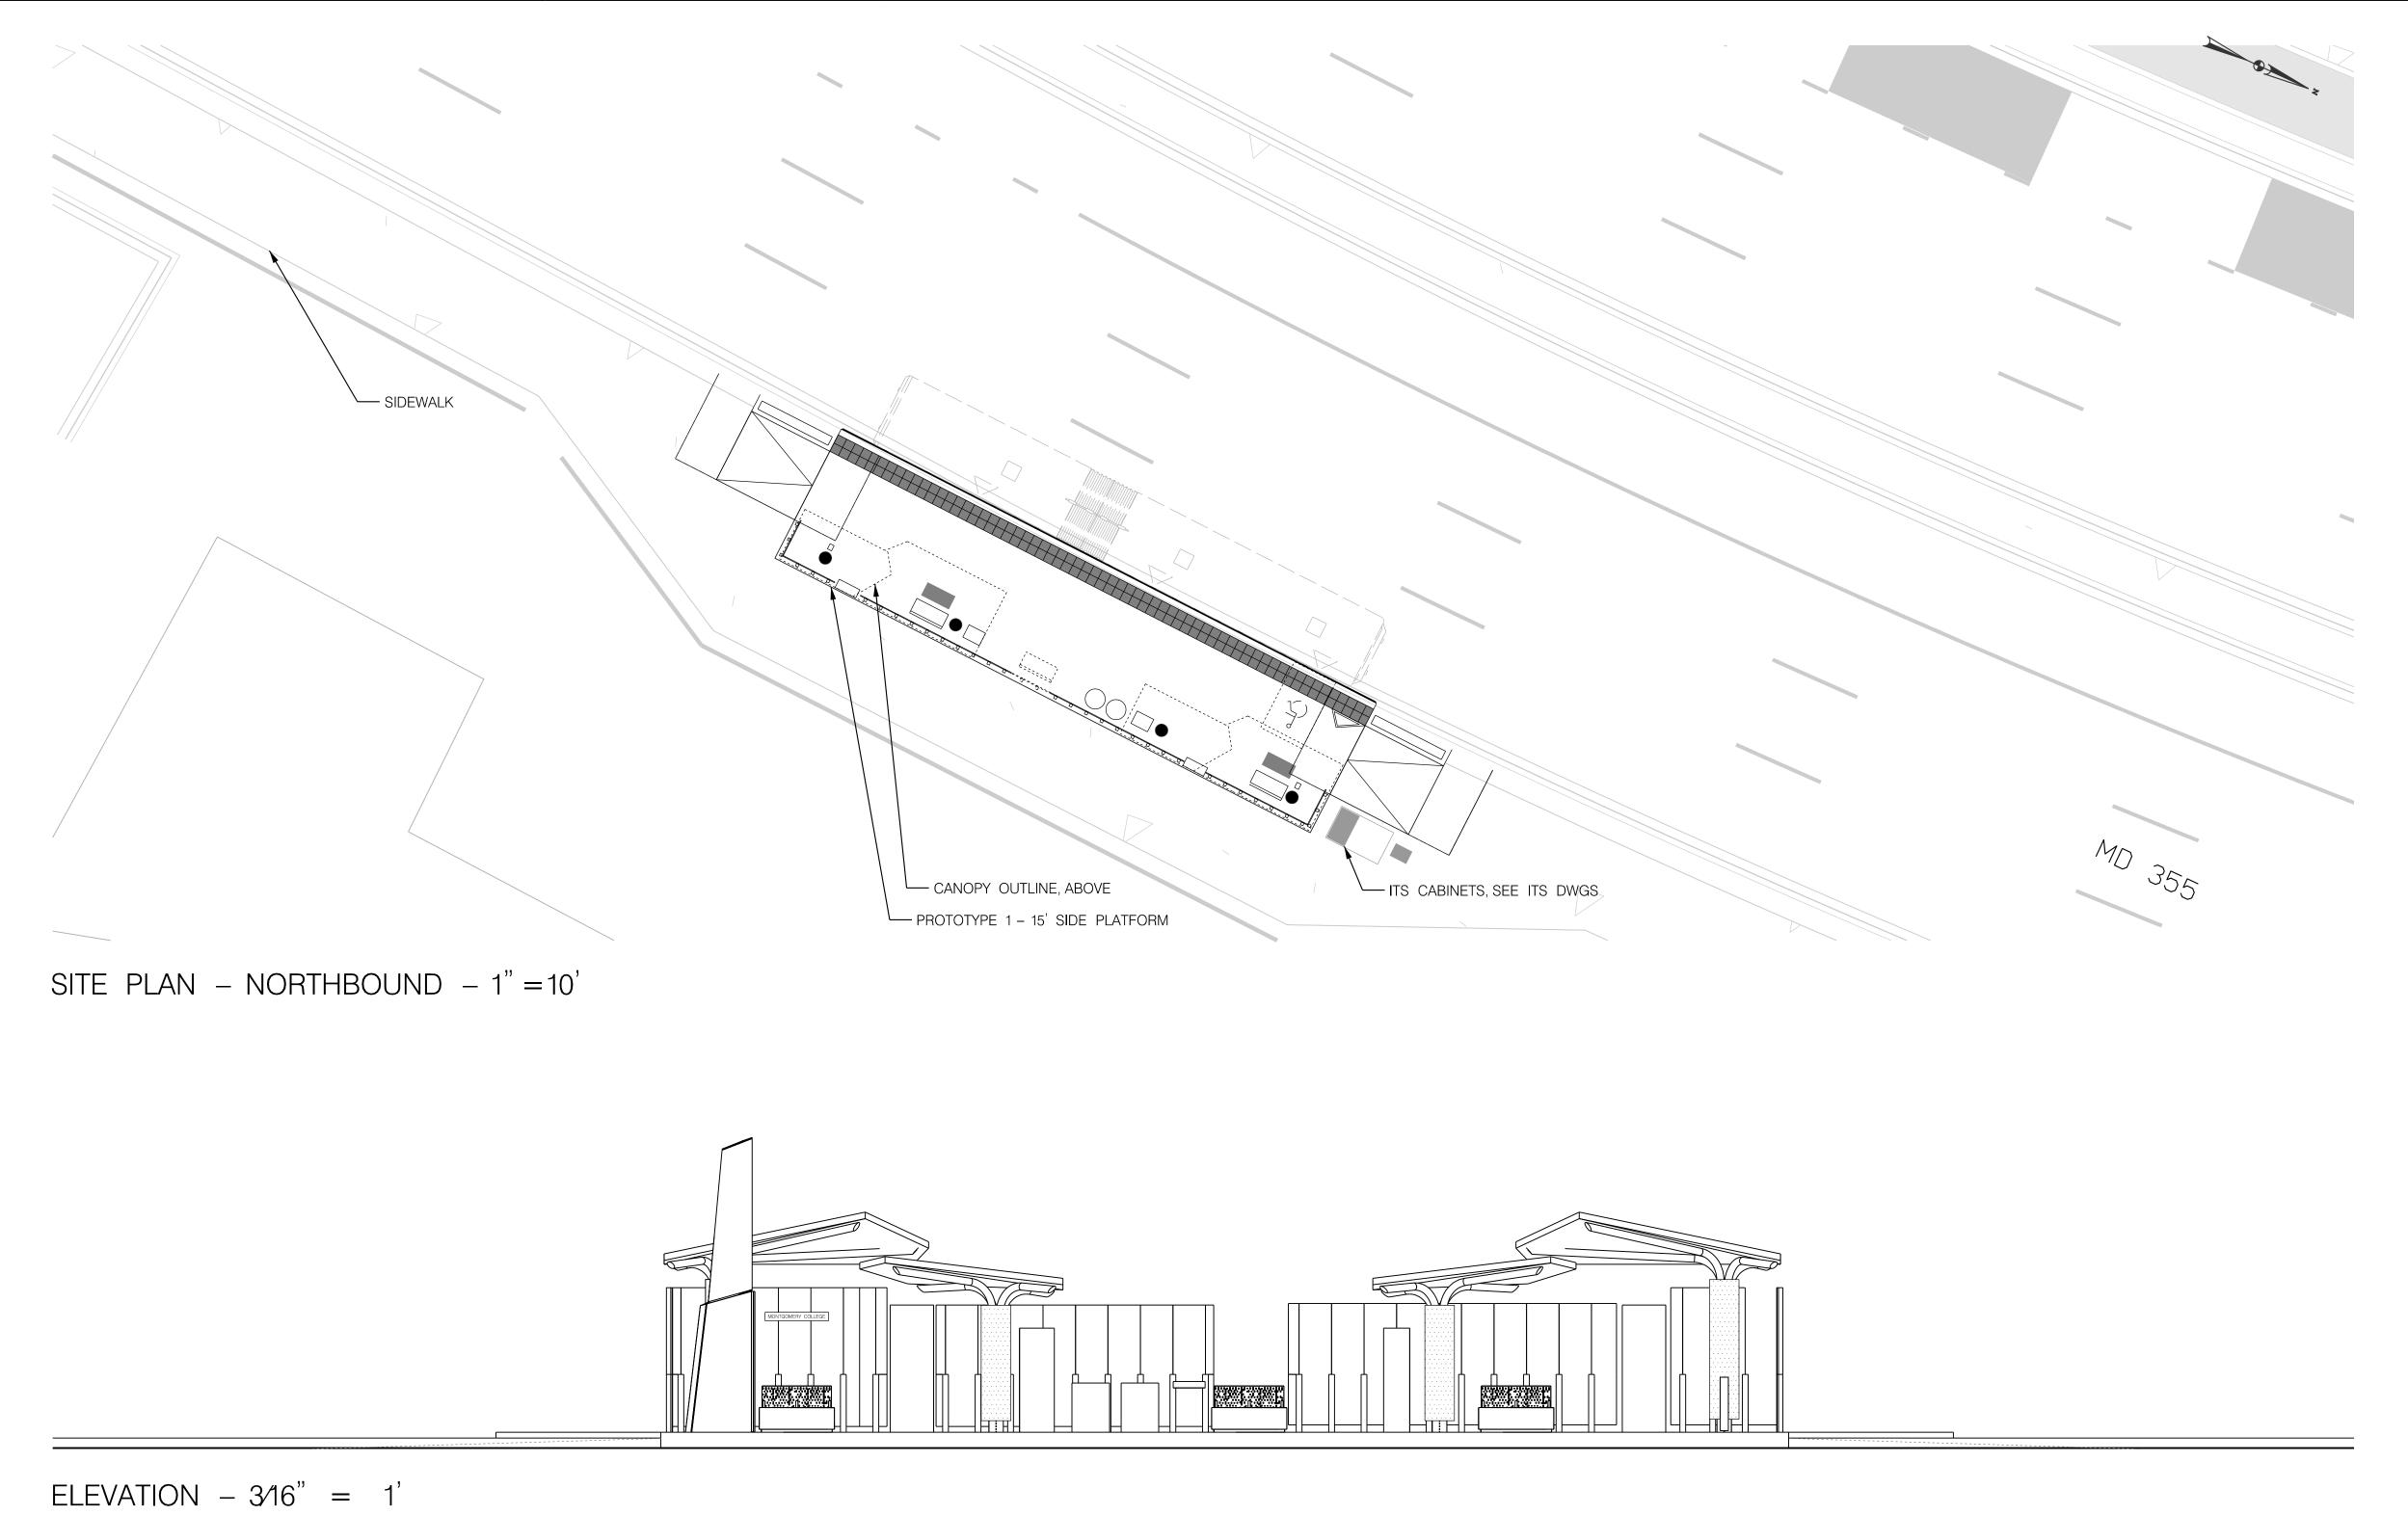

STATION AMENITIES SYMBOL DESCRIPTION STATION MARKER LEAN RAIL TVM MEDIA DISPLAY/ AD PANEL BENCH CARD READER MOSAIC ART PAVER WINDSCREEN GUARD RAIL (MEDIAN PLATFORM) TACTILE PAVER OPTIONAL PLANTER TRASH /RECYCLING RECEPTACLES OPTIONAL WINDSCREEN [-----OPTIONAL BENCH

GENERAL NOTES: 1. ARCHITECTURAL SITE PLANS SHALL BE READ IN CONJUNCTION WITH THE PLATFORM PLANS AND ELEVATIONS.

2. THE PLATFORM SLOPES AND SLOPED WALKWAY SLOPES SHALL COMPLY WITH THE MAXIMUM REQUIREMENTS IN THE PLATFORM PROTOTYPE PLANS. FINAL GRADING SHALL BE FURTHER DEVELOPED WITH CIVIL DURING FINAL DESIGN.

MONTGOMERY COUNTY DEPARTMENT OF TRANSPORTATION DIVISION OF TRANSPORTATION ENGINEERING GAITHERSBURG, MARYLAND RECOMMENDED FOR APPROVAL DATE BY Chief, Design Section APPROVED

Checked by : _

Chief, Division of Transportation Engineering

Designed by :_____ Drawn by :____

REVISION

MD 355 BUS RAPID TRANSIT (BRT) ARCHITECTURAL SITE PLAN AND ELEVATION SEG 3 MONTGOMERY COLLEGE

AR-27

DATE: DECEMBER 2022 SCALE: VARIES SHEET 832 of 887 Project No. :502005


SCALE: 3/16" = 1'-0"

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PROFESSIONAL CERTIFICATION: I HEREBY CERTIFY THAT THESE DOCUMENTS WERE PREPARED OR APPROVED BY ME, AND THAT I AM A DULY LICENSED PROFESSIONAL ENGINEER UNDER THE LAWS OF THE STATE OF MARYLAND.

655 15th Street – Suite 800 Washington DC 20005 USA tel 703 836 9600


LICENSE NO: _____ ___ EXPIRATION DATE: _

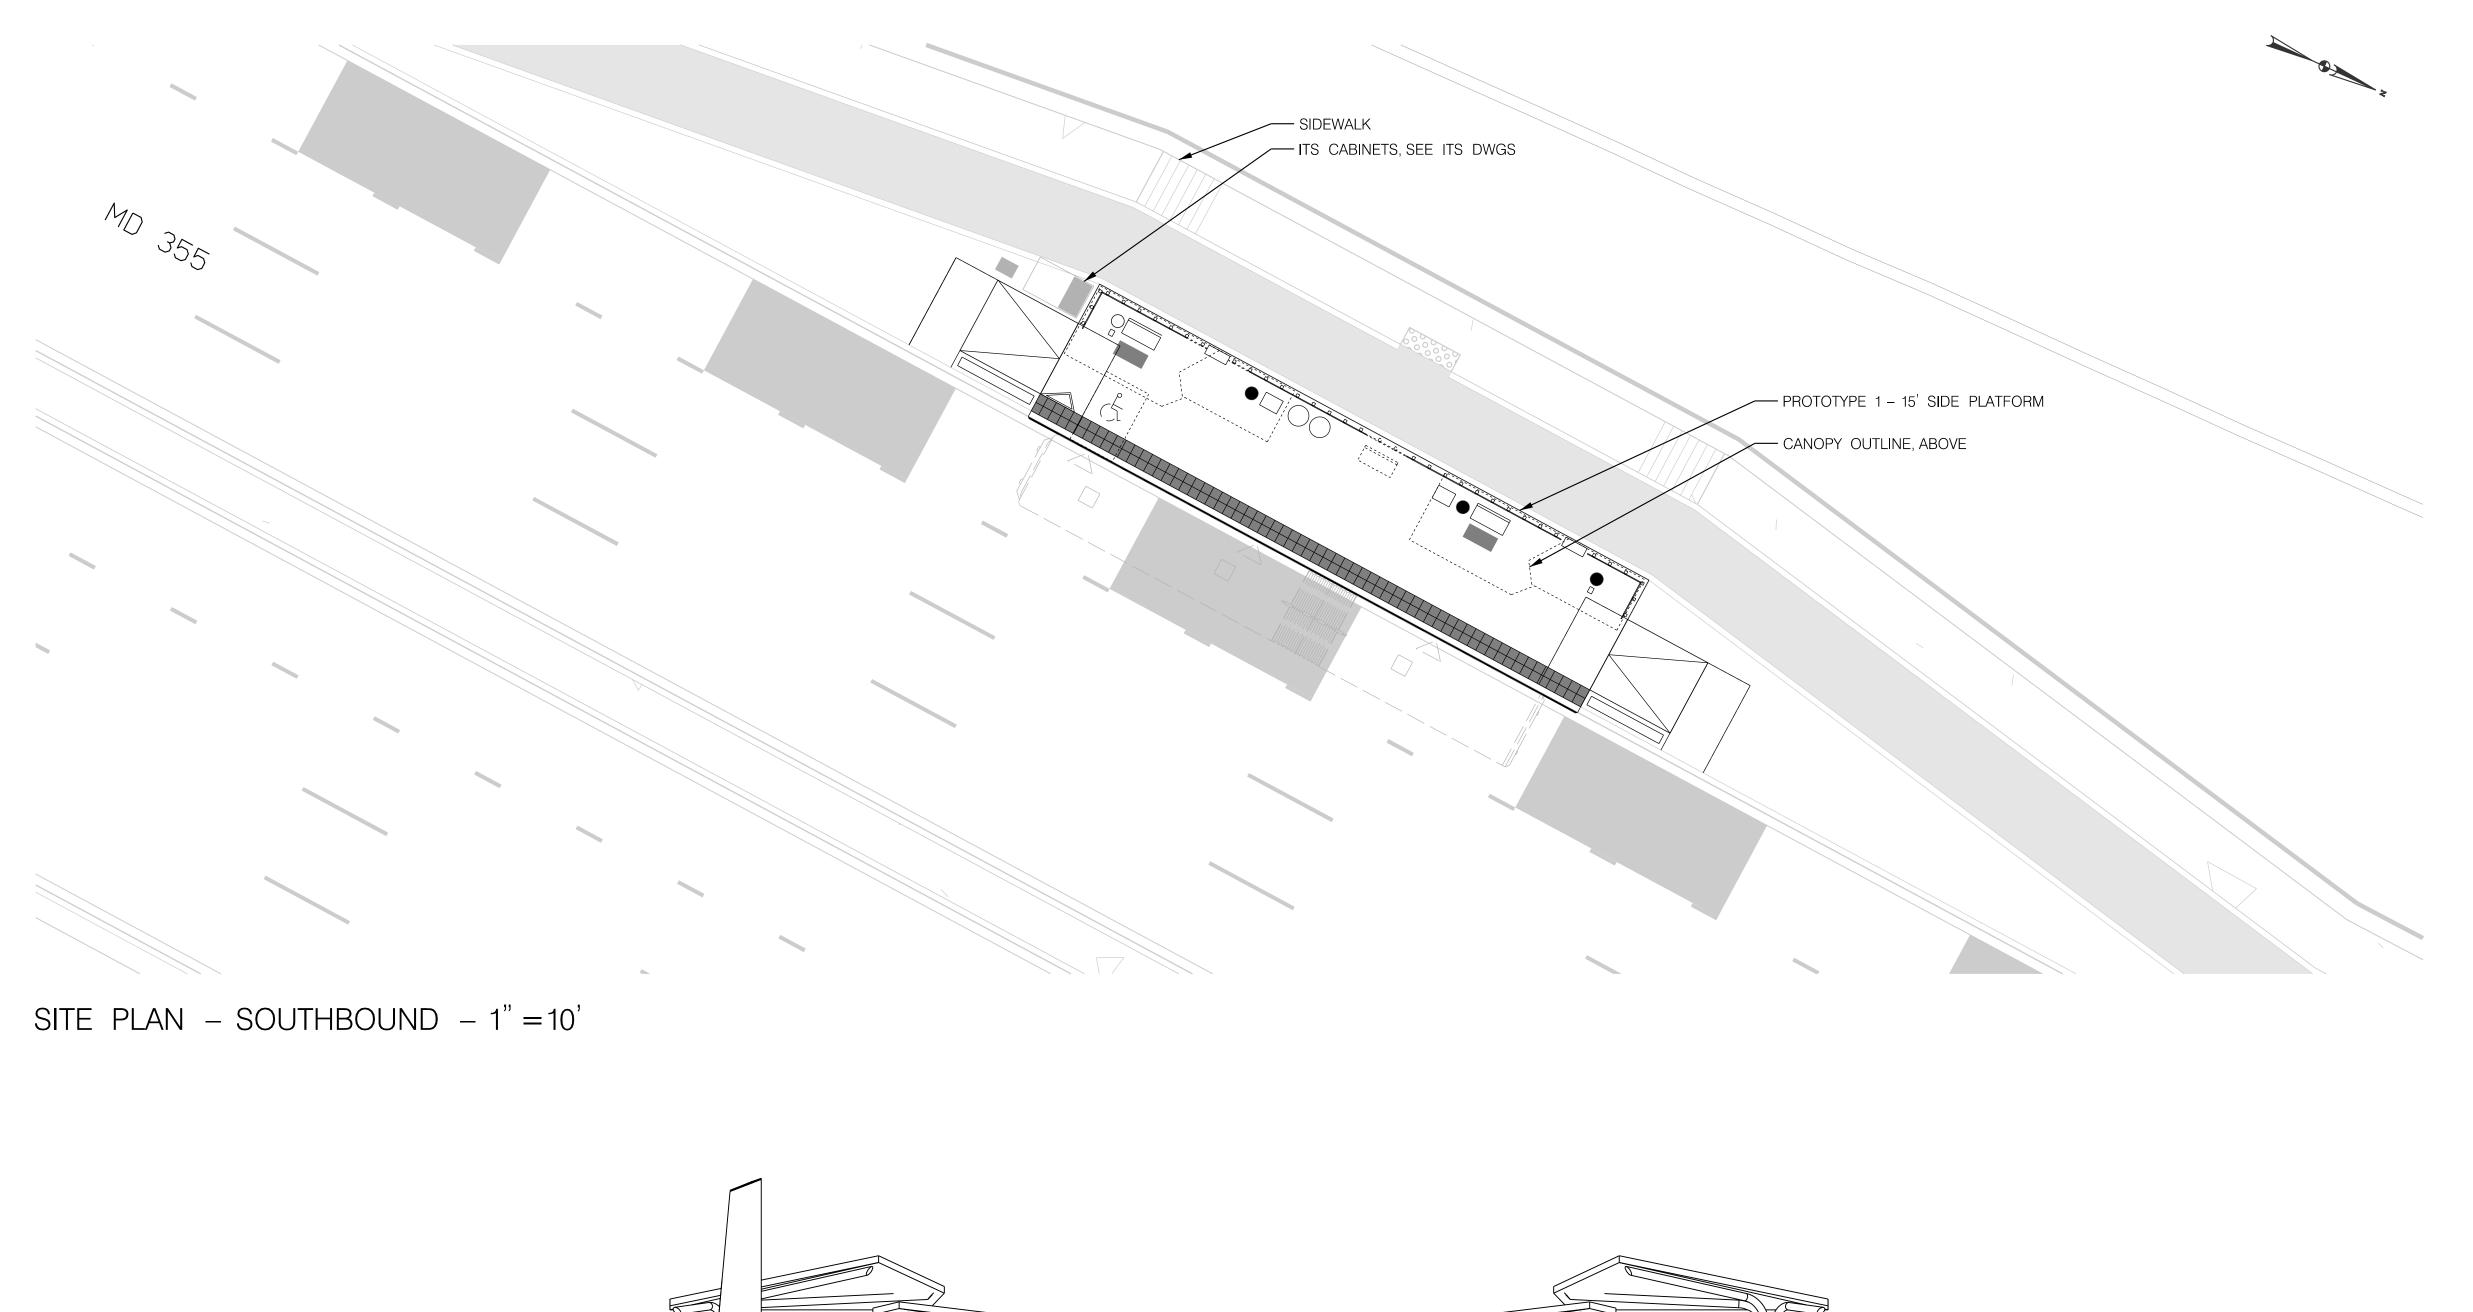

N AMENITIES
DESCRIPTION
STATION MARKER
LEAN RAIL
TVM
MEDIA DISPLAY/ AD PANEL
BENCH
CARD READER
MOSAIC ART PAVER
WINDSCREEN
GUARD RAIL (MEDIAN PLATFORM)
TACTILE PAVER
OPTIONAL PLANTER
TRASH /RECYCLING RECEPTACLES
OPTIONAL WINDSCREEN
OPTIONAL BENCH

GENERAL NOTES: 1. ARCHITECTURAL SITE PLANS SHALL BE READ IN CONJUNCTION WITH THE PLATFORM PLANS AND ELEVATIONS.

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REVISION

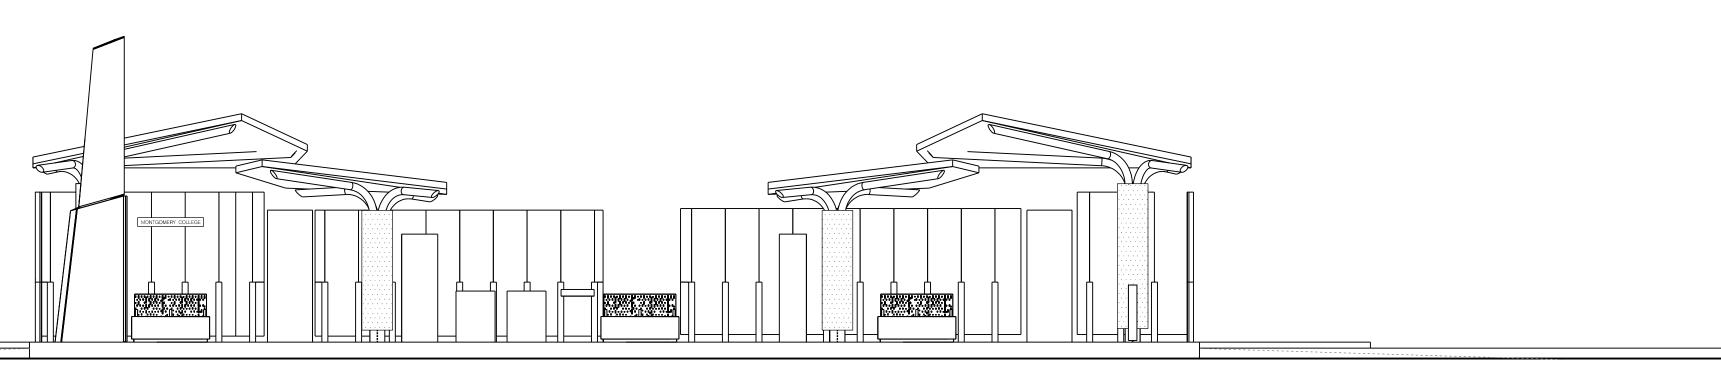DATE BY

MONTGOMERY COUNTY DEPARTMENT OF TRANSPORTATION

Checked by : _

DIVISION OF TRANSPORTATION ENGINEERING GAITHERSBURG, MARYLAND RECOMMENDED FOR APPROVAL

Designed by :_____ Drawn by :____

Chief, Design Section APPROVED Chief, Division of Transportation Engineering MD 355 BUS RAPID TRANSIT (BRT) ARCHITECTURAL SITE PLAN AND ELEVATION SEG 3 MONTGOMERY COLLEGE

AR-28

DATE: DECEMBER 2022 SCALE: VARIES SHEET <u>833</u> of <u>887</u> Project No. : 502005


SCALE: 3/16" = 1'-0"

ELEVATION - 3/16" = 1'


IBI GROUP
655 15th Street – Suite 800
Washington DC 20005 USA
tel 703 836 9600 ibigroup.com

PROFESSIONAL CERTIFICATION:
I HEREBY CERTIFY THAT THESE DOCUMENTS WERE PREPARED OR APPROVED BY ME, AND THAT I AM A DULY LICENSED PROFESSIONAL ENGINEER UNDER THE LAWS OF THE STATE

OF MARYLAND. LICENSE NO: _____ ___ EXPIRATION DATE: _

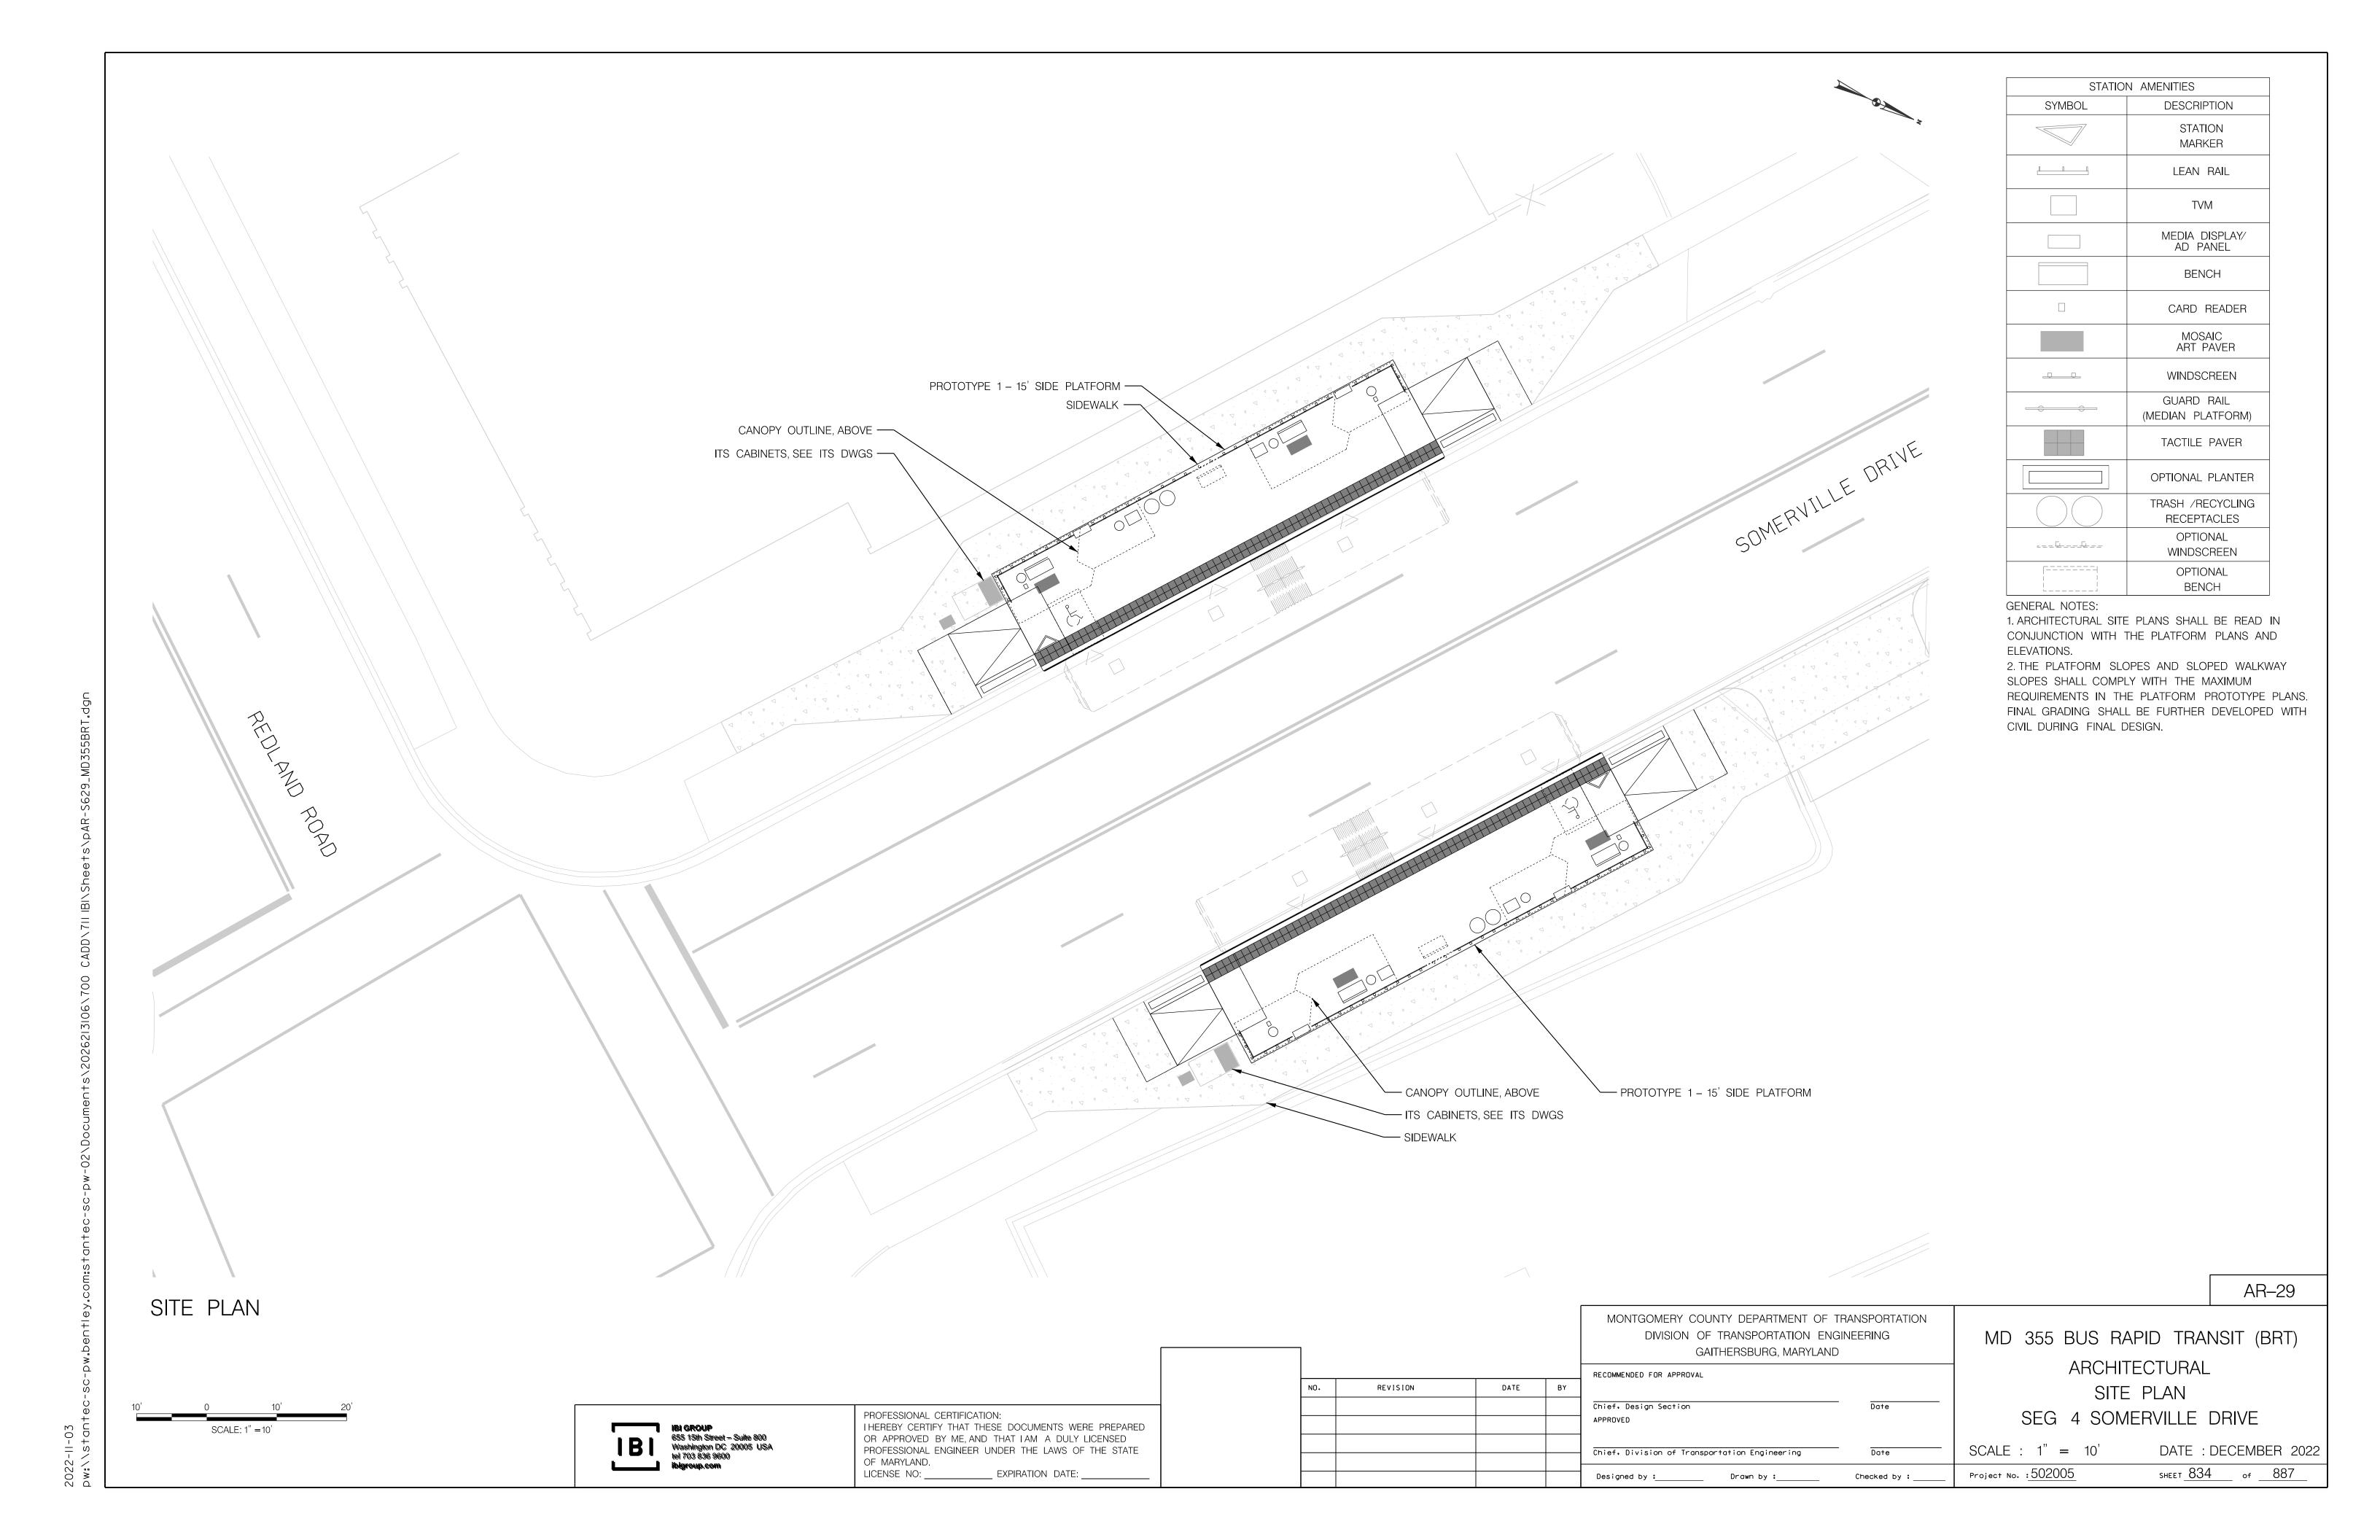

ELEVATION - SOUTHBOUND

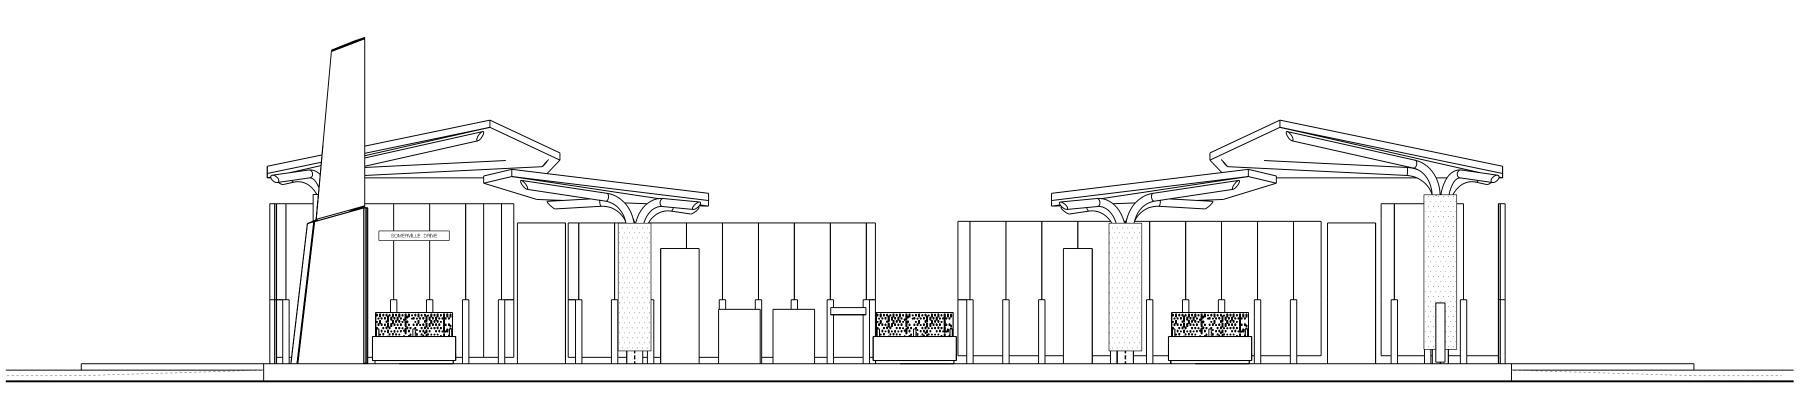

ELEVATION - NORTHBOUND

AR-30

MONTGOMERY COUNTY DEPARTMENT OF TRANSPORTATION DIVISION OF TRANSPORTATION ENGINEERING GAITHERSBURG, MARYLAND RECOMMENDED FOR APPROVAL DATE BY Chief, Design Section APPROVED

MD 355 BUS RAPID TRANSIT (BRT) ARCHITECTURAL ELEVATION SEG 4 SOMERVILLE DRIVE

SCALE: 1" = 5'DATE: DECEMBER 2022

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Washington DC 20005 USA
tel 703 836 9600
ibigroup com ibigroup.com

PROFESSIONAL CERTIFICATION:
I HEREBY CERTIFY THAT THESE DOCUMENTS WERE PREPARED OR APPROVED BY ME, AND THAT I AM A DULY LICENSED PROFESSIONAL ENGINEER UNDER THE LAWS OF THE STATE OF MARYLAND. LICENSE NO: _____ ___ EXPIRATION DATE: __

SCALE: 1'' = 5'

REVISION

Chief, Division of Transportation Engineering

Designed by :_____ Drawn by :____

Checked by : _

Project No. : 502005

GENERAL NOTES:

CIVIL DURING FINAL DESIGN.

ELEVATIONS.


1. ARCHITECTURAL SITE PLANS SHALL BE READ IN CONJUNCTION WITH THE PLATFORM PLANS AND

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REQUIREMENTS IN THE PLATFORM PROTOTYPE PLANS. FINAL GRADING SHALL BE FURTHER DEVELOPED WITH

SLOPES SHALL COMPLY WITH THE MAXIMUM

SHEET <u>835</u> of <u>887</u>

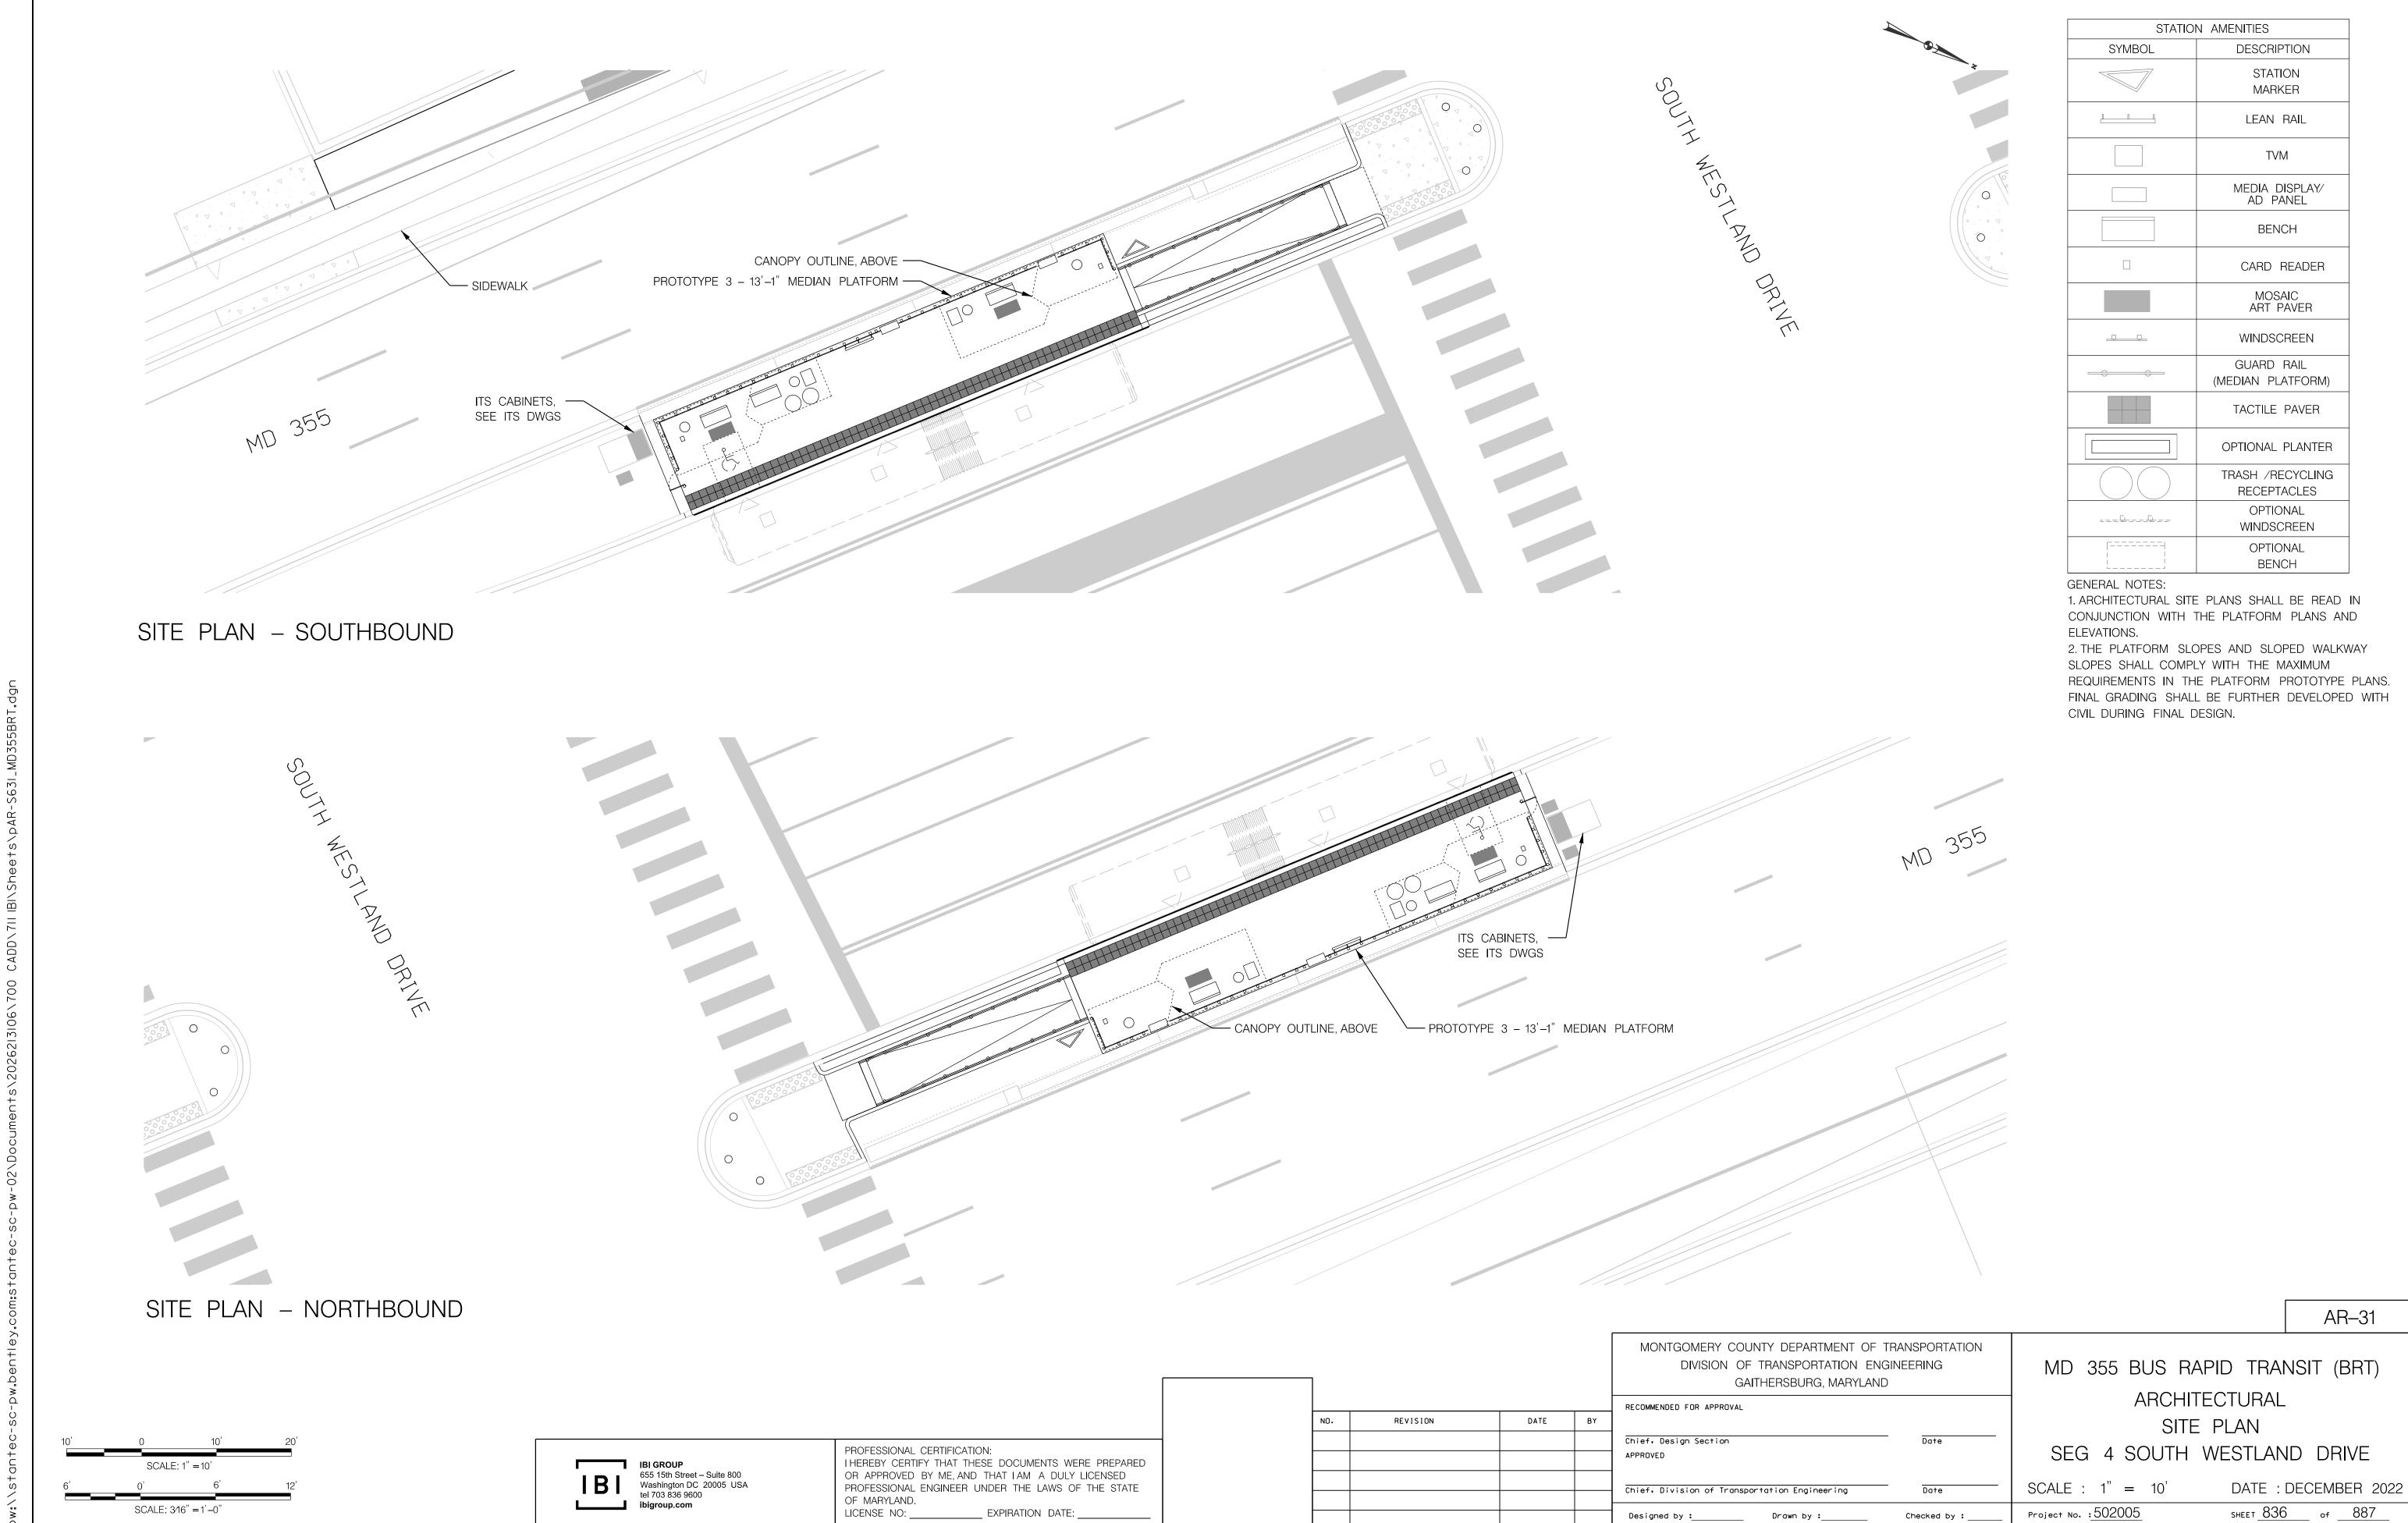

2022-11-03

ELEVATION - NORTHBOUND

REVISION

AR-32

MONTGOMERY COUNTY DEPARTMENT OF TRANSPORTATION DIVISION OF TRANSPORTATION ENGINEERING GAITHERSBURG, MARYLAND RECOMMENDED FOR APPROVAL DATE BY Chief. Design Section APPROVED Chief, Division of Transportation Engineering

Checked by : $_$

Designed by :_____ Drawn by :____

MD 355 BUS RAPID TRANSIT (BRT) ARCHITECTURAL ELEVATION SEG 4 SOUTH WESTLAND DRIVE

GENERAL NOTES:

CIVIL DURING FINAL DESIGN.

ELEVATIONS.

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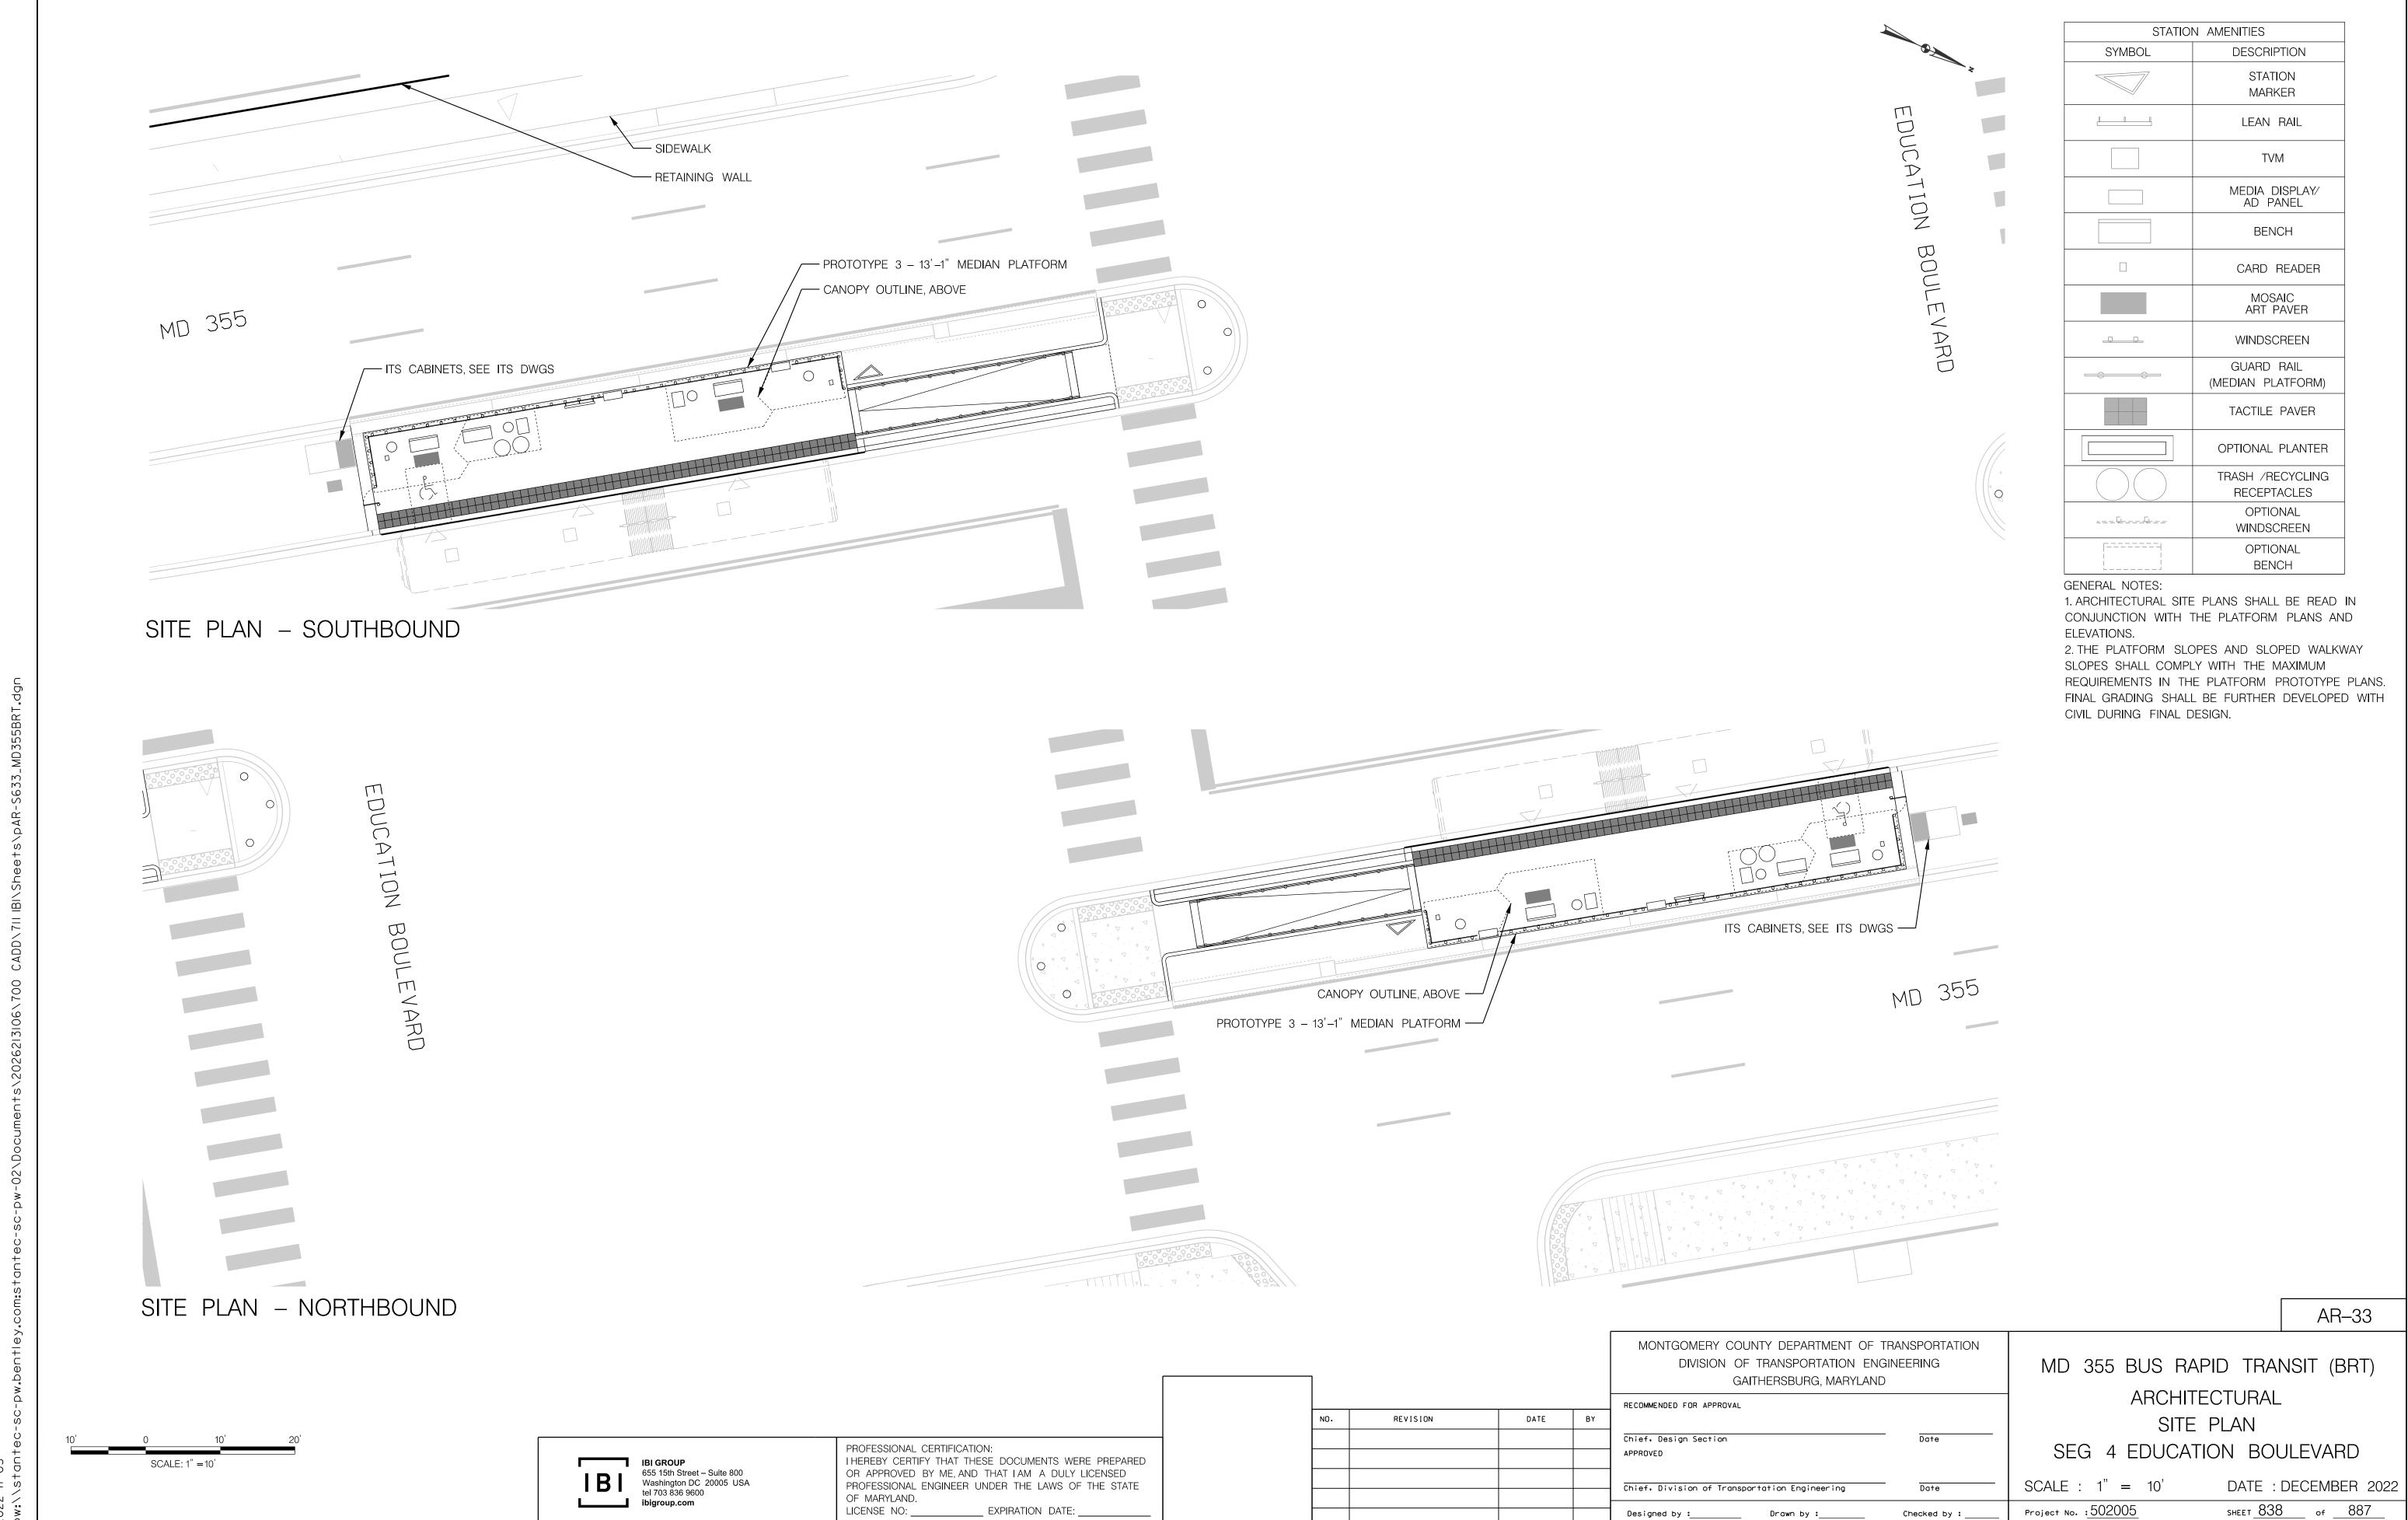
SCALE : 1" = 5"

DATE: DECEMBER 2022 SHEET <u>837</u> of <u>887</u> Project No. : 502005

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SCALE: 1'' = 5'



Drawn by :____

AR-34

MONTGOMERY COUNTY DEPARTMENT OF TRANSPORTATION DIVISION OF TRANSPORTATION ENGINEERING GAITHERSBURG, MARYLAND RECOMMENDED FOR APPROVAL DATE BY Chief. Design Section APPROVED

Checked by : $_$

ELEVATION SEG 4 EDUCATION BOULEVARD

MD 355 BUS RAPID TRANSIT (BRT)

ARCHITECTURAL

SCALE: 1'' = 5'DATE: DECEMBER 2022

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Washington DC 20005 USA
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PROFESSIONAL CERTIFICATION:
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OF MARYLAND. LICENSE NO: _____ EXPIRATION DATE: ___

Chief, Division of Transportation Engineering Designed by :_____ Drawn by :____

REVISION

Project No. : 502005

GENERAL NOTES:

CIVIL DURING FINAL DESIGN.

ELEVATIONS.


1. ARCHITECTURAL SITE PLANS SHALL BE READ IN CONJUNCTION WITH THE PLATFORM PLANS AND

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SHEET <u>839</u> of <u>887</u>



2022-11-03

GENERAL NOTES: 1. ARCHITECTURAL SITE PLANS SHALL BE READ IN CONJUNCTION WITH THE PLATFORM PLANS AND ELEVATIONS.
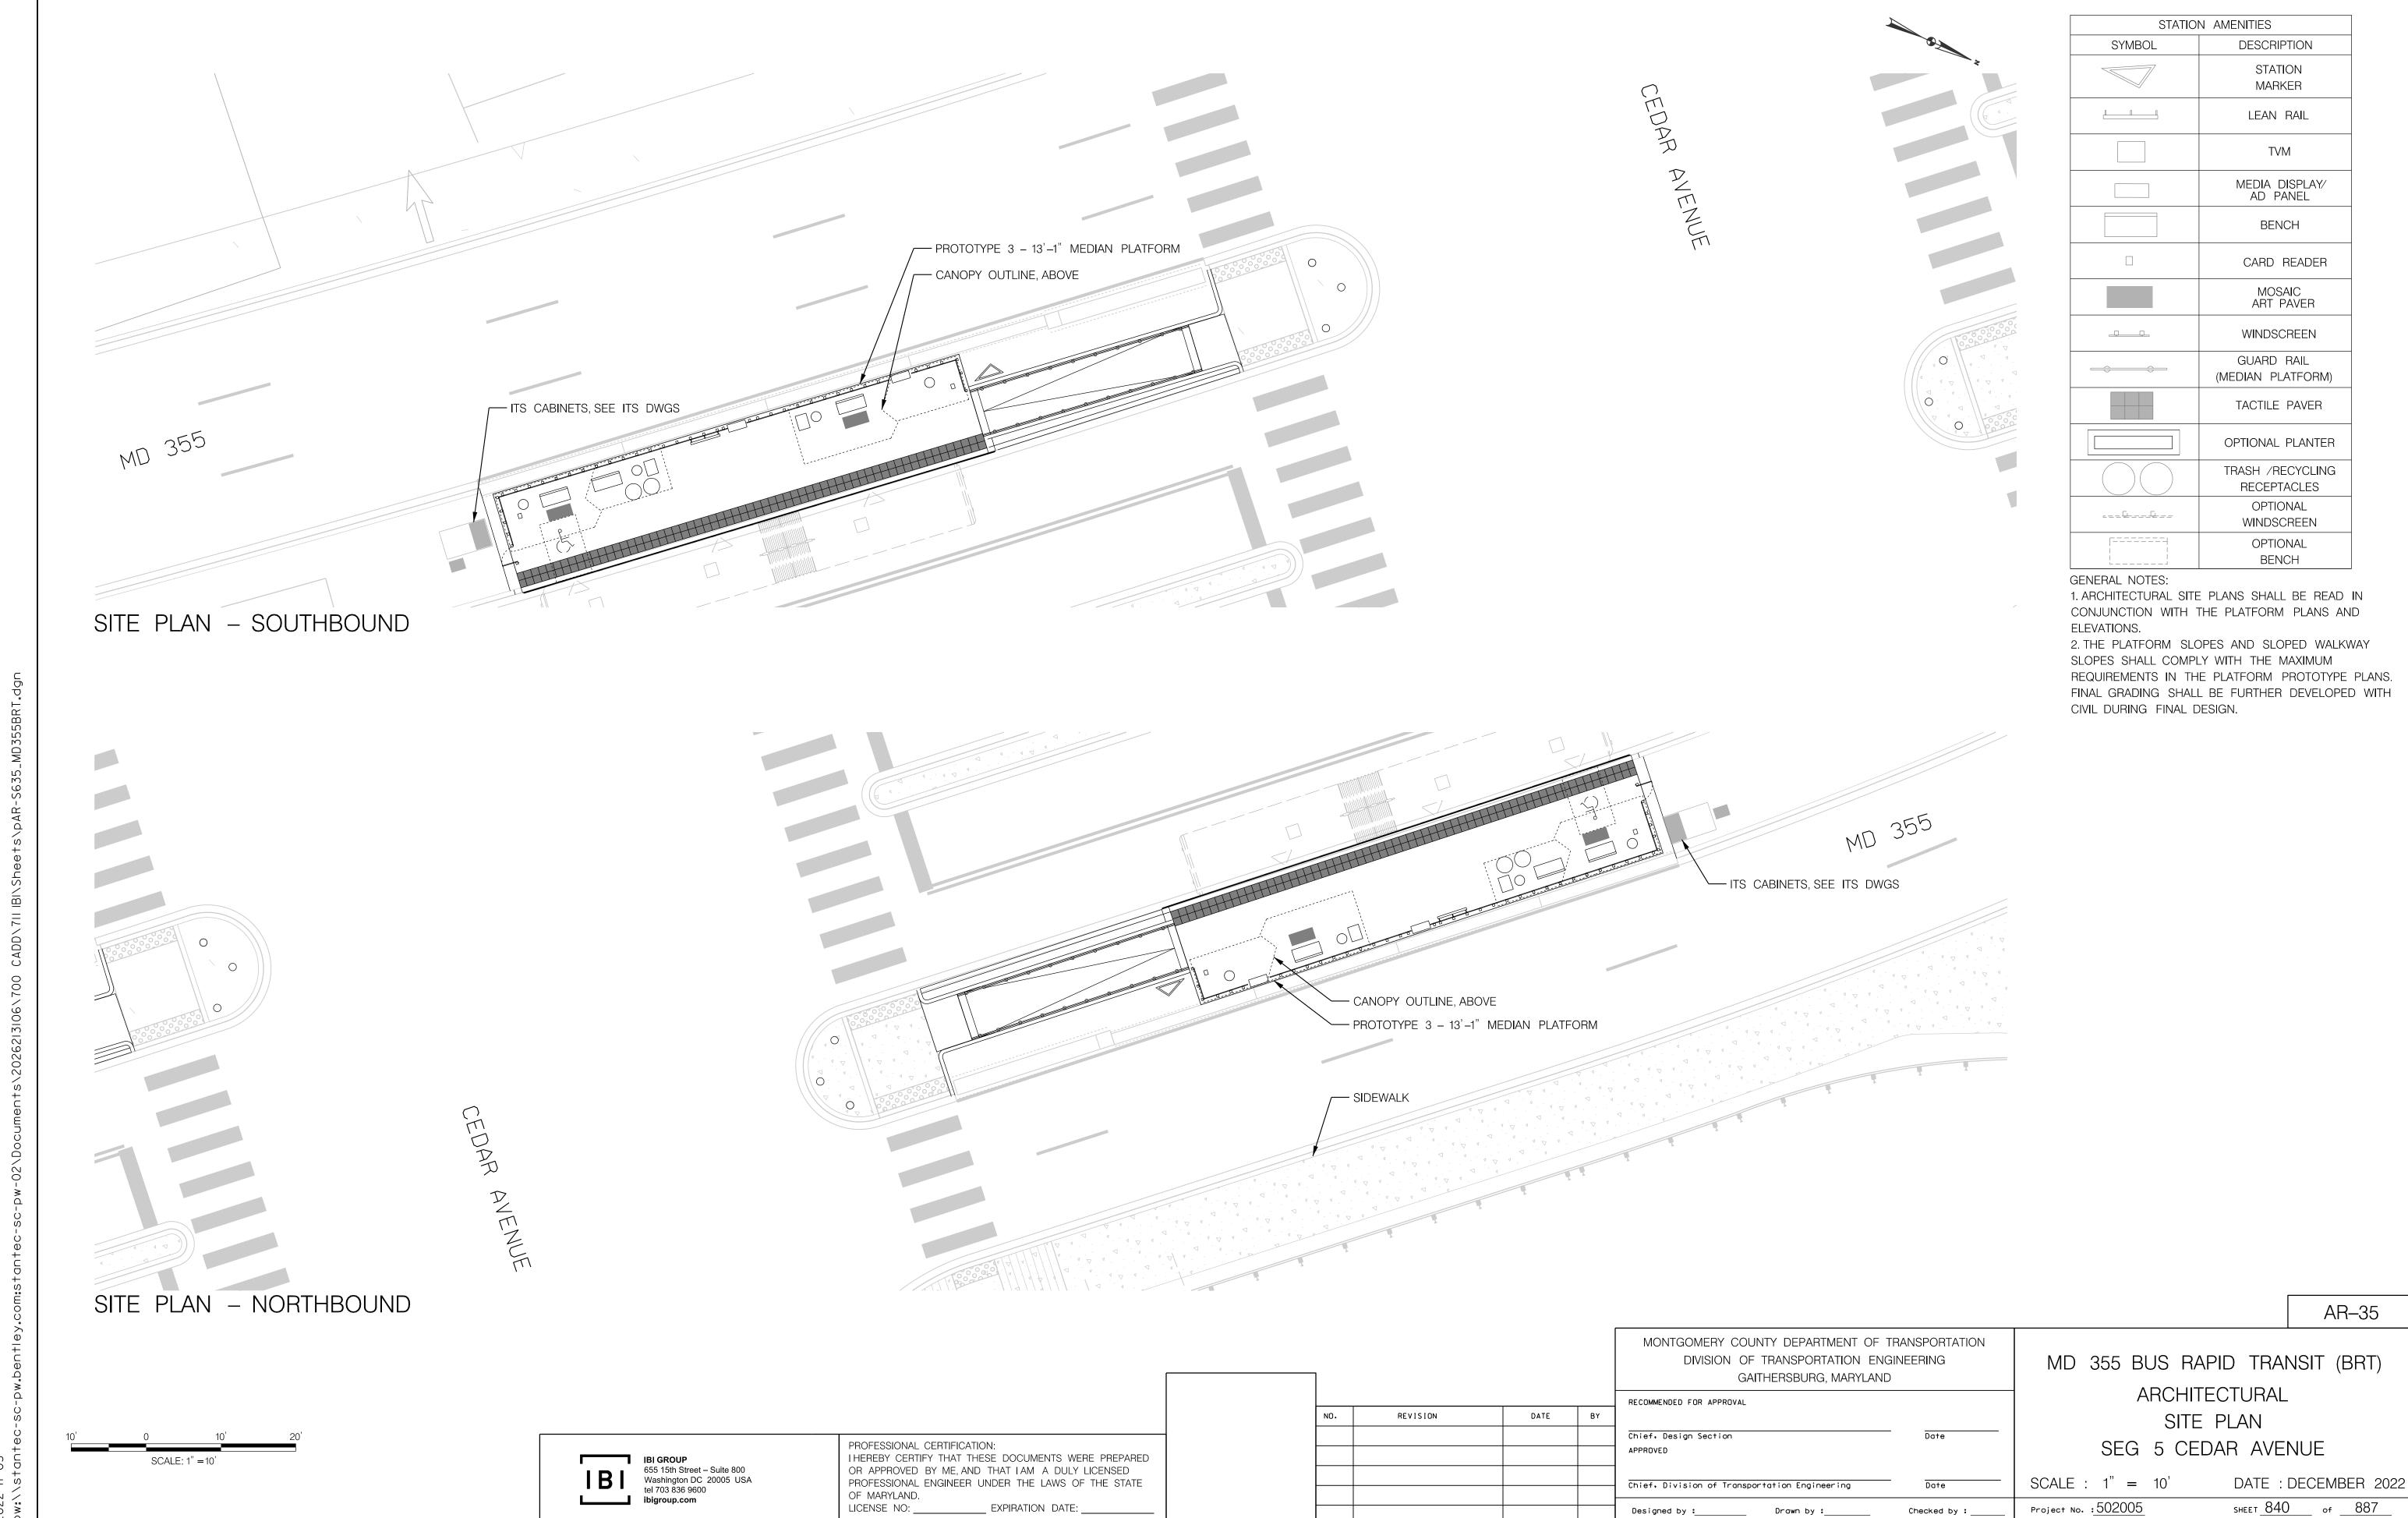
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ELEVATION - NORTHBOUND

REVISION

AR-36

MD 355 BUS RAPID TRANSIT (BRT) DIVISION OF TRANSPORTATION ENGINEERING GAITHERSBURG, MARYLAND RECOMMENDED FOR APPROVAL DATE BY Chief. Design Section APPROVED Chief. Division of Transportation Engineering

Checked by : $_$

MONTGOMERY COUNTY DEPARTMENT OF TRANSPORTATION

Designed by :_____ Drawn by :____


ARCHITECTURAL ELEVATION SEG 5 CEDAR AVENUE

DATE: DECEMBER 2022 SCALE : 1" = 5'SHEET <u>841</u> of <u>887</u> Project No. : 502005

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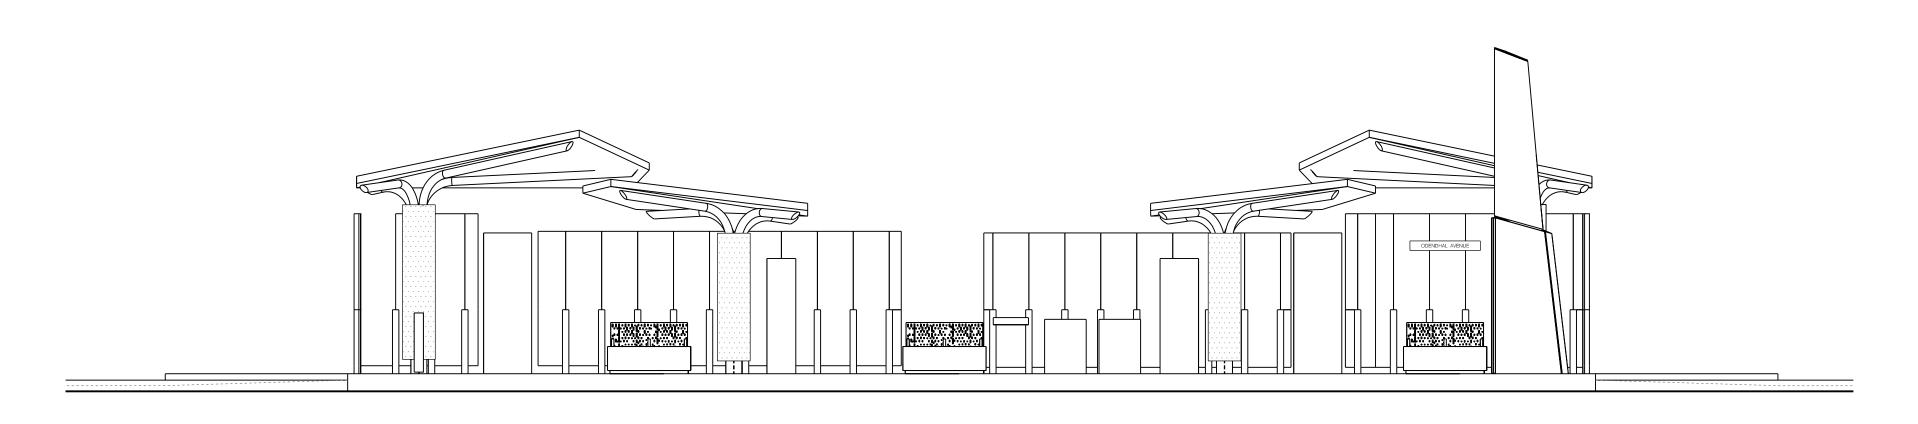
PROFESSIONAL CERTIFICATION:
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LICENSE NO: _____ EXPIRATION DATE: ___



2022-11-03

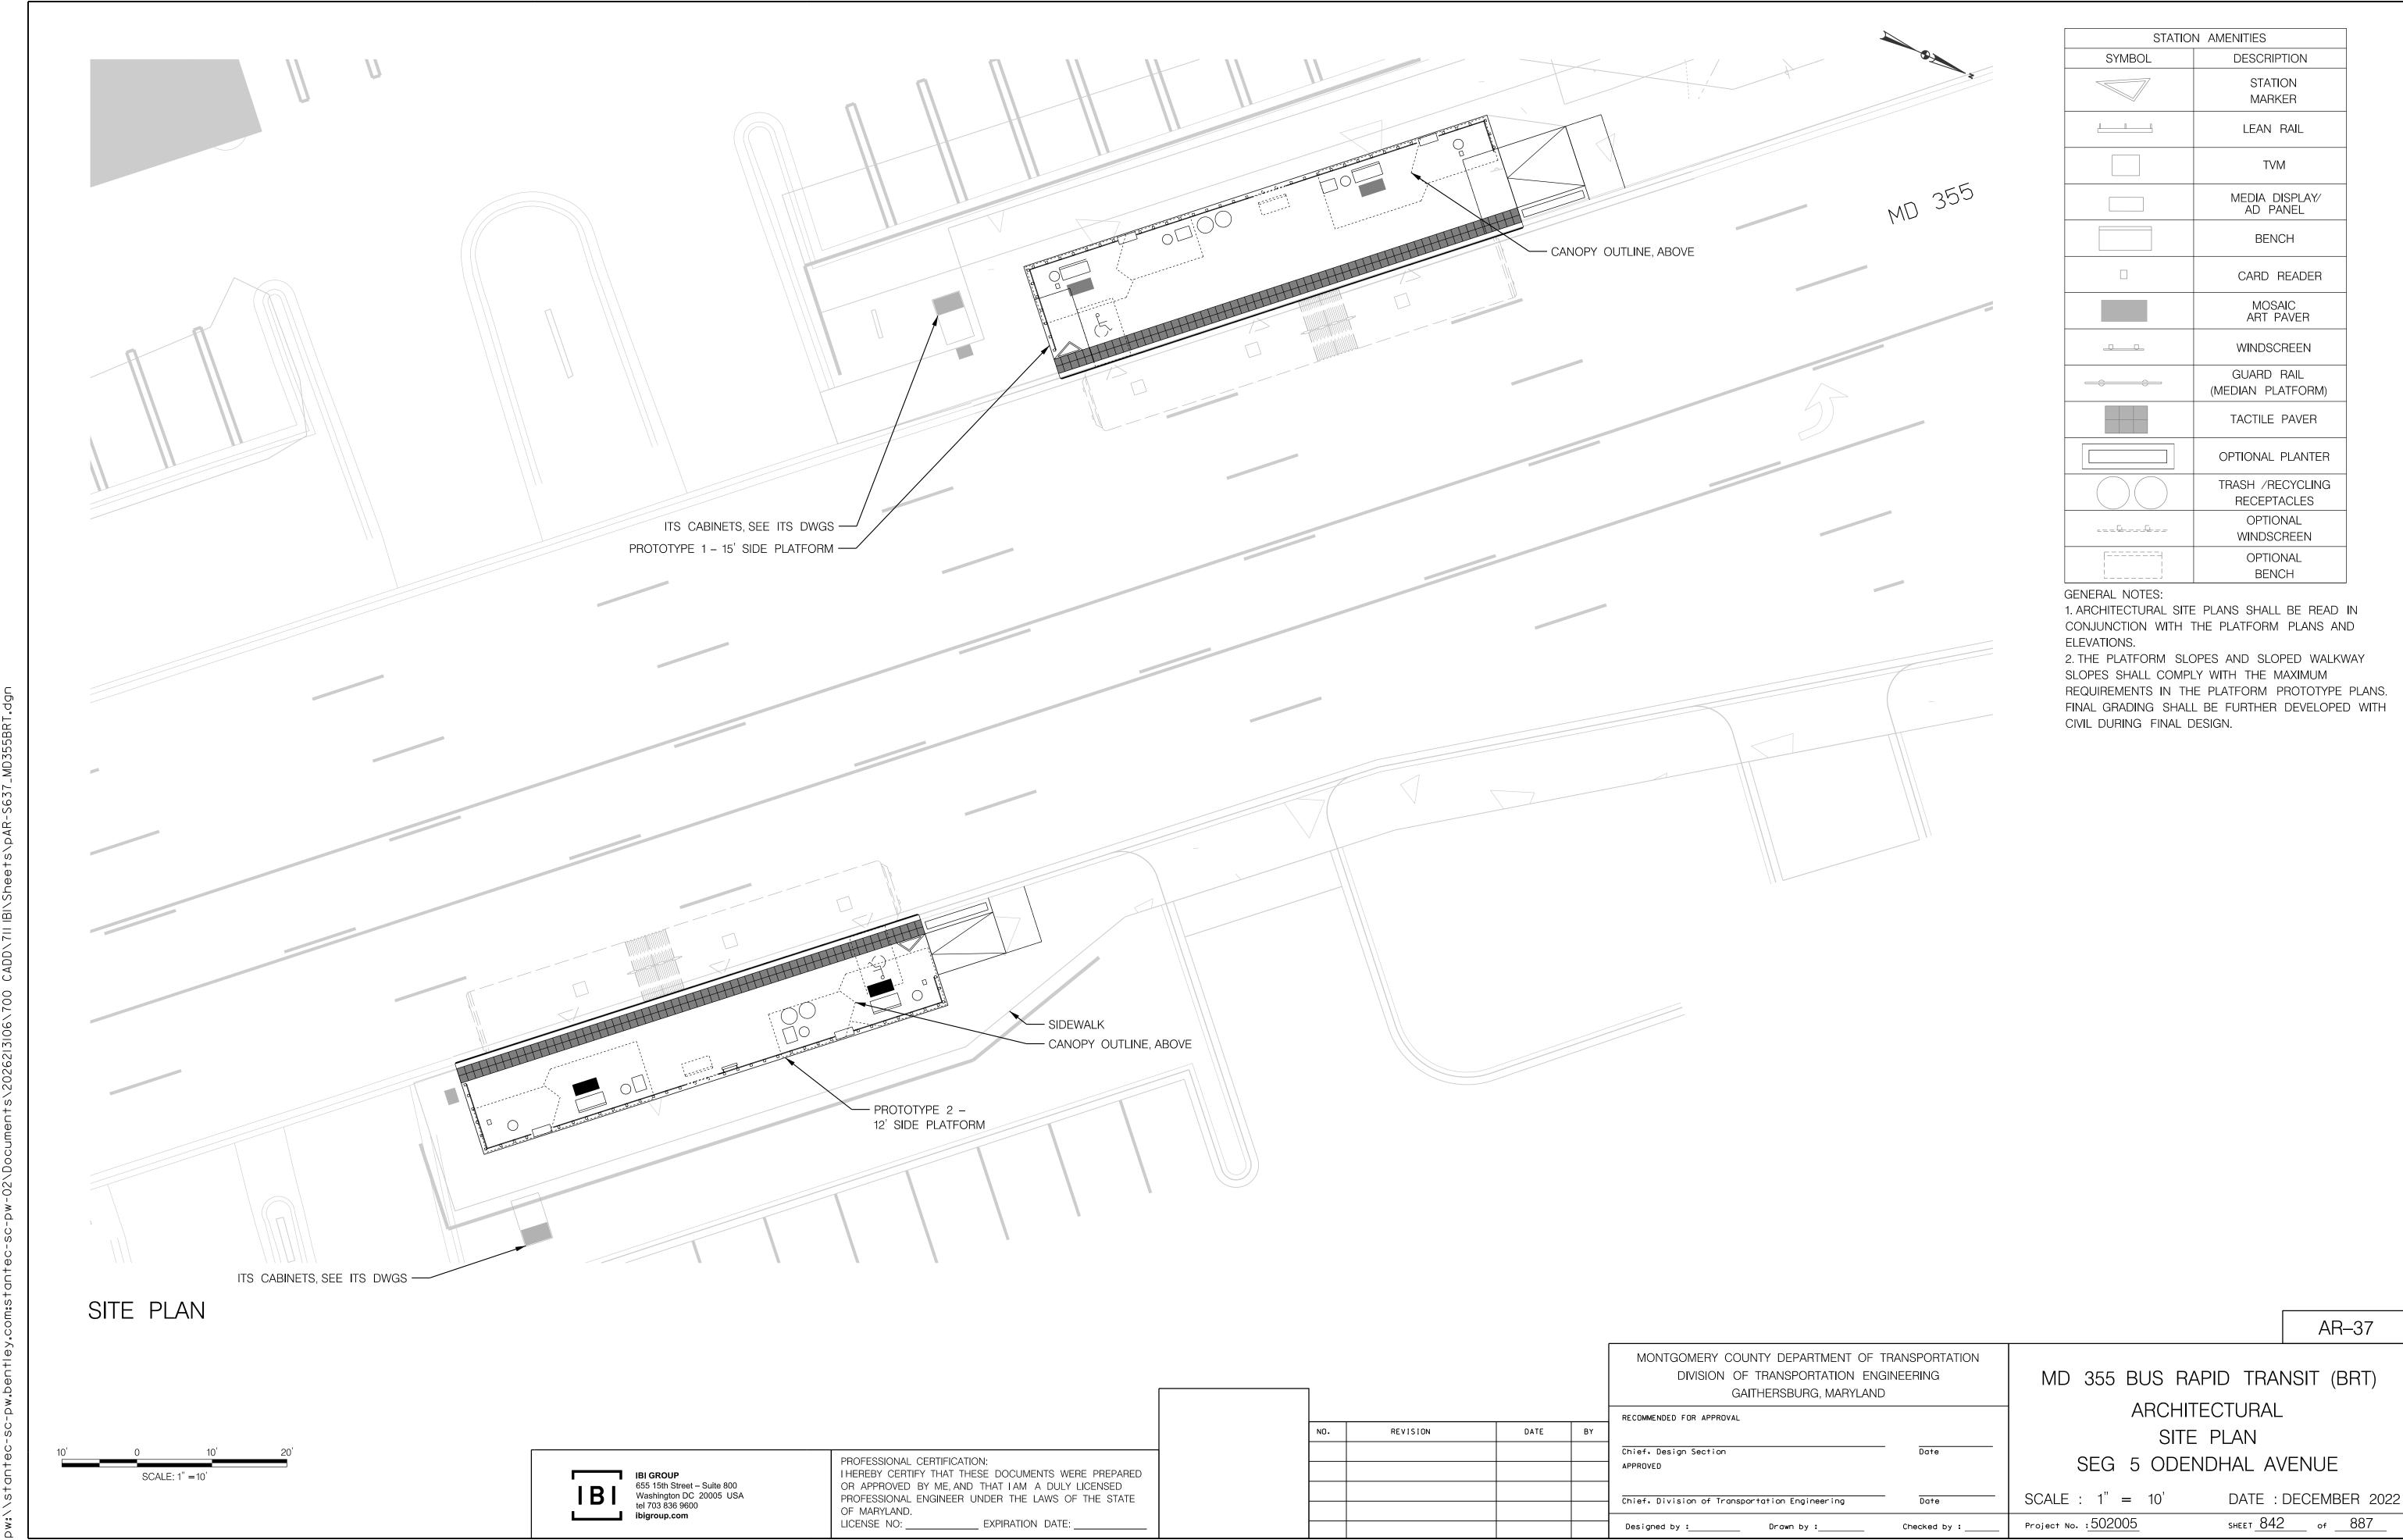ELEVATION - SOUTHBOUND



ELEVATION - NORTHBOUND

AR-38

MONTGOMERY COUNTY DEPARTMENT OF TRANSPORTATION DIVISION OF TRANSPORTATION ENGINEERING GAITHERSBURG, MARYLAND RECOMMENDED FOR APPROVAL DATE BY Chief. Design Section

Drawn by :____

Checked by : _

Chief, Division of Transportation Engineering

APPROVED

Designed by :____

REVISION

ARCHITECTURAL ELEVATION

GENERAL NOTES:

CIVIL DURING FINAL DESIGN.

ELEVATIONS.

1. ARCHITECTURAL SITE PLANS SHALL BE READ IN CONJUNCTION WITH THE PLATFORM PLANS AND

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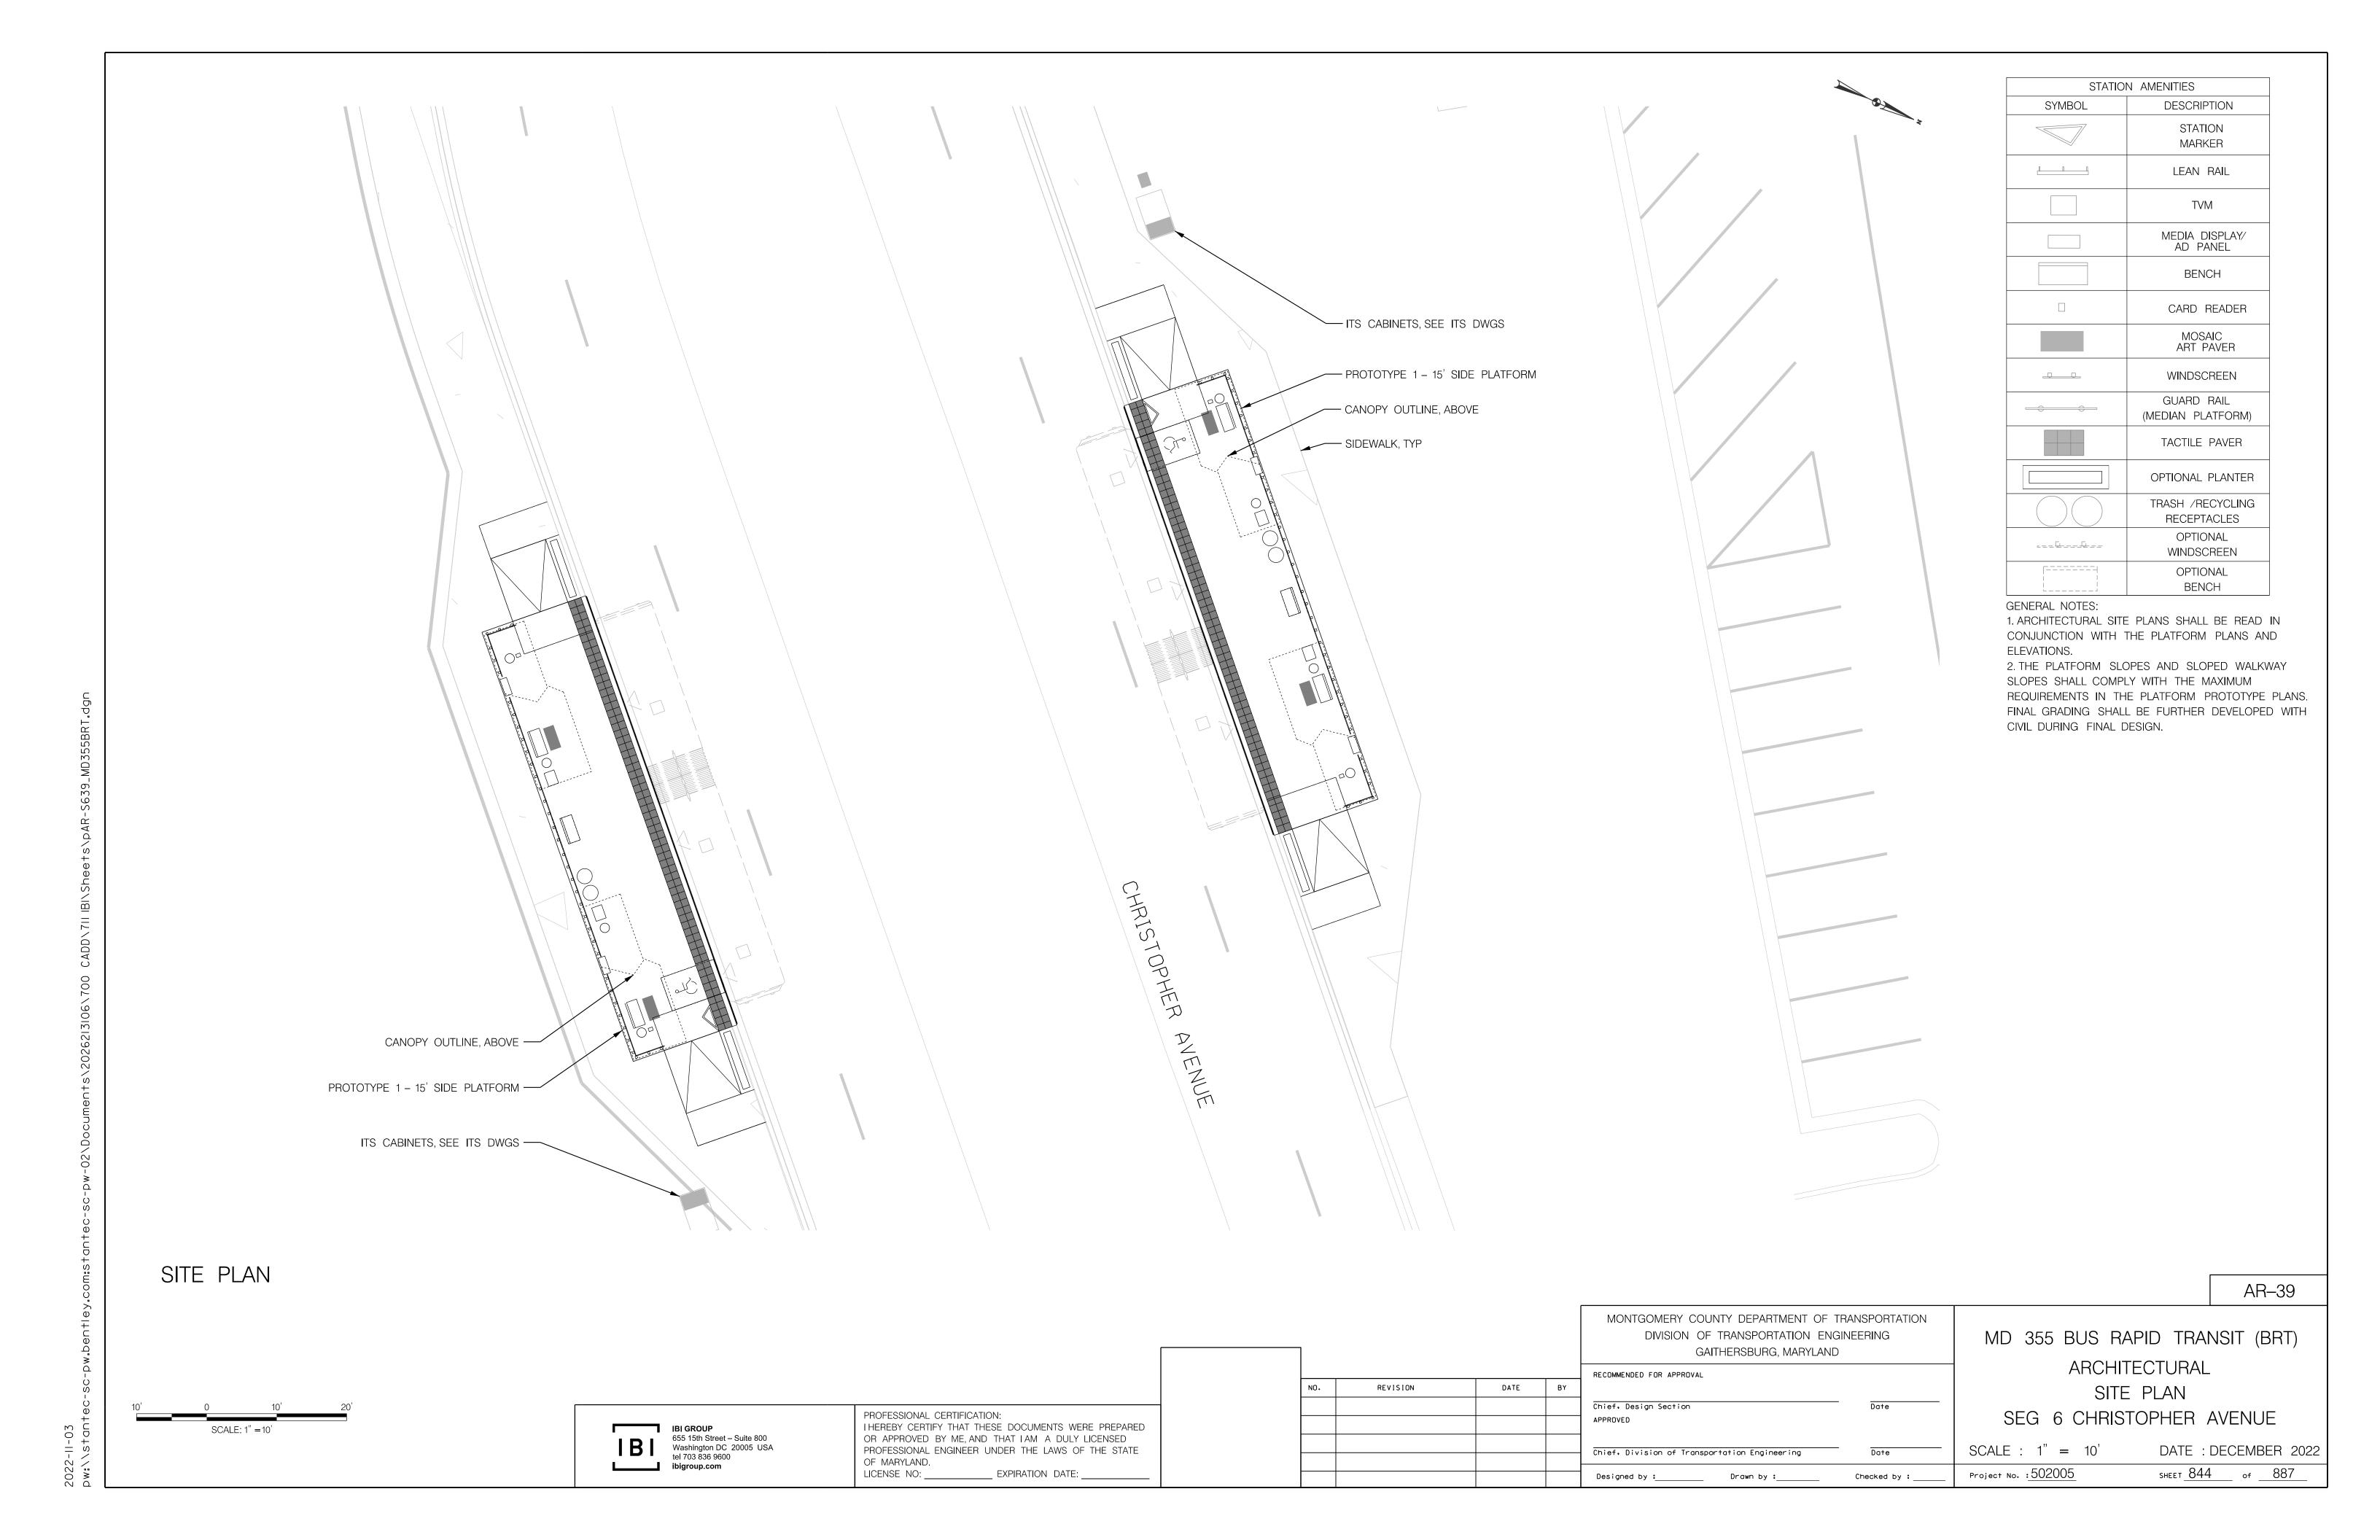
SEG 5 ODENDHAL AVENUE SCALE: 1" = 5'DATE: DECEMBER 2022 SHEET <u>843</u> of <u>887</u> Project No. : 502005

MD 355 BUS RAPID TRANSIT (BRT)


IBI GROUP
655 15th Street – Suite 800
Washington DC 20005 USA
tel 703 836 9600

PROFESSIONAL CERTIFICATION: I HEREBY CERTIFY THAT THESE DOCUMENTS WERE PREPARED OR APPROVED BY ME, AND THAT I AM A DULY LICENSED PROFESSIONAL ENGINEER UNDER THE LAWS OF THE STATE OF MARYLAND. LICENSE NO: _____ ___ EXPIRATION DATE: _

SCALE: 1'' = 5'



ELEVATION - SOUTHBOUND

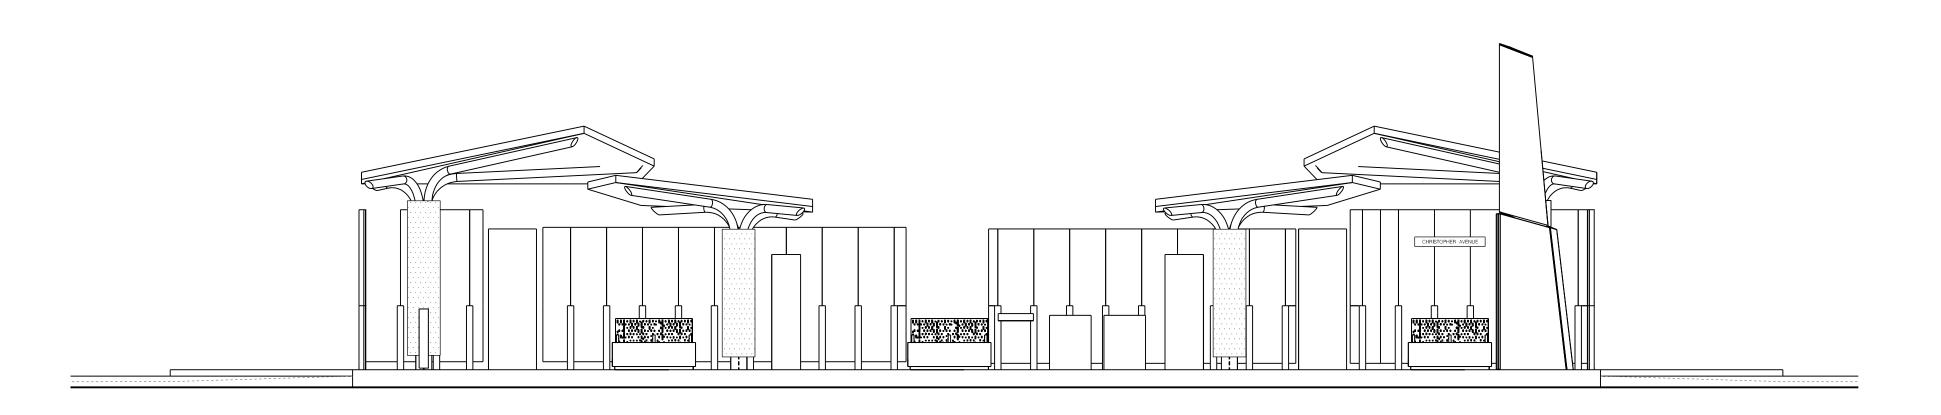

ELEVATION - NORTHBOUND

AR-40

MONTGOMERY COUNTY DEPARTMENT OF TRANSPORTATION DIVISION OF TRANSPORTATION ENGINEERING GAITHERSBURG, MARYLAND RECOMMENDED FOR APPROVAL DATE BY Chief. Design Section APPROVED

ARCHITECTURAL ELEVATION SEG 6 CHRISTOPHER AVENUE

MD 355 BUS RAPID TRANSIT (BRT)

SCALE: 1" = 5'DATE: DECEMBER 2022

GENERAL NOTES:

CIVIL DURING FINAL DESIGN.

ELEVATIONS.

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SCALE: 1'' = 5'


REVISION

Designed by :_____ Drawn by :____


Chief, Division of Transportation Engineering

Project No. : 502005Checked by : _

SHEET <u>845</u> of <u>887</u>

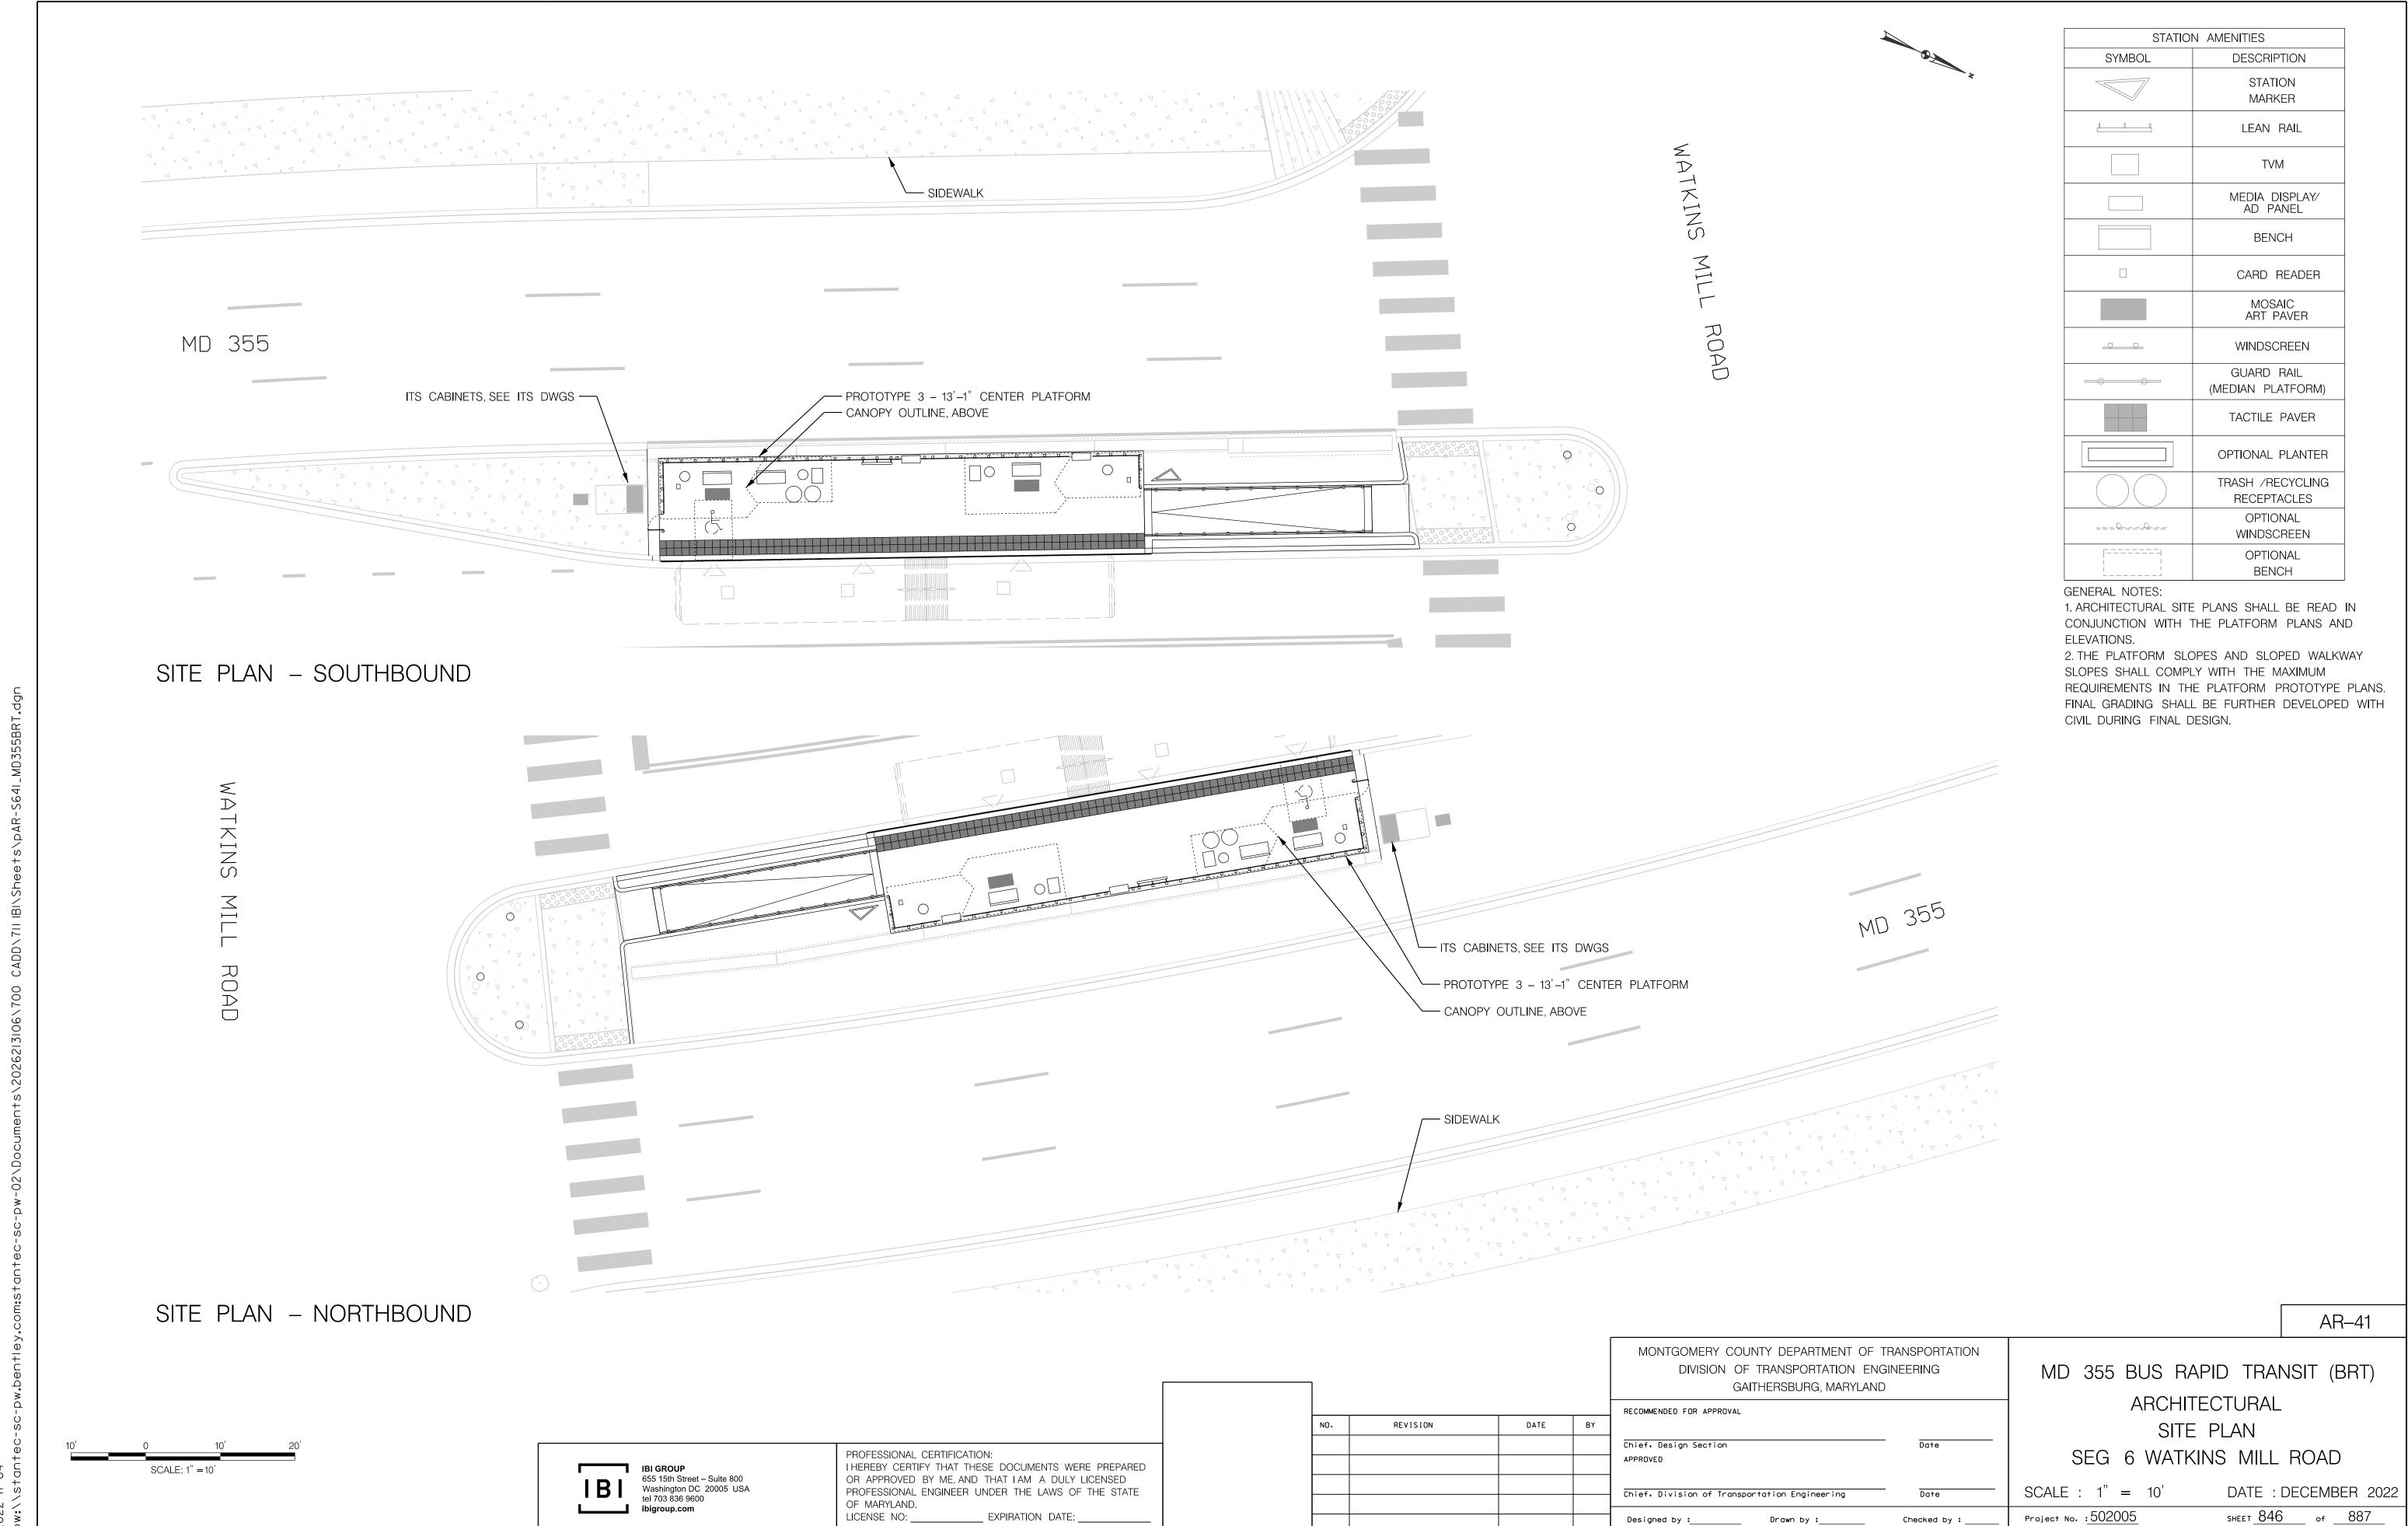

ELEVATION - SOUTHBOUND

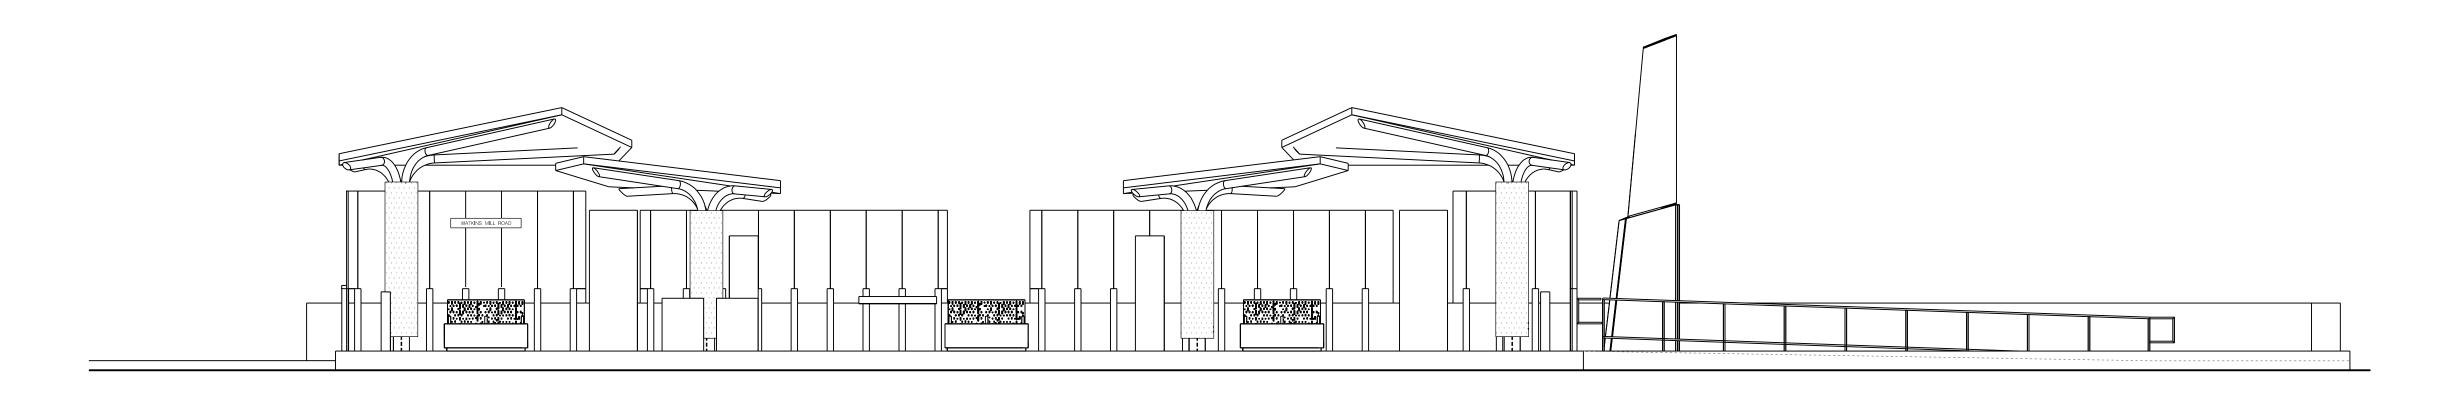

ELEVATION - NORTHBOUND

AR-42

MONTGOMERY COUNTY DEPARTMENT OF TRANSPORTATION DIVISION OF TRANSPORTATION ENGINEERING GAITHERSBURG, MARYLAND RECOMMENDED FOR APPROVAL Chief. Design Section APPROVED

Checked by : $_$

Chief, Division of Transportation Engineering

Designed by :_____ Drawn by :____

REVISION

DATE BY

ELEVATION SEG 6 WATKINS MILL ROAD

GENERAL NOTES:

CIVIL DURING FINAL DESIGN.

ELEVATIONS.

1. ARCHITECTURAL SITE PLANS SHALL BE READ IN CONJUNCTION WITH THE PLATFORM PLANS AND

2. THE PLATFORM SLOPES AND SLOPED WALKWAY

REQUIREMENTS IN THE PLATFORM PROTOTYPE PLANS. FINAL GRADING SHALL BE FURTHER DEVELOPED WITH

SLOPES SHALL COMPLY WITH THE MAXIMUM

DATE: DECEMBER 2022 SCALE : 1" = 5"SHEET <u>847</u> of <u>887</u> Project No. : 502005

MD 355 BUS RAPID TRANSIT (BRT)


ARCHITECTURAL

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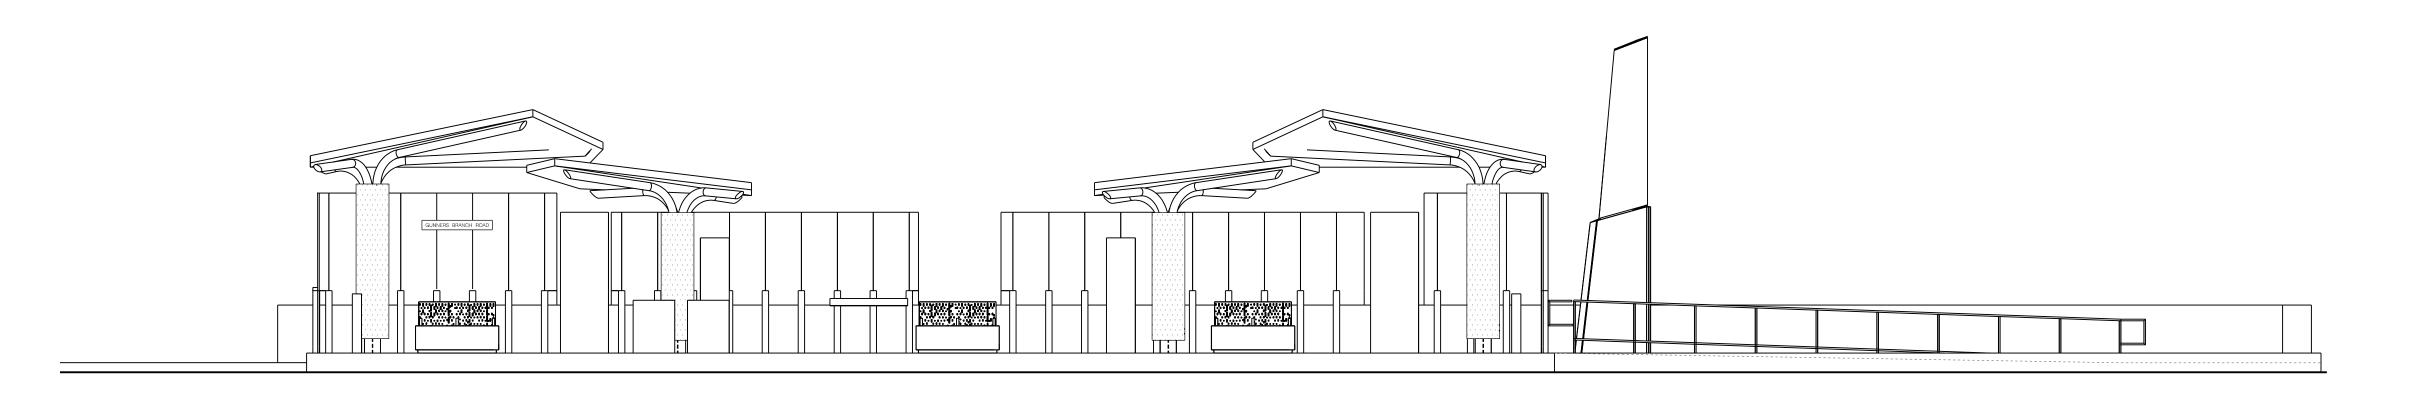
PROFESSIONAL CERTIFICATION:
I HEREBY CERTIFY THAT THESE DOCUMENTS WERE PREPARED OR APPROVED BY ME, AND THAT I AM A DULY LICENSED PROFESSIONAL ENGINEER UNDER THE LAWS OF THE STATE

OF MARYLAND. LICENSE NO: _____ EXPIRATION DATE: ___

SCALE: 1'' = 5'

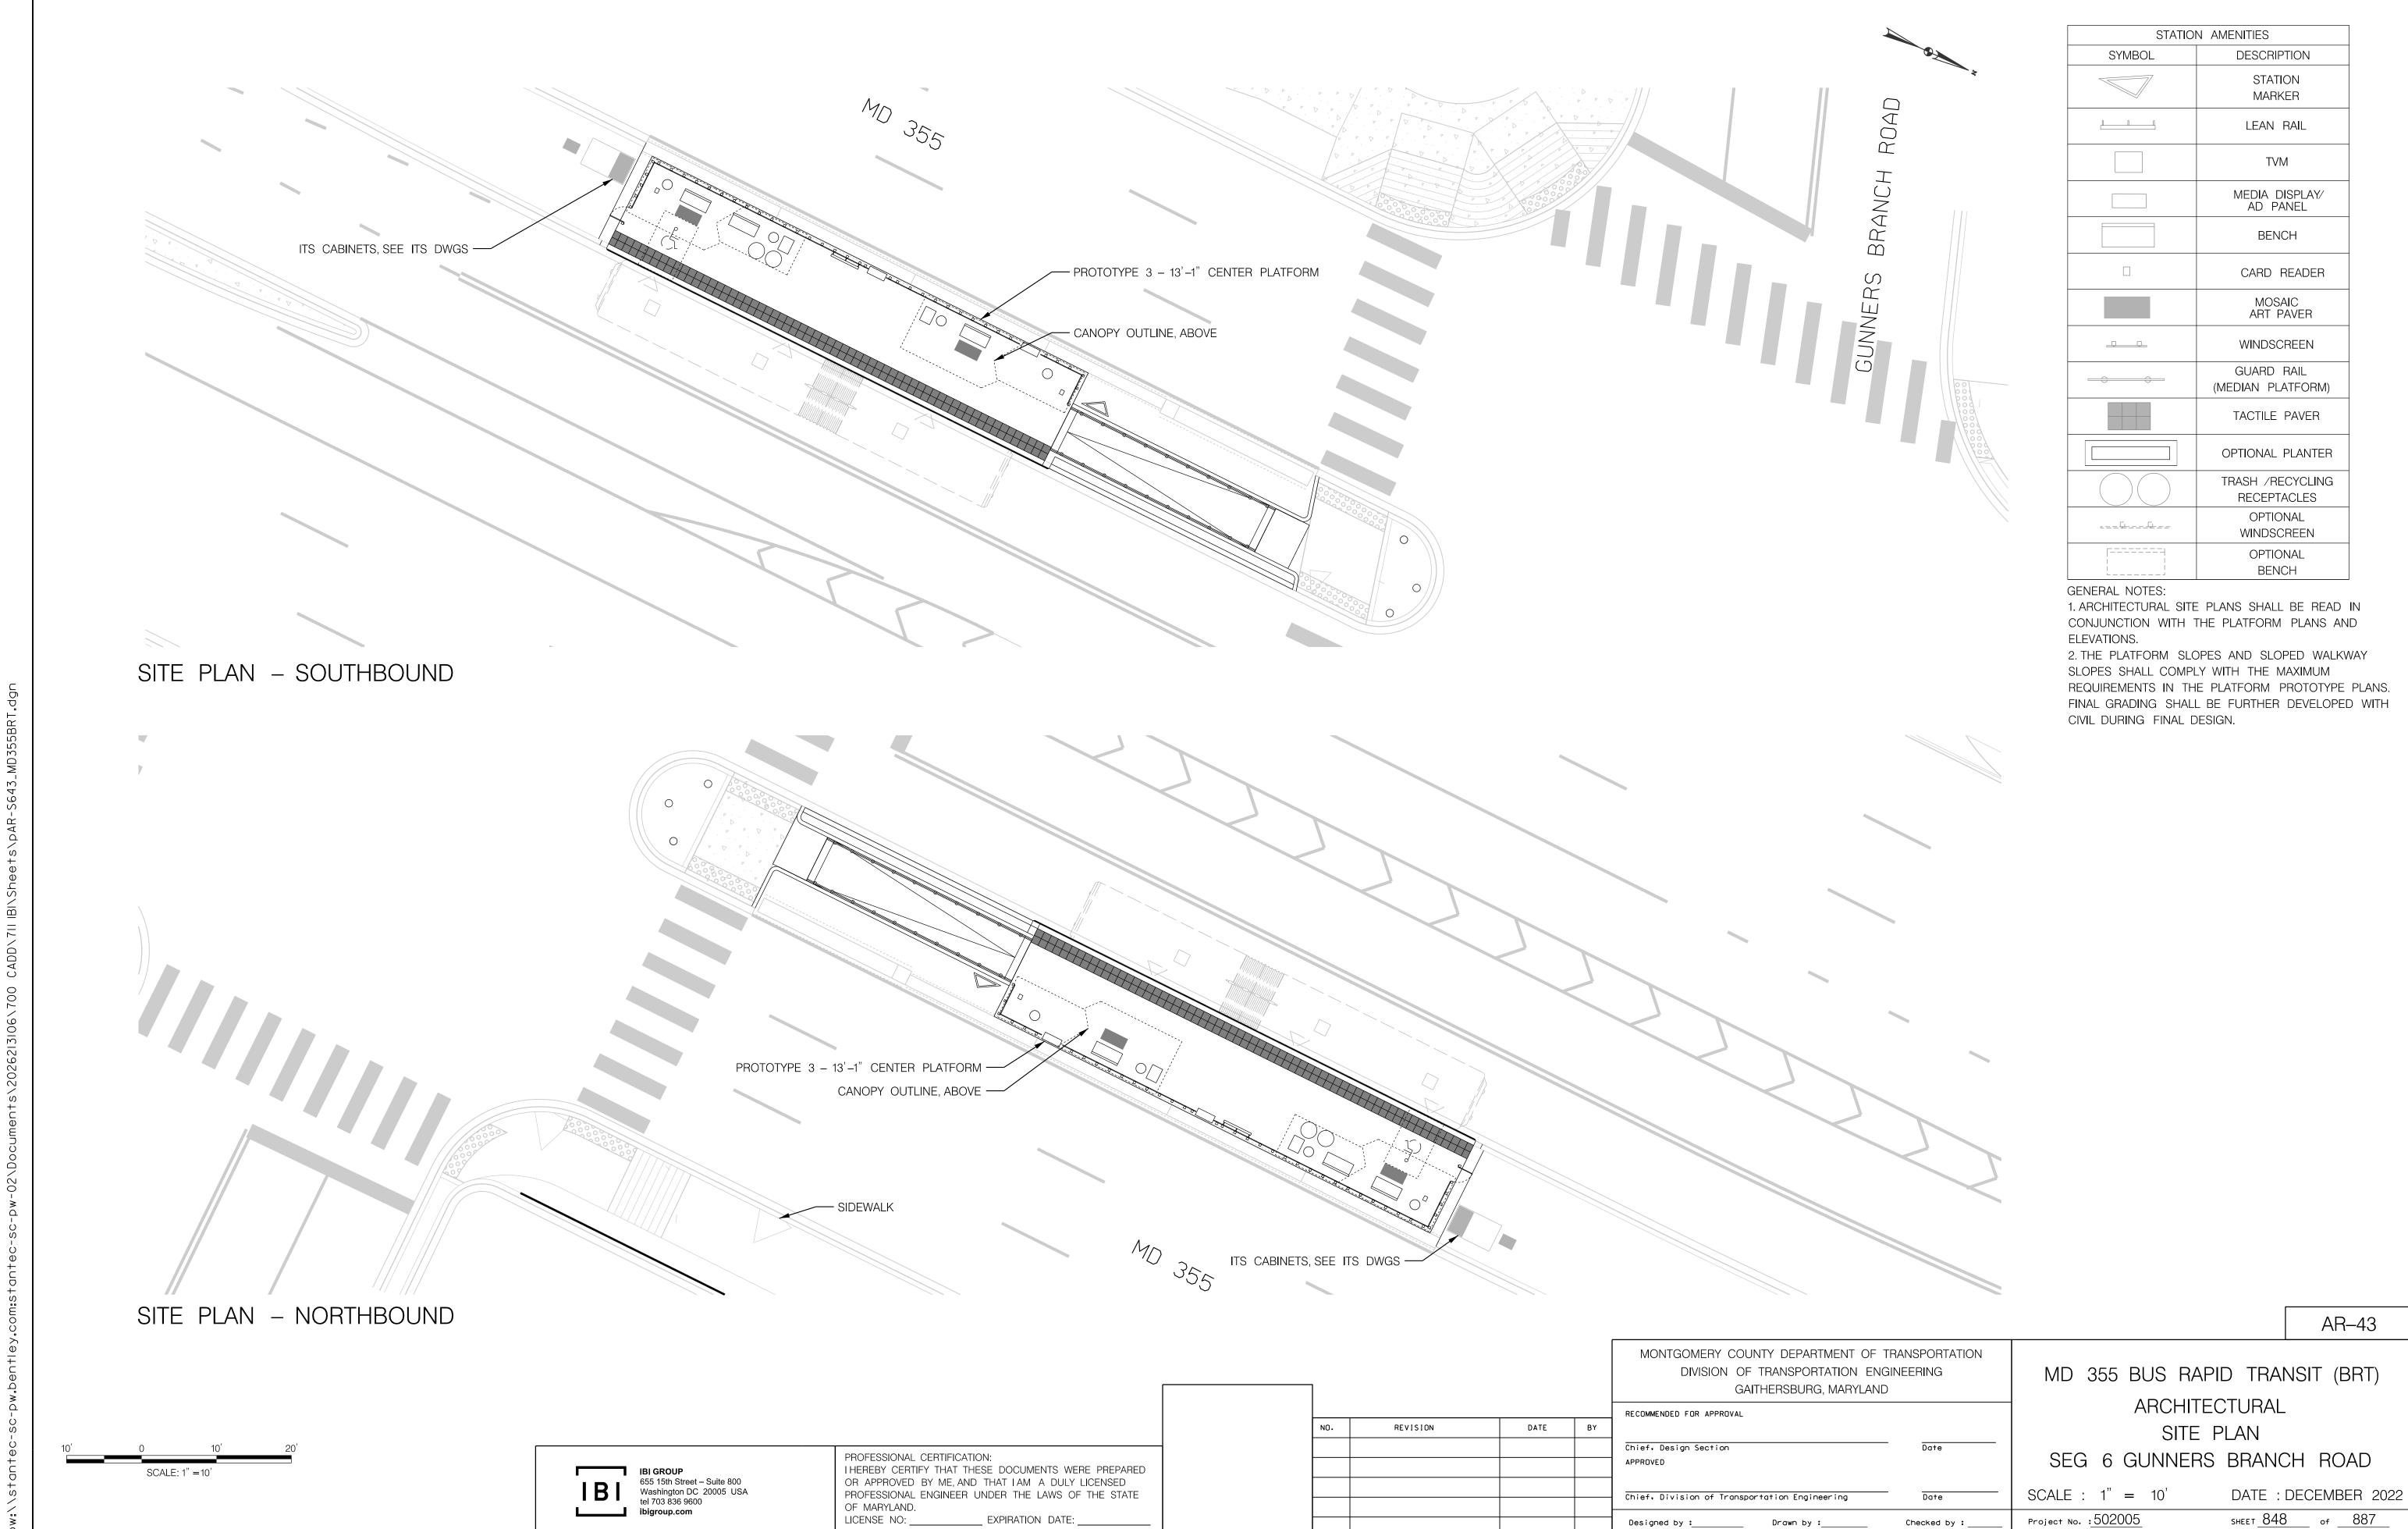

ELEVATION - SOUTHBOUND



ELEVATION - NORTHBOUND

REVISION

AR-44

MONTGOMERY COUNTY DEPARTMENT OF TRANSPORTATION DIVISION OF TRANSPORTATION ENGINEERING GAITHERSBURG, MARYLAND RECOMMENDED FOR APPROVAL DATE BY Chief. Design Section APPROVED

Checked by : $_$

Chief, Division of Transportation Engineering

Designed by :_____ Drawn by :____

ARCHITECTURAL ELEVATION SEG 6 GUNNERS BRANCH ROAD

MD 355 BUS RAPID TRANSIT (BRT)

SCALE : 1" = 5"Project No. : 502005

GENERAL NOTES:

CIVIL DURING FINAL DESIGN.

ELEVATIONS.

1. ARCHITECTURAL SITE PLANS SHALL BE READ IN CONJUNCTION WITH THE PLATFORM PLANS AND

2. THE PLATFORM SLOPES AND SLOPED WALKWAY

REQUIREMENTS IN THE PLATFORM PROTOTYPE PLANS. FINAL GRADING SHALL BE FURTHER DEVELOPED WITH

SLOPES SHALL COMPLY WITH THE MAXIMUM

DATE: DECEMBER 2022 SHEET <u>849</u> of <u>887</u>

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PROFESSIONAL CERTIFICATION:
I HEREBY CERTIFY THAT THESE DOCUMENTS WERE PREPARED PROFESSIONAL ENGINEER UNDER THE LAWS OF THE STATE LICENSE NO: _____ EXPIRATION DATE: ___

OR APPROVED BY ME, AND THAT I AM A DULY LICENSED OF MARYLAND.

SCALE: 1'' = 5'

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GENERAL NOTES: 1. ARCHITECTURAL SITE PLANS SHALL BE READ IN CONJUNCTION WITH THE PLATFORM PLANS AND ELEVATIONS.

2. THE PLATFORM SLOPES AND SLOPED WALKWAY SLOPES SHALL COMPLY WITH THE MAXIMUM REQUIREMENTS IN THE PLATFORM PROTOTYPE PLANS. FINAL GRADING SHALL BE FURTHER DEVELOPED WITH CIVIL DURING FINAL DESIGN.

MONTGOMERY COUNTY DEPARTMENT OF TRANSPORTATION DIVISION OF TRANSPORTATION ENGINEERING GAITHERSBURG, MARYLAND RECOMMENDED FOR APPROVAL DATE Chief, Design Section

Chief, Division of Transportation Engineering

Designed by :_____ Drawn by :____

Checked by : _

APPROVED

LOT 13 TRANSIT CENTER

MD 355 BUS RAPID TRANSIT (BRT)

CONCEPTUAL DESIGN

AR-46

DATE: DECEMBER 2022 SCALE : AS NOTED SHEET <u>851</u> of <u>887</u> Project No. : 502005

Stantec Stantec

PROFESSIONAL CERTIFICATION:
I HEREBY CERTIFY THAT THESE DOCUMENTS WERE PREPARED
OR APPROVED BY ME, AND THAT I AM A DULY LICENSED PROFESSIONAL ENGINEER UNDER THE LAWS OF THE STATE LICENSE NO: _____ EXPIRATION DATE: _

OF MARYLAND.

- EXISTING UTILITIES

GENERAL NOTES: 1. ARCHITECTURAL SITE PLANS SHALL BE READ IN CONJUNCTION WITH THE PLATFORM PLANS AND ELEVATIONS.

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MONTGOMERY COUNTY DEPARTMENT OF TRANSPORTATION DIVISION OF TRANSPORTATION ENGINEERING

GAITHERSBURG, MARYLAND RECOMMENDED FOR APPROVAL

GROSVENOR TRANSIT CENTER CONCEPTUAL DESIGN

MD 355 BUS RAPID TRANSIT (BRT)

SCALE : AS NOTED

DATE: DECEMBER 2022

AR-47

EXISTING

STREETLIGHT

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PROFESSIONAL CERTIFICATION: I HEREBY CERTIFY THAT THESE DOCUMENTS WERE PREPARED OR APPROVED BY ME, AND THAT I AM A DULY LICENSED PROFESSIONAL ENGINEER UNDER THE LAWS OF THE STATE OF MARYLAND.

655 15th Street – Suite 800 Washington DC 20005 USA tel 703 836 9600

LICENSE NO: _____ EXPIRATION DATE: __

Designed by :_____ Drawn by :____

Chief, Division of Transportation Engineering

Chief, Design Section

APPROVED

DATE BY

REVISION

Project No. : 502005

Checked by : _

SHEET <u>852</u> of <u>887</u>

- 2. CONTRACTOR SHALL CONTACT MONTGOMERY COUNTY DOT AND SHA DISTRICT 3 TRAFFIC TO COORDINATE WORK HOUR RESTRICTIONS AND LANE CLOSURES. THE CONTRACTOR SHALL USE MAINTENANCE OF TRAFFIC TEMPORARY TRAFFIC CONTROL TYPICAL APPLICATIONS (TTCTA) AS PER THE LATEST EDITION OF THE MARYLAND BOOK OF STANDARDS.
- ALL CABLE ENERGIZING PROPOSED ITS EQUIPMENT SHALL BE NEW.
- 4. THE ENGINEER SHALL BE NOTIFIED IMMEDIATELY IN CASE OF DAMAGE TO AN EXISTING FACILITY.
- 5. THE CONTRACTOR SHALL REPLACE ALL CONCRETE GUTTERS. FLUMES, UNDERDRAINS AND OTHER CONCRETE STRUCTURES DAMAGED OR REMOVED DURING INSTALLATION OF FOUNDATIONS OR CABLE AT NO COST TO THE COUNTY.
- 6. ALL CONNECTIONS BETWEEN GROUND RODS AND GROUND CABLE SHALL BE BY EXOTHERMIC WELD.
- 7. ALL HANDHOLES. CONDUITS UNDER PAVEMENT, STUB UP AT UTILITY POLES, ITS STRUCTURES, CABINETS AND METERED SERVICE PEDESTALS SHALL BE STAKED OUT AND EVERY LOCATION APPROVED BY THE ENGINEER AND MCDOT TRAFFIC BEFORE ANY WORK IS PERFORMED.
- 8. THE CONTRACTOR SHALL CAP AND ABANDON ALL EXISTING CONDUITS AND REMOVE ALL EXISTING CABLES THAT ARE NO LONGER IN USE.
- 9. THE CONTRACTOR SHALL COORDINATE THE INSTALLATION OF FOUNDATIONS, MANHOLES, CONDUITS, HANDHOLES, AND DUCT CABLES WITH THE INSTALLATION OF PROPOSED DRAINAGE STRUCTURES, BUS PLATFORM ELEMENTS AND ARCHITECTURAL FEATURES. IF THE CONTRACTOR PERCEIVES THAT A CONFLICT WILL OCCUR, THE CONTRACTOR SHALL NOTIFY THE PROJECT ENGINEER IMMEDIATELY SO THAT THE CONFLICT MAY BE RESOLVED.
- 10. REMOVAL AND DISPOSAL OF EXISTING ITS INFRASTRUCTURE INCLUDING CONDUITS. CABLES, MANHOLES, JUNCTION BOXES, HANDHOLES, FOUNDATIONS 1 FT. BELOW GRADE, CABINETS, ELECTRICAL SERVICE EQUIPMENT, BACKFILL AND GRADING SHALL BE INCIDENTAL TO THE LUMP SUM REWOVAL AND DISPOSAL OF EXISTING ITS MATERIALS AND EQUIPMENT ITEM IN THE CONTRACT.
- 11. ALL MOUNTING HARDWARE NECESSARY FOR THE PROPOSED CONDUIT SHALL BE INCIDENTAL TO THE RESPECTIVE CONDUIT ITEM. THIS SHALL INCLUDE ALL BANDING, CLAMPS. HARDWARE AND FOR ALL MATERIALS, LABOR, EQUIPMENT AND INCIDENTALS NECESSARY TO COMPLETE THE WORK.
- 12. RIGHT OF WAY SHOWN ON THE PLANS IS APPROXIMATE AND BASED ON THE BEST AVAILABLE INFORMATION.
- 13. CLEARING AND GRUBBING REQUIRED FOR INSTALLATION OF ITS STRUCTURES, MANHOLES, CABINETS, METERED SERVICE PEDESTALS, CONDUITS, ETC. WILL NOT BE MEASURED AND THE COST WILL BE INCIDENTAL TO THE PERTINENT BID ITEM.
- 14. ALL TRENCHING MUST BE BACKFILLED AND RESTORED TO ITS ORIGINAL CONDITION ON THE SAME WORKING DAY ON WHICH IT WAS OPENED, AREAS WHICH ARE NOT RESEEDED, MULCHED OR SODDED MUST BE COVERED TO PREVENT EROSION. ALL SOIL NOT USED FOR BACKFILL MUST BE REMOVED ON THE SAME WORKING DAY.
- 15. ALL SOIL REWOVED FOR HANDHOLES, FOUNDATIONS, ETC. MUST BE COVERED TO PREVENT EROSION. SOIL NOT USED FOR BACKFILL MUST BE DISPOSED OF TO THE ENGINEER'S SATISFACTION ON THE SAME WORKING DAY THE BACKFILL IS
- 16. EXISTING ELECTRICAL AND FIBER OPTIC CABLE LOCATIONS ARE SHOWN FOR REFERENCE ONLY. VERIFY EXACT LOCATIONS IN THE FIELD. COORDINATE INSTALLATION OF PROPOSED CABLE WITH EXISTING LOCATIONS. FOR LOCATIONS OF UTILITIES. CALL MISS UTILITY 1-800-257-7777 FORTY-EIGHT (48) HOURS IN ADVANCE OF PERFORMING WORK.
- 17. COMMUNICATION AND ELECTRICAL HANDHOLES SHALL BE INSTALLED AS SHOWN ON PLANS AND EVERY 500 FT. THERE SHALL BE NO MORE THAN 500 FT. BETWEEN CONSECUTIVE COMMUNICATION HANDHOLES, OR BETWEEN CONSECUTIVE ELECTRICAL HANDHOLES. CONDUITS FOR ELECTRICAL CABLES SHALL NOT SHARE HANDHOLES WITH CONDUITS FOR COMMUNICATION CABLES.
- 18. CONDUIT BENDS FOR ELECTRICAL, COMMUNICATIONS AND FIBER OPTIC CABLES SHALL NOT EXCEED CABLE MANUFACTURER'S
- 19. HIGH = DENSITY POLYETHYLENE (HDPE) STANDARD DIMENSION RATIO (SDR) 11 CONDUIT MAY BE USED AS AN ALTERNATE TO POLYVINYL CHLORIDE (PVC) SCHEDULÉ 80 CONDUIT. ALL PLASTIC CONDUITS WILL BE PAID FOR USING PVC ITEMS IN THE
- 20. SLOTTED CONDUITS SHALL BE INSTALLED PRIOR TO FINAL ROADWAY SURFACE. REFER TO SHA STANDARD MD 805.01 FOR
- 21. TEST PITS ARE PROVIDED TO LOCATE UNDERGROUND UTILITIES FOR BORED CONDUIT INSTALLATION.
- 22. REFER TO STATION PLANS AND STATION PLATFORM DETAILS FOR ADDITIONAL INFORMATION
- 23. REFER TO ELECTRICAL PLANS FOR ELECTRICAL FEED DETAILS FOR PROPOSED ITS CABINETS.
- 24. WITHIN 36 IN. OF UNDERGROUND UTILITY LOCATIONS, THE CONTRACTOR SHALL BE REQUIRED TO EXCAVATE FOR FOUNDATION AND CONDUIT BY HAND HAND DIGGING SHALL BE INCIDENTAL TO PERTINENT BID ITEMS.
- 25. INTERCEPTING EXISTING CONDUIT SHALL BE INCIDENTAL TO THE PERTINENT HANDHOLE, MANHOLE OR CABINET BID ITEM.
- 26. RIGID GALVANIZED STEEL CONDUIT (3/4*) IS PROVIDED TO FEED ETHERNET CABLE UP THE CANOPY AND OUT TO THE CCTV CAMERA LOCATION. THE CONTRACTOR SHALL INCLUDE ROUTING DETAILS ON SHOP DRAWINGS FOR CANOPY.
- 27. ALL CONDUITS FOR FUTURE EQUIPMENT SHALL BE CAPPED AND MADE SAFE AS DIRECTED BY THE ENGINEER.
- 28. IN LIEU OF PVC WEATHERHEADS. THE CONTRACTOR MAY SUBSTITUTE WEATHER RESISTENT FOAM MATERIAL.
- 29. LASHING TO EXISTING OVERHEAD FIBER IS ACCEPTABLE.

FIBER OPTIC CABLE NOTES

- THE CONTRACTOR SHALL BE RESPONSIBLE FOR TERMINATING ALL ITS EQUIPMENT CABLE TO THE APPROPRIATE TERMINALS AND PROPERLY LABELING EACH CABLE. REFER TO THE IFB FOR CABLE LABELING SPECIFICATIONS.
- TRACER WIRE SHALL BE INSTALLED IN ALL PROPOSED OR EXISTING UNDERGROUND CONDUIT WHICH CONTAINS FIBER OPTIC CABLE. THE TRACER WIRE SHALL BE INCIDENTAL TO THE COST FOR FIBER OPTIC CABLES OR CONDUIT AS INDICATED BY THE SPECIAL PROVISIONS. TRACER WIRE SHALL BE A LOCATABLE MULE /PULL TAPE.
- ALL FIBER TERMINATION POINTS (CABLE AND CONDUIT) SHALL BE STAKED AND APPROVED BY MONTGOMERY COUNTY PRIOR TO INSTALLATION. CONTACT JIM COLBERT AT 240-777-2996.
- 4. ALL FIBER OPTIC CABLE WORK MUST BE COMPLETED BY MONTGOMERY COUNTY APPROVED CONTRACTOR.
- 5. ALL FIBER OPTIC AND CATEGORY 6 ETHERNET CABLE SHALL BE OUTDOOR RATED.
- 6. ALL FIBER OPTIC CABLE SHALL BE CONNECTORIZED USING PIGTAILS WITH FACTORY INSTALLED CONNECTORS. USE FC-UPC FOR SINGLE MODE FIBER. USE LC-UPC FOR MULTIMODE FIBER OM3.
- 7. SUPPLY 1 METER FC-UPC TO LC-UPC OR LC-UPC TO LC-UPC PATCH CORDS AS REQUIRED FOR CONNECTION OF PATCH PANEL TO ETHERNET SWITCH. USE CORNING GLASS BENDING SENSITIVE PATCH CORDS.
- PATCH PANELS SHALL USE FC-UPC CONNECTIONS FOR SINGLE MODE FIBER. PATCH PANELS SHALL USE LC-UPC CONNECTORS FOR MULTIMODE FIBER


ITS LEGEND PASSENGER INFORMATION DISPLAY AD PANEL TVM KIOSK CARD READER CCTV CAMERA COMM. CABINET AND PAD HANDHOLE ITS CONDUIT AND WIRING ITS CANOPY CONDUIT AND WIRING


ITS-1


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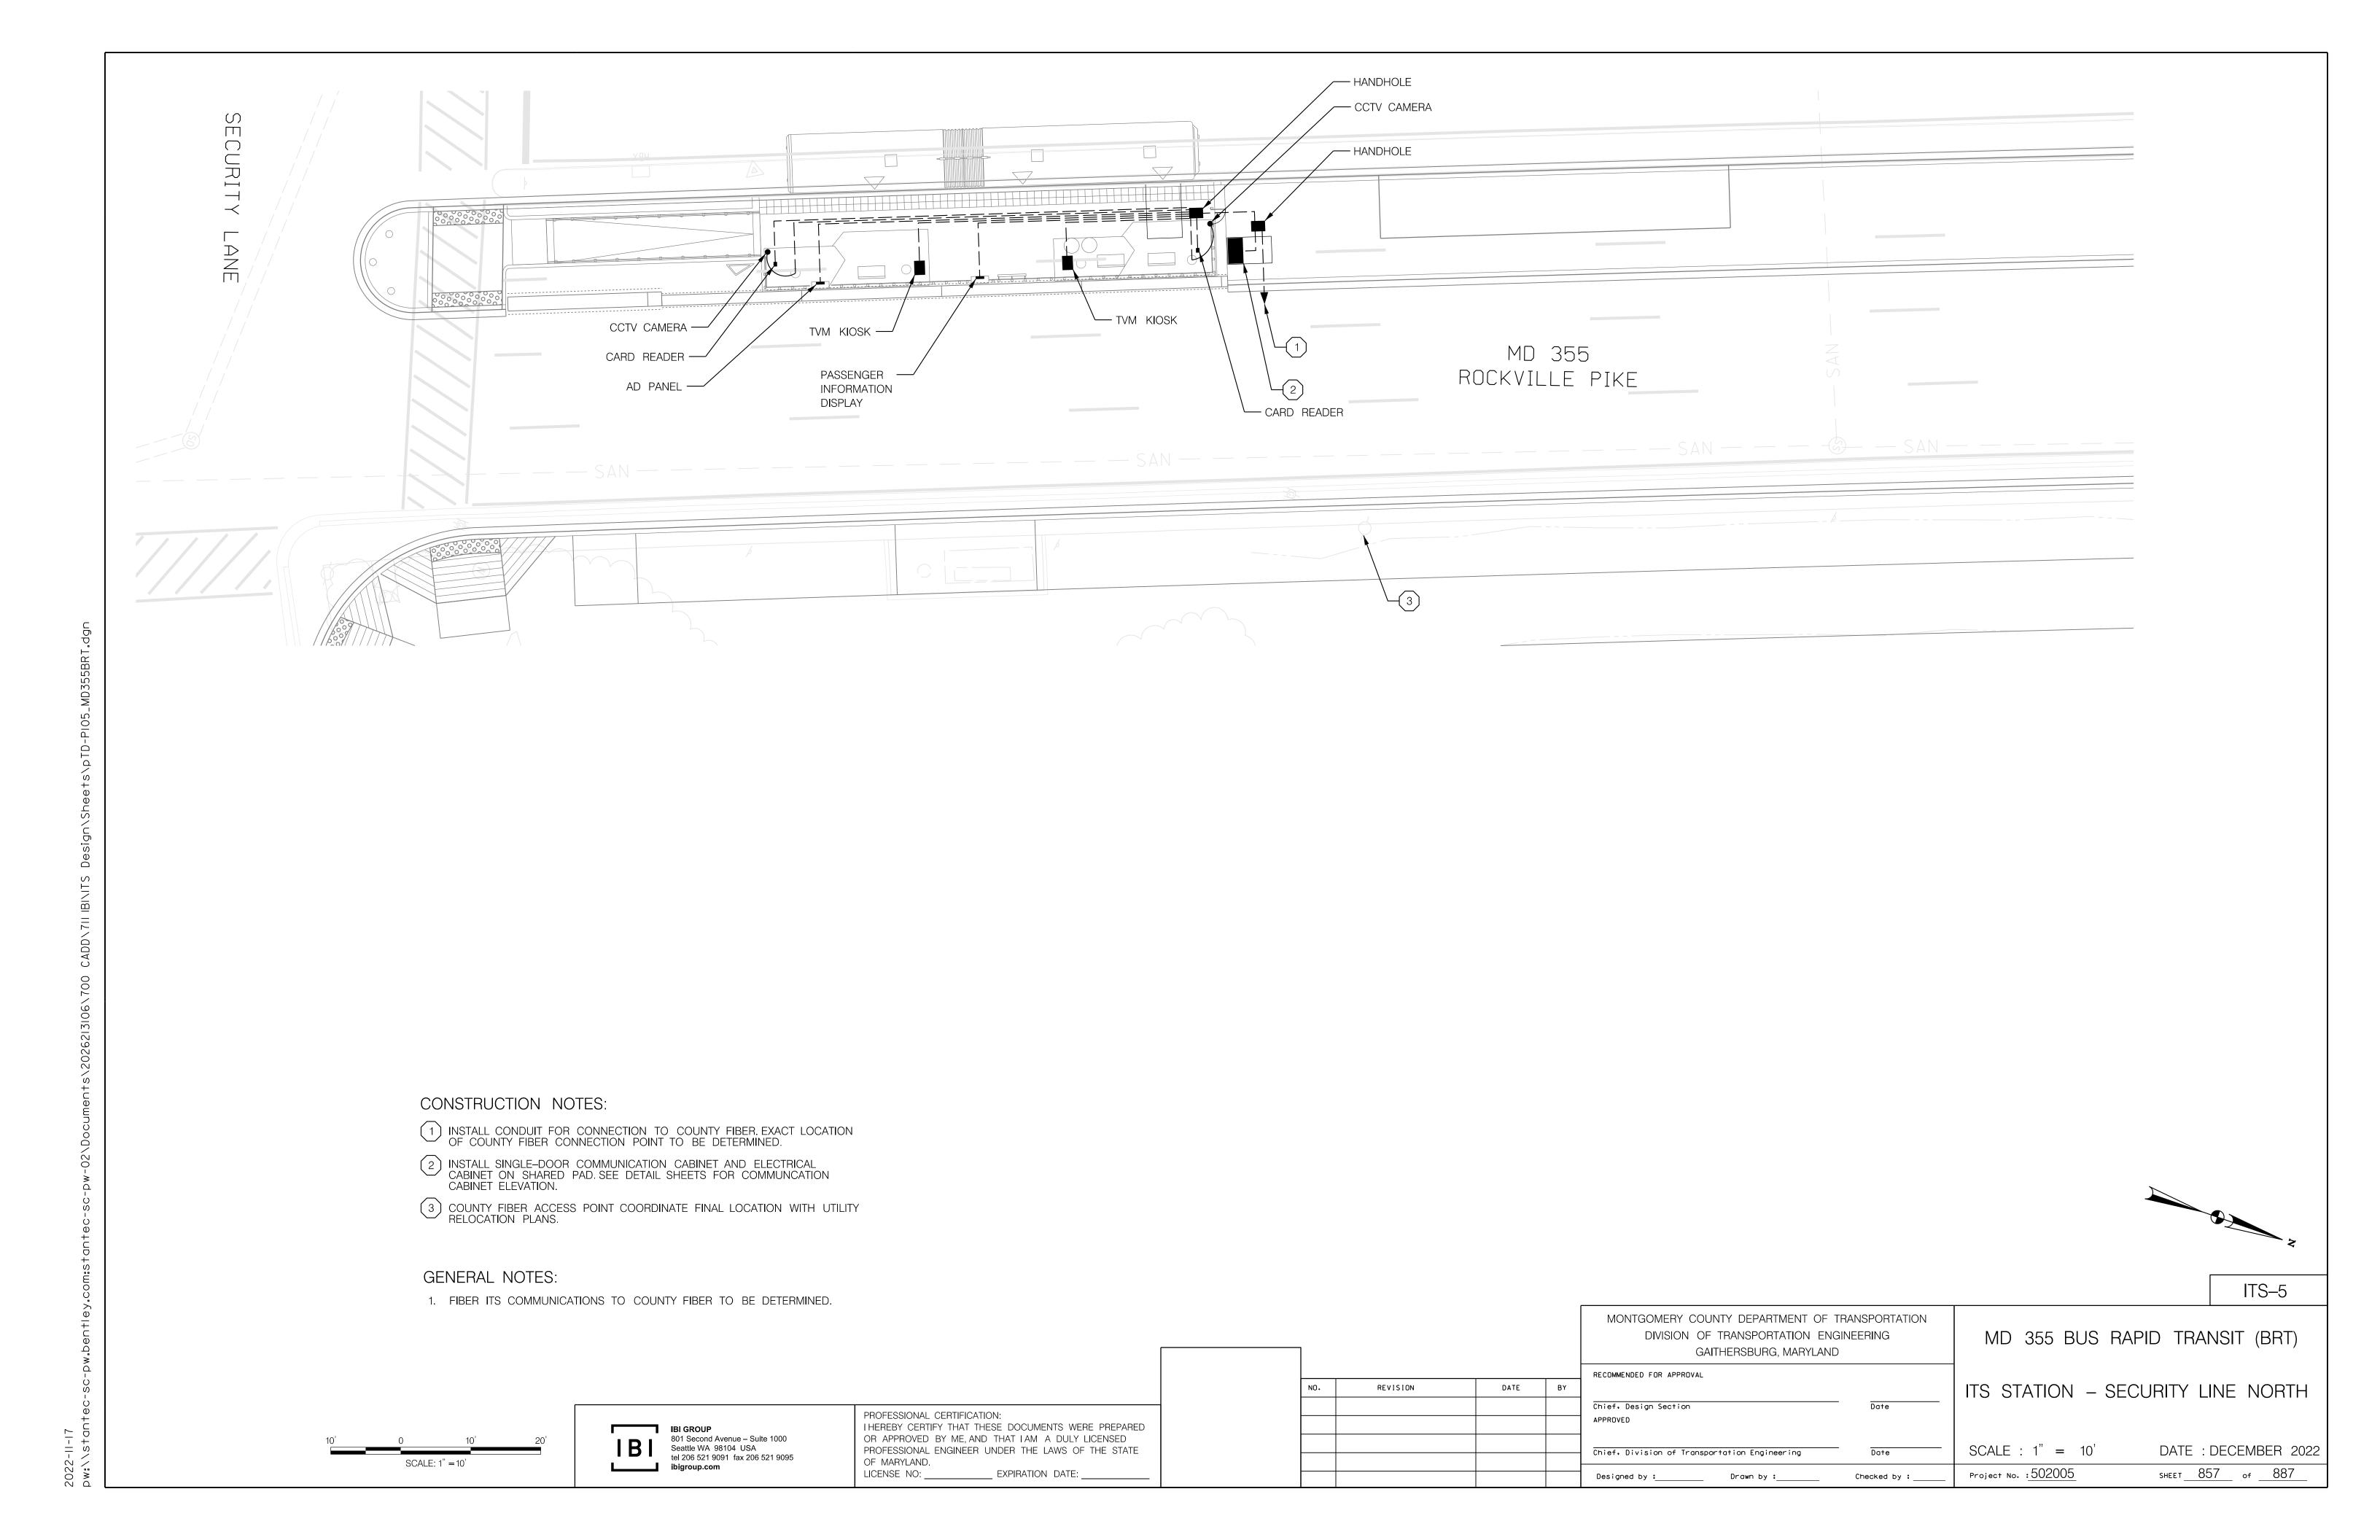
PROFESSIONAL CERTIFICATION: THEREBY CERTIFY THAT THESE DOCUMENTS WERE PREPARED OR APPROVED BY ME, AND THAT I AM A DULY LICENSED PROFESSIONAL ENGINEER UNDER THE LAWS OF THE STATE OF MARYLAND. ___ EXPIRATION DATE: LICENSE NO: _____


MONTGOMERY COUNTY DEPARTMENT OF TRANSPORTATION MD 355 BUS RAPID TRANSIT (BRT) DIVISION OF TRANSPORTATION ENGINEERING GAITHERSBURG, MARYLAND RECOMMENDED FOR APPROVAL ITS NOTES AND LEGEND REVISION DATE Chief, Design Section APPROVED SCALE: DATE: DECEMBER 2022 Chief, Division of Transportation Engineering Project No. :502005 SHEET 853 of 887 Designed by :_____ Drawn by :____ Checked by :




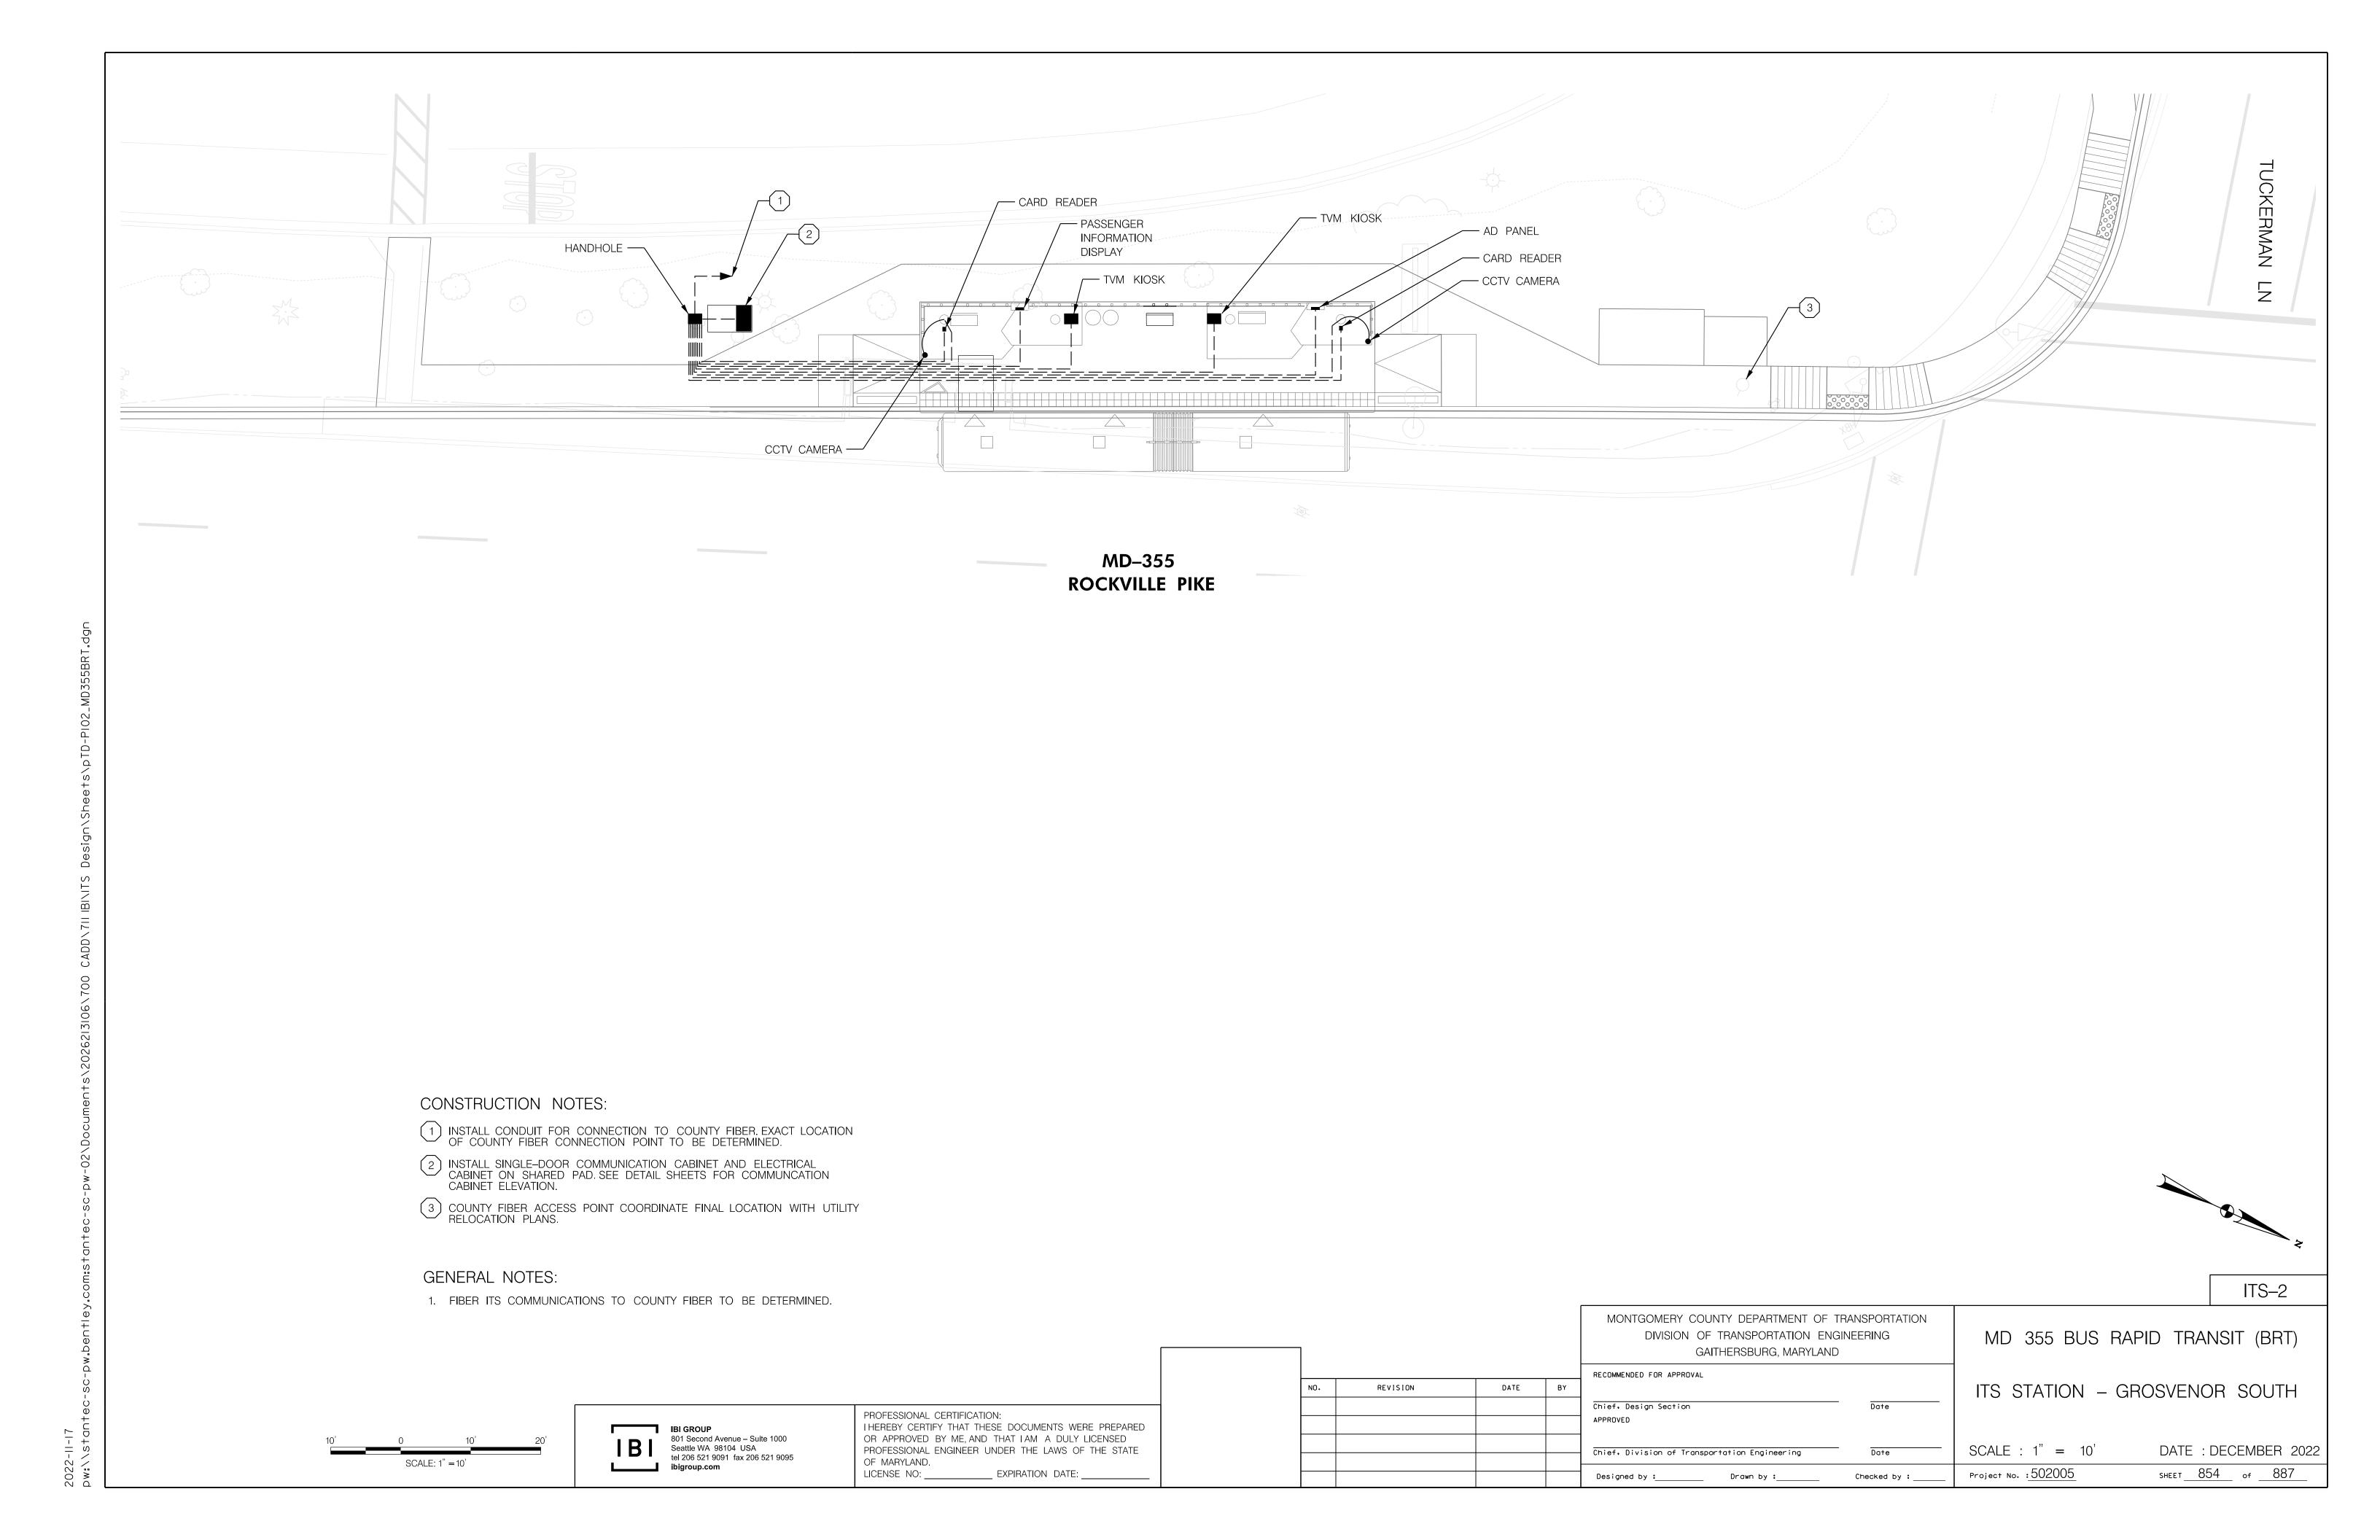

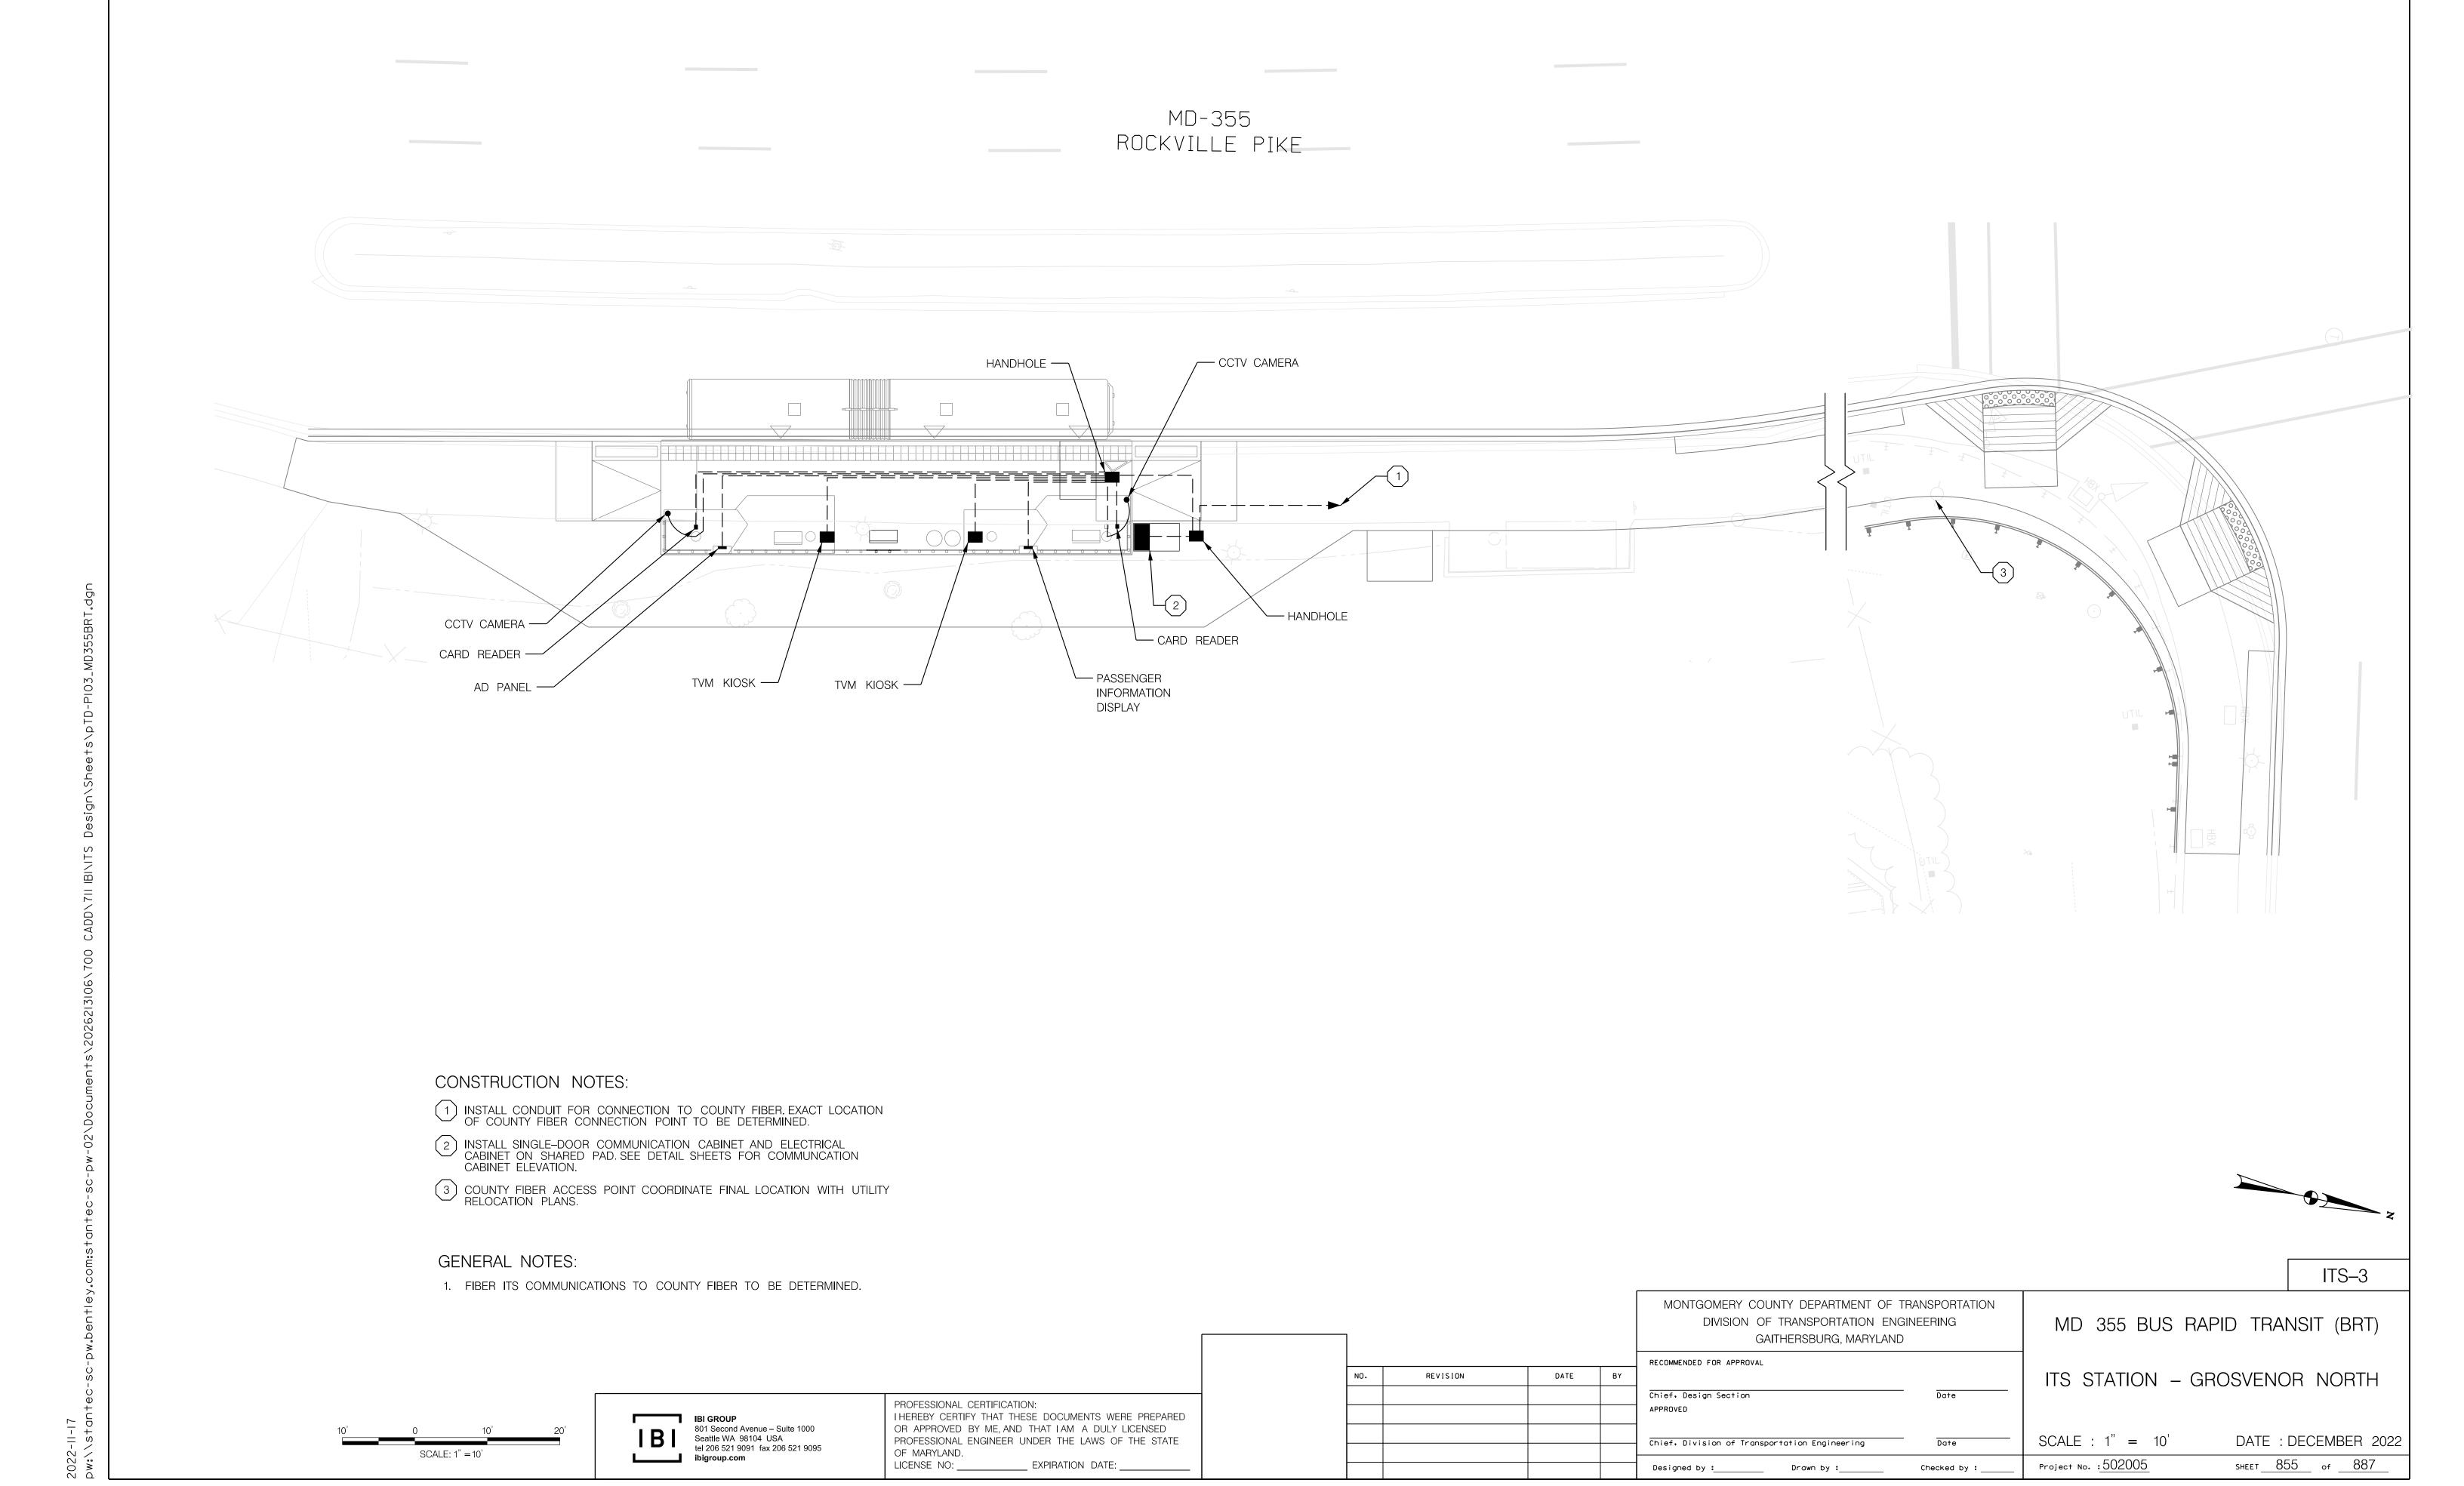

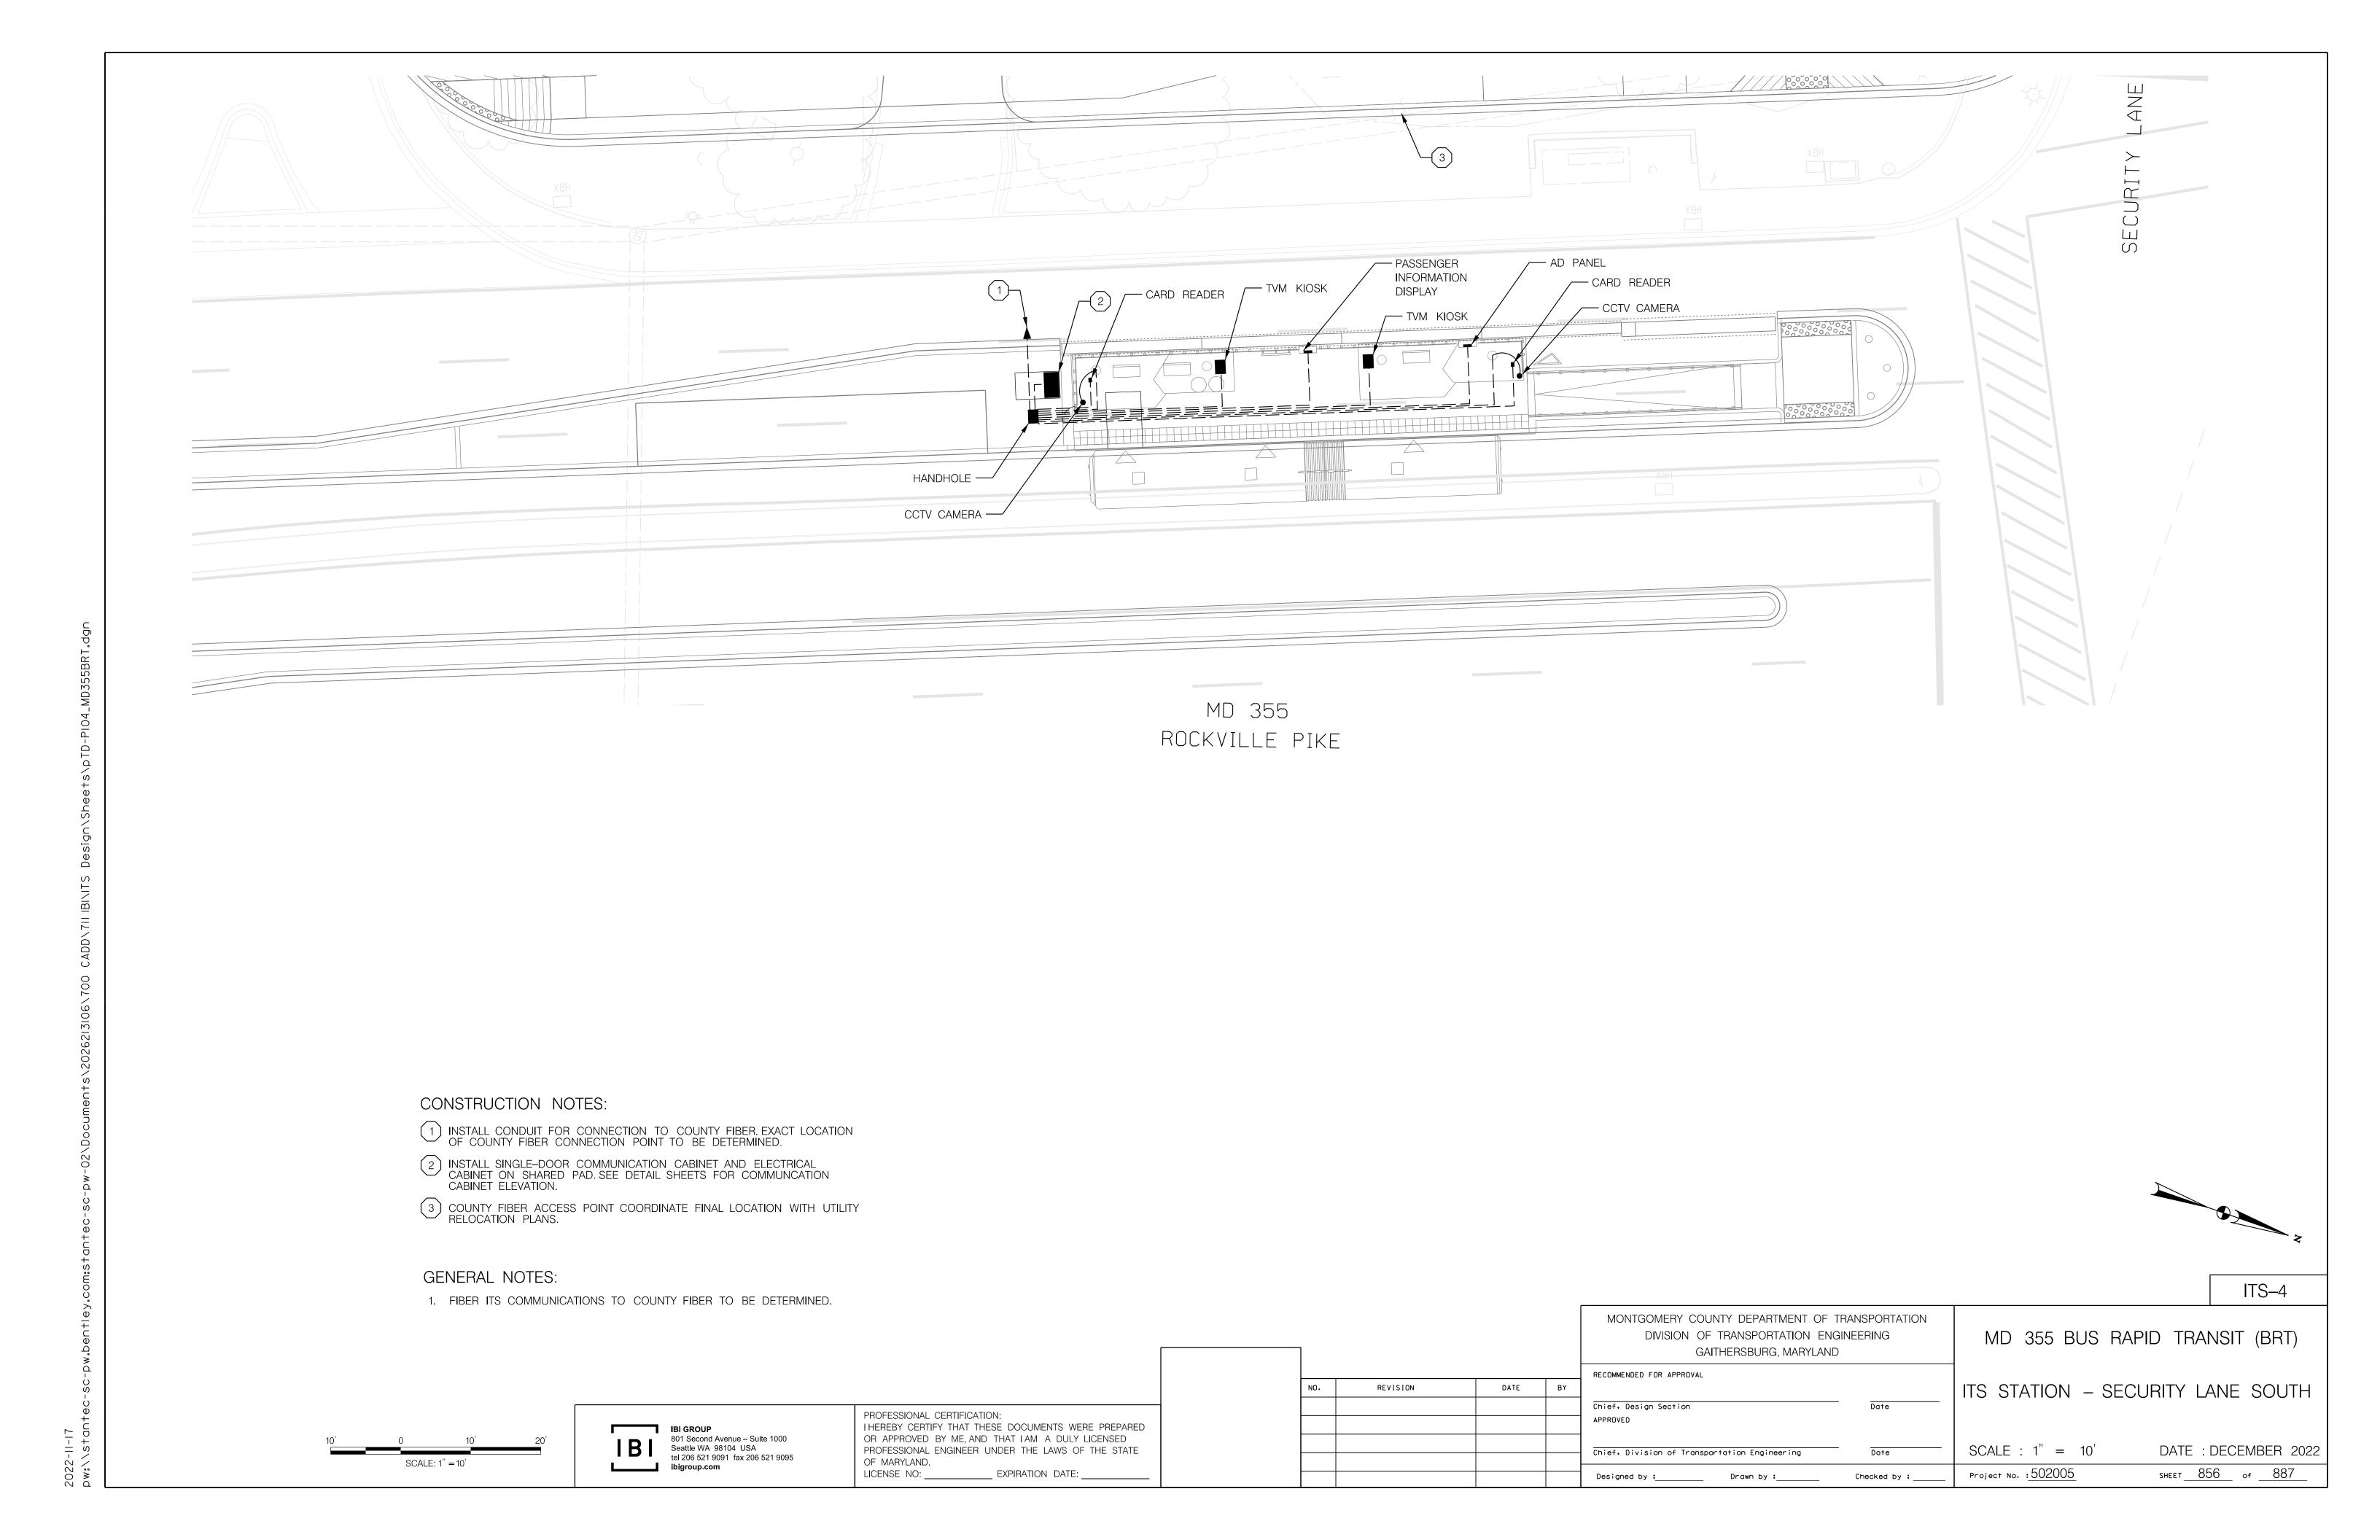

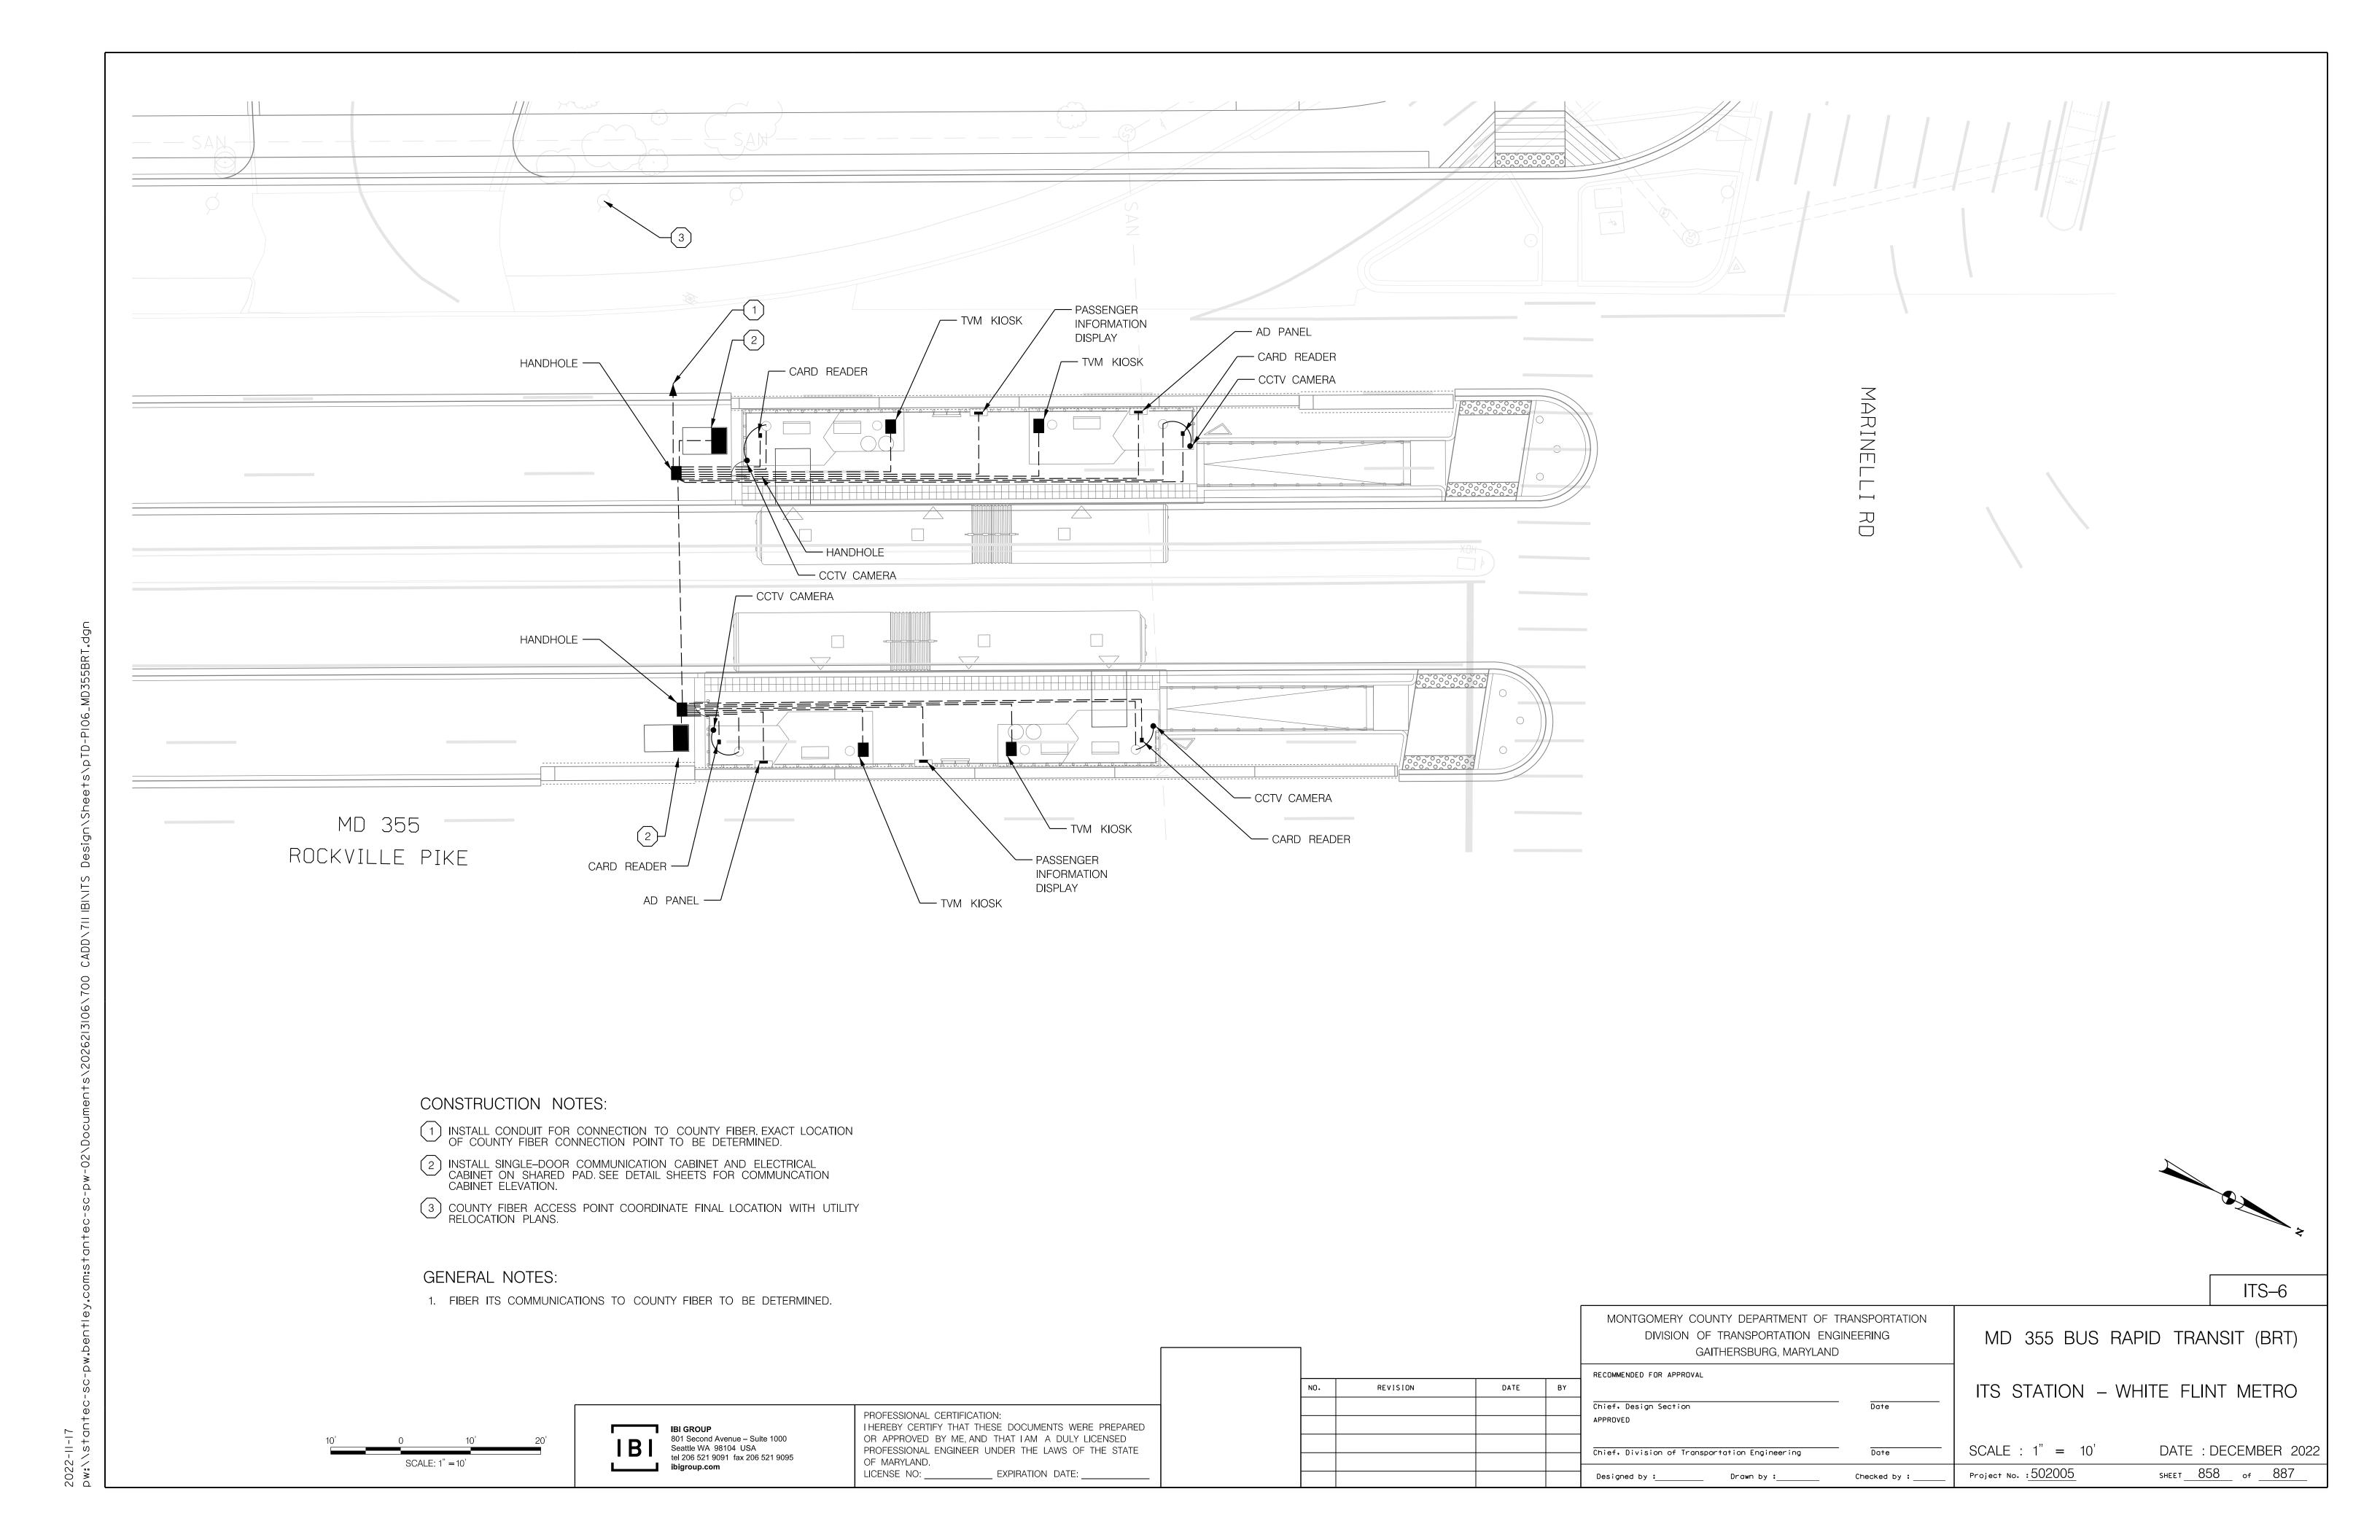

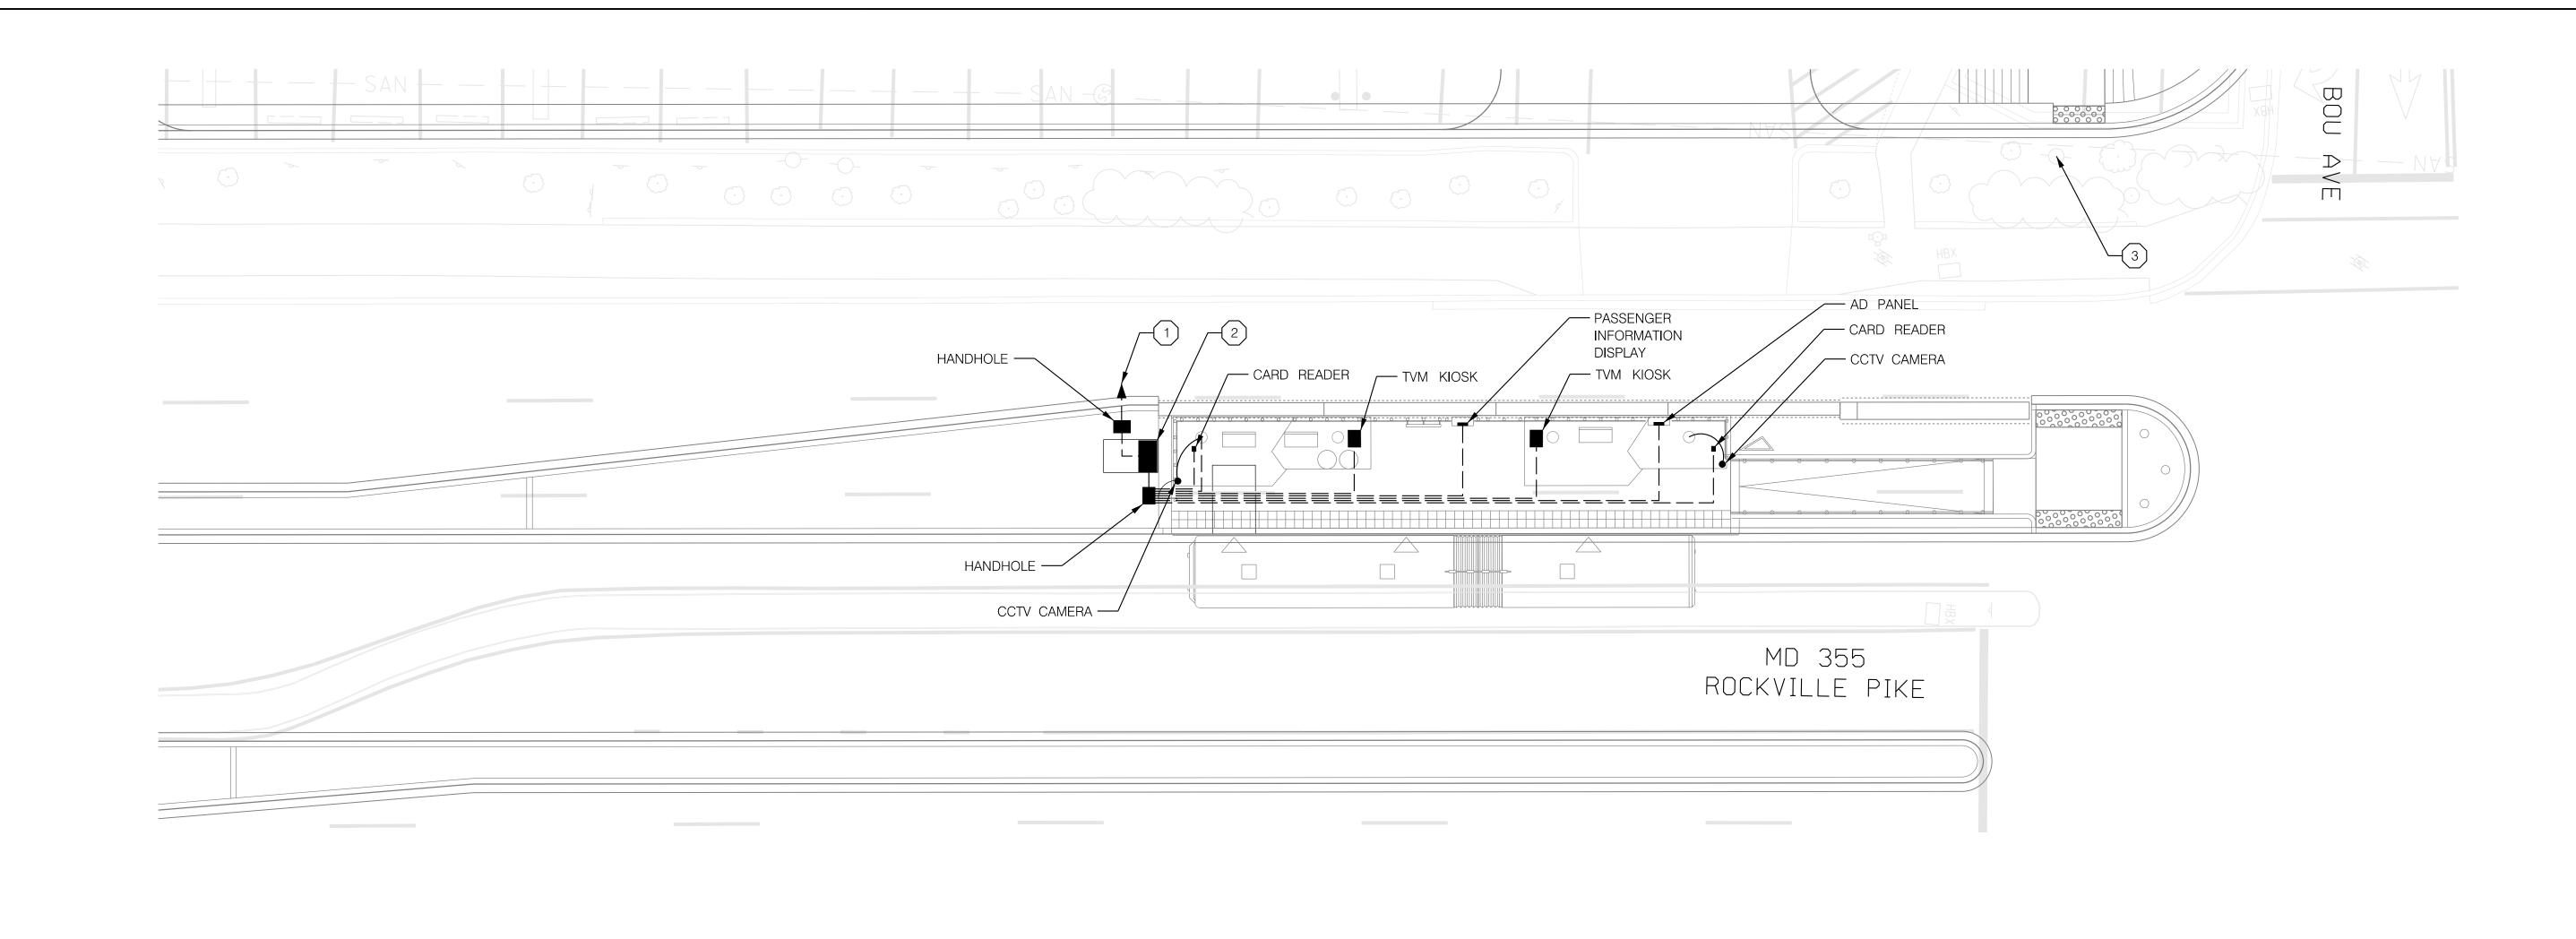

- 1) INSTALL CONDUIT FOR CONNECTION TO COUNTY FIBER. EXACT LOCATION OF COUNTY FIBER CONNECTION POINT TO BE DETERMINED.
- 2 INSTALL SINGLE-DOOR COMMUNICATION CABINET AND ELECTRICAL CABINET ON SHARED PAD. SEE DETAIL SHEETS FOR COMMUNCATION CABINET ELEVATION.
- 3 COUNTY FIBER ACCESS POINT COORDINATE FINAL LOCATION WITH UTILITY RELOCATION PLANS.


GENERAL NOTES:


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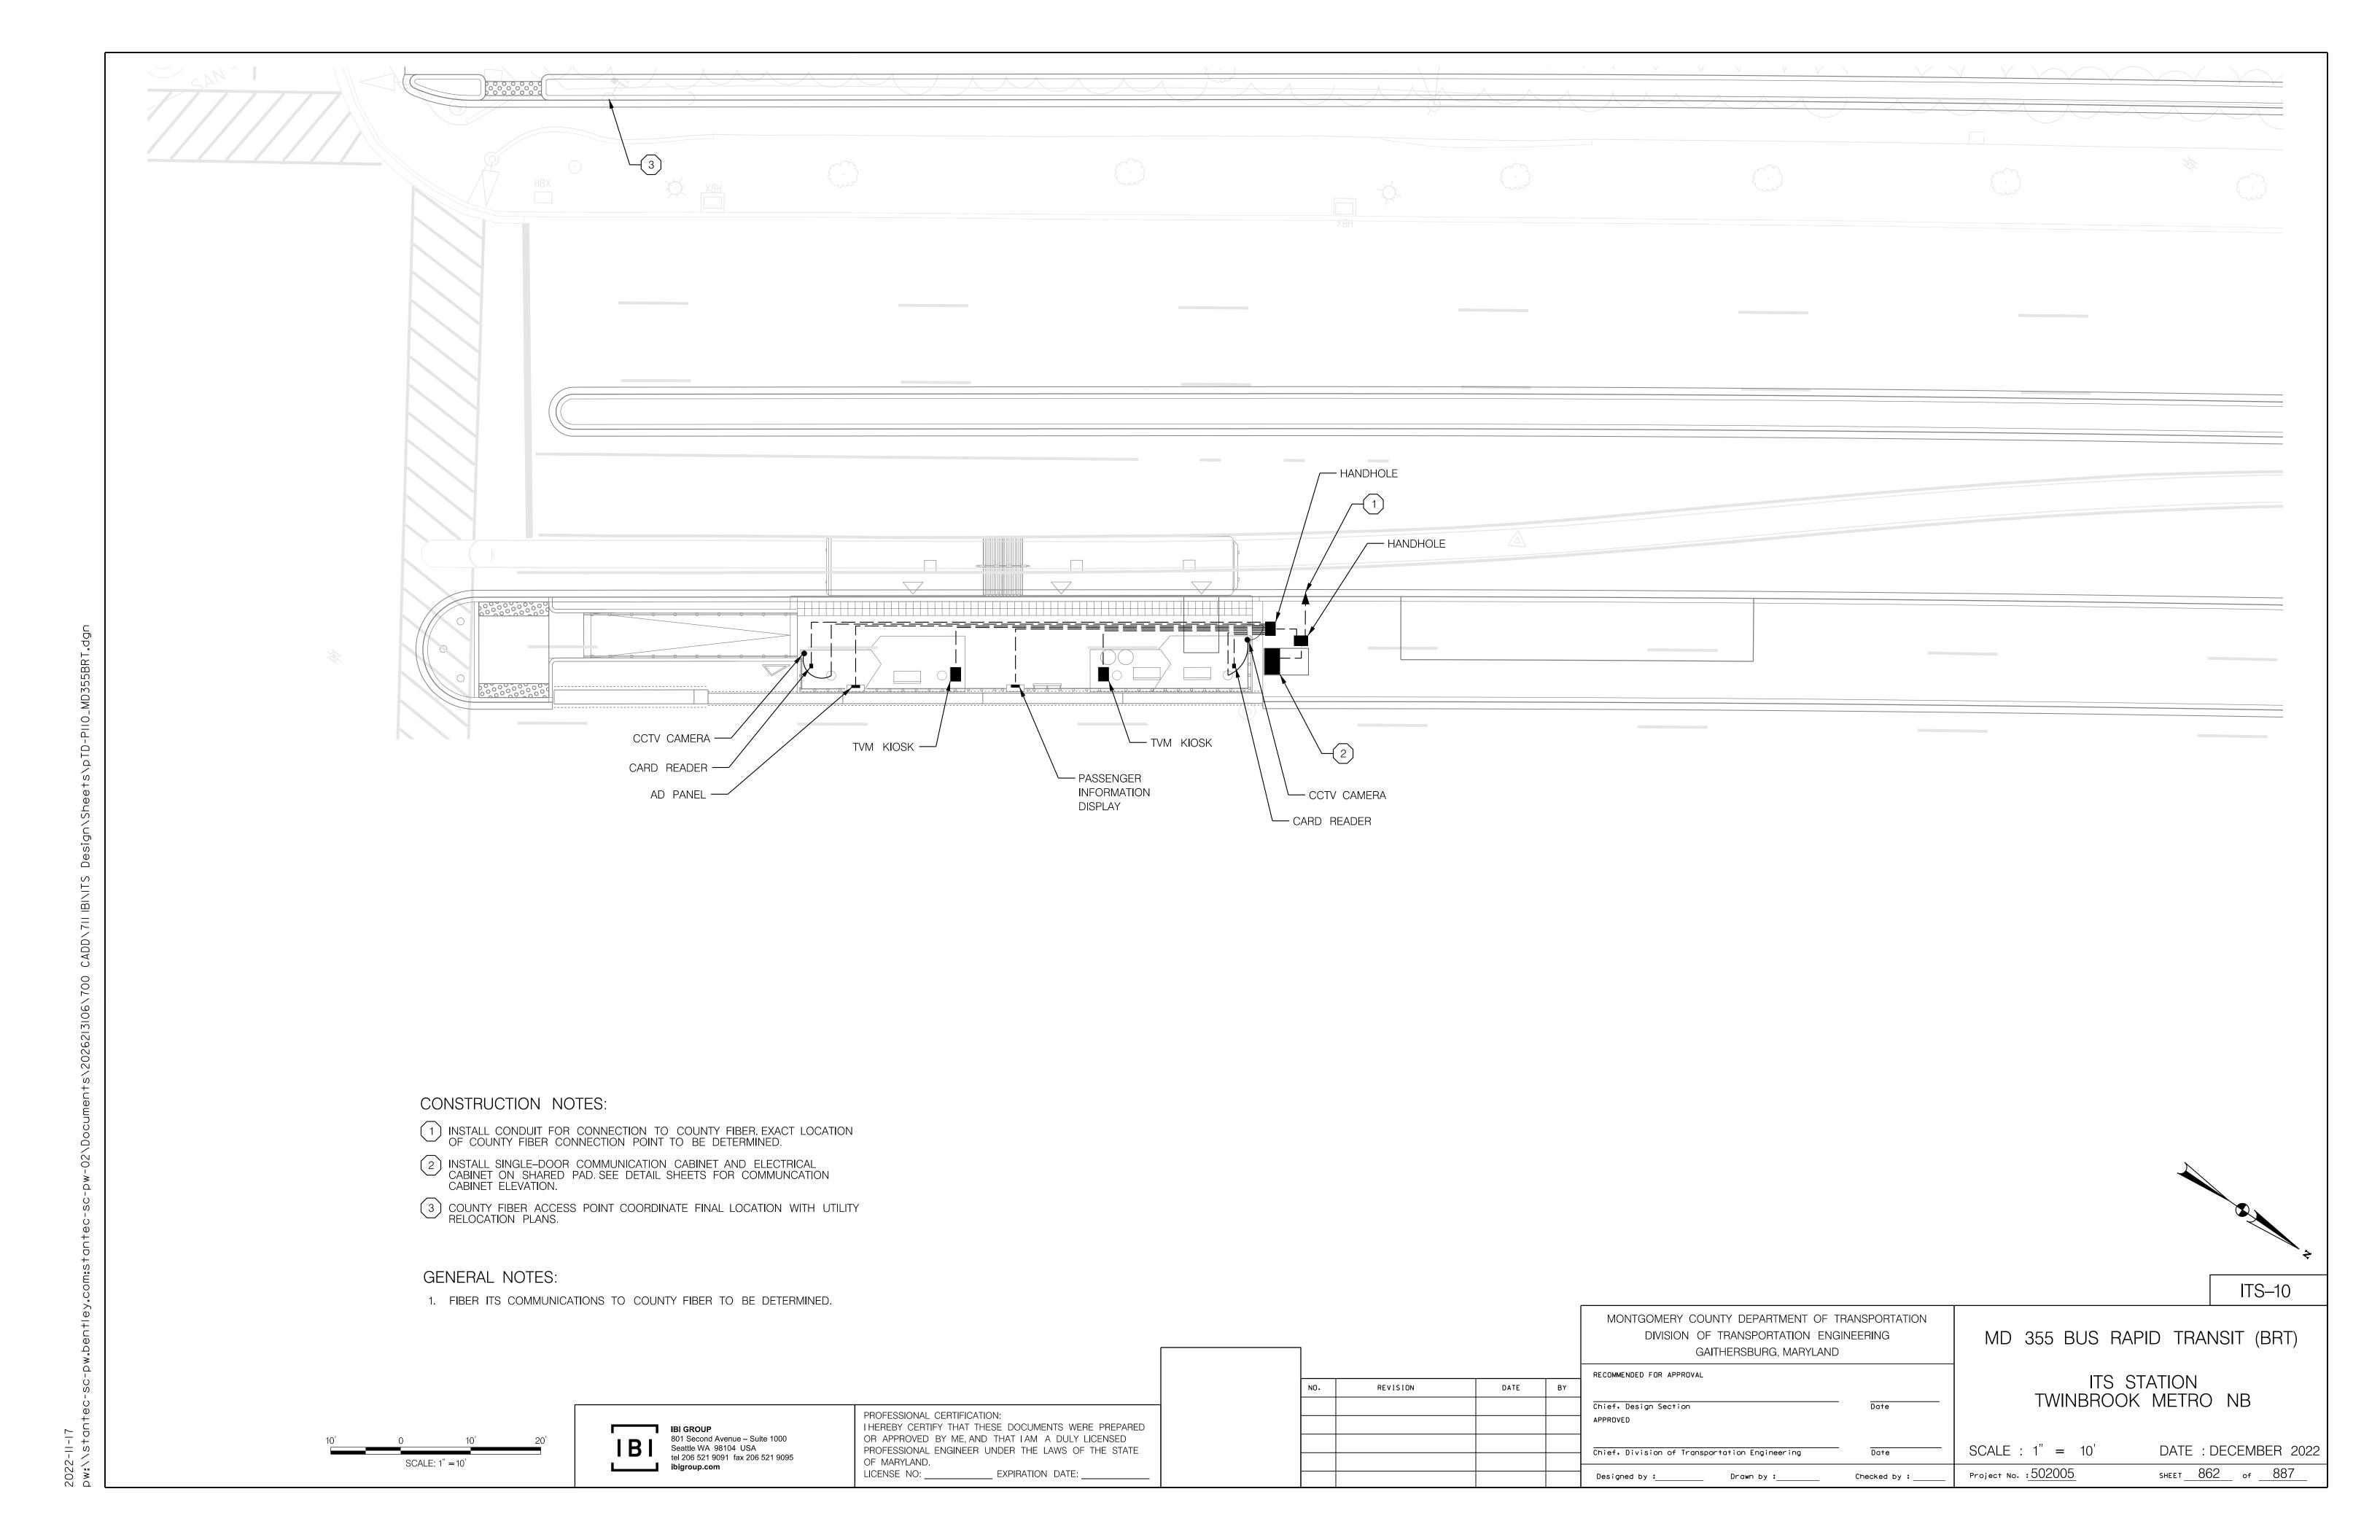
1. FIBER ITS COMMUNICATIONS TO COUNTY FIBER TO BE DETERMINED.


ITS-7 MONTGOMERY COUNTY DEPARTMENT OF TRANSPORTATION MD 355 BUS RAPID TRANSIT (BRT) DIVISION OF TRANSPORTATION ENGINEERING GAITHERSBURG, MARYLAND RECOMMENDED FOR APPROVAL ITS STATION - BOU AVENUE SOUTH DATE BY REVISION Chief. Design Section APPROVED SCALE : 1" = 10"DATE: DECEMBER 2022 Chief, Division of Transportation Engineering SHEET <u>859</u> of <u>887</u> Project No. : 502005 Designed by :_____ Drawn by :____ Checked by : _

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- 1) INSTALL CONDUIT FOR CONNECTION TO COUNTY FIBER. EXACT LOCATION OF COUNTY FIBER CONNECTION POINT TO BE DETERMINED.
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GENERAL NOTES:

1. FIBER ITS COMMUNICATIONS TO COUNTY FIBER TO BE DETERMINED.

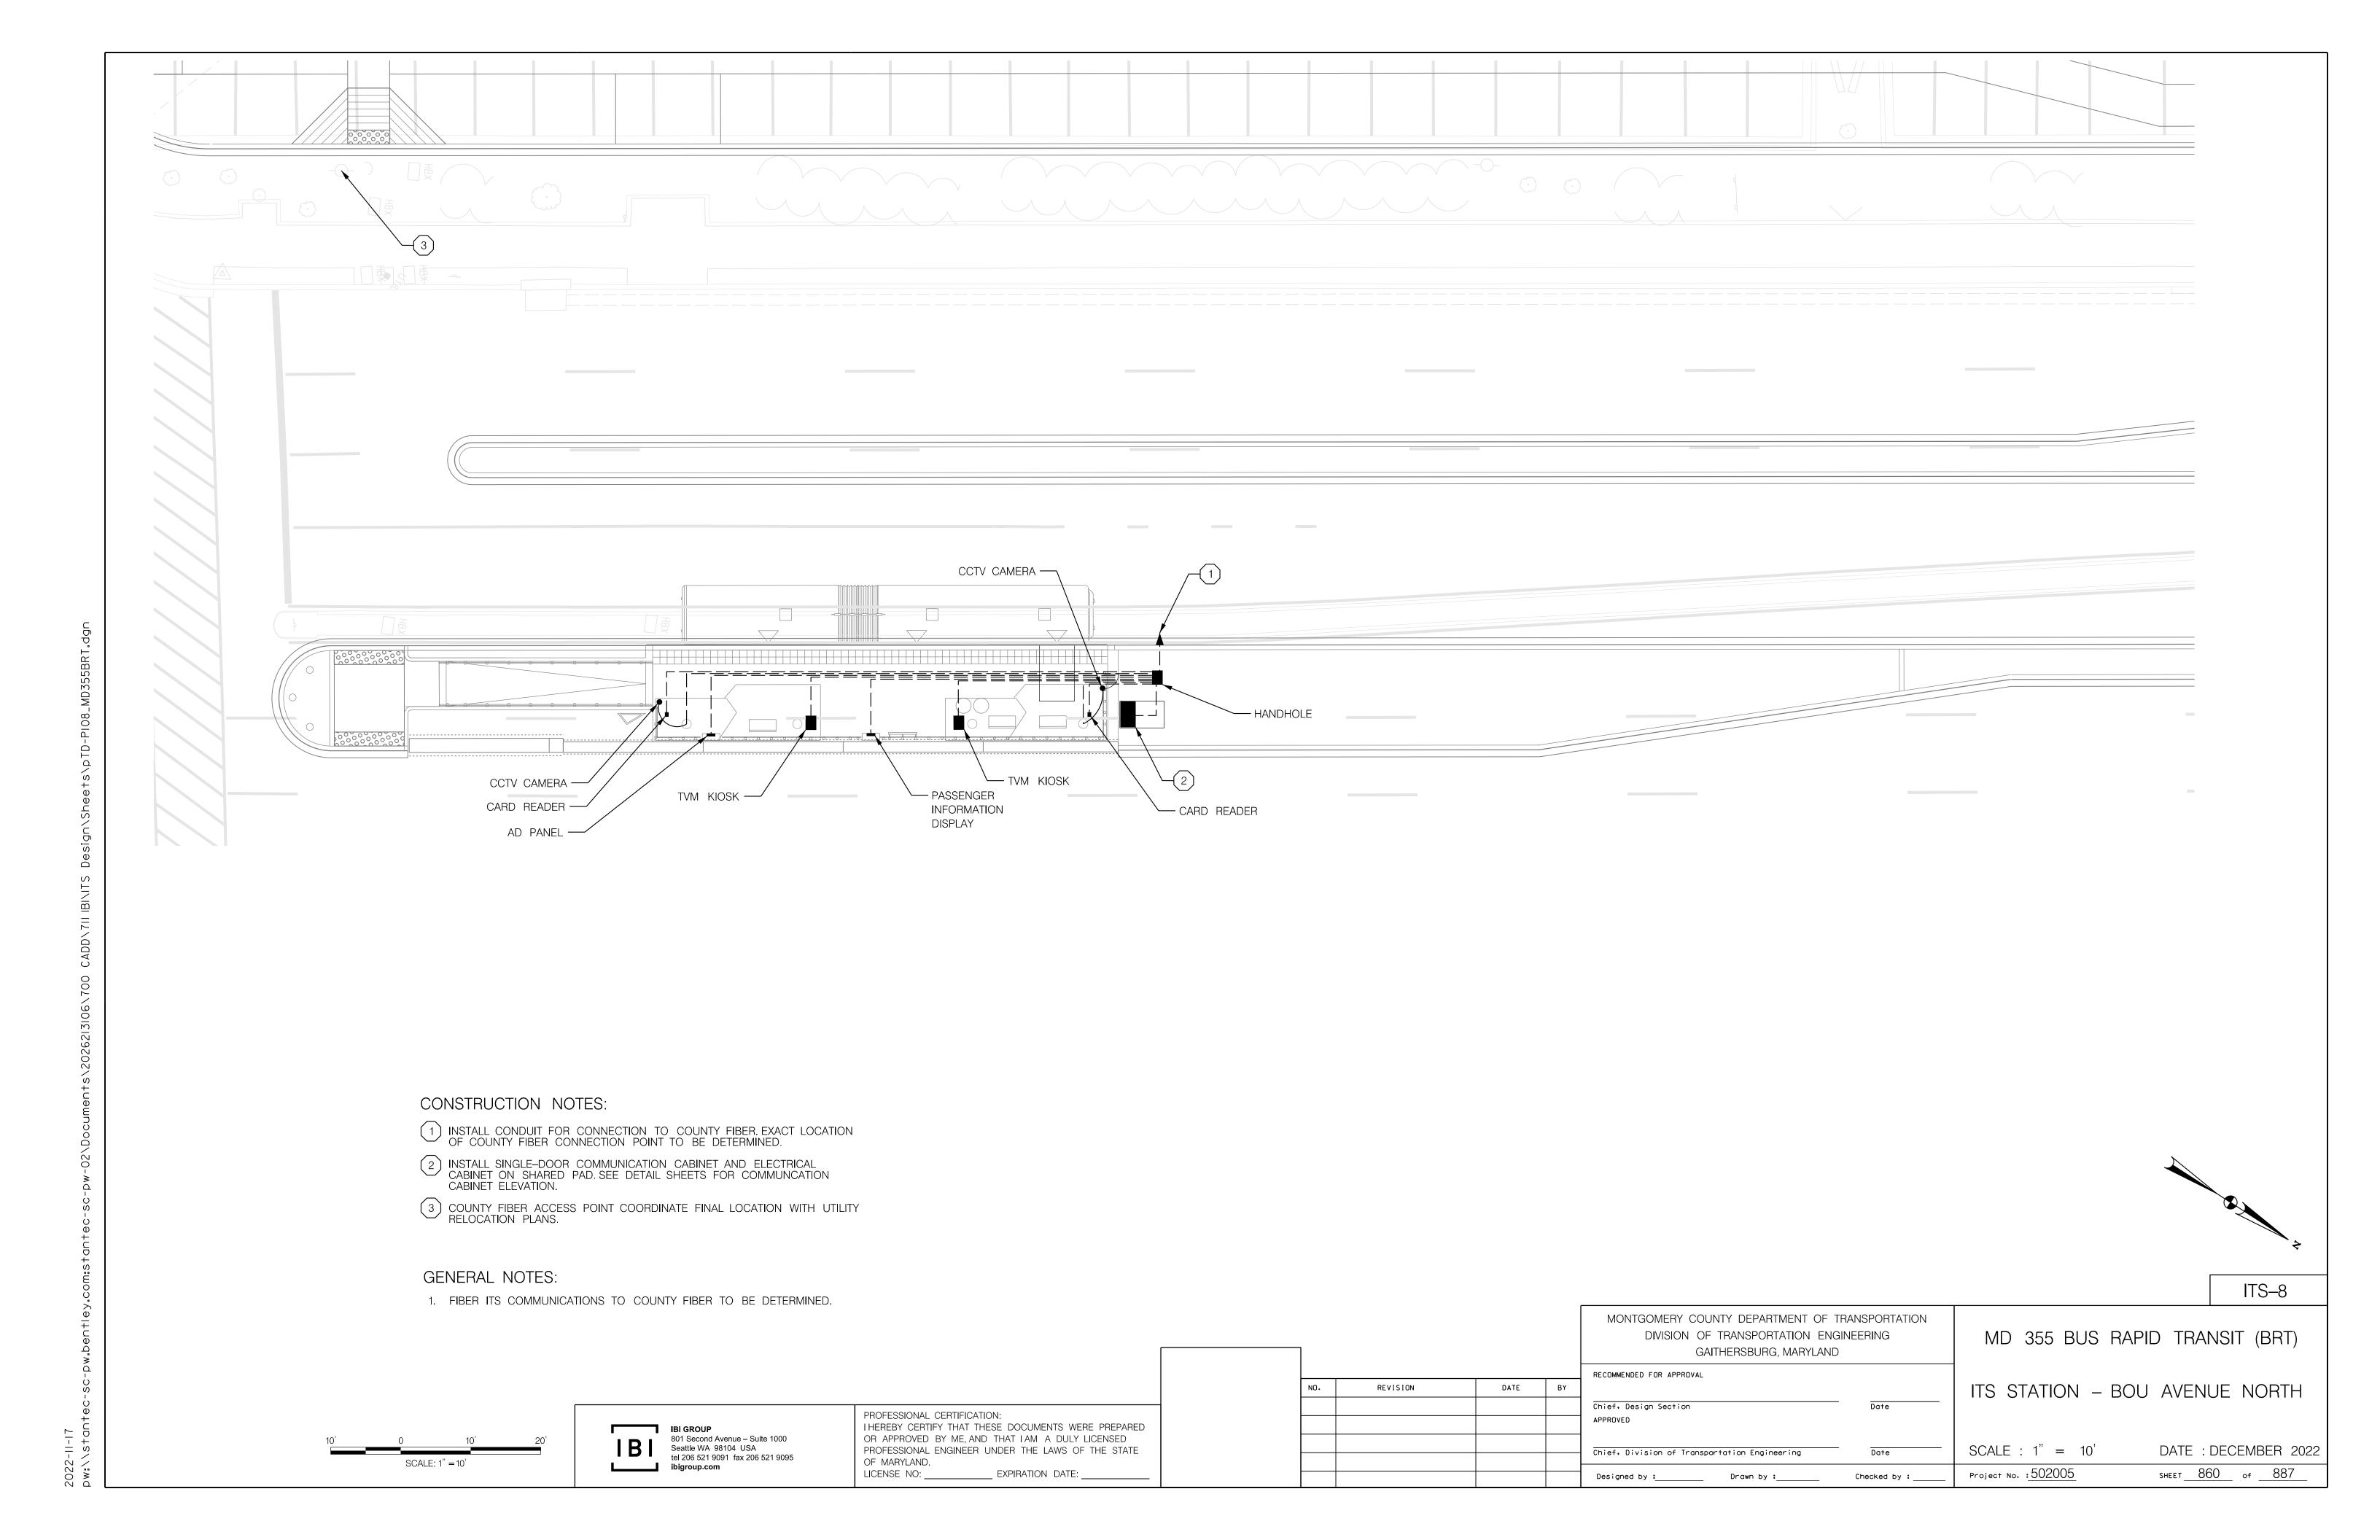MONTGOMERY COUNTY DEPARTMENT OF TRANSPORTATION
DIVISION OF TRANSPORTATION ENGINEERING
GAITHERSBURG, MARYLAND

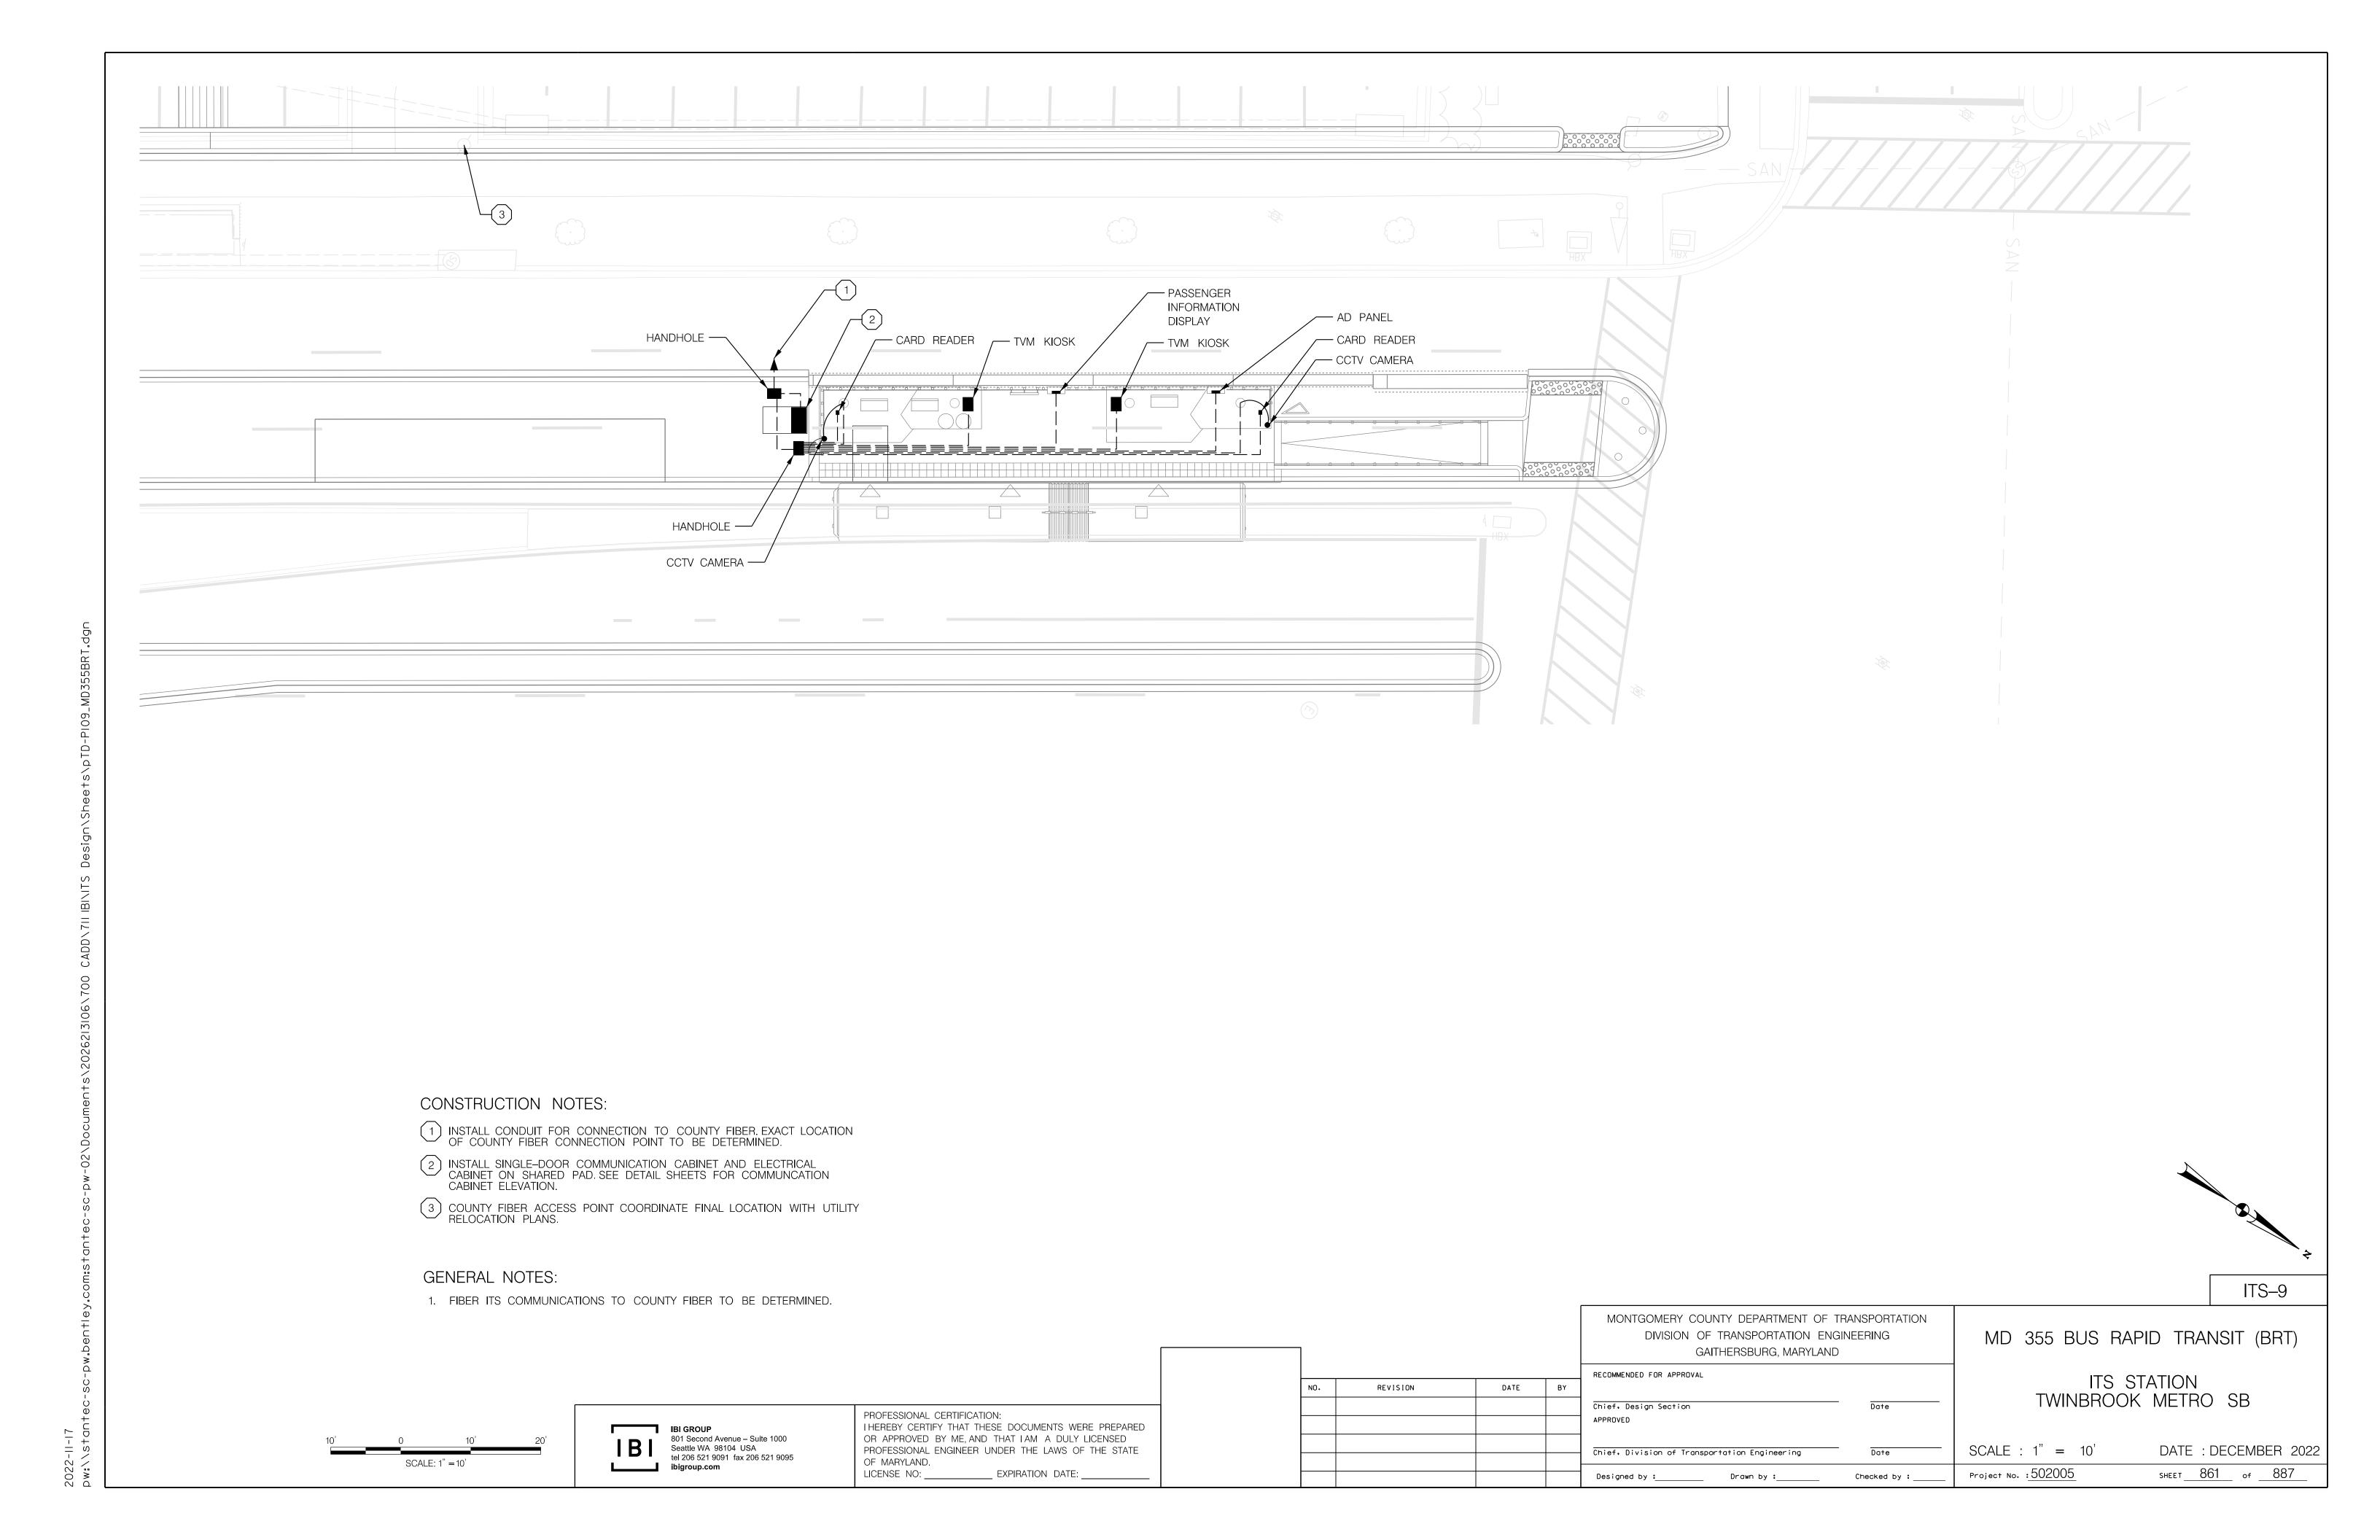RECOMMENDED FOR APPROVAL

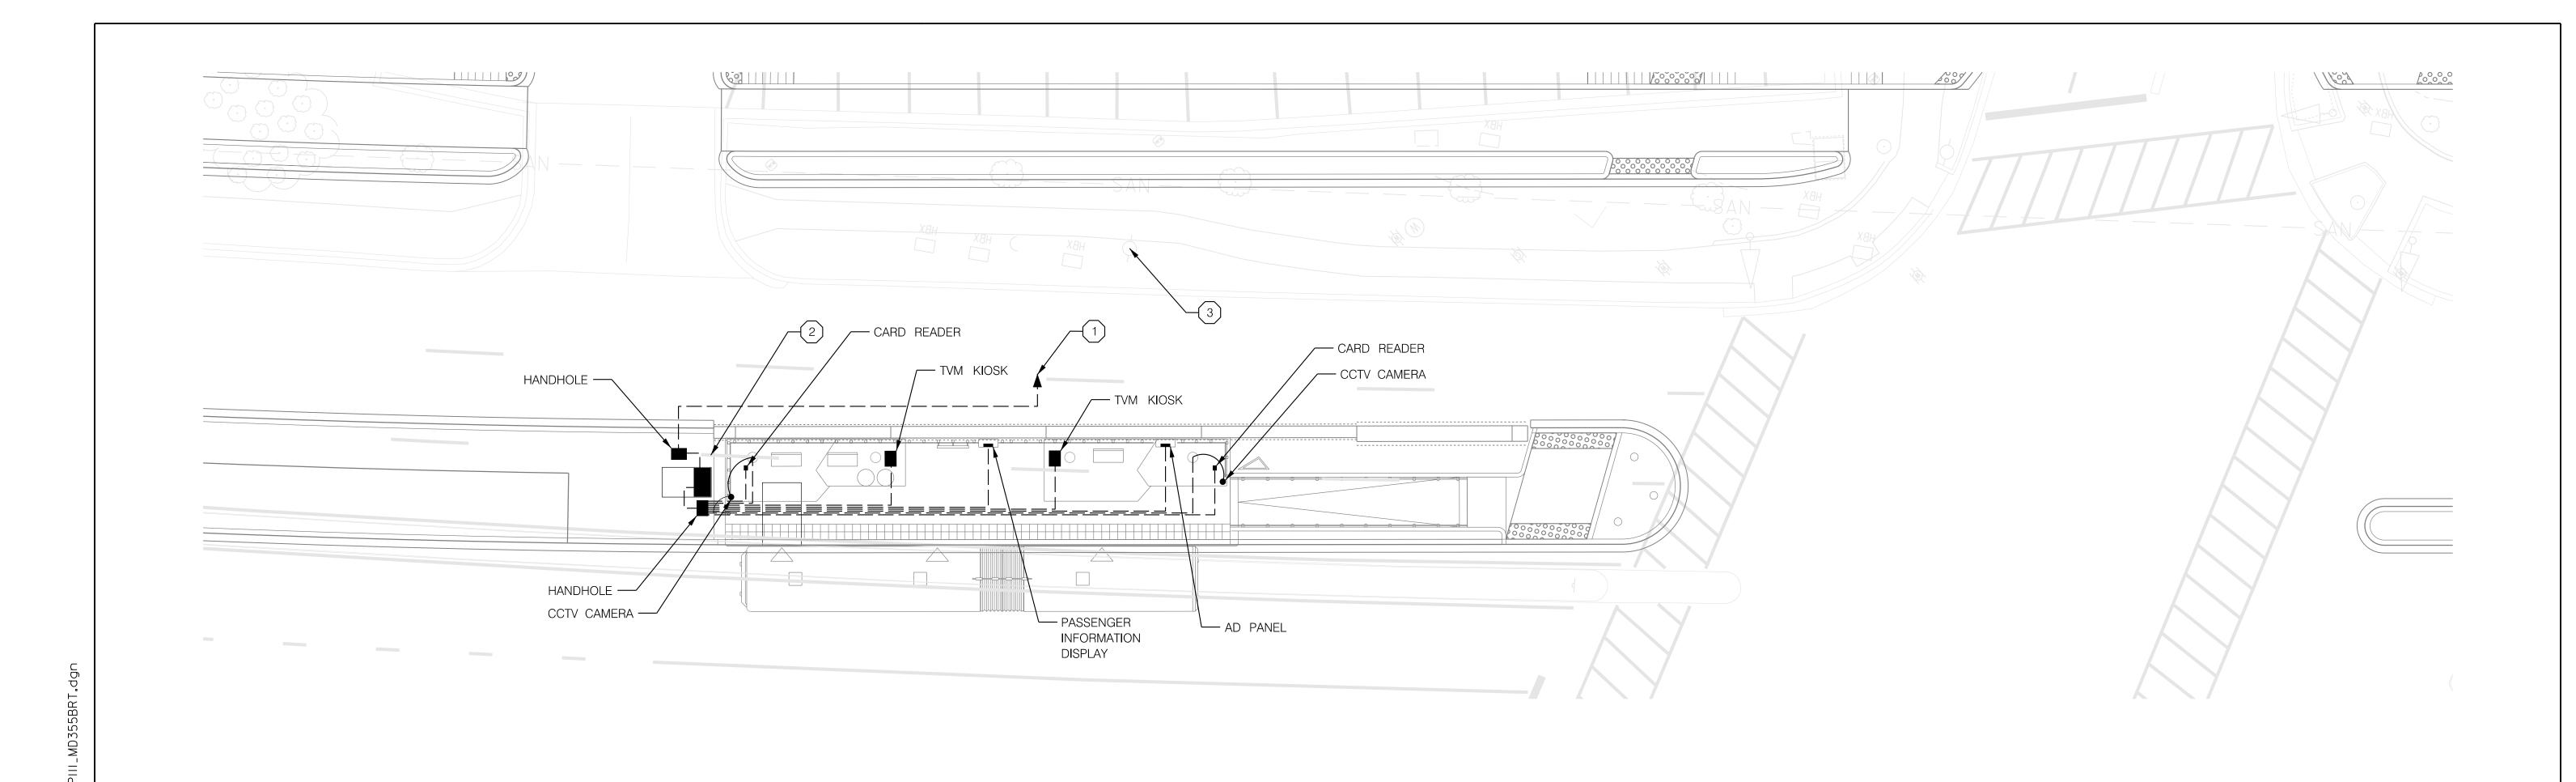Chief. Design Section
APPROVED

Chief, Division of Transportation Engineering
Date

Designed by :______ Drawn by :_____ Checked by :_____

MD 355 BUS RAPID TRANSIT (BRT)

ITS-11


ITS STATION EDMONSTON DRIVE SB

SCALE : 1" = 10' DATE : DECEMBER 2022

Project No. : 502005 SHEET 863 of 887

10' 0 10' SCALE: 1" = 10'

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- 2 INSTALL SINGLE-DOOR COMMUNICATION CABINET AND ELECTRICAL CABINET ON SHARED PAD. SEE DETAIL SHEETS FOR COMMUNCATION CABINET ELEVATION.
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GENERAL NOTES:
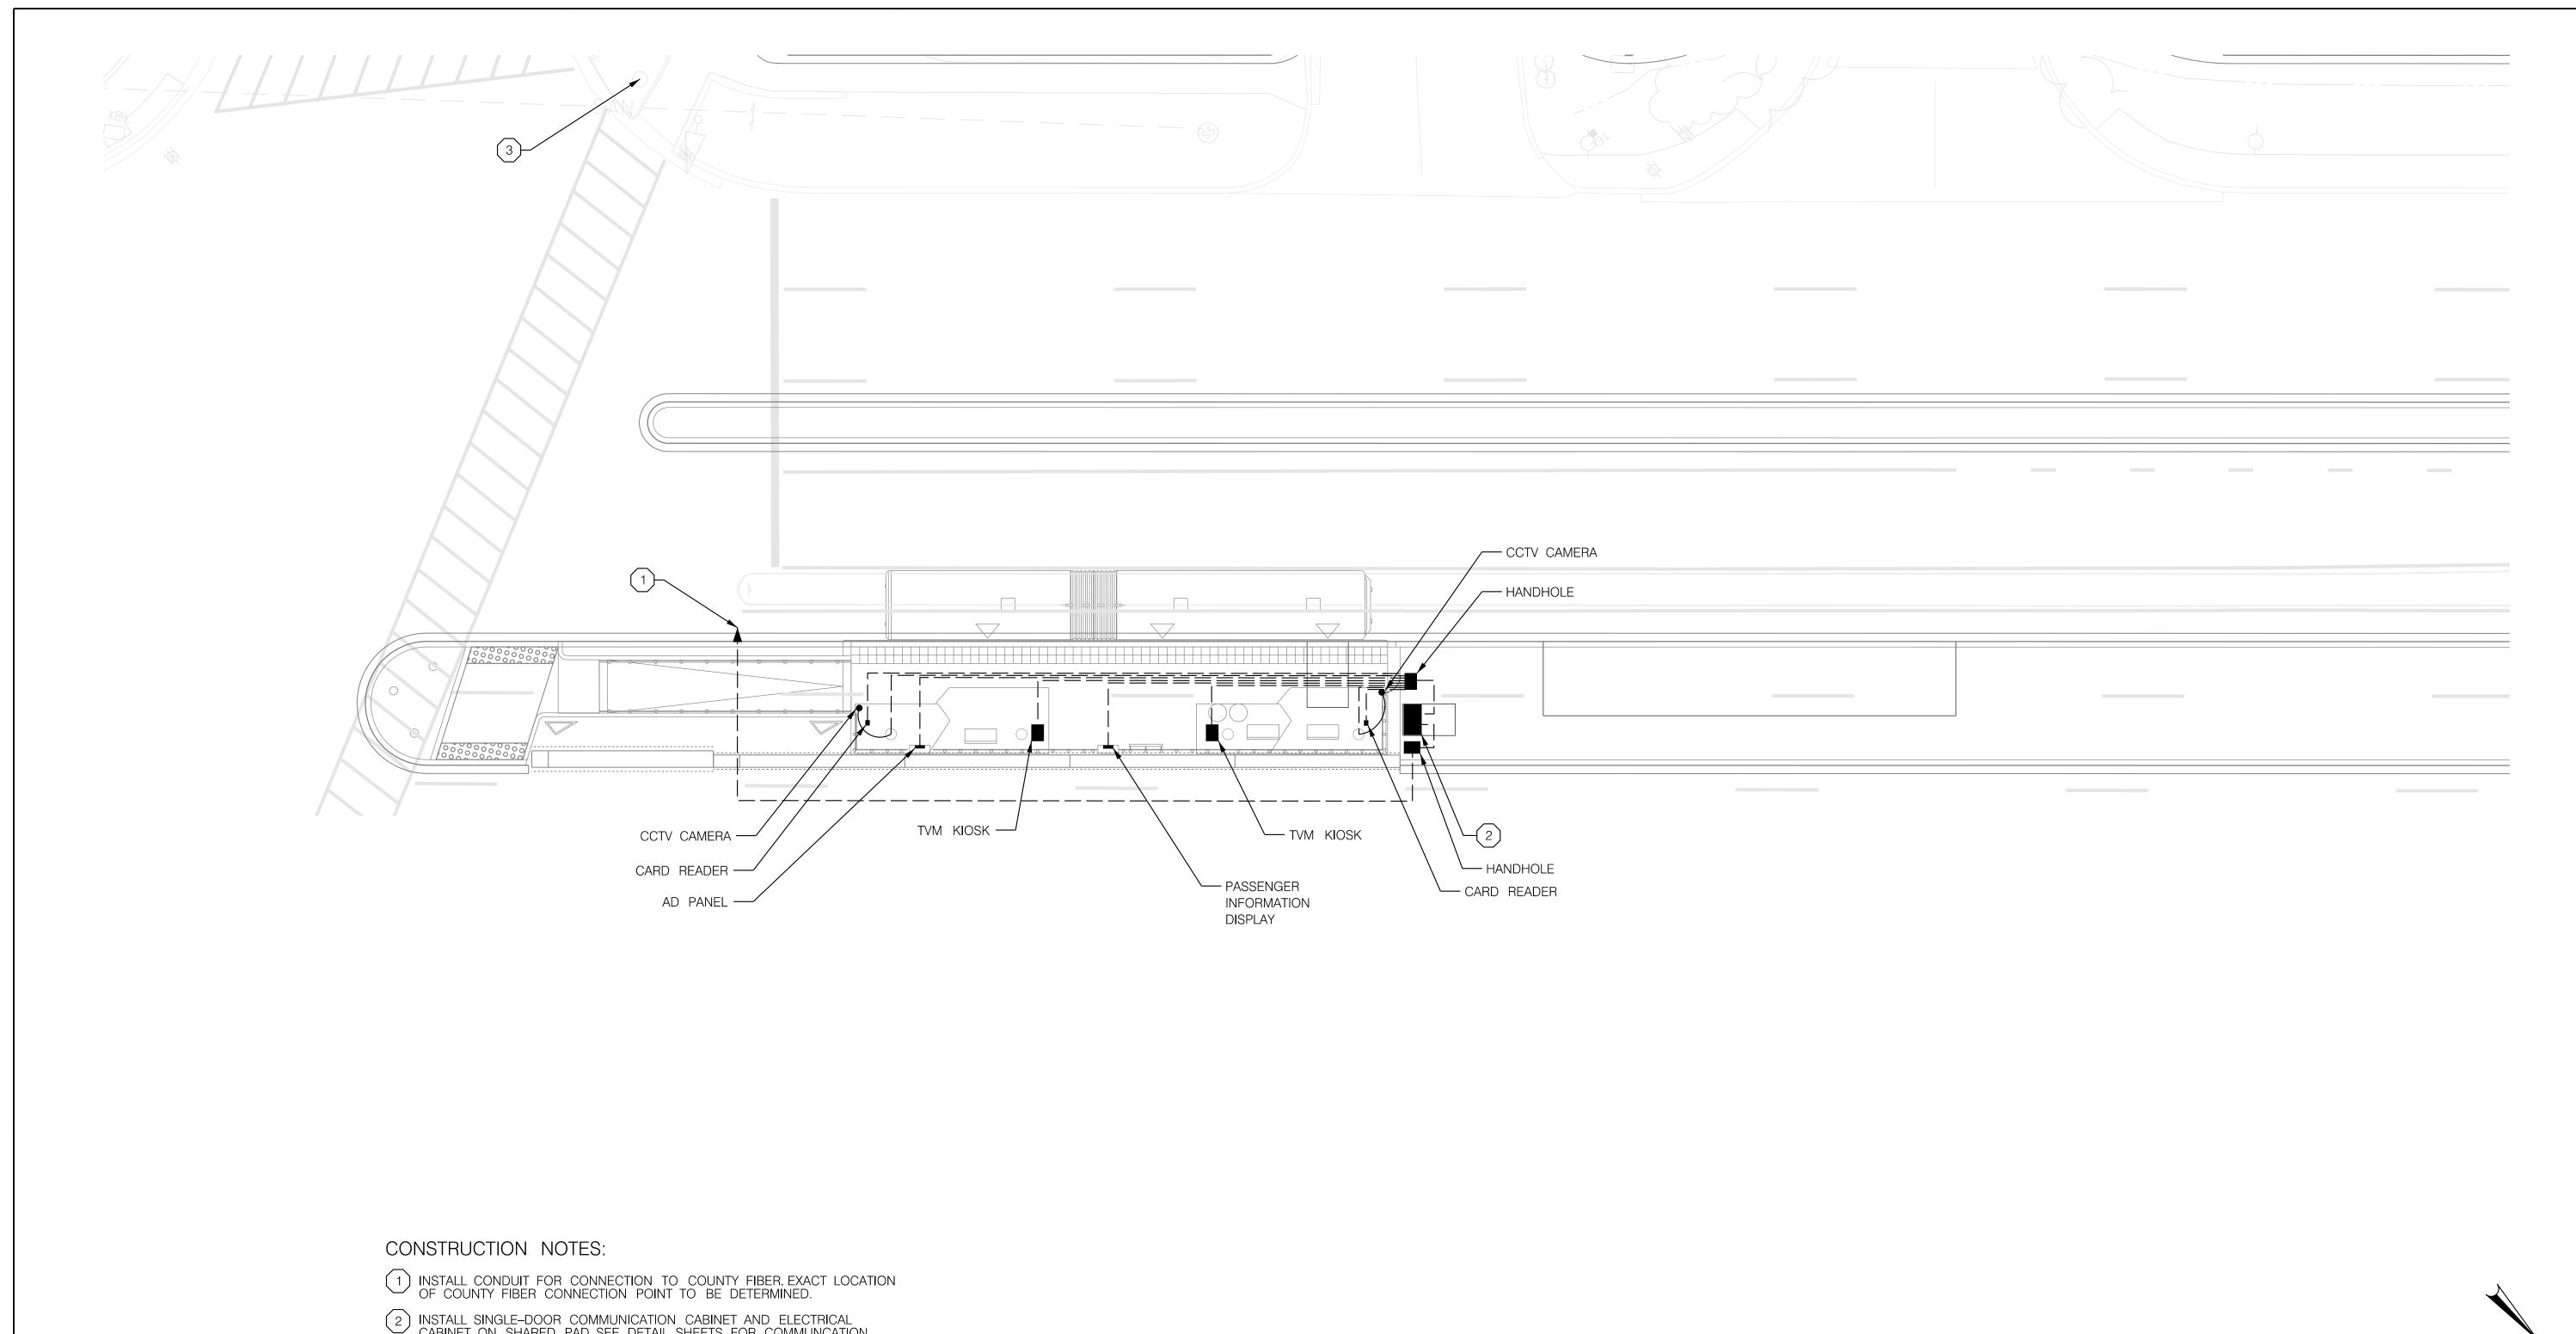
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	MONTGOMERY COUNTY DEPARTMENT OF TOUR DIVISION OF TRANSPORTATION ENG. GAITHERSBURG, MARYLAND	GINEERING	
DATE DY	RECOMMENDED FOR APPROVAL		
DATE BY	Chief, Design Section APPROVED	Date	
	Chief, Division of Transportation Engineering	Date	SC

Designed by :_____ Drawn by :____

Checked by : ___


REVISION

MD 355 BUS RAPID TRANSIT (BRT)


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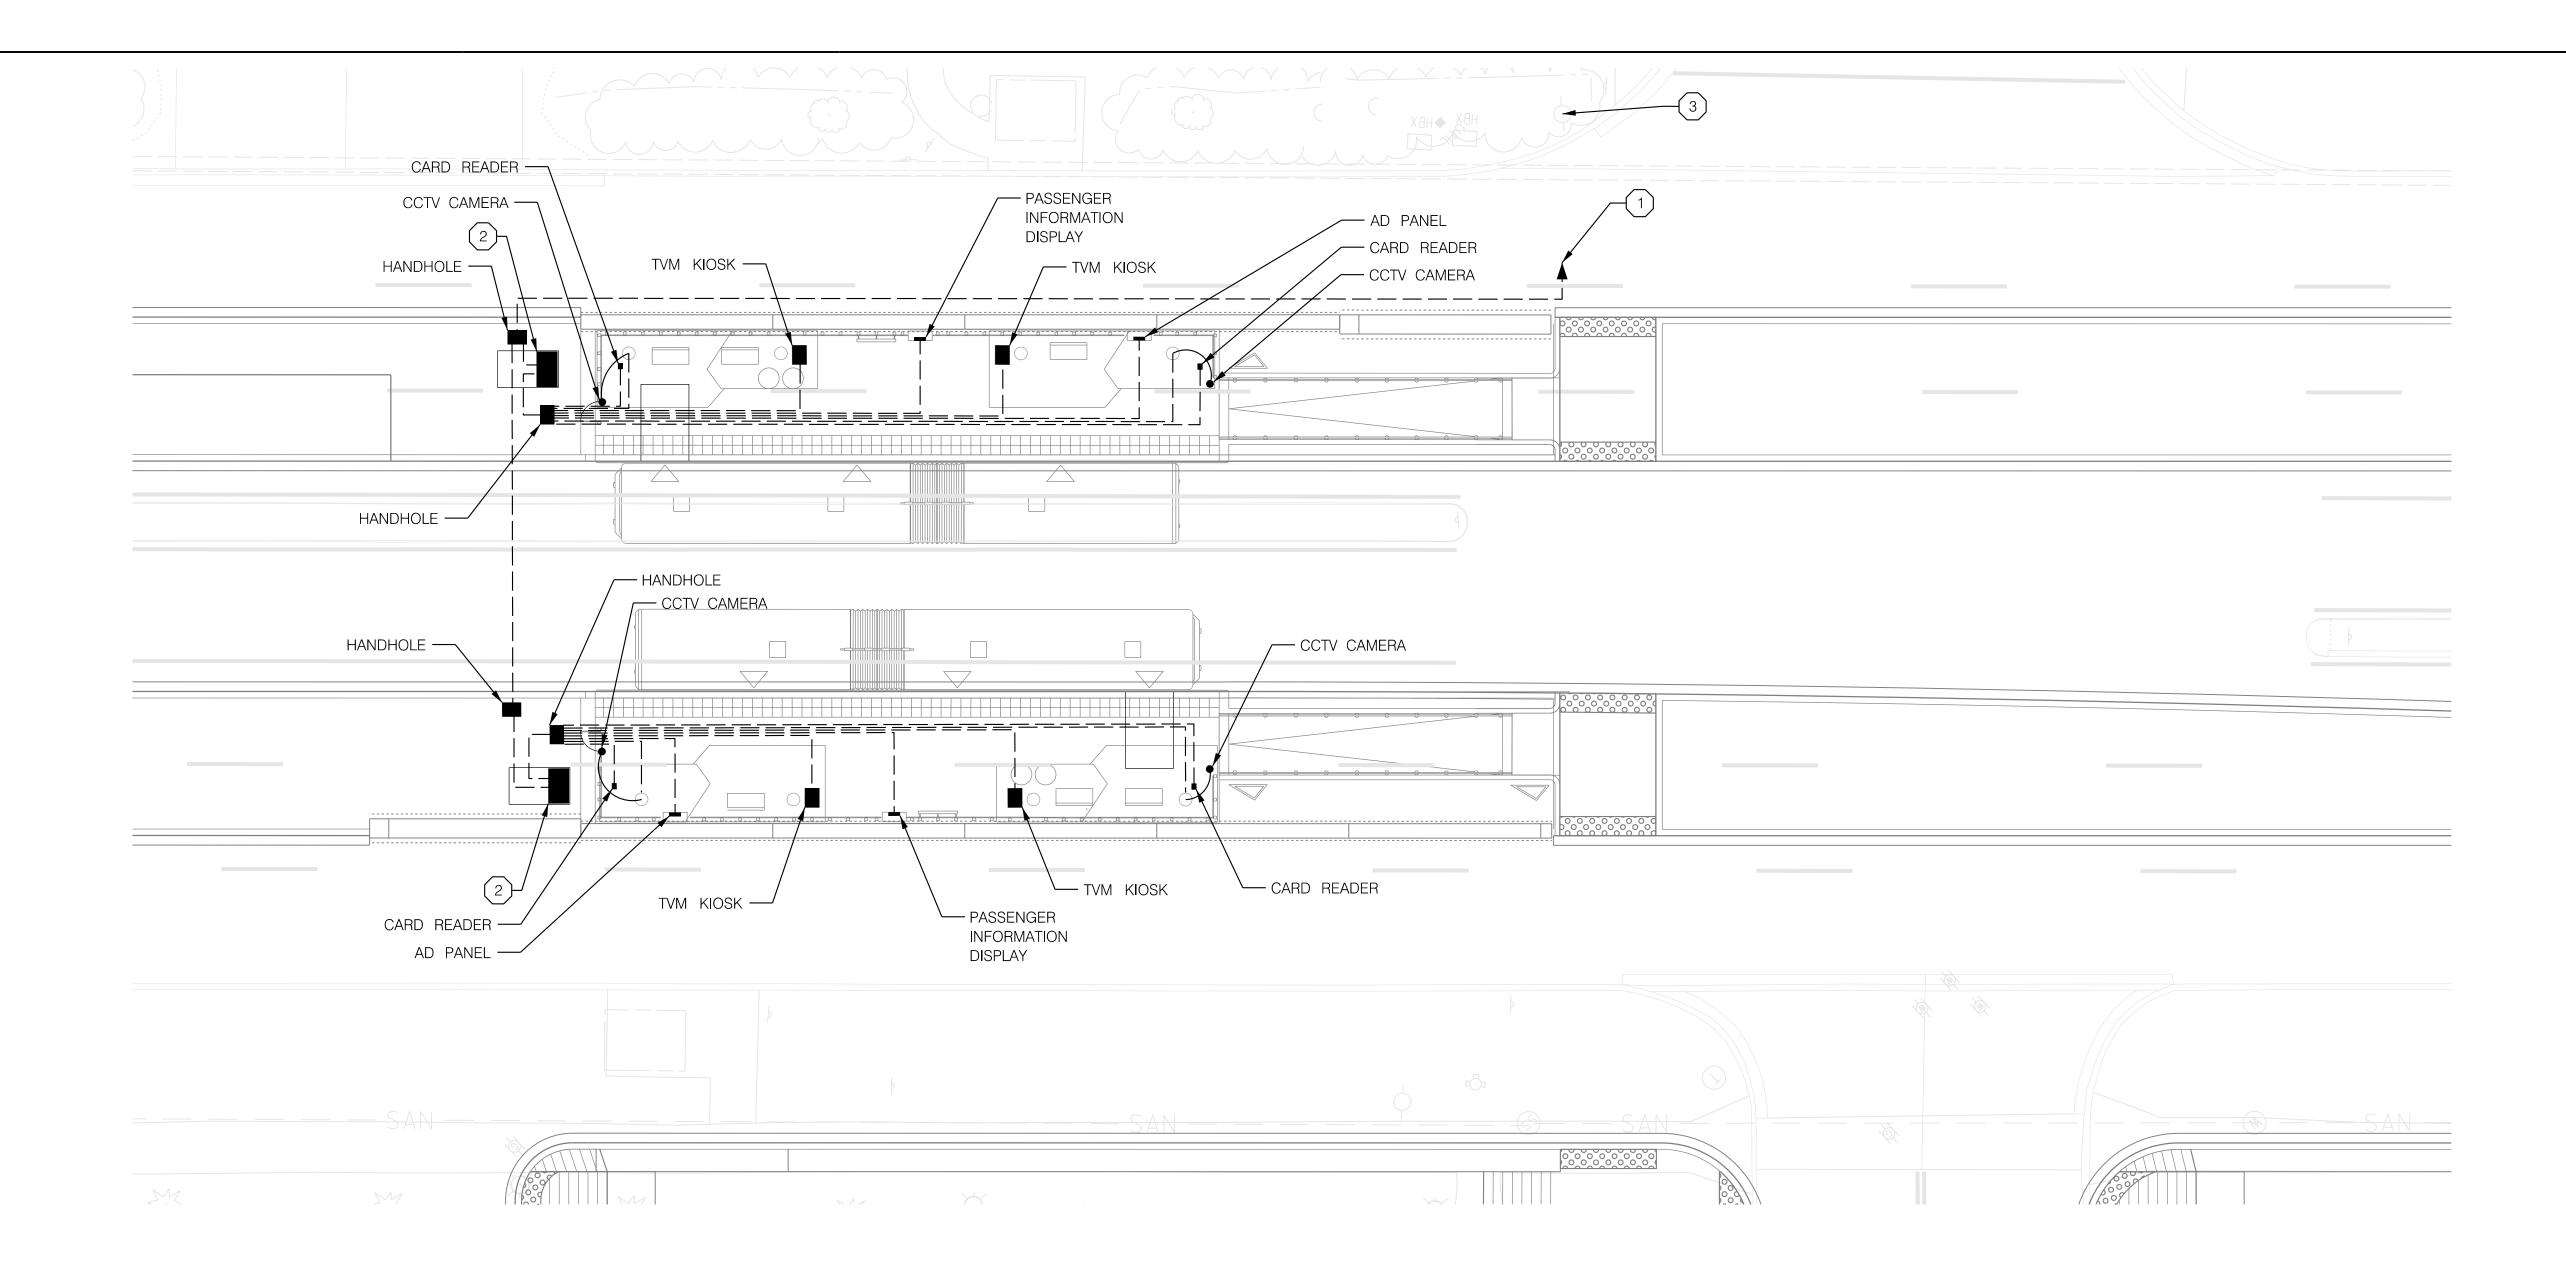
ITS STATION EDMONSTON DRIVE NB

SCALE : 1" = 10'DATE: DECEMBER 2022 SHEET <u>864</u> of <u>887</u> Project No. : 502005

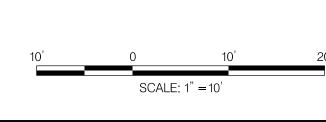

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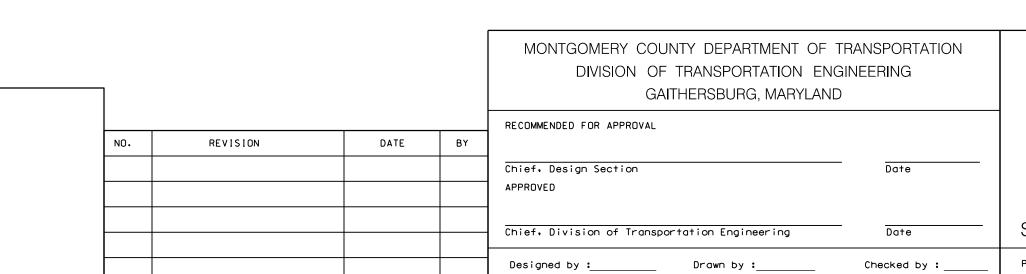


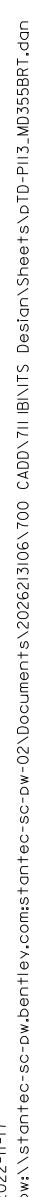

- 1) INSTALL CONDUIT FOR CONNECTION TO COUNTY FIBER. EXACT LOCATION OF COUNTY FIBER CONNECTION POINT TO BE DETERMINED.
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GENERAL NOTES:

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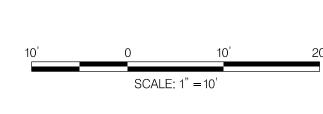


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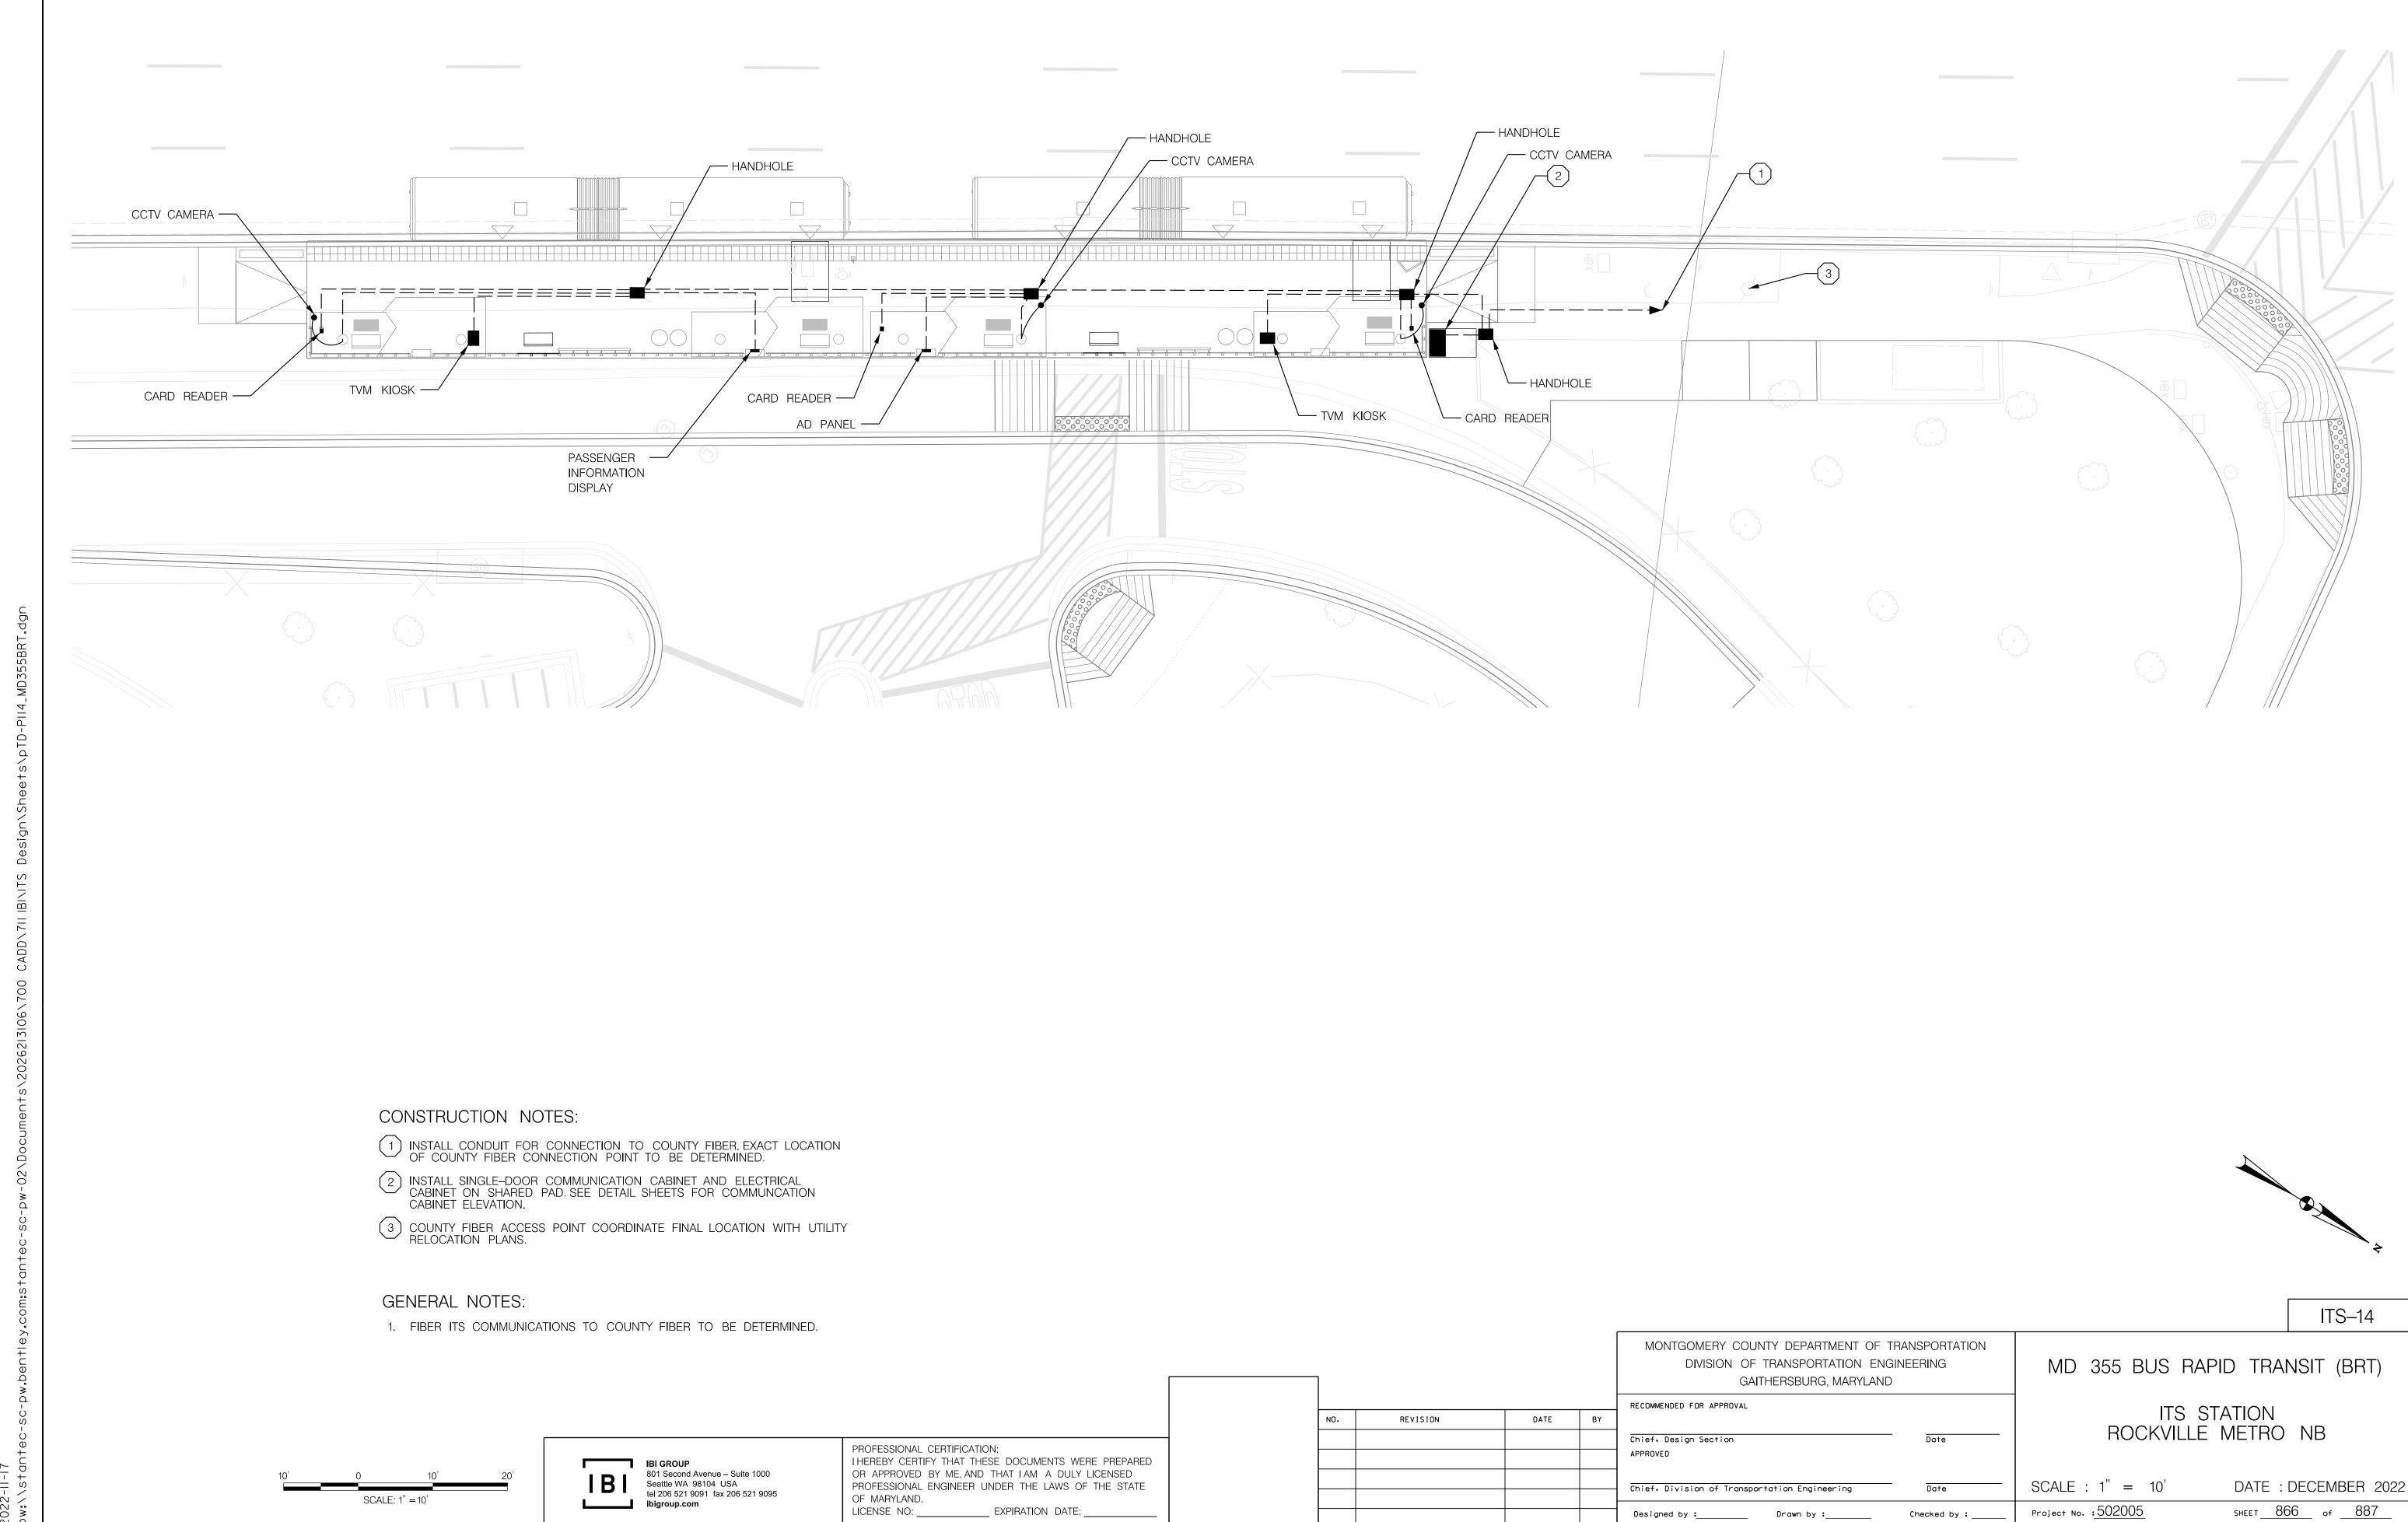
MD 355 BUS RAPID TRANSIT (BRT)


ITS STATION MOUNT VERNON PLACE

DATE: DECEMBER 2022 SCALE : 1" = 10'SHEET <u>865</u> of <u>88</u>7 Project No. :502005



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GENERAL NOTES:

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MONTGOMERY COUNTY DEPARTMENT OF TRANSPORTATION
DIVISION OF TRANSPORTATION ENGINEERING
GAITHERSBURG, MARYLAND

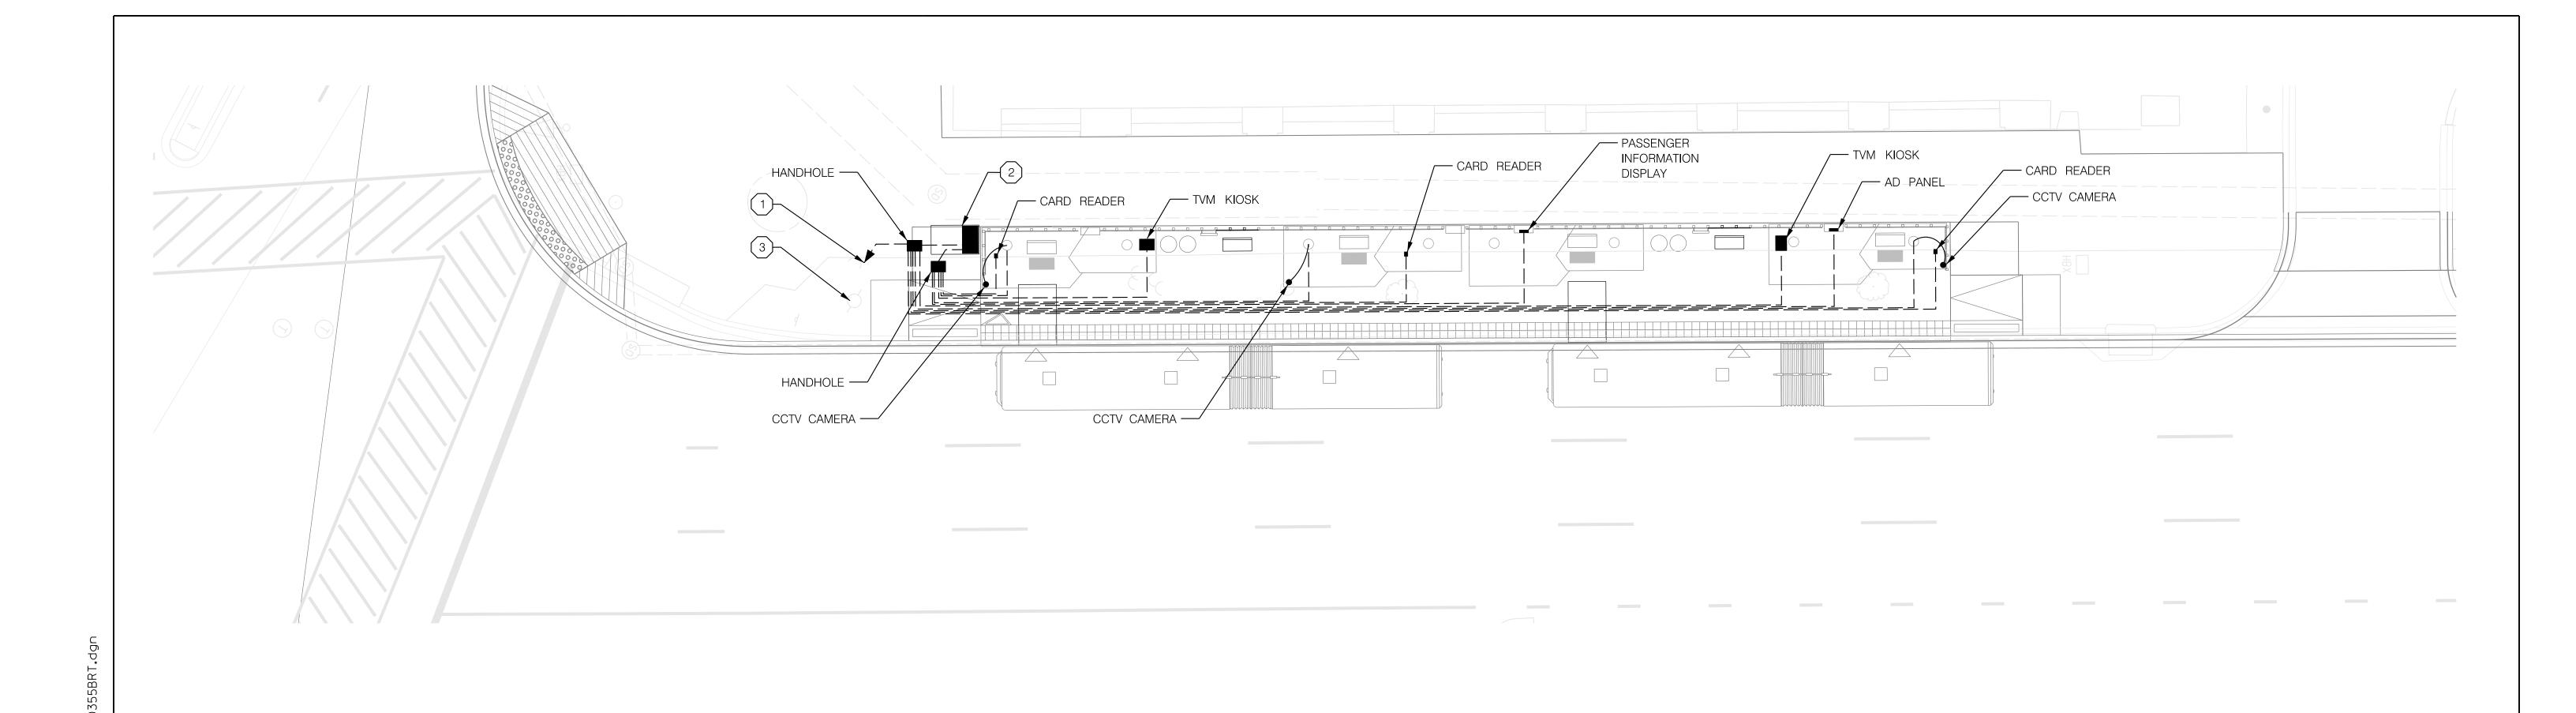RECOMMENDED FOR APPROVAL

Chief, Design Section
APPROVED

Chief, Division of Transportation Engineering

Date

Solution Section
Date

Checked by : _

Designed by :_____ Drawn by :____

REVISION

MD 355 BUS RAPID TRANSIT (BRT)

ITS-15


ITS STATION ROCKVILLE METRO SB


SCALE : 1" = 10' DATE : DECEMBER 2022


Project No. : 502005 SHEET 867 of 887

10' 0 10' 20' SCALE: 1" = 10'

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- 1) INSTALL CONDUIT FOR CONNECTION TO COUNTY FIBER. EXACT LOCATION OF COUNTY FIBER CONNECTION POINT TO BE DETERMINED.
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MONTGOMERY COUNTY DEPARTMENT OF TRANSPORTATION
DIVISION OF TRANSPORTATION ENGINEERING
GAITHERSBURG, MARYLAND

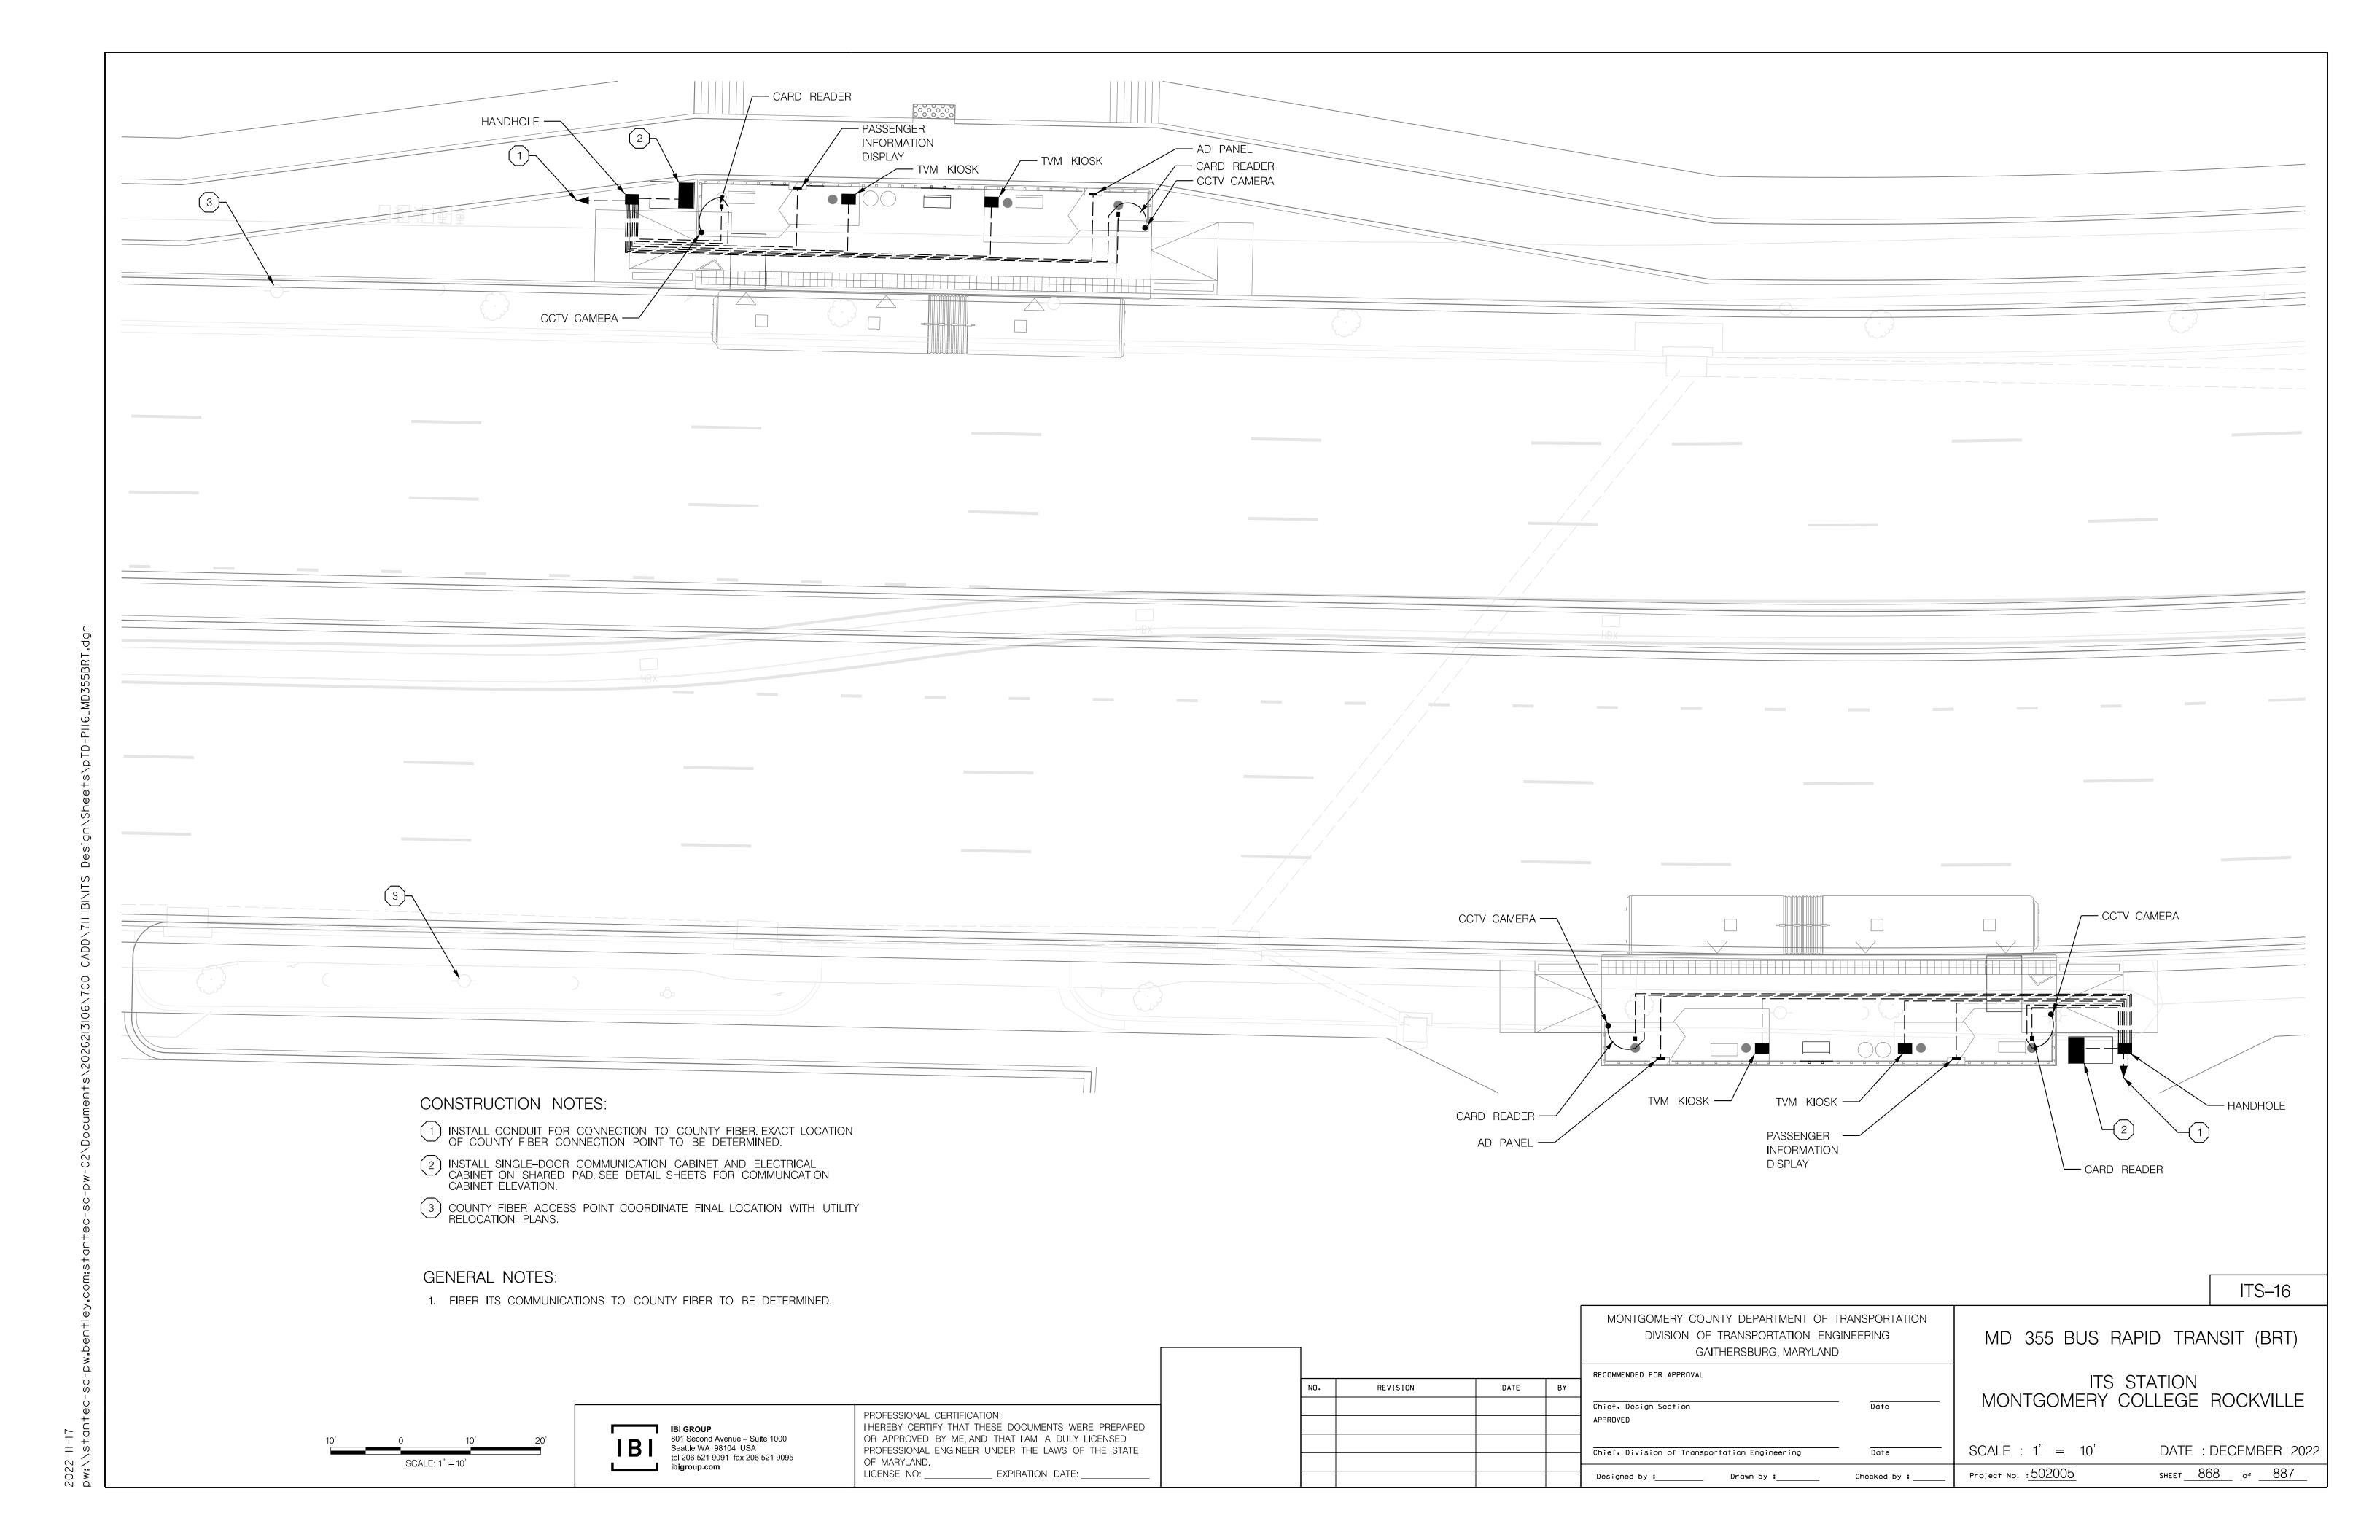RECOMMENDED FOR APPROVAL

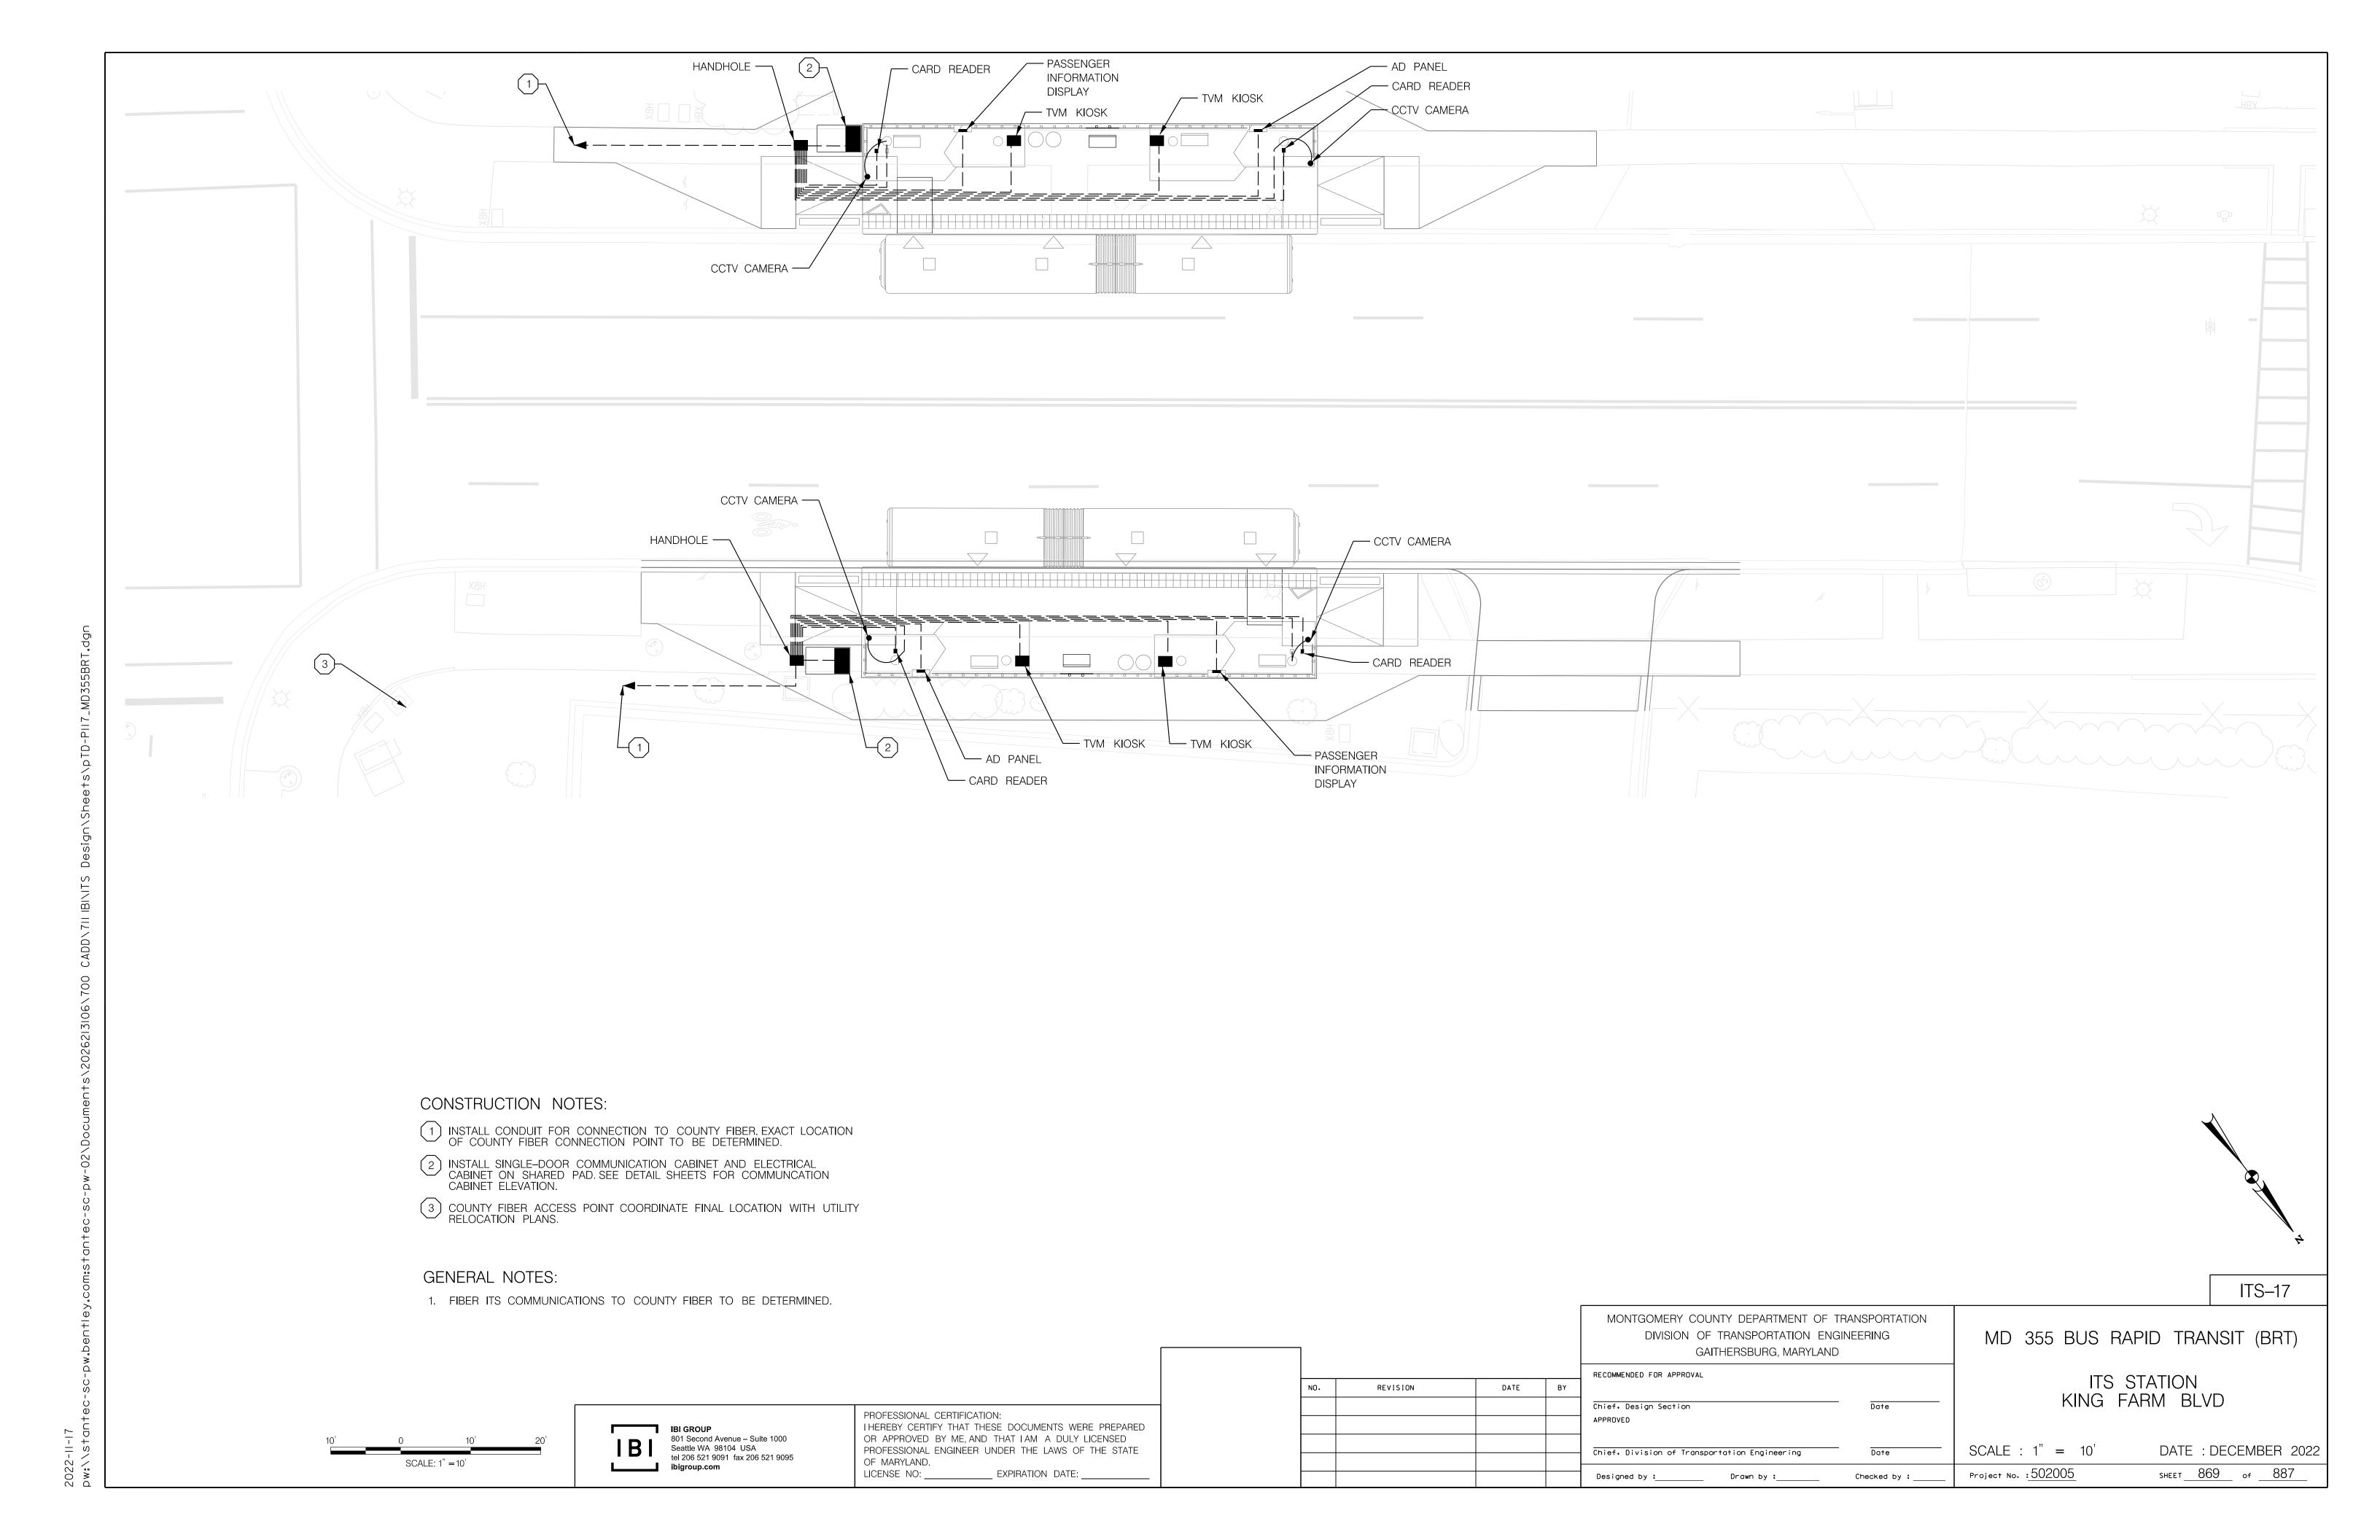Chief. Design Section
APPROVED

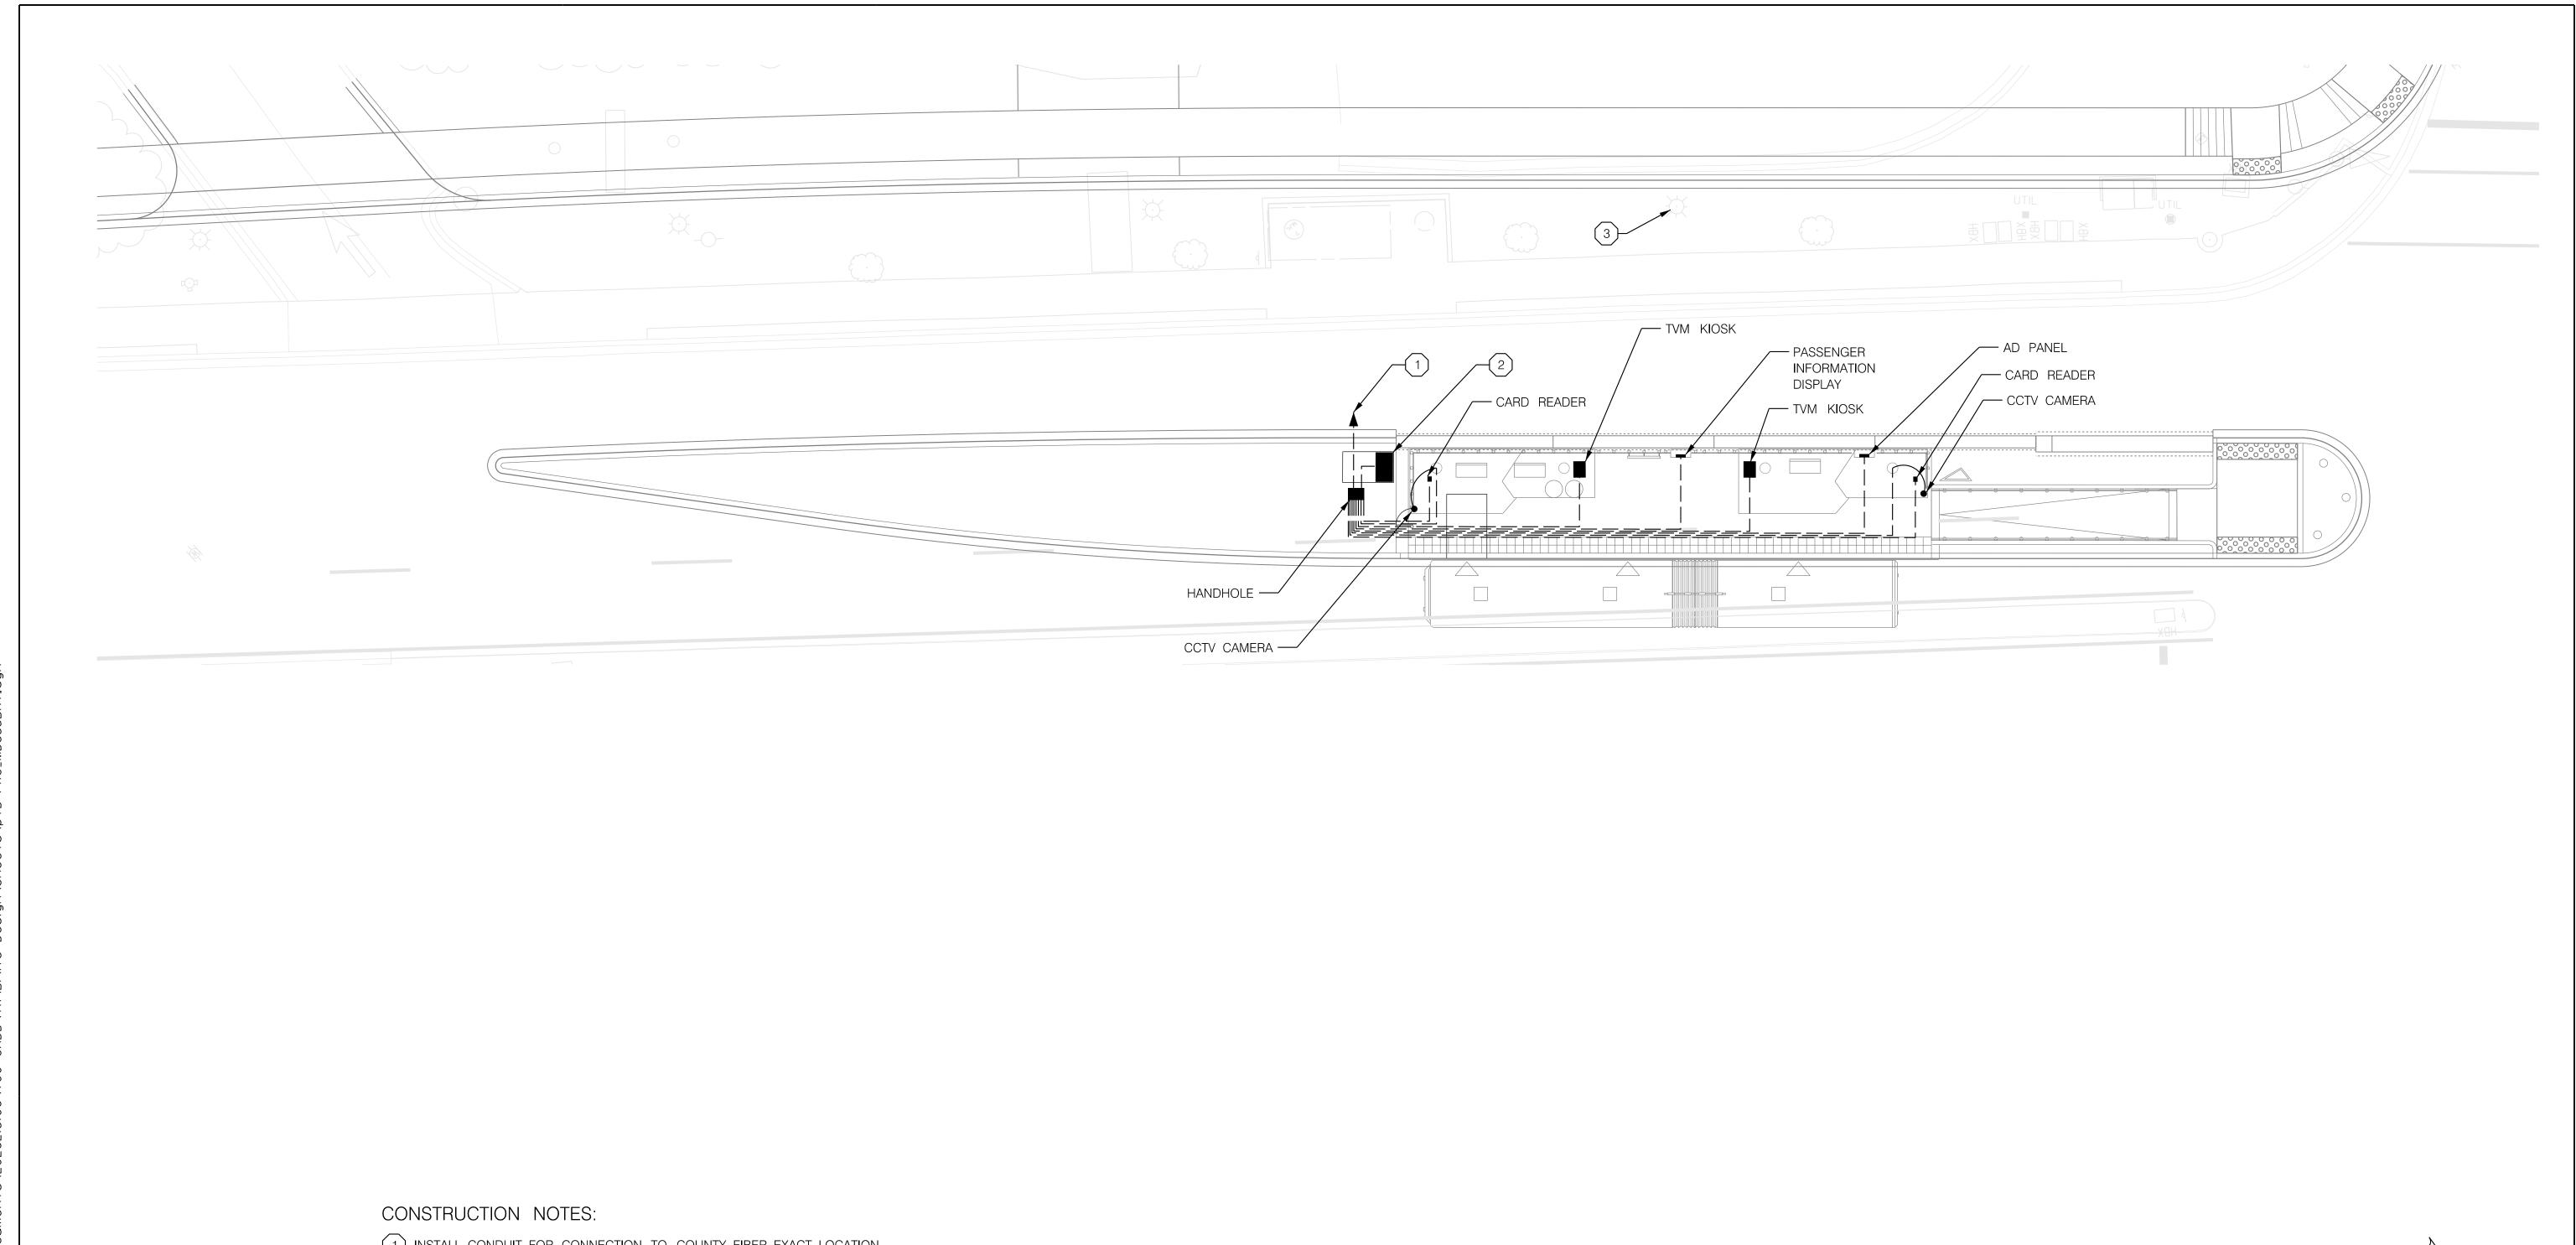Chief. Division of Transportation Engineering

Date

Designed by :______ Checked by :______


MD 355 BUS RAPID TRANSIT (BRT)

ITS-18


ITS STATION SOUTH WESTLAND DRIVE SB

SCALE : 1" = 10' DATE : DECEMBER 2022

Project No. : 502005 SHEET 870 of 887

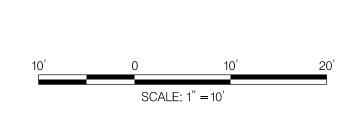

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GENERAL NOTES:

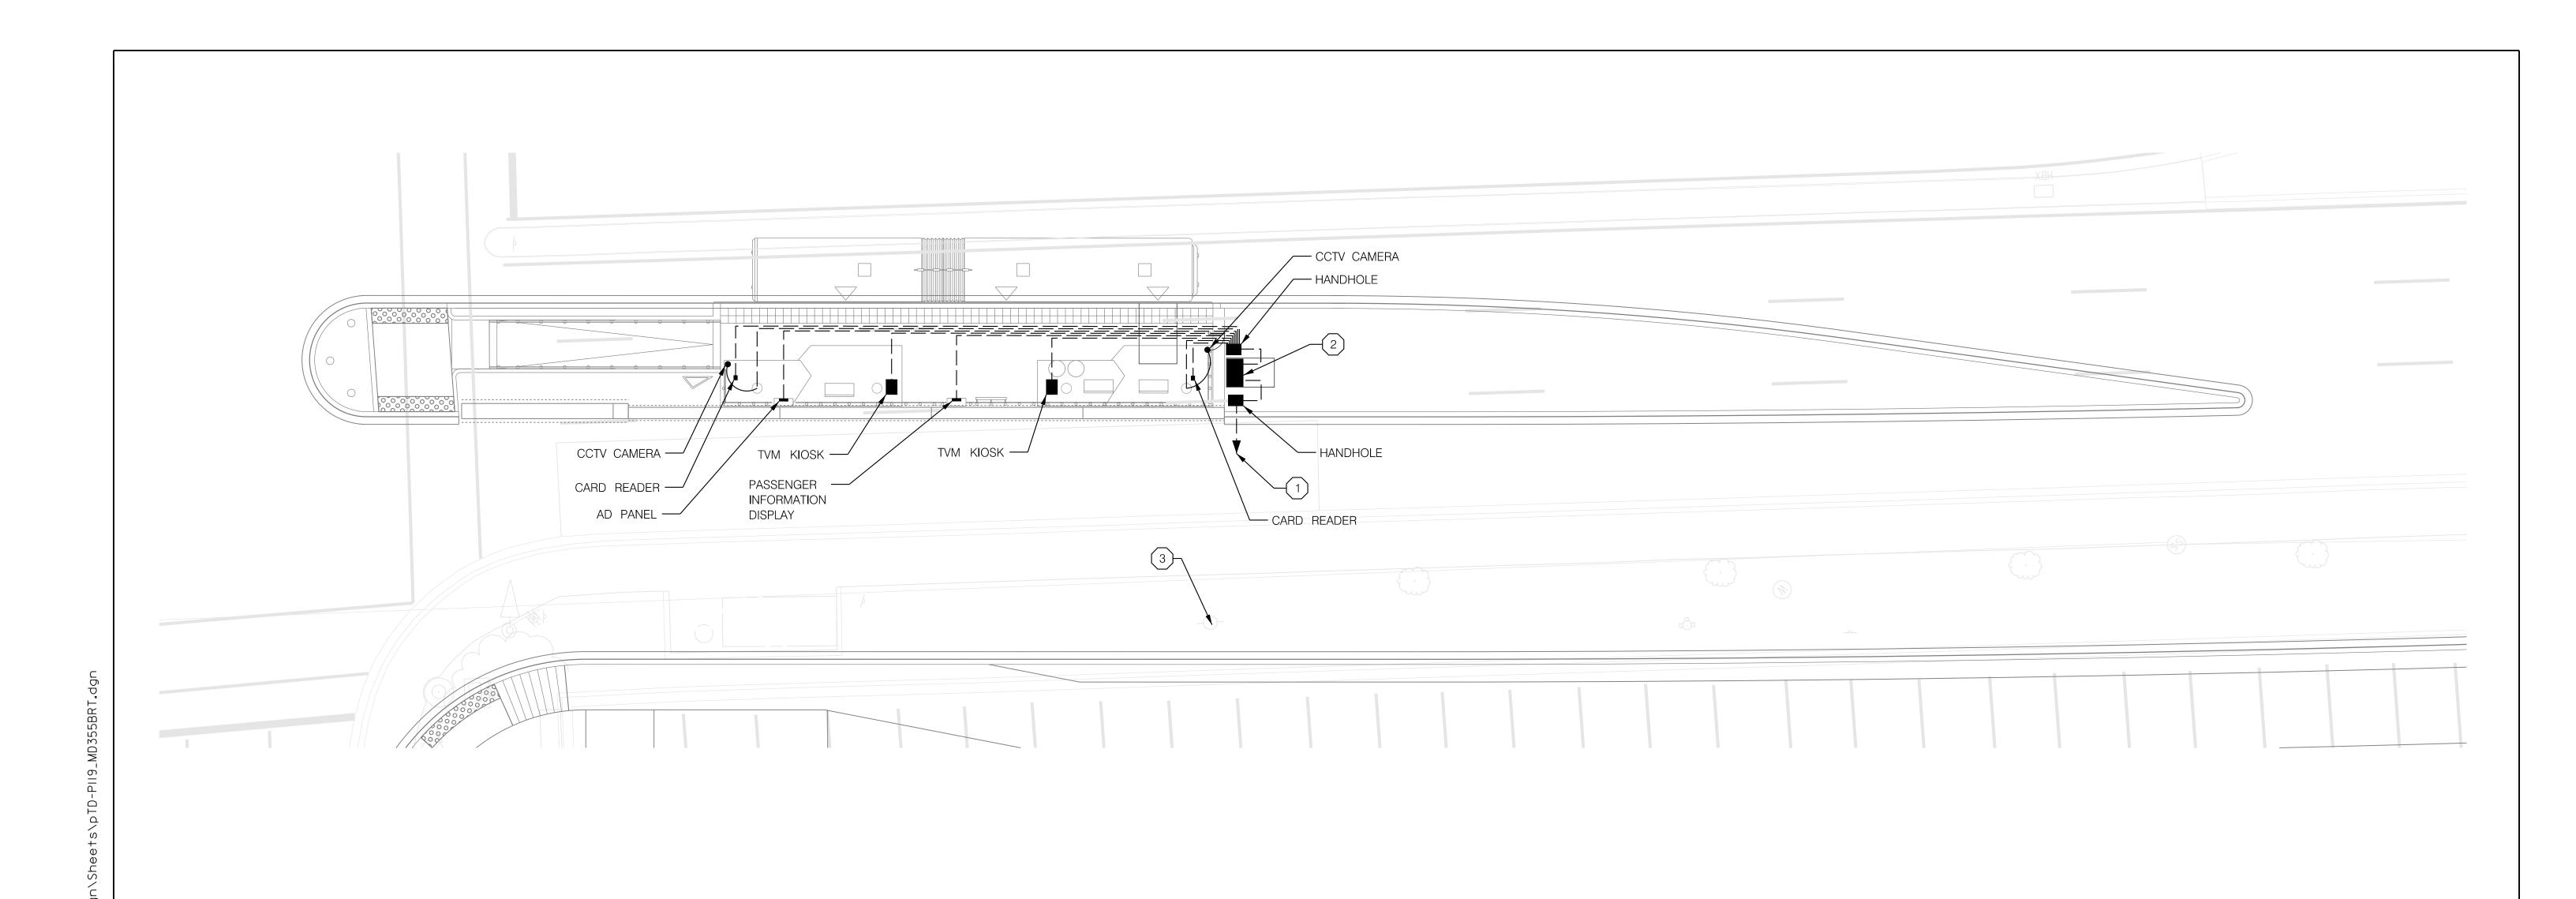1. FIBER ITS COMMUNICATIONS TO COUNTY FIBER TO BE DETERMINED.

MONTGOMERY COUNTY DEPARTMENT OF TRANSPORTATION DIVISION OF TRANSPORTATION ENGINEERING GAITHERSBURG, MARYLAND RECOMMENDED FOR APPROVAL DATE BY REVISION Chief. Design Section APPROVED Chief, Division of Transportation Engineering

Designed by :_____ Drawn by :____


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MD 355 BUS RAPID TRANSIT (BRT)


ITS-19


ITS STATION SOUTH WESTLAND DRIVE NB


DATE: DECEMBER 2022 SCALE : 1" = 10"SHEET 871 of 887 Project No. : 502005

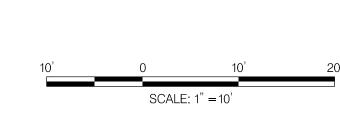

801 Second Avenue – Suite 1000 Seattle WA 98104 USA tel 206 521 9091 fax 206 521 9095

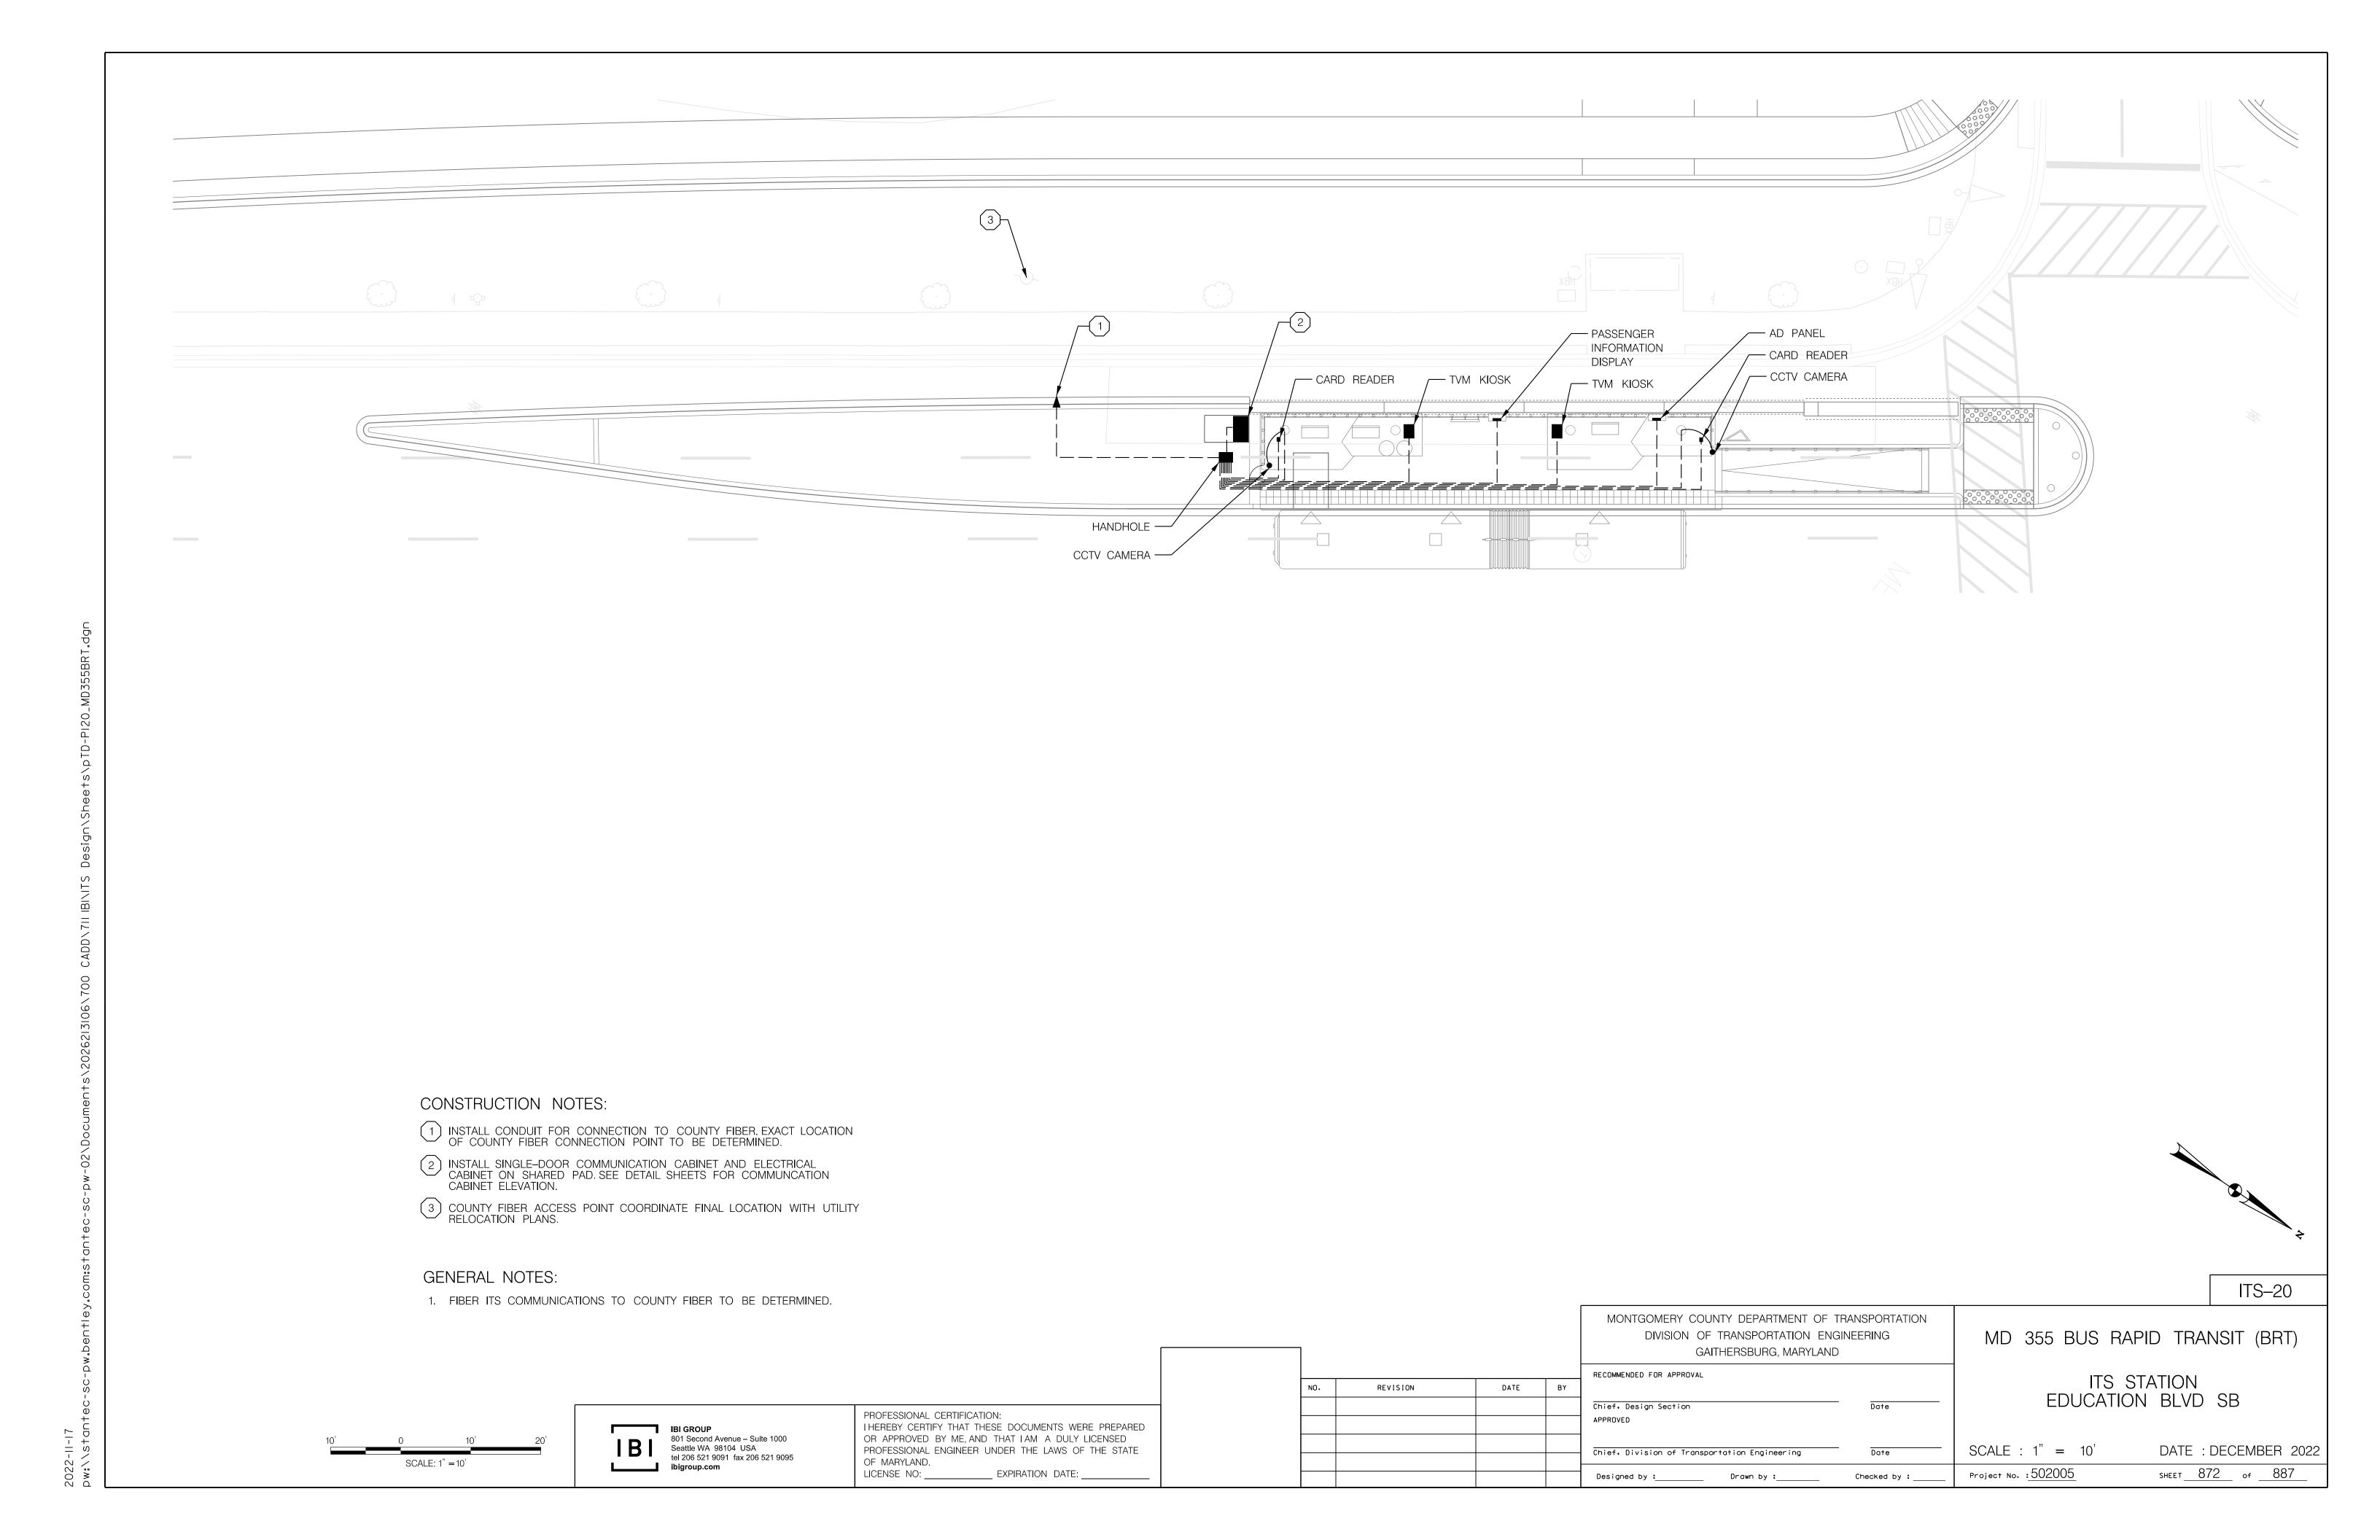

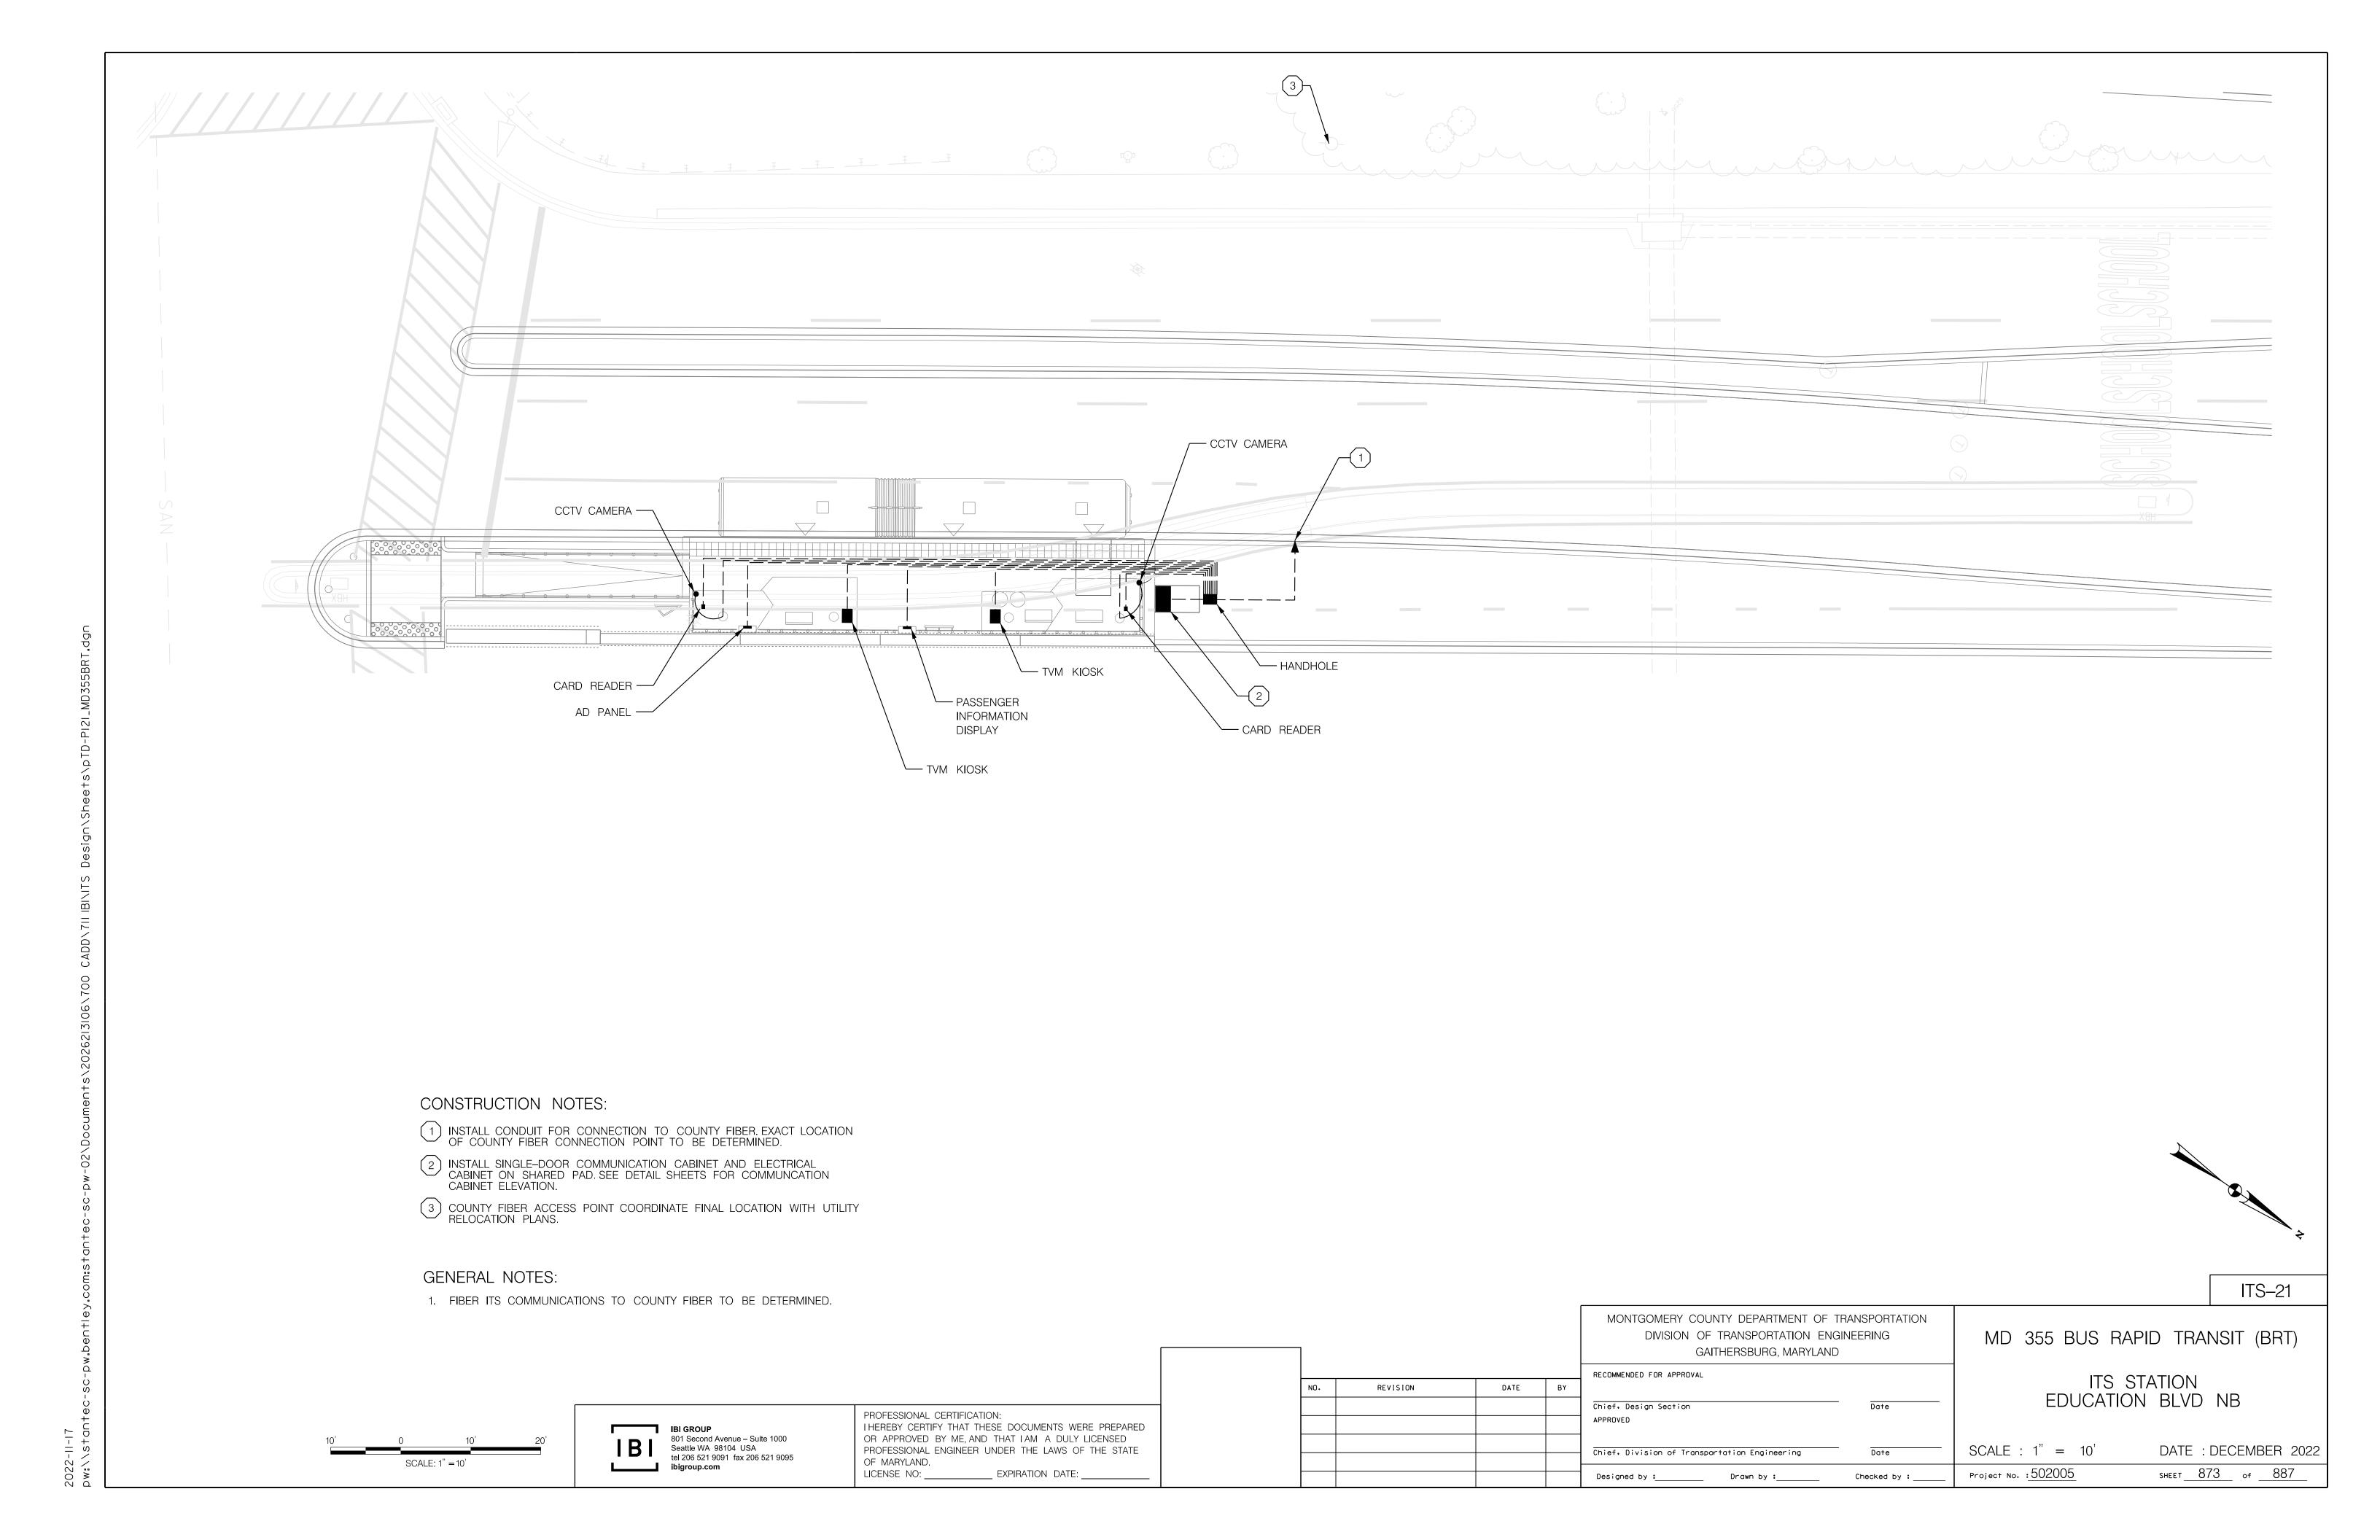

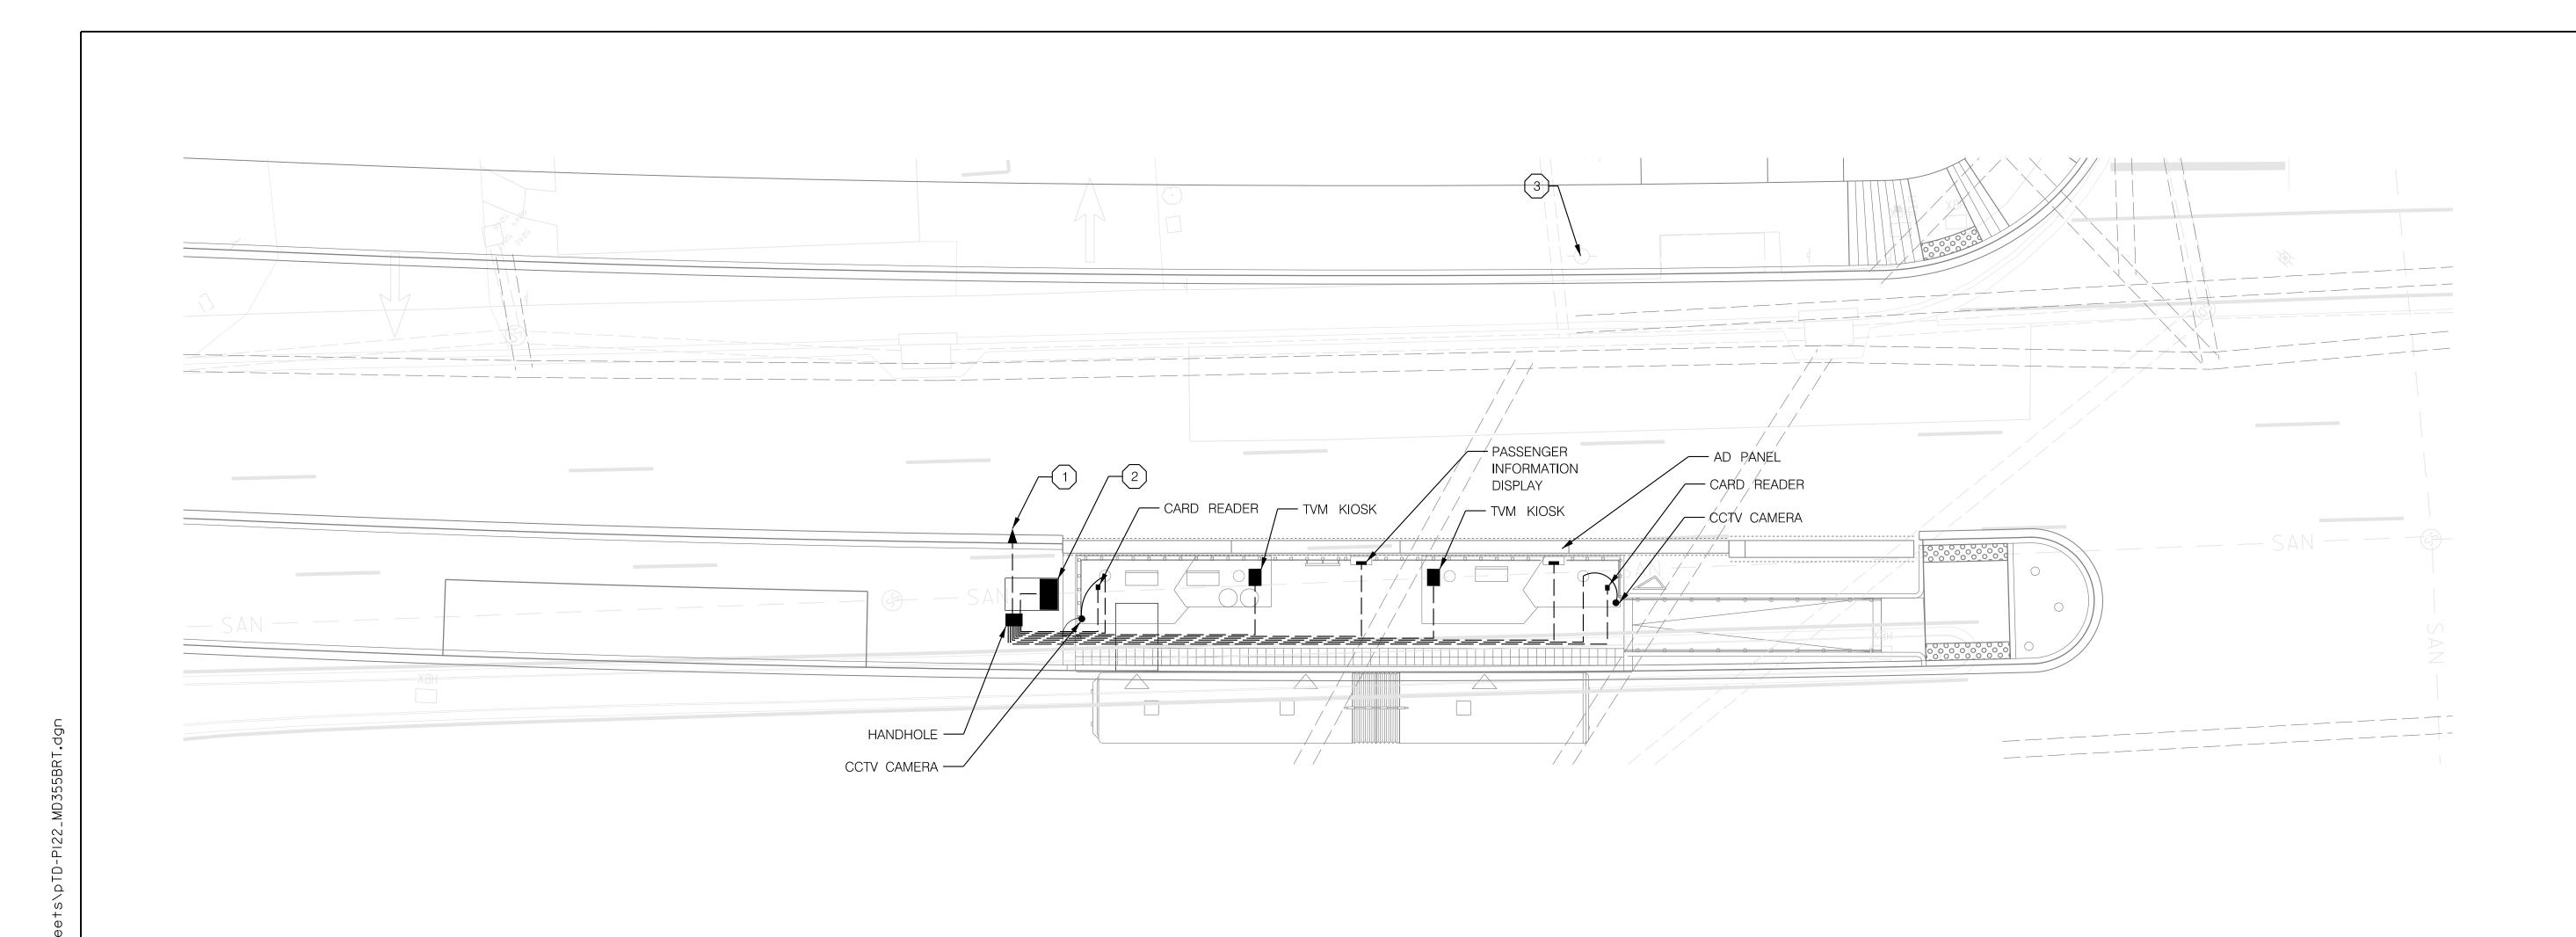

- 1) INSTALL CONDUIT FOR CONNECTION TO COUNTY FIBER. EXACT LOCATION OF COUNTY FIBER CONNECTION POINT TO BE DETERMINED.
- 2 INSTALL SINGLE-DOOR COMMUNICATION CABINET AND ELECTRICAL CABINET ON SHARED PAD. SEE DETAIL SHEETS FOR COMMUNCATION CABINET ELEVATION.
- 3 COUNTY FIBER ACCESS POINT COORDINATE FINAL LOCATION WITH UTILITY RELOCATION PLANS.

GENERAL NOTES:

1. FIBER ITS COMMUNICATIONS TO COUNTY FIBER TO BE DETERMINED.

ITS-22

MD	355	BUS	RAPID	TRANSIT	(BRT)
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PROFESSIONAL CERTIFICATION: I HEREBY CERTIFY THAT THESE DOCUMENTS WERE PREPARED 801 Second Avenue – Suite 1000 Seattle WA 98104 USA tel 206 521 9091 fax 206 521 9095 OR APPROVED BY ME, AND THAT I AM A DULY LICENSED PROFESSIONAL ENGINEER UNDER THE LAWS OF THE STATE OF MARYLAND. LICENSE NO: _____ EXPIRATION DATE: _

ITS STATION ODENHAL AVENUE SB

DATE: DECEMBER 2022 SCALE : 1" = 10'SHEET 874 of 887 Project No. : 502005

SCALE: 1" = 10'

Checked by : _

MONTGOMERY COUNTY DEPARTMENT OF TRANSPORTATION

DIVISION OF TRANSPORTATION ENGINEERING GAITHERSBURG, MARYLAND

RECOMMENDED FOR APPROVAL

Chief. Design Section


Chief, Division of Transportation Engineering


Designed by :_____ Drawn by :____


APPROVED

DATE BY

REVISION

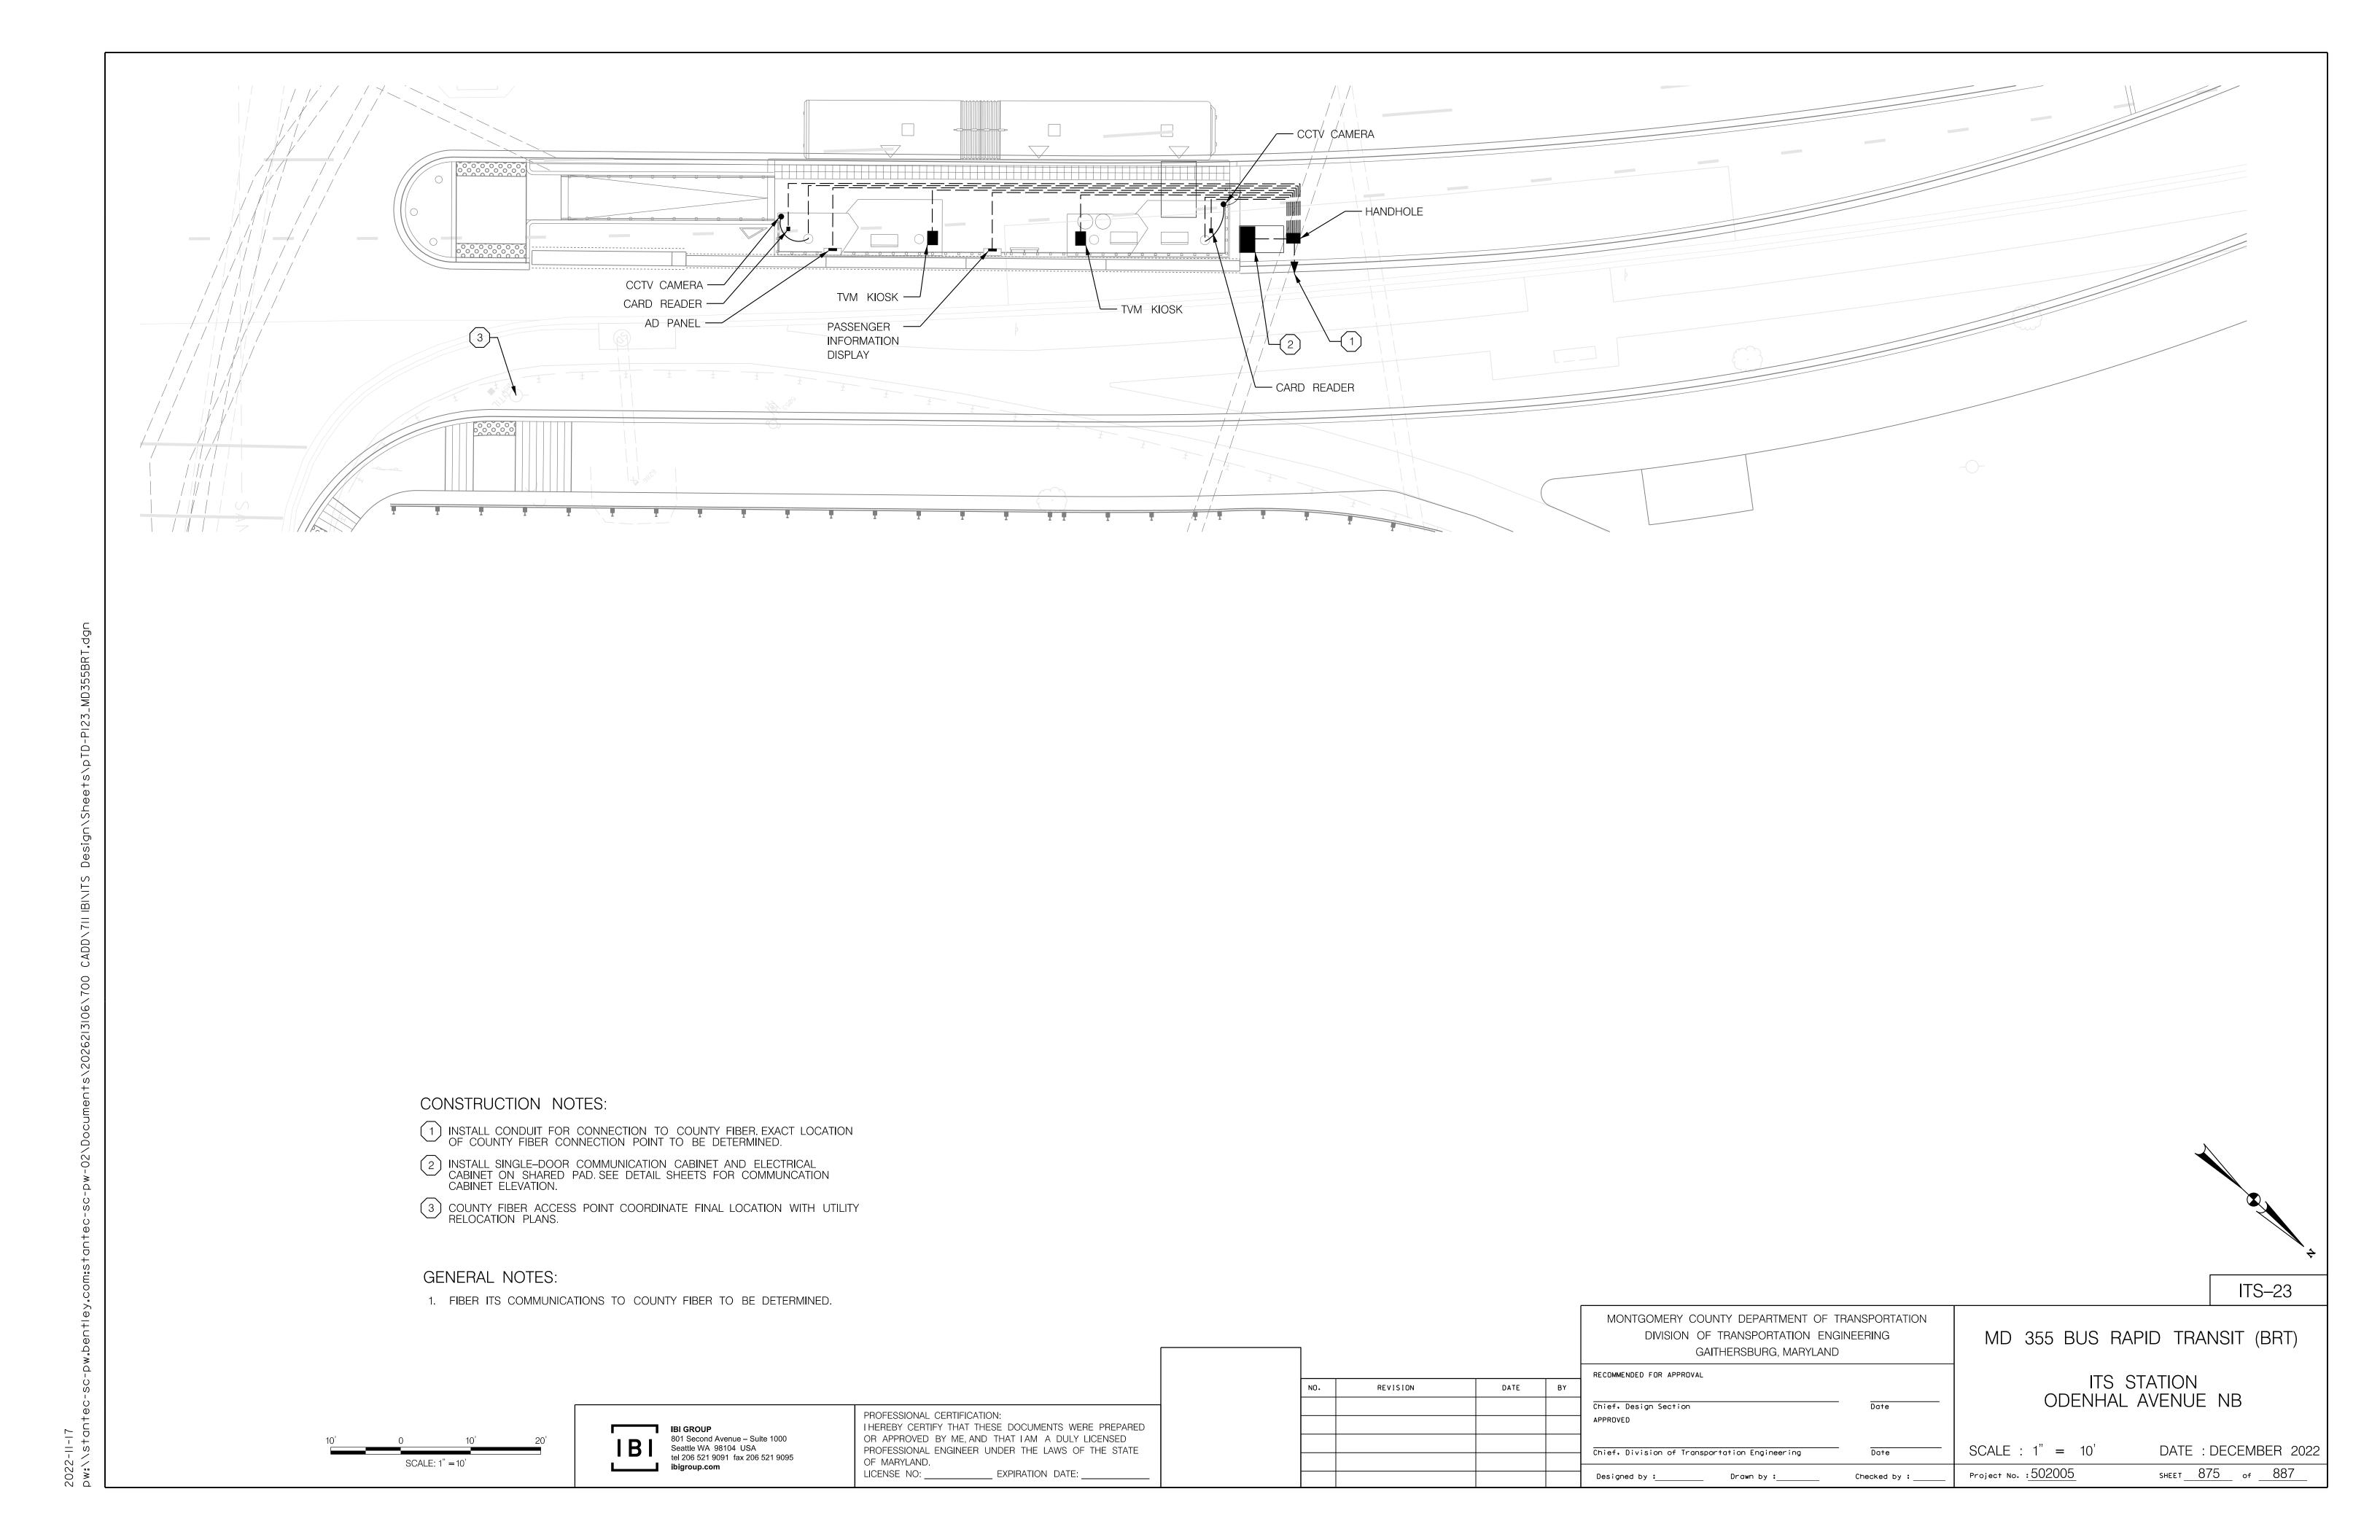

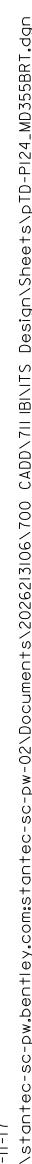


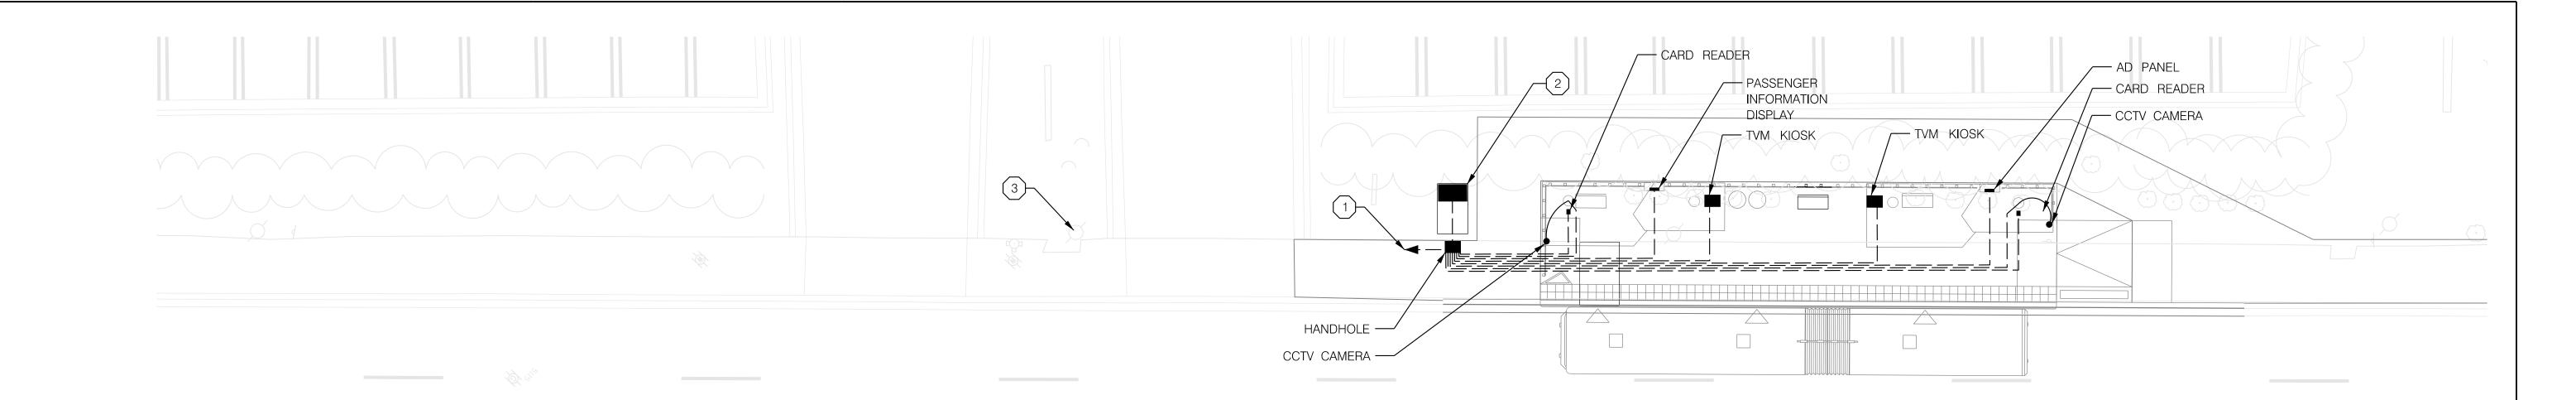

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- 2 INSTALL SINGLE-DOOR COMMUNICATION CABINET AND ELECTRICAL CABINET ON SHARED PAD. SEE DETAIL SHEETS FOR COMMUNCATION CABINET ELEVATION.
- 3 COUNTY FIBER ACCESS POINT COORDINATE FINAL LOCATION WITH UTILITY RELOCATION PLANS.

GENERAL NOTES:

1. FIBER ITS COMMUNICATIONS TO COUNTY FIBER TO BE DETERMINED.

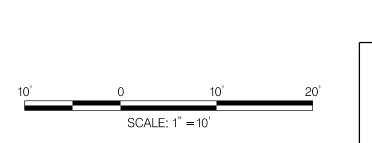

801 Second Avenue - Suite 1000 Seattle WA 98104 USA tel 206 521 9091 fax 206 521 9095

PROFESSIONAL CERTIFICATION: OR APPROVED BY ME, AND THAT I AM A DULY LICENSED PROFESSIONAL ENGINEER UNDER THE LAWS OF THE STATE OF MARYLAND. LICENSE NO:

				MONTGOMERY COUNTY DEPARTMENT OF	TRANSPORTATION	
				DIVISION OF TRANSPORTATION ENGINEERING GAITHERSBURG, MARYLAND		
]						
	ı	<u>T</u>		RECOMMENDED FOR APPROVAL		
NO.	REVISION	DATE	BY			l ,
				Chief, Design Section	Date	L
				APPROVED		
				Chief, Division of Transportation Engineering	Date	SC
				Designed by : Drawn by :	Checked by :	Proj


MD 355 BUS RAPID TRANSIT (BRT)

ITS STATION LAKEFOREST TRANSIT CENTER - SB

DATE: DECEMBER 2022 SCALE : 1" = 10"SHEET <u>876</u> of <u>887</u> Project No. :<u>502005</u>

I HEREBY CERTIFY THAT THESE DOCUMENTS WERE PREPARED ___ EXPIRATION DATE:

ITS-24

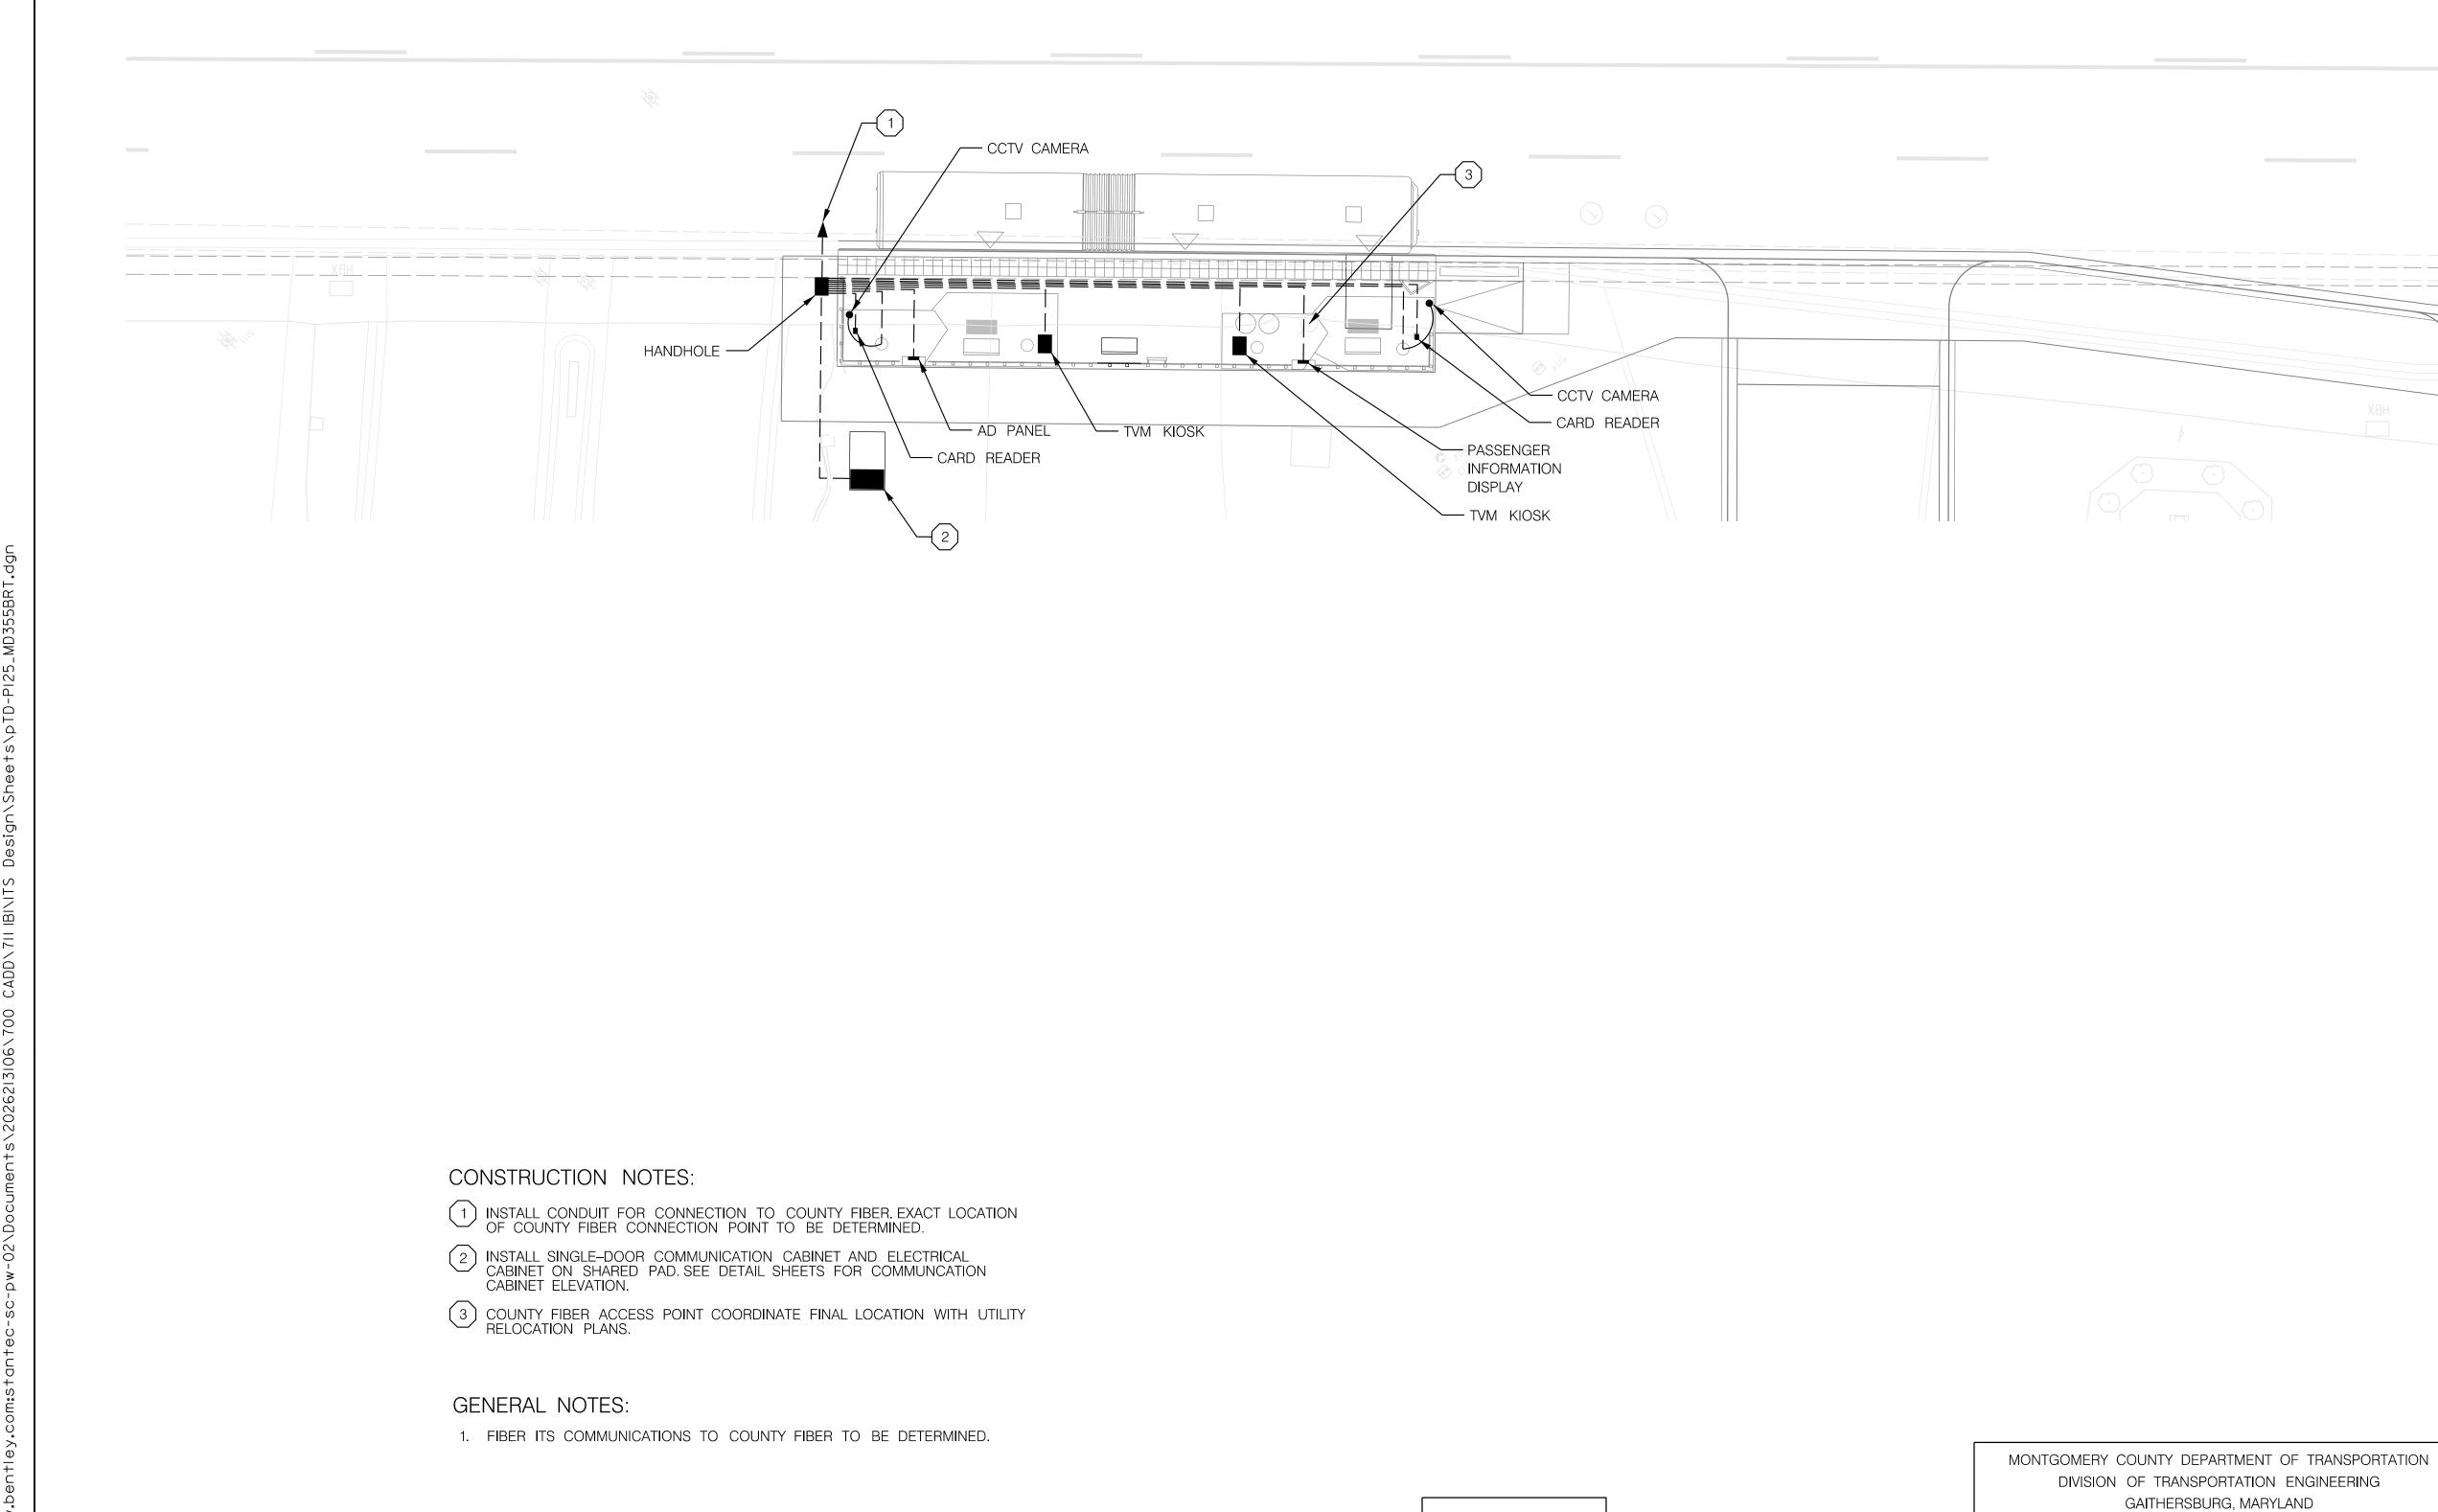

ITS-25

MD 355 BUS RAPID TRANSIT (BRT)

RECOMMENDED FOR APPROVAL

Chief. Design Section

Chief, Division of Transportation Engineering

Designed by :_____ Drawn by :____

Checked by : _

APPROVED

DATE BY


REVISION


ITS STATION LAKEFOREST TRANSIT CENTER – NB

DATE: DECEMBER 2022 SCALE : 1" = 10'SHEET 877 of 887 Project No. : 502005

SCALE: 1" = 10'

801 Second Avenue – Suite 1000 Seattle WA 98104 USA tel 206 521 9091 fax 206 521 9095

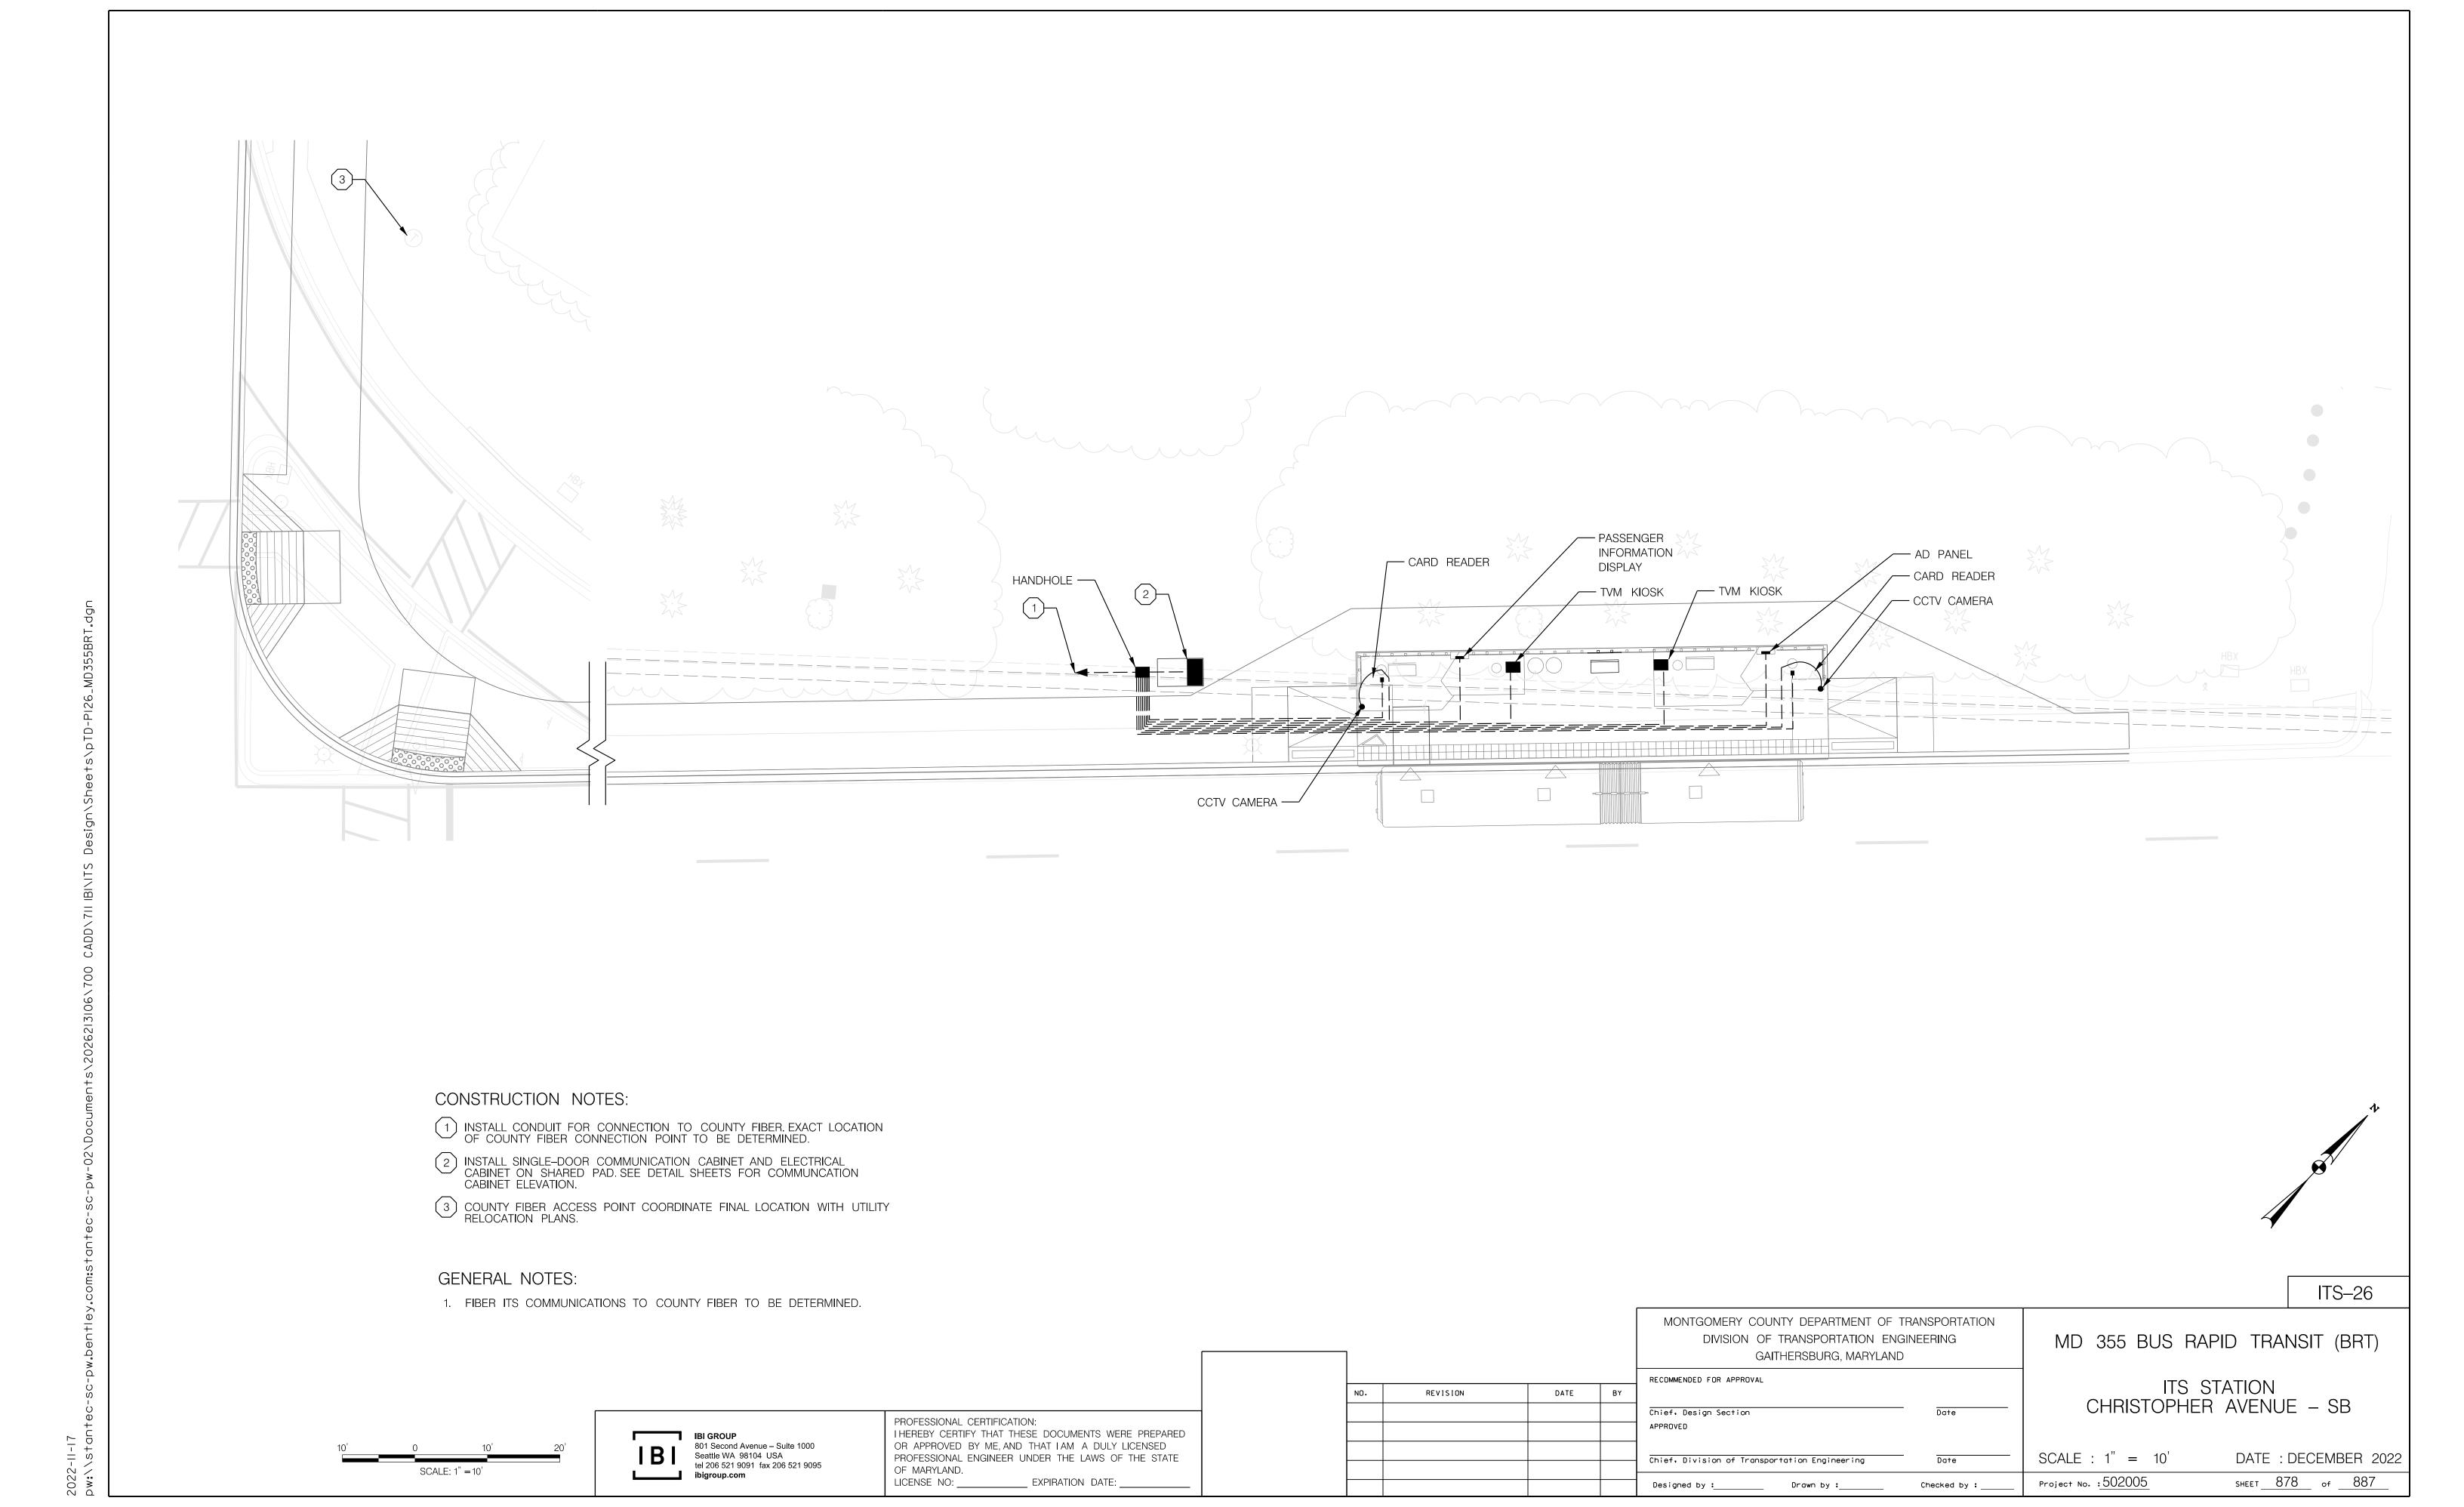

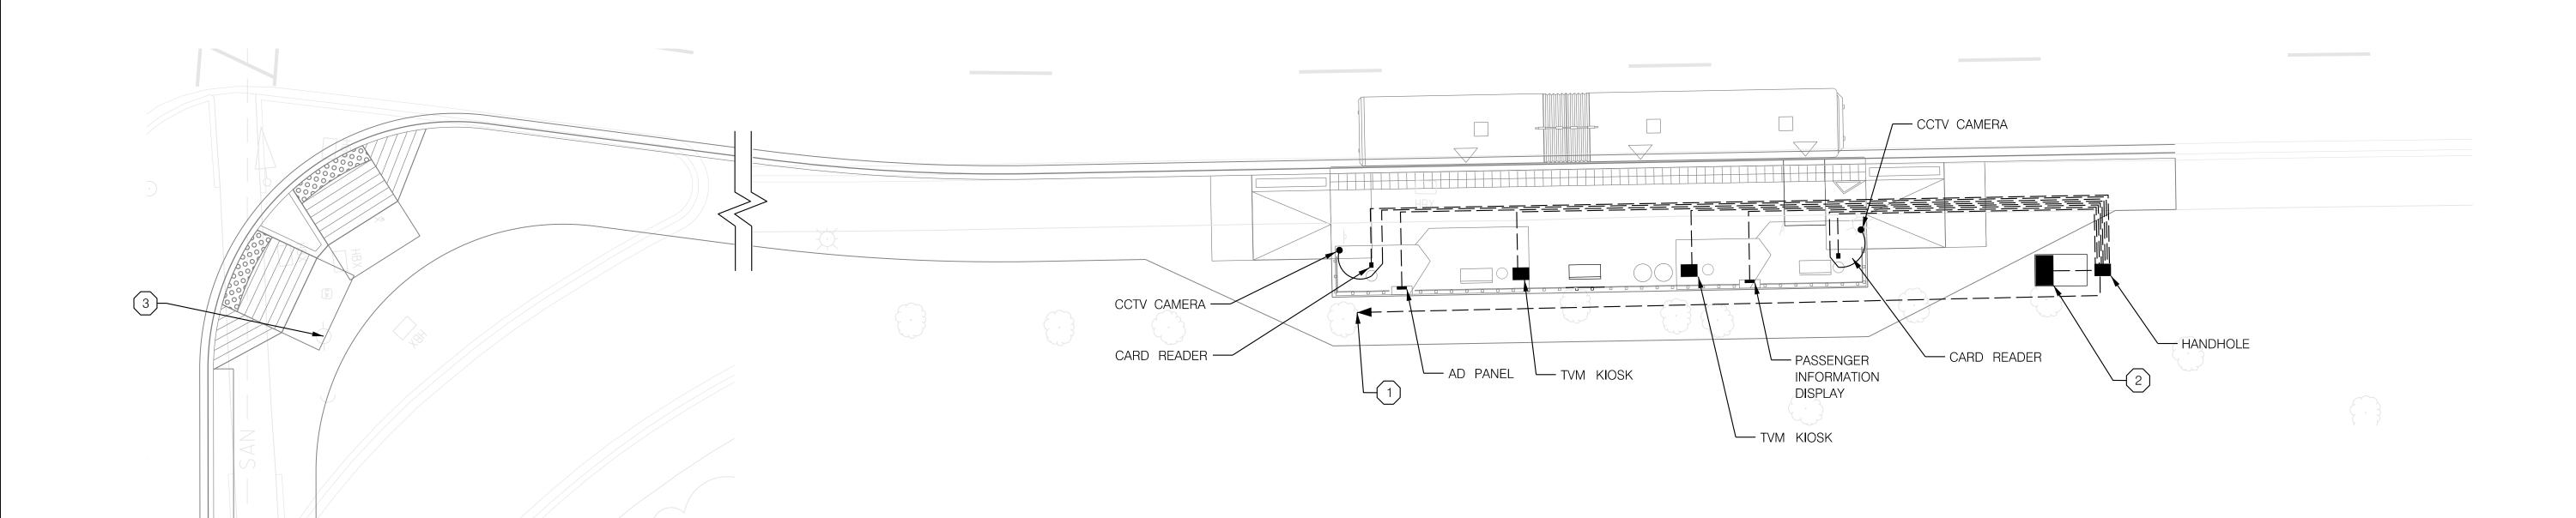


CONSTRUCTION NOTES:

- 1) INSTALL CONDUIT FOR CONNECTION TO COUNTY FIBER. EXACT LOCATION OF COUNTY FIBER CONNECTION POINT TO BE DETERMINED.
- 2 INSTALL SINGLE-DOOR COMMUNICATION CABINET AND ELECTRICAL CABINET ON SHARED PAD. SEE DETAIL SHEETS FOR COMMUNCATION CABINET ELEVATION.
- 3 COUNTY FIBER ACCESS POINT COORDINATE FINAL LOCATION WITH UTILITY RELOCATION PLANS.

GENERAL NOTES:

1. FIBER ITS COMMUNICATIONS TO COUNTY FIBER TO BE DETERMINED.

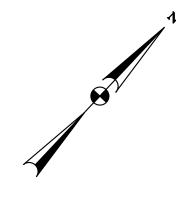

ITS-27

			MONTGOMERY COUNTY DEPARTMENT OF TRANSPORTATION DIVISION OF TRANSPORTATION ENGINEERING GAITHERSBURG, MARYLAND		N
REVISION	DATE	BY	RECOMMENDED FOR APPROVAL Chief, Design Section APPROVED	Date	
			Chief, Division of Transportation Engineering	Date	SCA


Designed by :_____ Drawn by :____

Checked by : ___

MD 355 BUS RAPID TRANSIT (BRT)


ITS STATION CHRISTOPHER AVENUE – NB


DATE: DECEMBER 2022 CALE : 1'' = 10'SHEET <u>879</u> of <u>887</u> Project No. : 502005

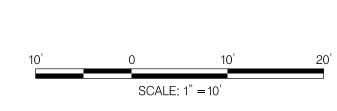



801 Second Avenue – Suite 1000 Seattle WA 98104 USA tel 206 521 9091 fax 206 521 9095

PROFESSIONAL CERTIFICATION:
I HEREBY CERTIFY THAT THESE DOCUMENTS WERE PREPARED OR APPROVED BY ME, AND THAT I AM A DULY LICENSED PROFESSIONAL ENGINEER UNDER THE LAWS OF THE STATE OF MARYLAND. LICENSE NO: _____ EXPIRATION DATE: _

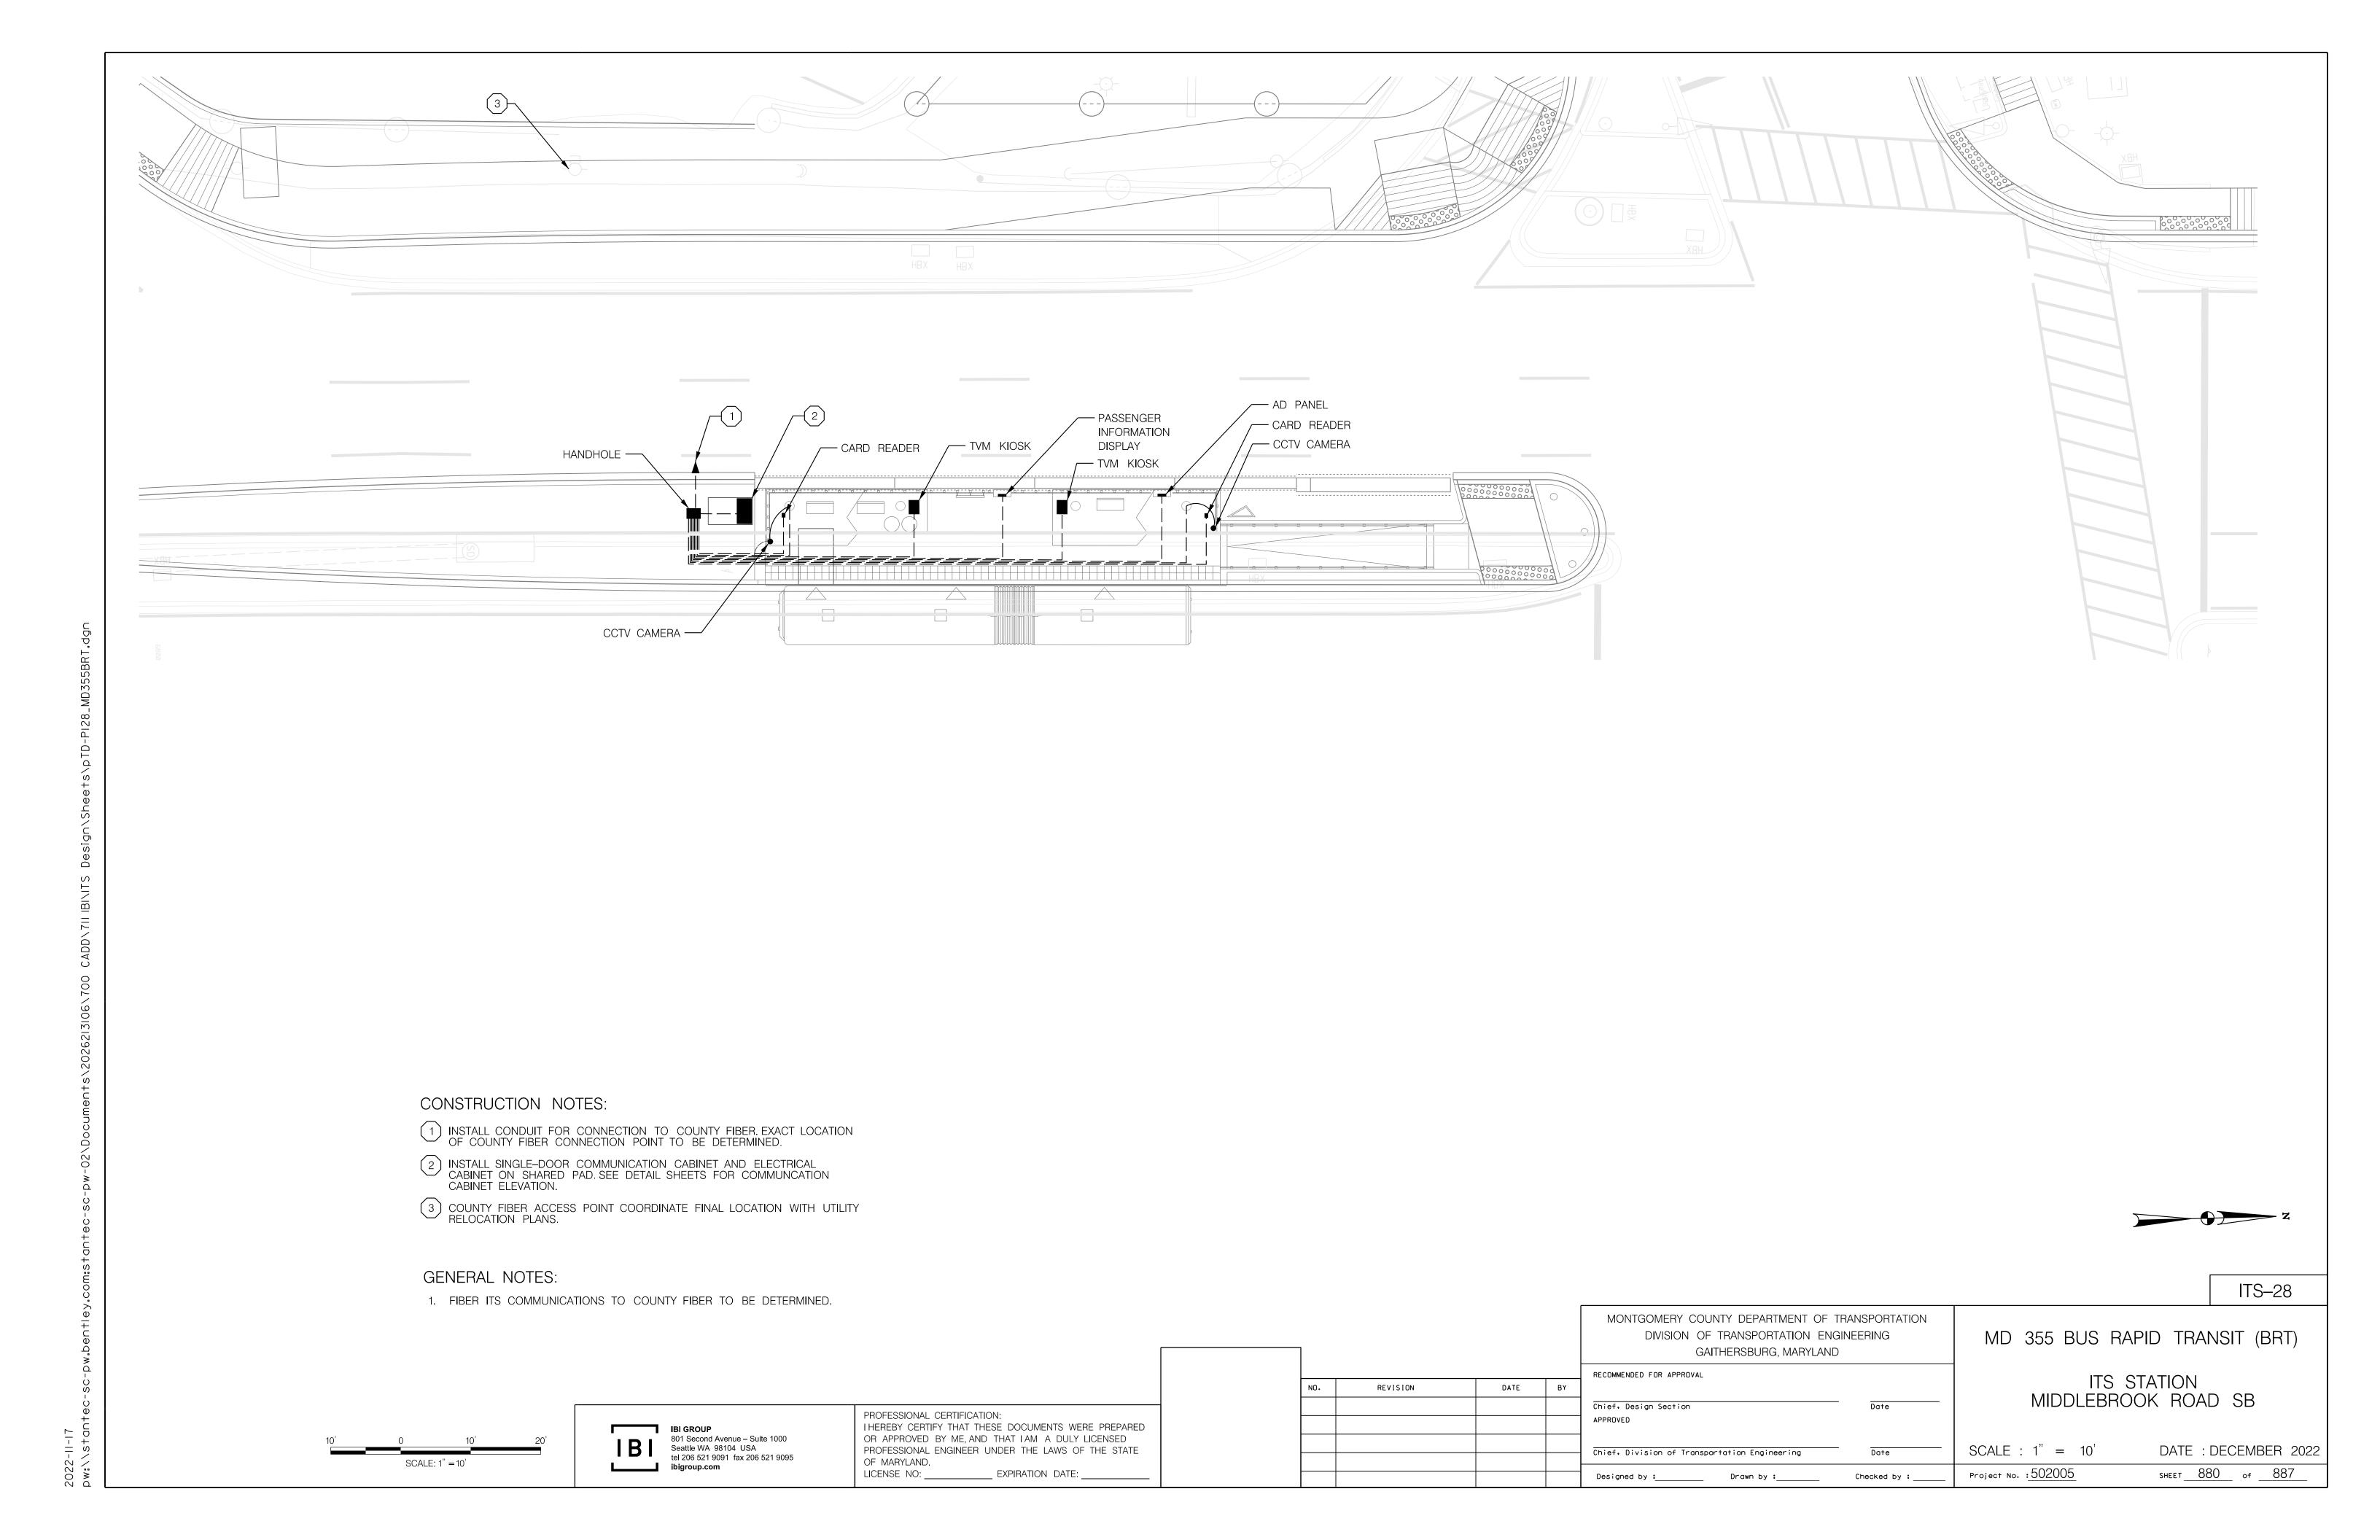

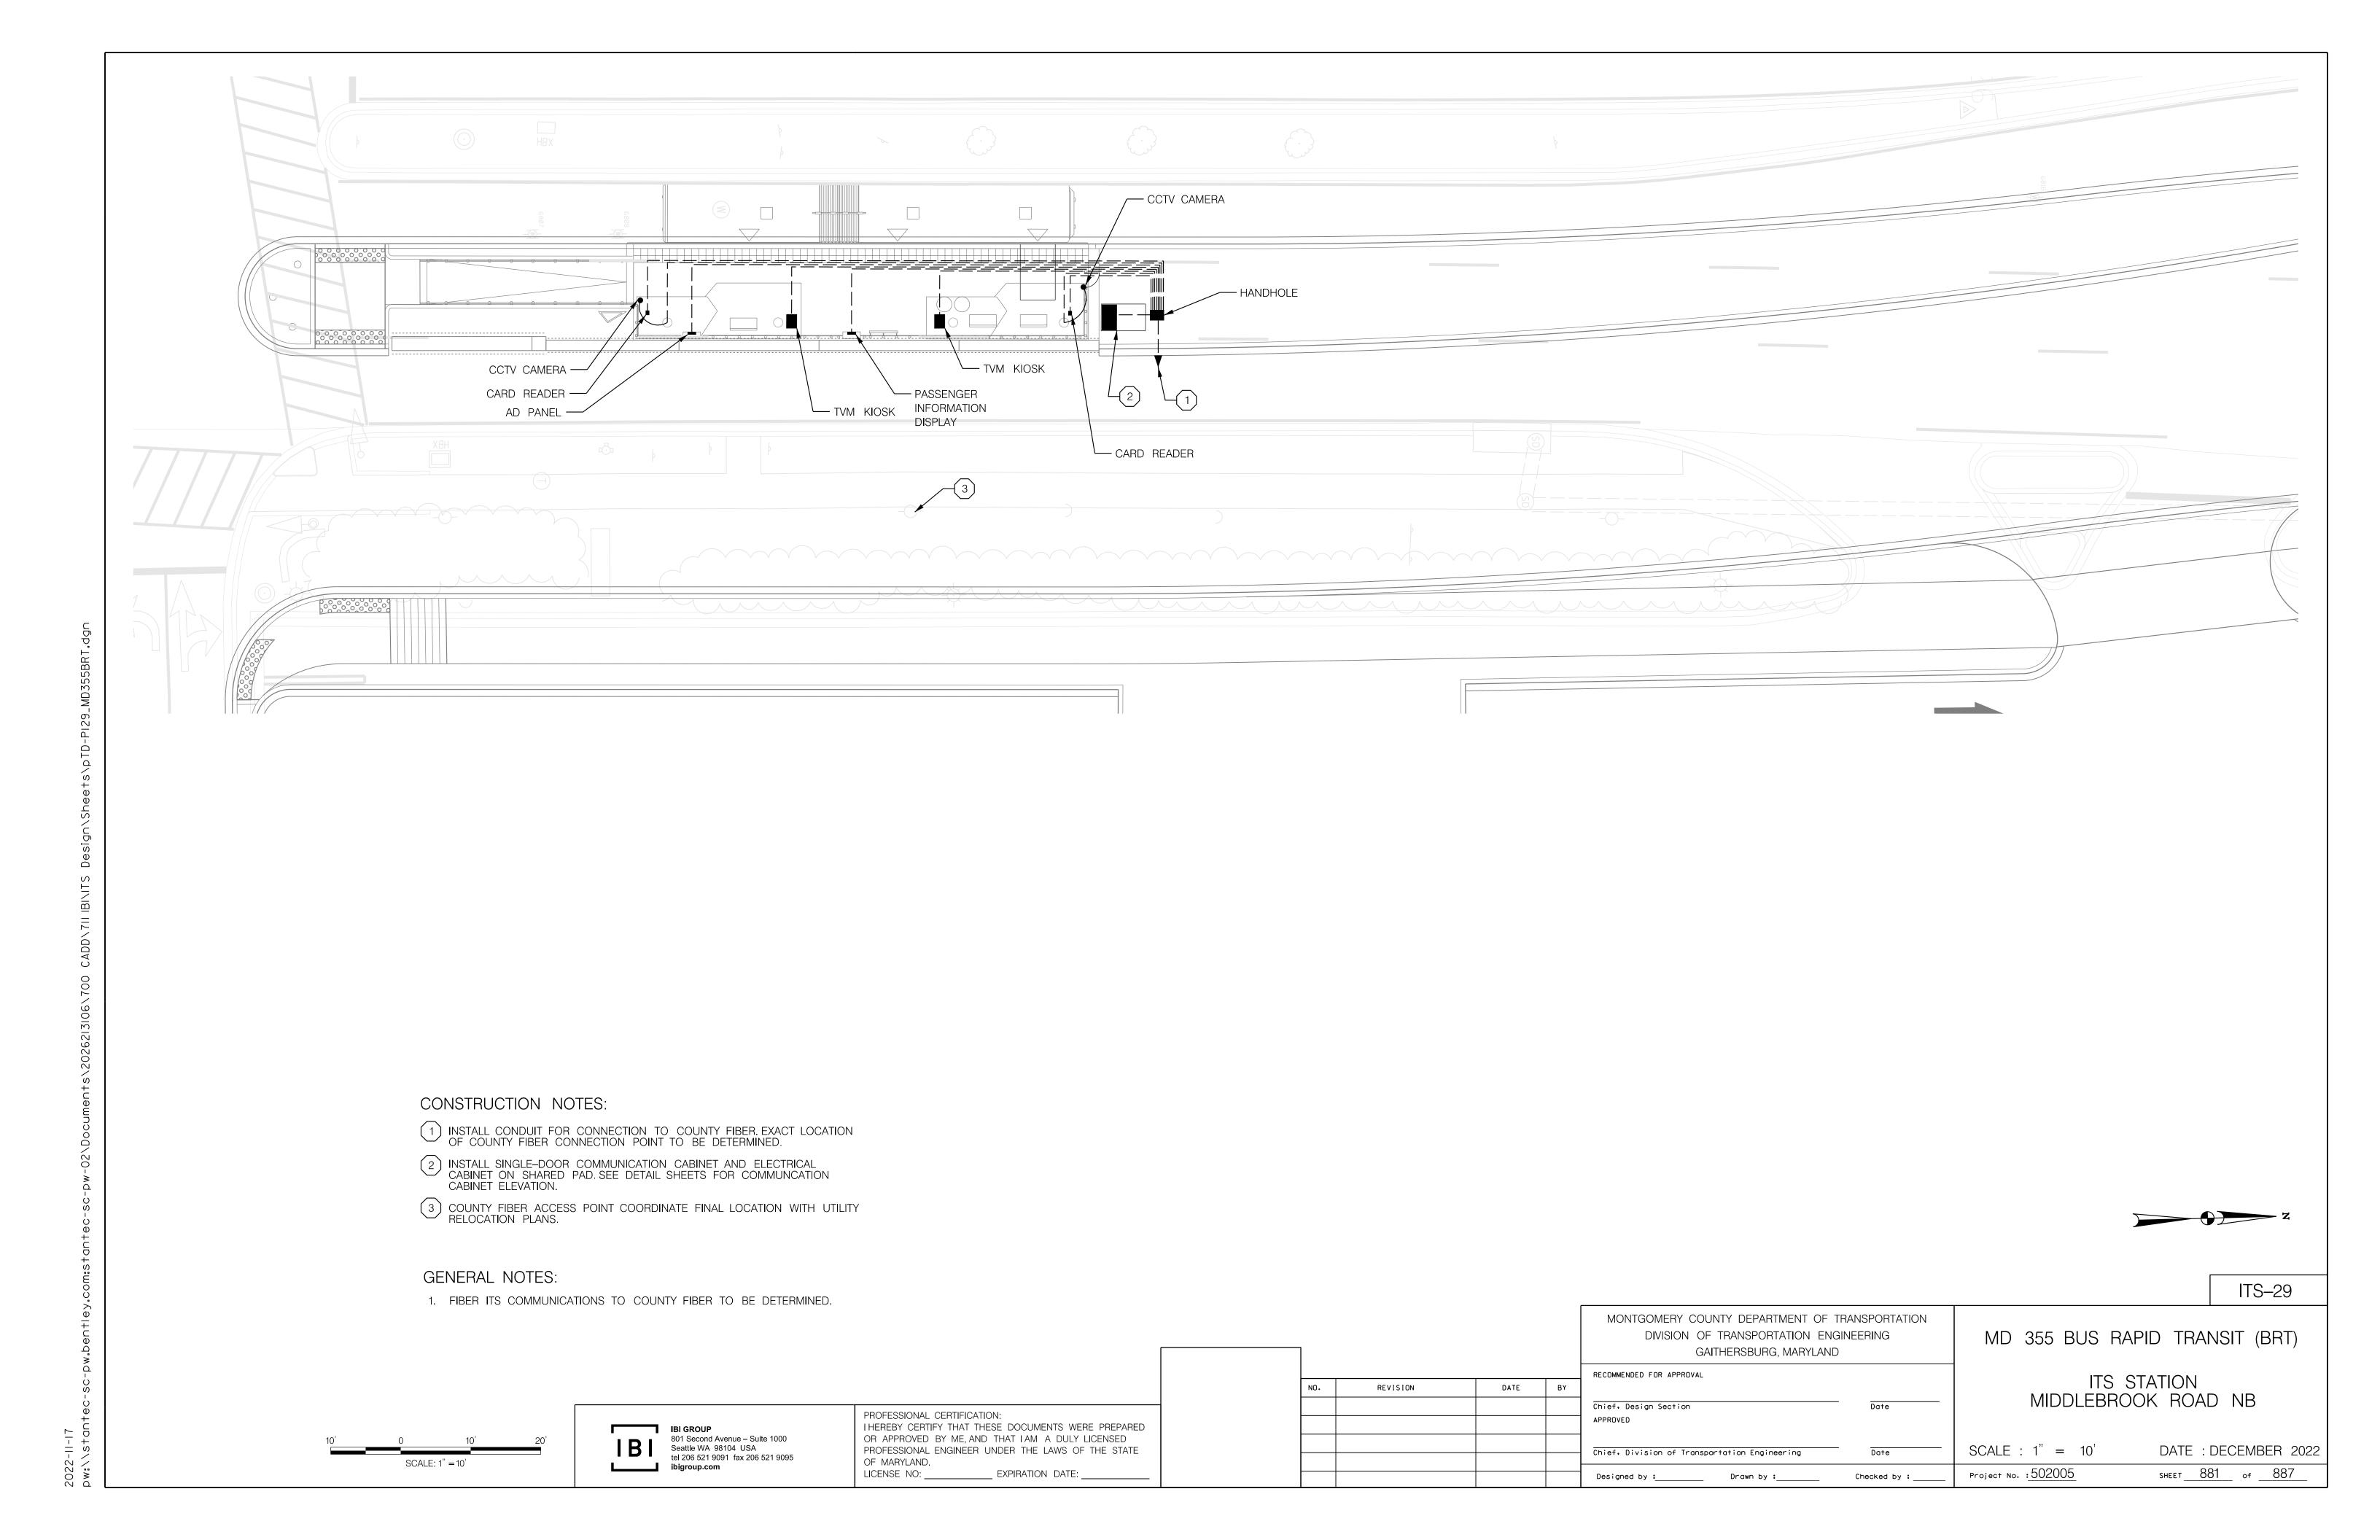

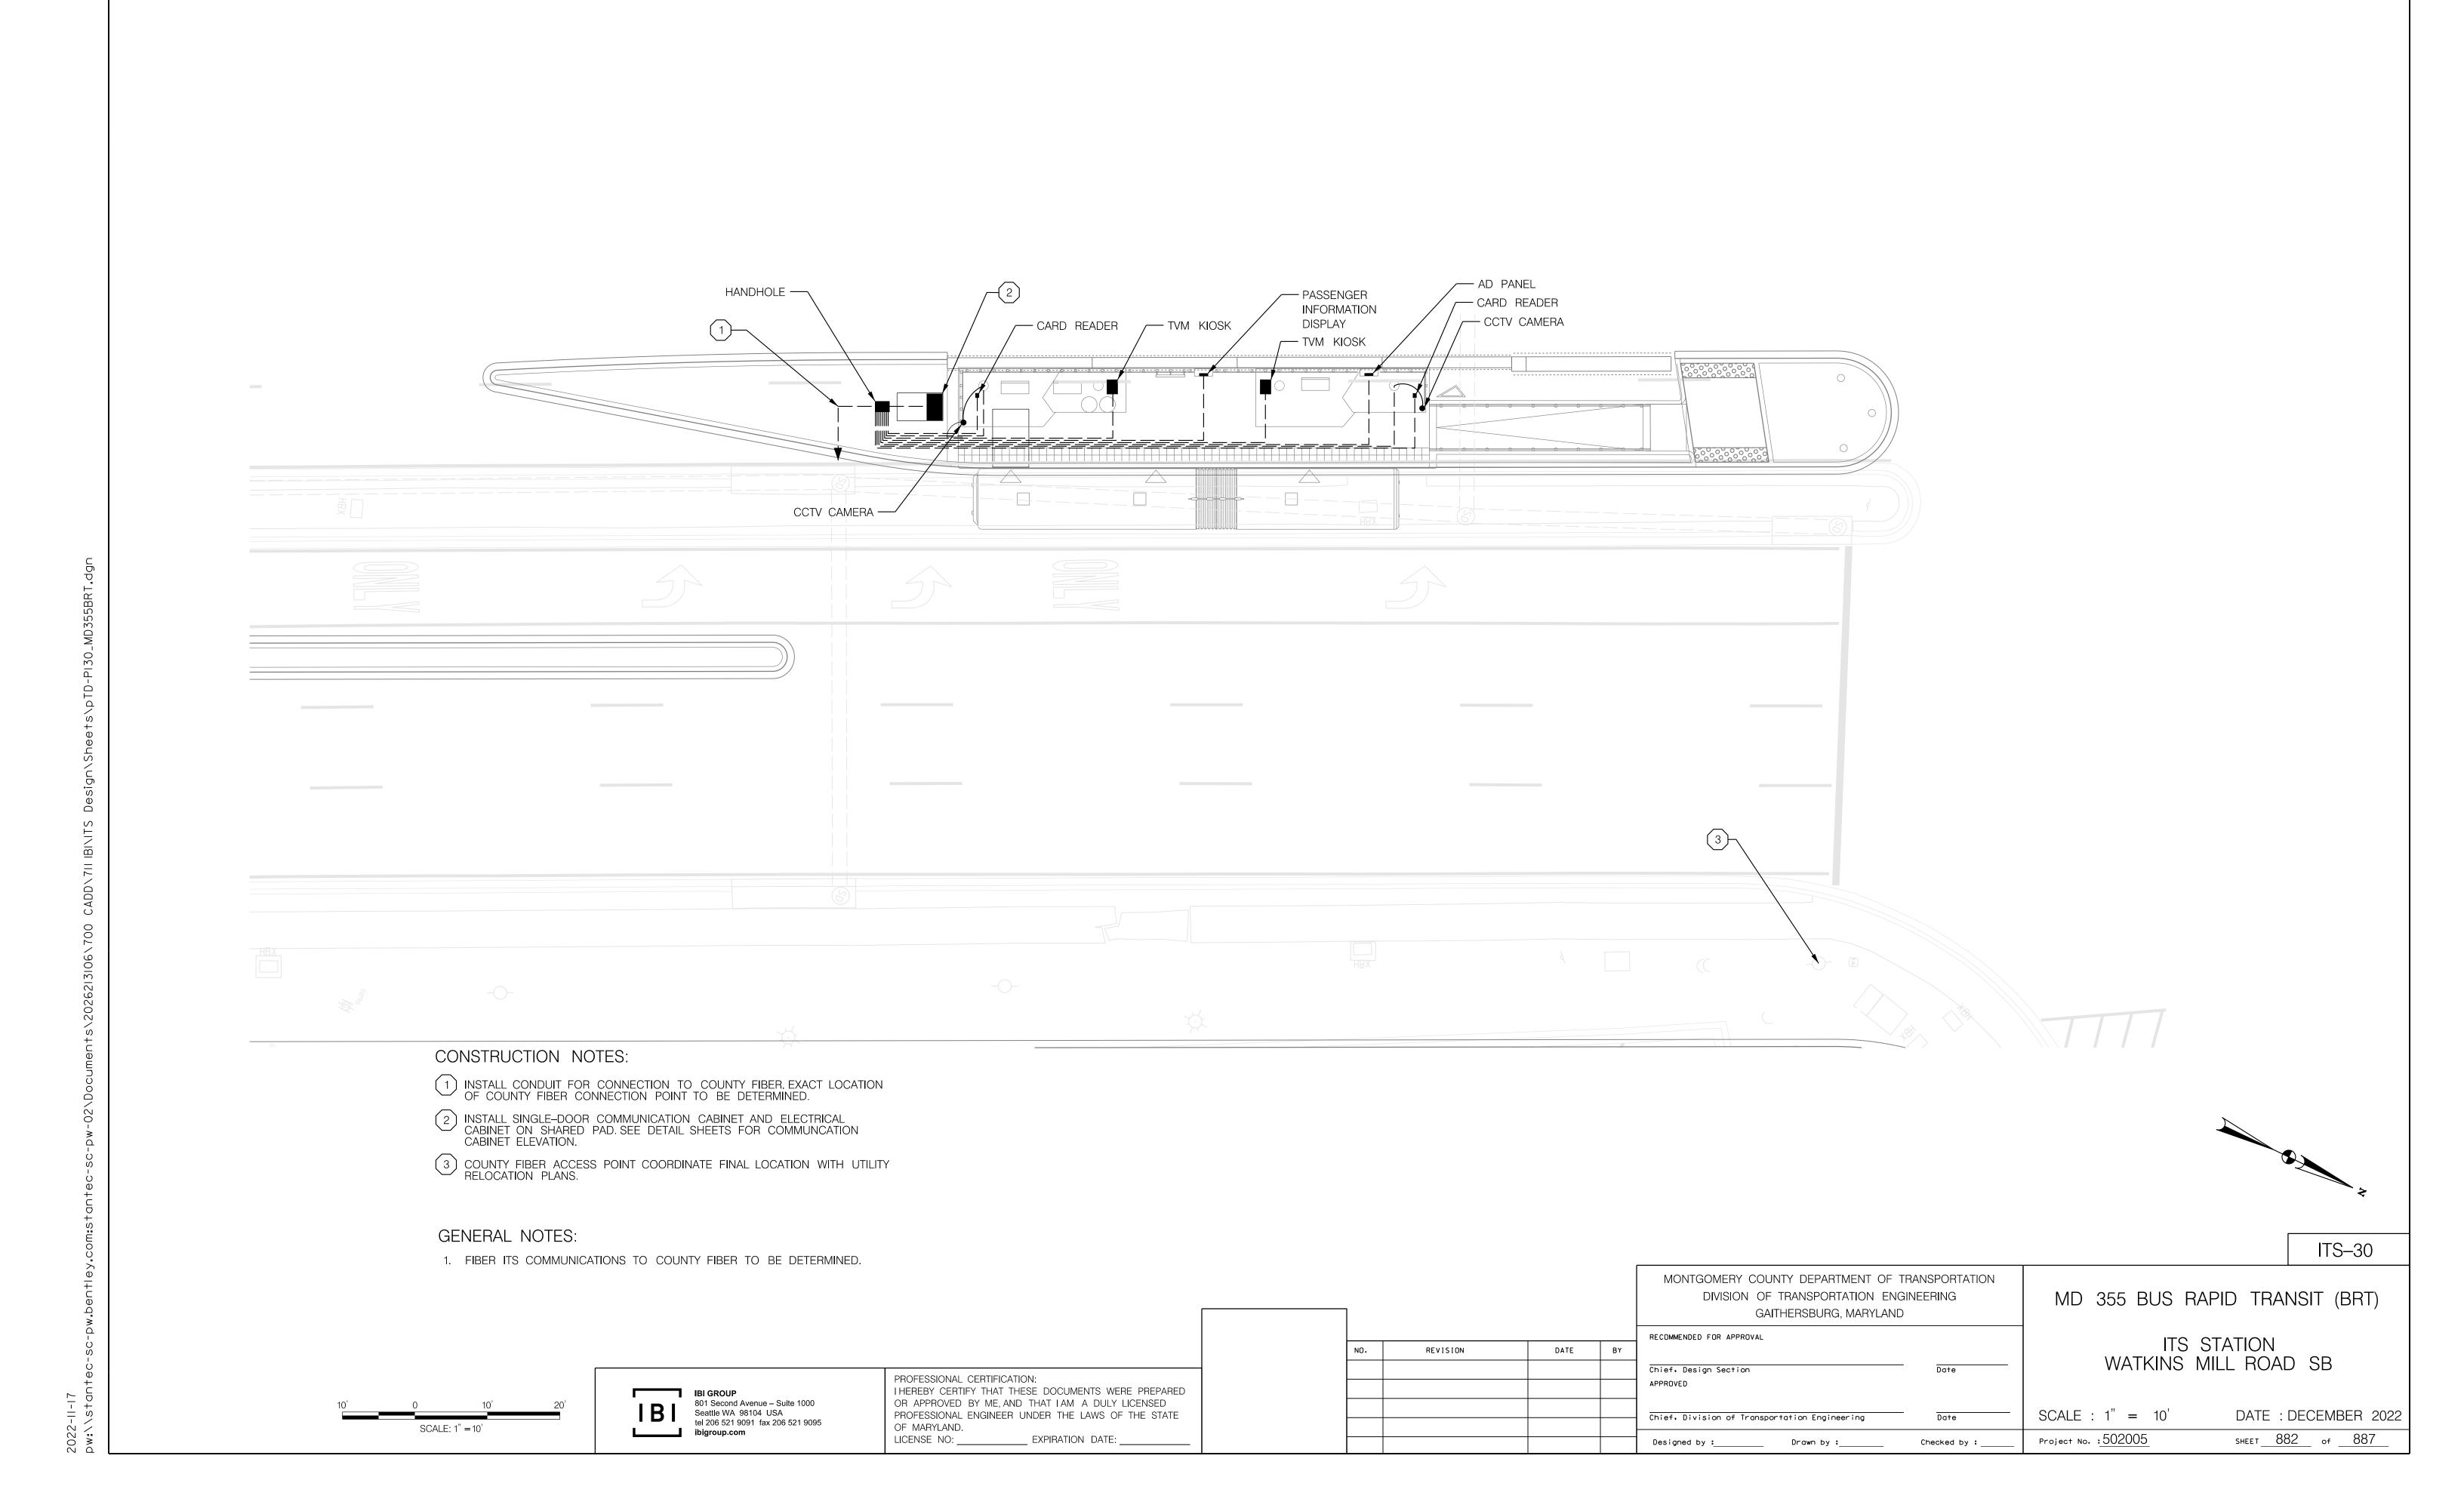

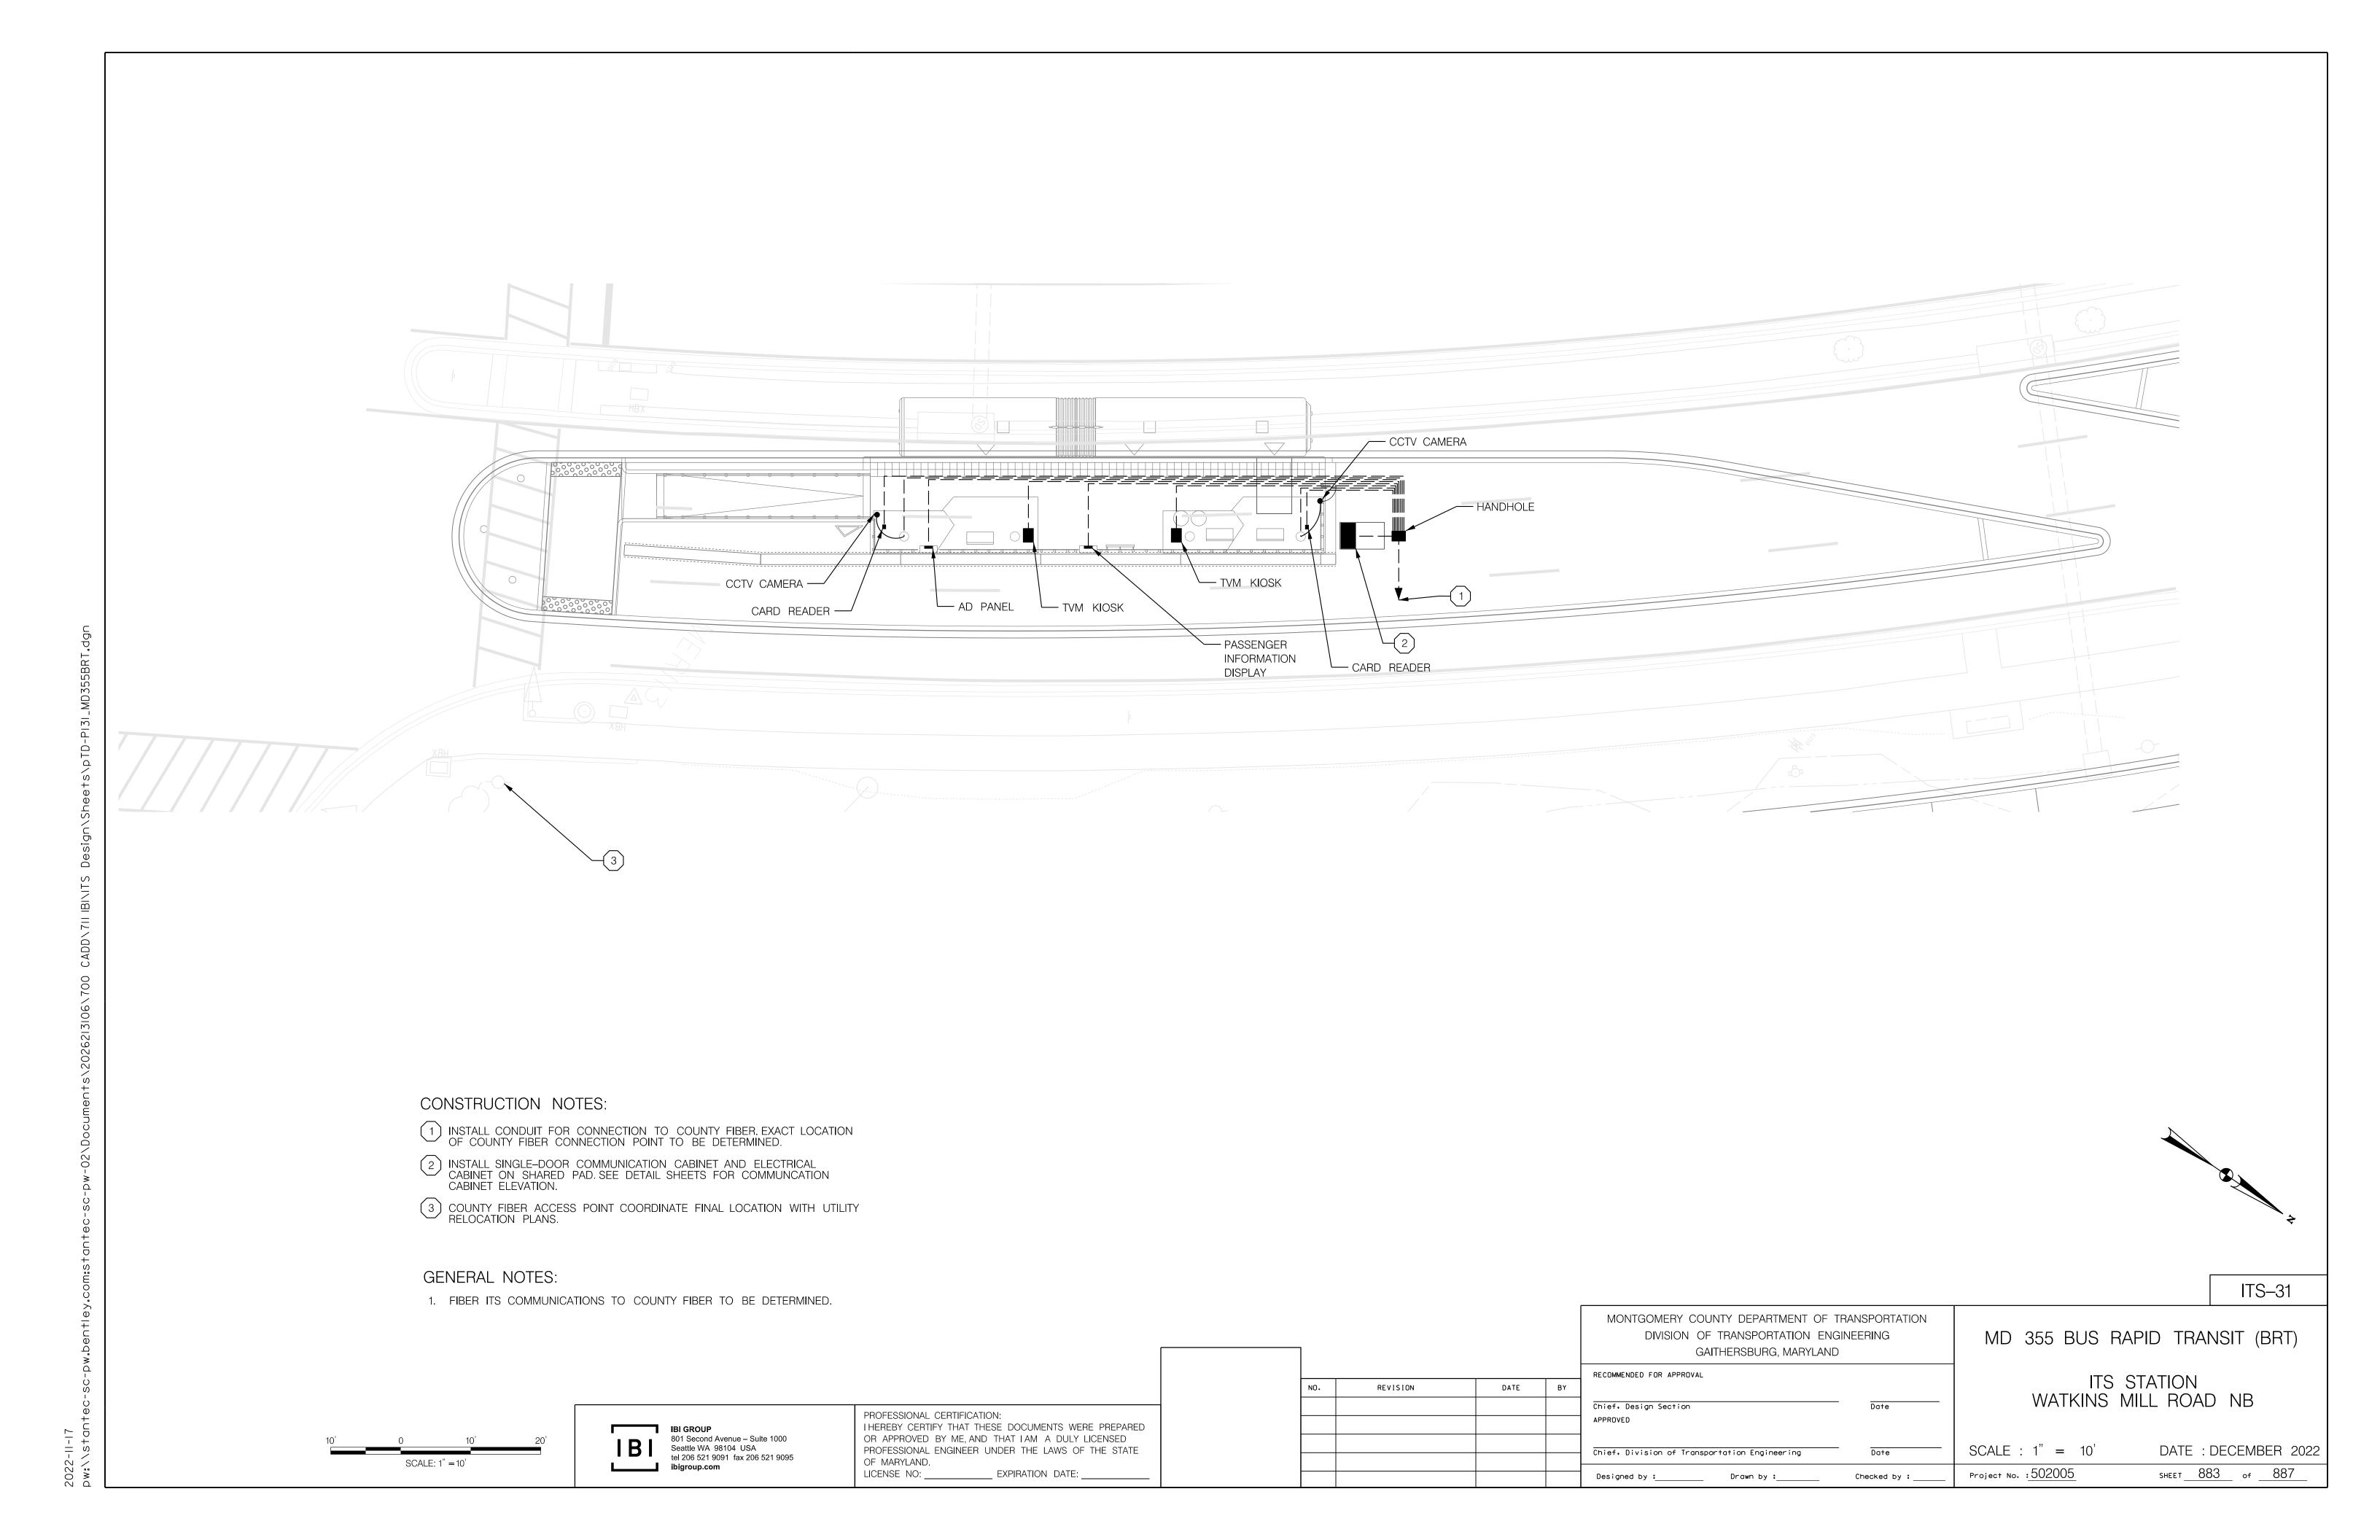

MONTGOMERY COUNTY DEPARTMENT OF TRANSPORTATION
DIVISION OF TRANSPORTATION ENGINEERING
GAITHERSBURG, MARYLAND

RECOMMENDED FOR APPROVAL

Thief, Design Section
APPROVED

Chief, Division of Transportation Engineering

Date

SCALE:

DATE: DECEMBER 2022

Checked by : _

Designed by :_____ Drawn by :____

Project No. :502005

ITS-32

SHEET <u>883A</u> of <u>887</u>

IBI GROUP
801 Second Avenue – Suite 1000
Seattle WA 98104 USA
tel 206 521 9091 fax 206 521 9095
ibigroup.com

PROFESSIONAL CERTIFICATION:
I HEREBY CERTIFY THAT THESE DOCUMENTS WERE PREPARED
OR APPROVED BY ME, AND THAT I AM A DULY LICENSED
PROFESSIONAL ENGINEER UNDER THE LAWS OF THE STATE
OF MARYLAND.
LICENSE NO: ______ EXPIRATION DATE: _____

REVISION

- HARDENED ETHERNET

(SUPPLIED BY OTHERS)

— SHELF WITH DRAWER

— SINGLE DOOR

WITH 8 SLOTS

COMMUNICATION CABINET

- CABINET POWER SUPPLY 120/240 30A MAIN CIRCUIT BARRIER

INSTALL FOUNDATION PER MD 816.02 & MD 816.03 NEMA 6


SWITCH WITH SFP MODULES

IRU CCH FIBER OPTIC PATCH PANEL 6 PORT

FC-UPC CONNECTORS FOR SINGLE MODE FIBER OR LC-UPC CONNECTORS FOR MULTIMODE FIBER

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022-11-17

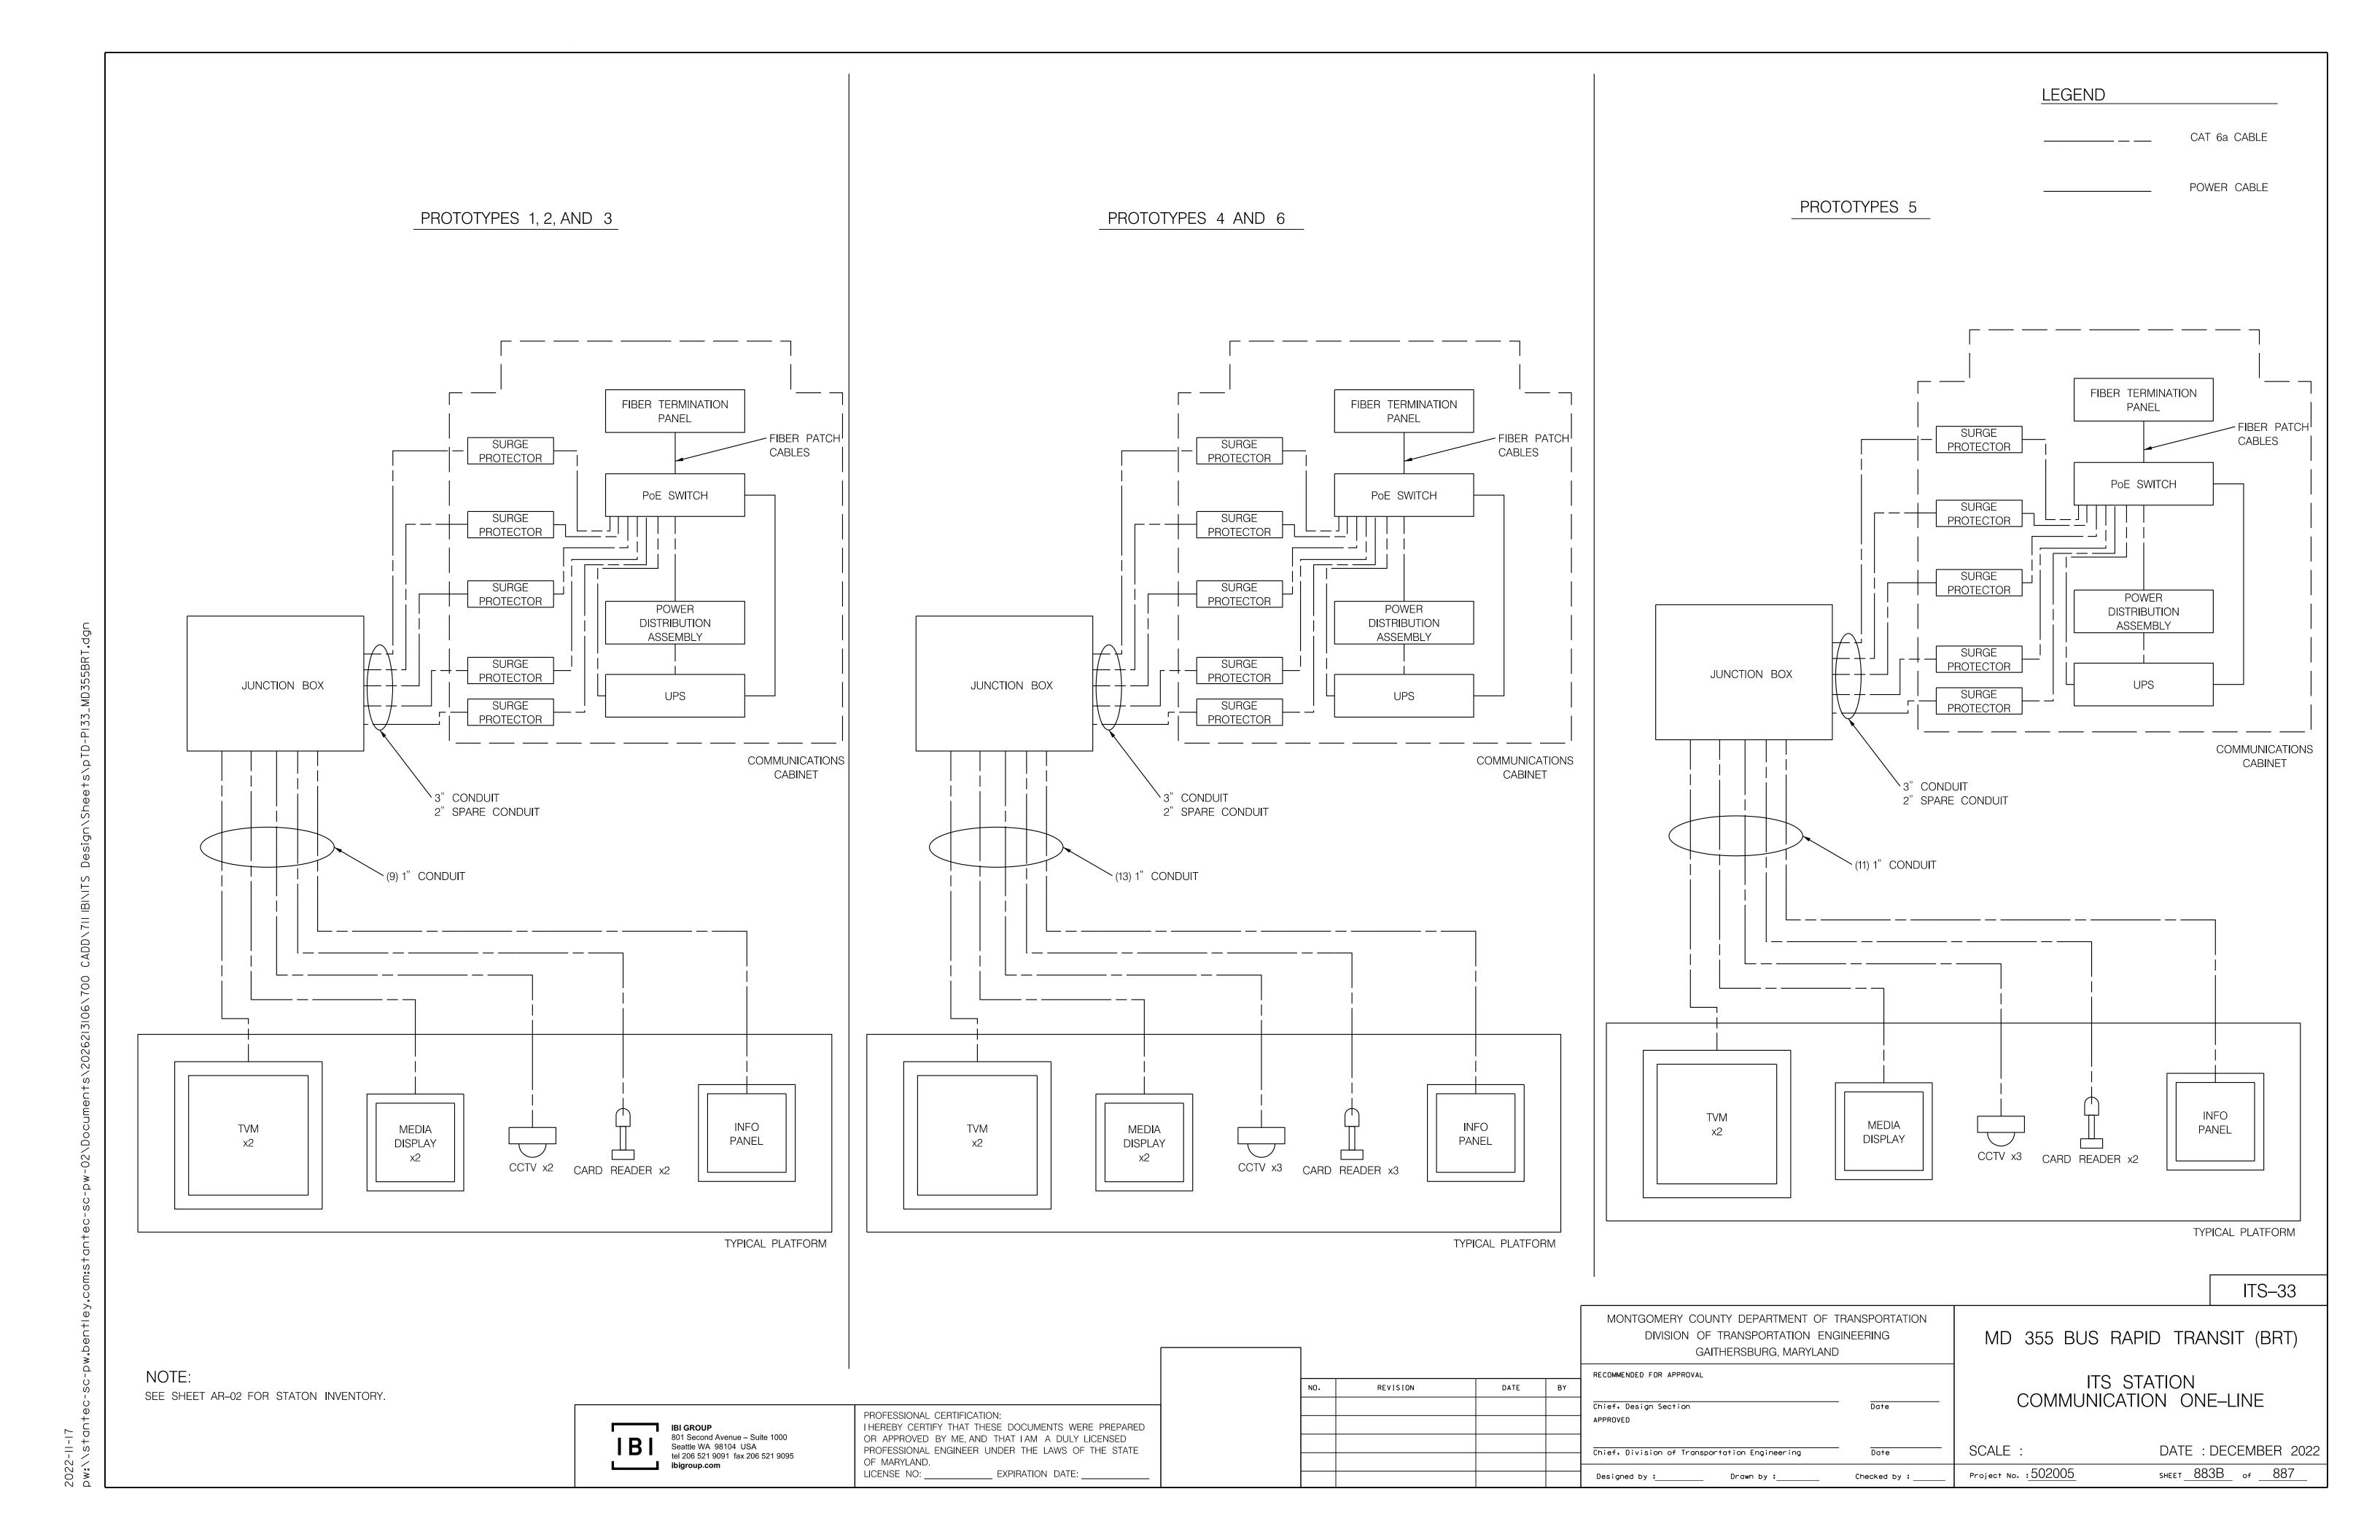

ROADWAY LIGHTING GENERAL NOTES

- 1. UNDERGROUND UTILITIES SHOWN ON THESE PLANS ARE SCHEMATIC ONLY AND MAY NOT BE COMPLETE. THE CONTRACTOR SHALL BE RESPONSIBLE FOR NOTIFYING "MISS UTILITY" PRIOR TO CONSTRUCTION SO THAT ALL UTILITIES MAY BE LOCATED IN THE FIELD. IF THE CONTRACTOR PERCEIVES THAT A CONFLICT BETWEEN THE UTILITIES AND THE SIGNS WILL OCCUR, THE CONTRACTOR SHALL NOTIFY THE ENGINEER IMMEDIATELY SO THAT THE CONFLICT MAY BE RESOLVED.
- 2. RIGHT-OF-WAY SHOWN ON THE PLANS IS APPROXIMATE AND BASED ON THE BEST AVAILABLE INFORMATION.
- 3. DESIGN OF PROPOSED LIGHTING CIRCUITS ASSUMES EXISTING LIGHTING CIRCUITS WILL BE FUNCTIONAL AT TIME OF CONSTRUCTION PER SHA DIRECTION. REPLACEMENT OF NON-WORKING CIRCUITS IS NOT INCLUDED IN CONTRACT WORK.
- 4. THE EXISTING LIGHTING SYSTEM SHALL REMAIN OPERATIONAL, SEE MAINTAIN EXISTING ROADWAY LIGHTING SPECIAL PROVISION, UNTIL THE PROPOSED LIGHTING INFRASTRUCTURE (CONDUIT, CABLES, FOUNDATIONS, ETC.) FOR THE PROPOSED SYSTEM HAS BEEN COMPLETED. OUTAGES TO LIGHTING WHEN SWITCHING FROM THE EXISTING LIGHTING SYSTEM TO THE PROPOSED LIGHTING SYSTEM ARE EXPECTED AND SHALL BE MINIMIZED TO THE EXTENT POSSIBLE.
- THE HORIZONTAL OFFSET OF THE PROPOSED LIGHT POLE TO THE NOTED OBJECT MAY BE ADJUSTED SO THAT THE LUMINAIRE IS MOUNTED BETWEEN 1 FOOT WITHIN AND 2 FEET OUTSIDE OF THE EDGE OF TRAVEL LANE. THE MINIMUM POLE OFFSET FROM THE CENTERLINE OF THE LIGHT POLE TO THE EDGE OF SHOULDER, FACE OF W-BEAM OR FACE OF CURB SHALL NOT BE LESS THAN 6 FEET, UNLESS OTHERWISE SHOWN ON THE PLANS, OR AS DIRECTED BY THE ENGINEER.
- 6. THE CENTER OF THE CABLE TRENCH SHALL BE 3 FEET BEHIND THE CENTER OF THE LIGHTING STRUCTURES UNLESS OTHERWISE SHOWN ON THE PLANS, OR AS DIRECTED BY THE ENGINEER.
- 7. THE ENGINEER SHALL BE NOTIFIED IMMEDIATELY IN CASE OF DAMAGE TO AN EXISTING FACILITY.
- 8. LIGHTING STRUCTURES SHALL NOT BE PLACED ON THE ROADWAY SIDE OF EXISTING OR PROPOSED TRAFFIC BARRIER W-BEAM OR CONCRETE TRAFFIC BARRIER WITHOUT WRITTEN AUTHORIZATION FROM THE ENGINEER.
- 9. ALL CONNECTIONS BETWEEN GROUND RODS AND GROUND CABLE SHALL BE BY EXOTHERMIC WELD.
- 10. CONDUCTORS SHALL NOT BE SPLICED EXCEPT IN STRUCTURES, MANHOLES AND PULL OR JUNCTION BOXES. ALL MANHOLES, CONDUITS UNDER PAVEMENT, LIGHTING STRUCTURES, ETC. SHALL BE STAKED OUT AND EVERY LOCATION APPROVED BY THE ENGINEER BEFORE ANY WORK IS DONE.
- 11. ALL DRIVEN CONDUIT SHALL BE PLACED UNDER PAVEMENT BY DIRECTIONAL BORING OR JACKING.
- 12. ALL LIGHTING STRUCTURES NOT PROTECTED BY TRAFFIC BARRIER SHALL BE ON BREAKAWAY BASES.
- 13. ALL TRENCHING MUST BE BACKFILLED AND STABILIZED ON THE SAME WORKING DAY ON WHICH IT WAS OPENED. AREAS WHICH ARE NOT RESEEDED, MULCHED OR SODDED MUST BE COVERED TO PREVENT EROSION.
- 14. ALL SOIL REMOVED FOR HANDBOXES, FOUNDATIONS, ETC. MUST BE COVERED TO PREVENT EROSION. SOIL NOT USED FOR BACKFILL MUST BE DISPOSED OF TO THE ENGINEER'S SATISFACTION ON THE SAME WORKING DAY THE BACKFILL IS COMPLETED.
- 15. WIRING FOR LIGHT POLES SHALL BE WIRED WITH ALTERNATING CIRCUITS SO THAT NO TWO ADJACENT LUMINAIRES ON A SIGN STRUCTURE OPERATE OFF THE SAME CIRCUIT.
- 16. PROPOSED JUNCTION BOXES SHALL BE GALVANIZED STEEL RATED NEMA 4X AND INCLUDE A LATCH TO BE LOCKED WITH A PADLOCK.
- 17. FOR WIRING WITHIN PROPOSED LIGHT POLES, PROVIDE 3-1/C NO. 10 AWG, TYPE THWH/THHN, 600V ELECTRICAL CABLES. THE ADDITIONAL 1/C NO. 10 AWG ELECTRICAL CABLE IS FOR LED LUMINAIRE GROUNDING AND SHALL HAVE GREEN INSULATION.
- 18. THE CONTRACTOR SHALL VERIFY LIGHTING CIRCUIT VOLTAGE PRIOR TO ORDERING ALL LED LUMINAIRES.
- 19. ALL PROPOSED LIGHT POLE LOCATIONS SHALL BE STAKED OUT PRIOR TO INSTALLATION.
- 20. CLEARING AND GRUBBING REQUIRED FOR INSTALLATION OF LIGHT POLES, MANHOLES, CONDUITS, DUCT CABLES, ETC. WILL NOT BE MEASURED AND THE COST WILL BE INCIDENTAL TO THE PERTINENT BID ITEM.

- 21. ALL PROPOSED LIGHT POLES AND TRANSFORMER BASES ARE TO BE GALVANIZED FINISH.
- 22. ALL LED FIXTURES SHALL BE PER THE MDOT SHA QUALIFIED PRODUCTS LIST, AS OF TIME OF ADVERTISEMENT.
- 23. ALL CABLING ENGERGIZING PROPOSED LIGHTING STRUCTURES SHALL BE NEW.
- 24. ALL LIGHT POLES SHALL BE INSTALLED PER SHA STD. NO. MD. 808.01. ALL LIGHT POLE FOUNDATIONS SHALL BE INSTALLED PER SHA STD. NO. MD. 801.02.
- 25. THE CONTRACTOR SHALL COORDINATE THE INSTALLATION OF LIGHT POLE FOUNDATIONS, MANHOLES, CONDUITS AND DUCT CABLES WITH THE INSTALLATION OF PROPOSED DRAINAGE STRUCTURES & PIPES. IF THE CONTRACTOR PERCEIVES THAT A CONFLICT WILL OCCUR, THE CONTRACTOR SHALL NOTIFY THE PROJECT ENGINEER IMMEDIATELY SO THAT THE CONFLICT MAY BE RESOLVED.
- 26. IF AN OUTFALL EXISTS WITHIN 25 FT OF MANHOLE, INSTALL UNDER DRAIN TO THE OUTFALL POINT. UNDER DRAIN SHALL BE QUANTIFIED PER LINEAR FOOT. IF AN MANHOLE CANNOT BE DRAINED TO AN OUTFALL, INSTALL THE MANHOLE PER NOTE 8 ON MD STD. 811.04-01. ADDITIONAL STONE SHALL BE INCIDENTAL TO PROPOSED MANHOLE ITEM.
- 27. ALL LIGHT POLES, CABINETS AND MANHOLES TO BE REMOVED SHALL HAVE THE FOUNDATION OR STRUCTURE REMOVED 1 FT. BELOW GRADE AND BACK FILLED.
- 28. PROPOSED LIGHT POLE FOUNDATIONS FOR BREAKAWAY STRUCTURES SHALL NOT PROTRUDE MORE THAN 4 INCHES ABOVE GRADE. IT IS ACCEPTABLE TO PERFORM MINOR GRADING TO AVOID PROTRUDING MORE THAN 4 INCHES ABOVE GRADE. MINOR GRADING SHALL BE INCIDENTAL TO CONCRETE FOUNDATIONS. CLEARING AND GRUBBING REQUIRED FOR INSTALLATION OF DUCT CABLE, LIGHTING STRUCTURES, MANHOLES, CABINETS, METERED SERVICE PEDESTALS, CONDUITS, ETC. WILL NOT BE MEASURED AND THE COST WILL BE INCIDENTAL TO THE PERTINENT BID ITEM.
- 29. THE CONTRACTOR SHALL UPDATE THE PANEL SCHEDULE WHEN ADDING NEW LIGHTING STRUCTURES OR SIGN LIGHTING TO AN EXISTING CABINET. UPDATING THE PANEL SCHEDULE SHALL BE INCIDENTAL TO PERTINENT BID ITEMS IN THE CONTRACT.
- 30. THE CONTRACTOR SHALL COORDINATE THE INSTALLATION OF LIGHT POLE FOUNDATIONS, CONDUIT, DUCT CABLE, MANHOLE AND OTHER NECESSARY ELECTRICAL EQUIPMENT WITH PROPOSED DRAINAGE AND STORM WATER MANAGEMENT FACILITIES INCLUDING PROPOSED DITCH LINERS AND MEDIA. THE CONTRACTOR SHALL STAGE LIGHTING AND ELECTRICAL CONSTRUCTION AS NECESSARY TO AVOID IMPACTING FACILITIES CONSTRUCTED UNDER THIS PROJECT.
- 31. WITHIN 36 IN. OF UNDERGROUND UTILITY LOCATIONS, THE CONTRACTOR SHALL BE REQUIRED TO EXCAVATE FOR FOUNDATIONS, CONDUITS, ETC. BY HAND. HAND DIGGING FOR INSTALLATION OR REMOVAL OF LIGHTING EQUIPMENT, W-BEAM, ETC. SHALL BE INCIDENTAL TO THE PERTINENT ITEMS IN THE EQUIPMENT LIST. NO ADDITIONAL COMPENSATION WILL BE PROVIDED FOR HAND DIGGING.
- 32. ALL MANHOLES SHALL HAVE CONCRETE COLLARS PER STANDARD MD 811.04. CONCRETE COLLARS SHALL BE INCIDENTAL TO MANHOLES.
- 33. THE CONTRACTOR SHALL CAP AND ABANDON ALL EXISTING CONDUITS AND REMOVE ALL EXISTING CABLES THAT ARE NO LONGER IN USE
- 34. THE CONTRACTOR SHALL INSTALL ALL LIGHT POLE FOUNDATIONS AND MANHOLES AT FINAL GRADE.
- 35. ANY DAMAGE TO THE EXISTING UTILITIES WILL BE REPAIRED IMMEDIATELY AT THE CONTRACTOR'S EXPENSE. THE ENGINEER SHALL BE NOTIFIED IMMEDIATELY IN CASE OF DAMAGE TO AN EXISTING FACILITY.
- 6. THE CONTRACTOR SHALL INSTALL DUCT END SEALS IN ALL LIGHT POLES AND ALL MANHOLES. DUCT END SEALS SHALL BE INCIDENTAL TO THE PERTINENT DUCT CABLE ITEMS.





OFFICE OF TRAFFIC & SAFETY TRAFFIC ENGINEERING DESIGN DIVISION


MD 355 BUS RAPID TRANSIT (BRT)

APPROVALS	REVISIONS	LIGHTING GENERAL NOTES						
		SCALE NONE DATE 12 / 2022 CONTRACT NO						
TEAM LEADER ASST. DIV. CHIEF		DESIGNED BY LHT COUNTY MONTGOMERY DRAWN BY LHT LOGMILE CHECKED BY SJW TIMS NO						
DIVISION CHIEF		MDE/PRD < 00-AA-0000 > TOD NO						
OFFICE DIRECTOR		DRAWING NO. LT - 01 OF 4 SHEET NO. 884 OF 887						



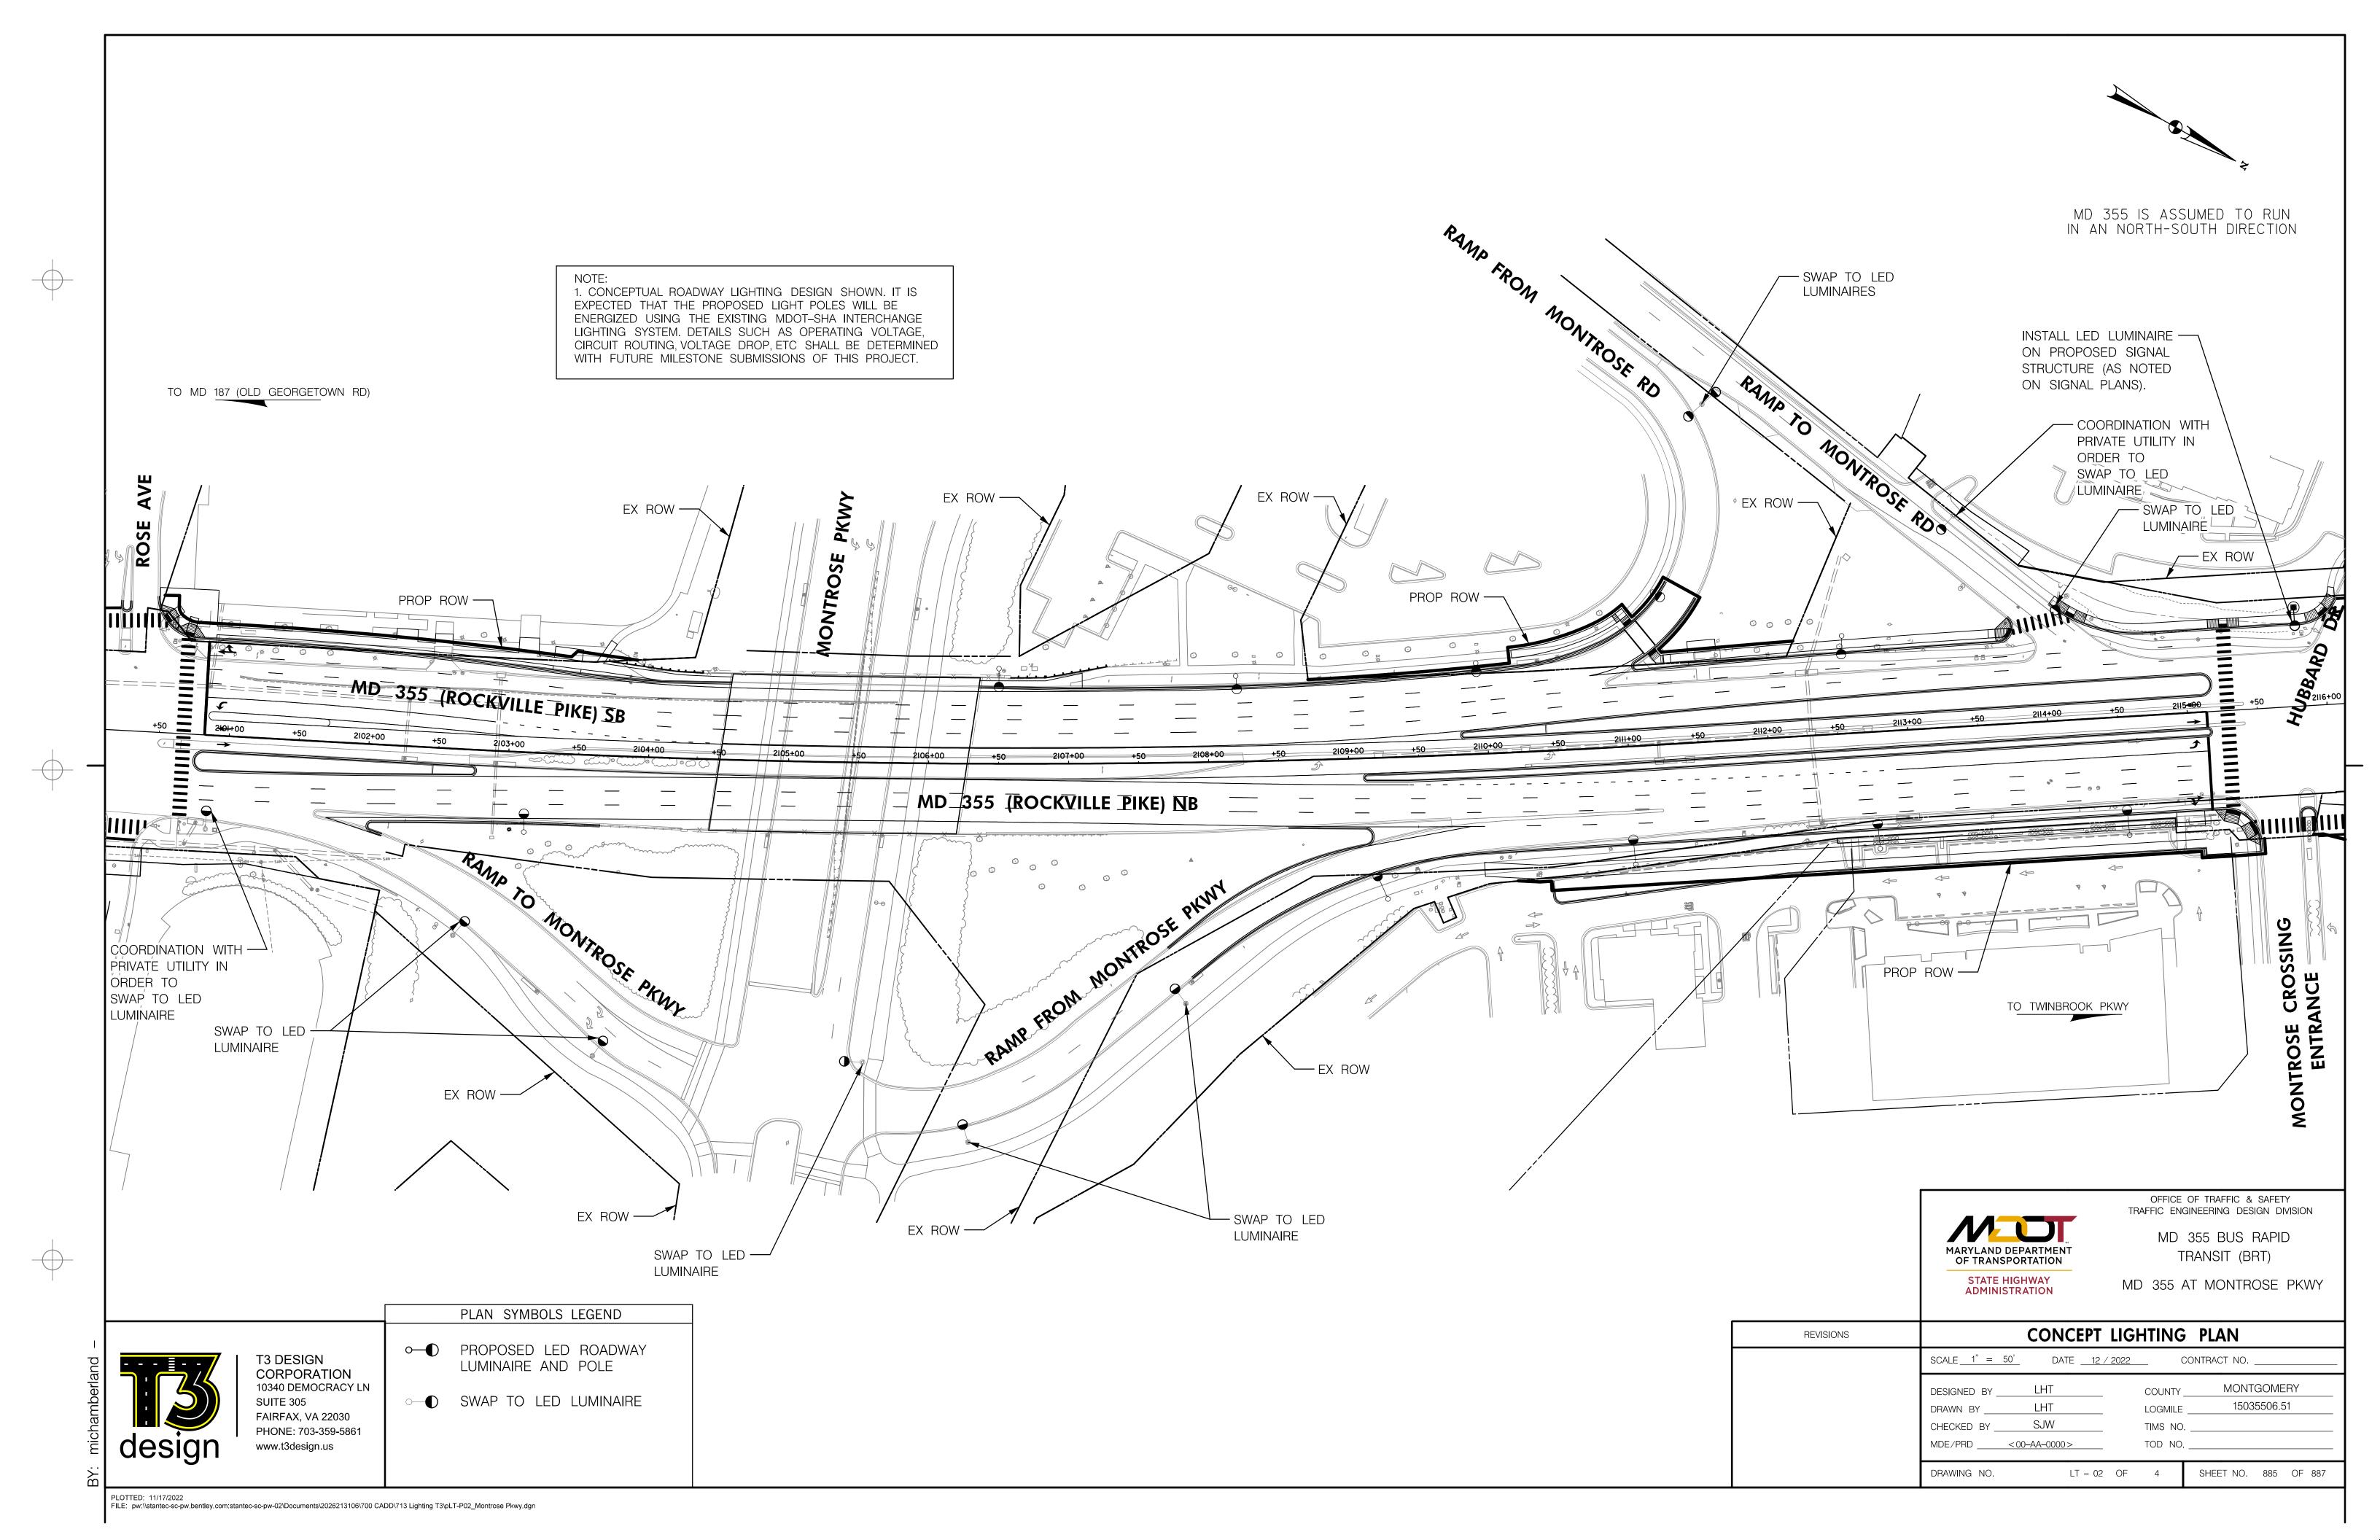

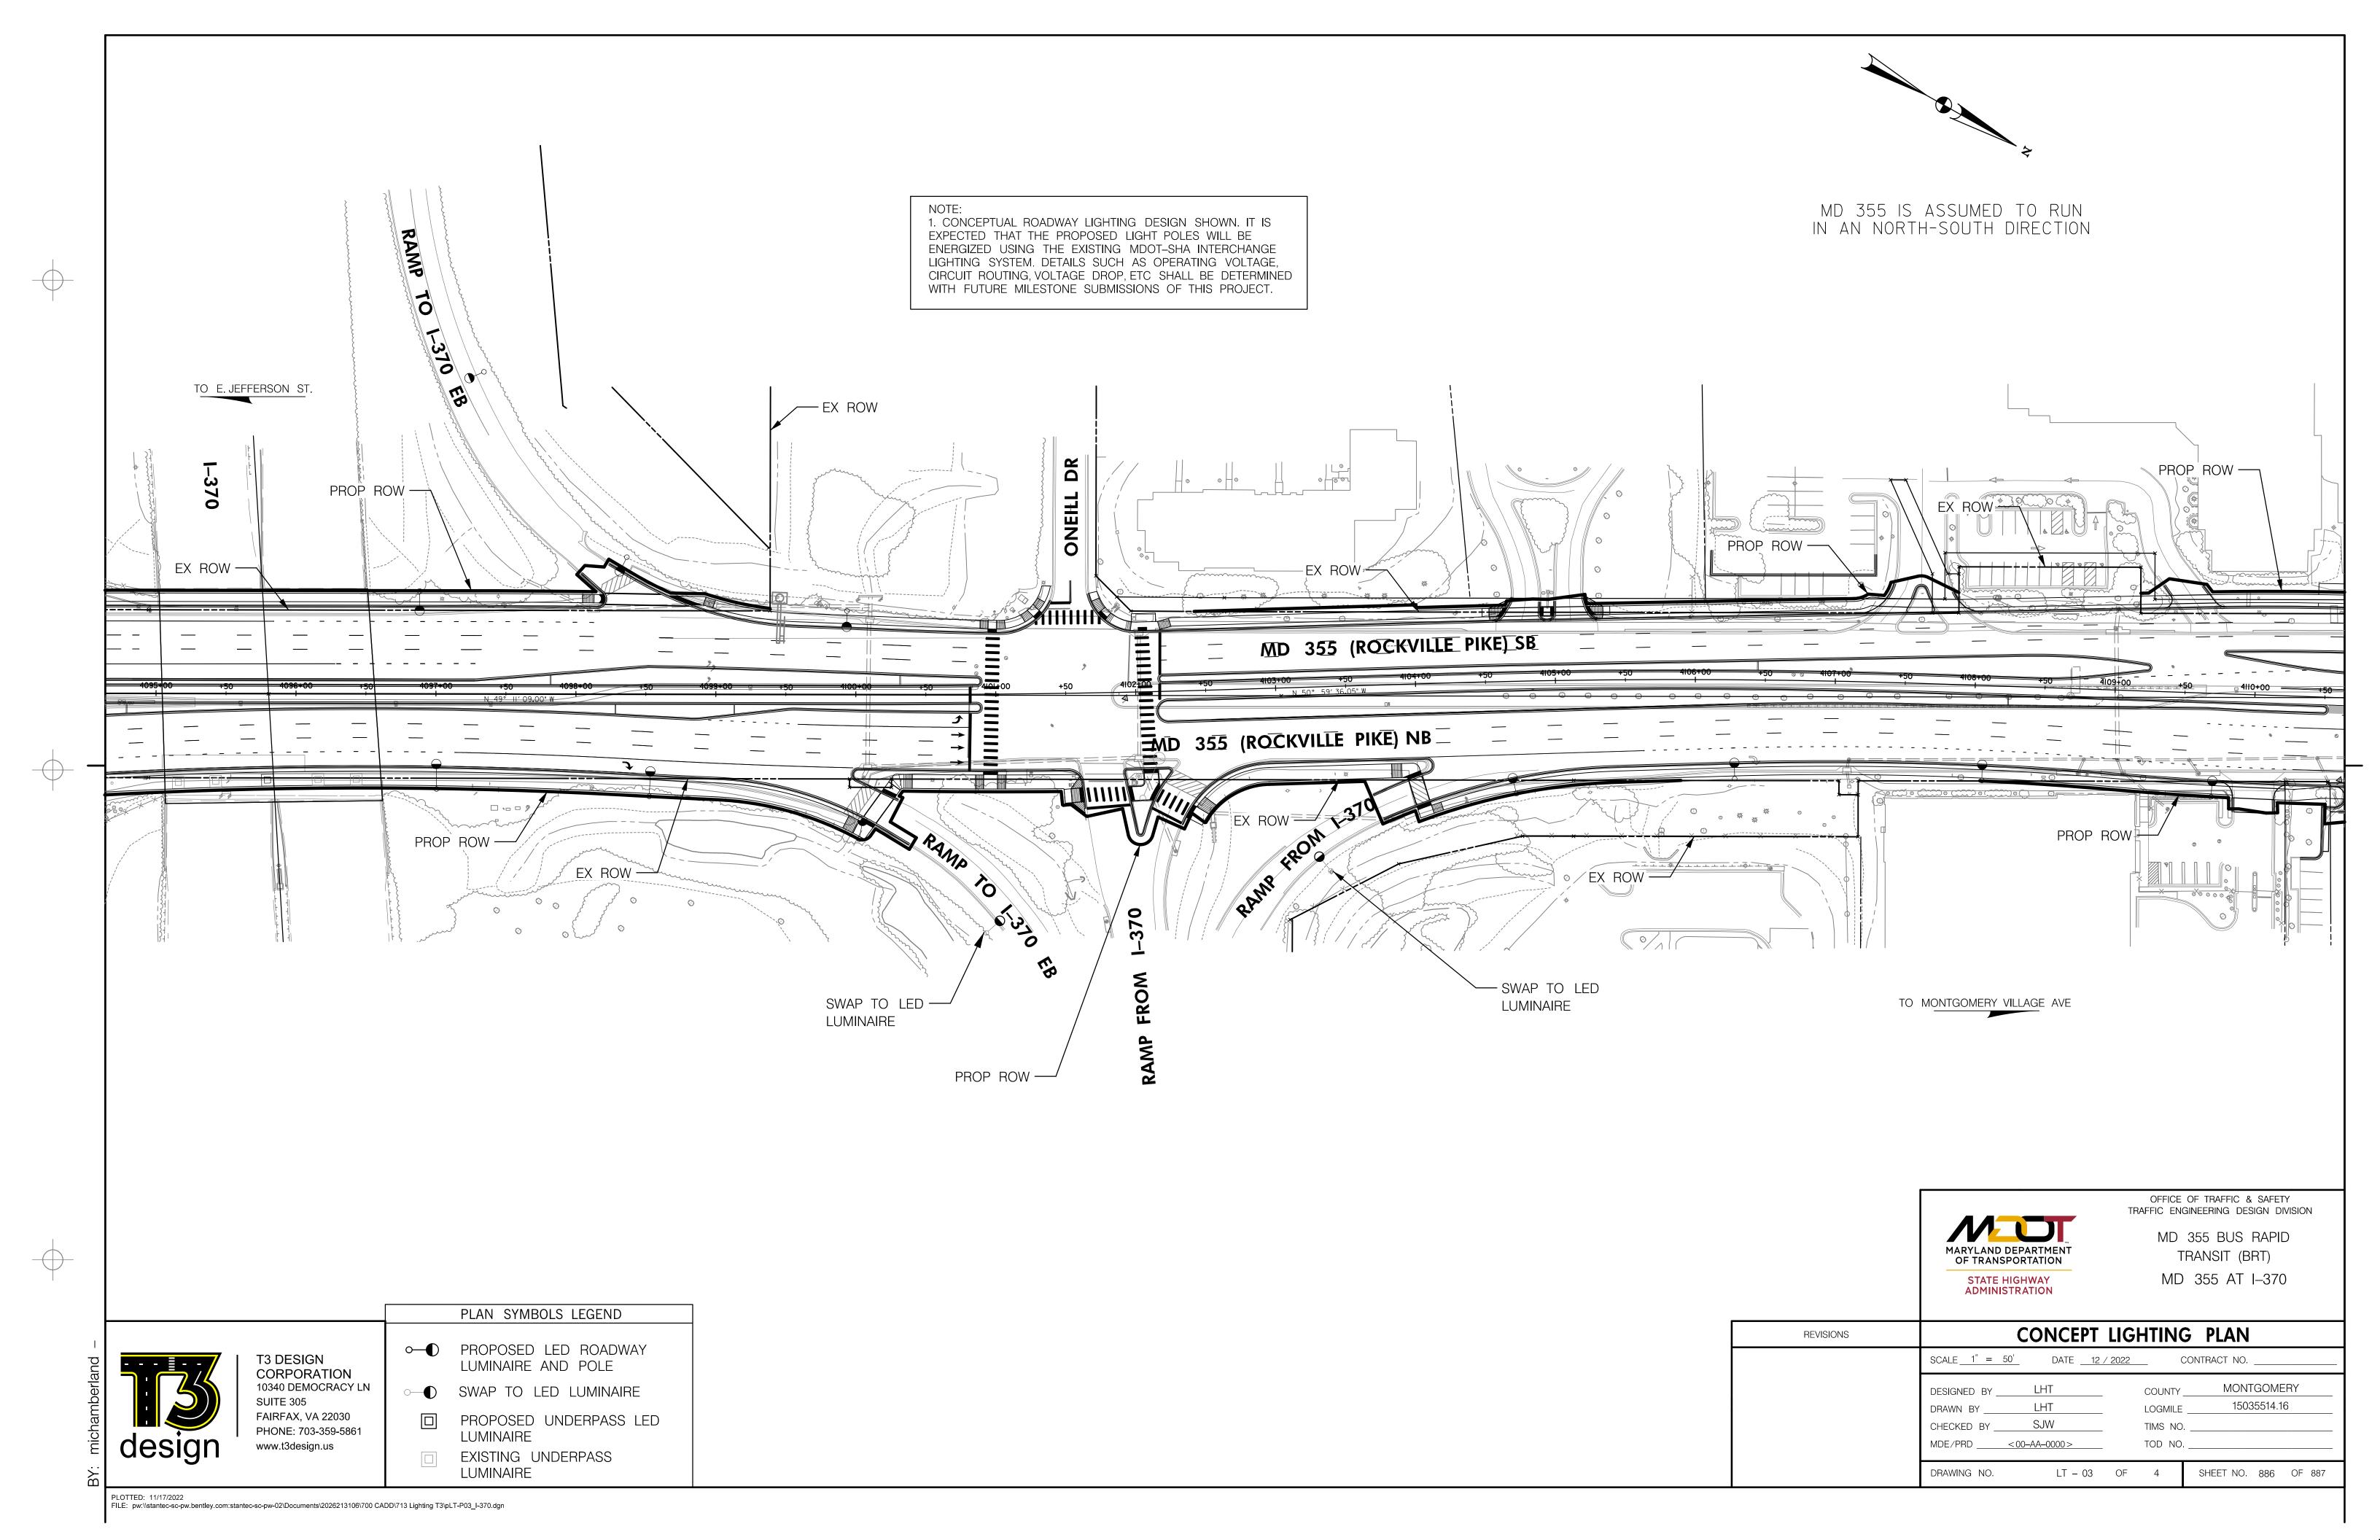

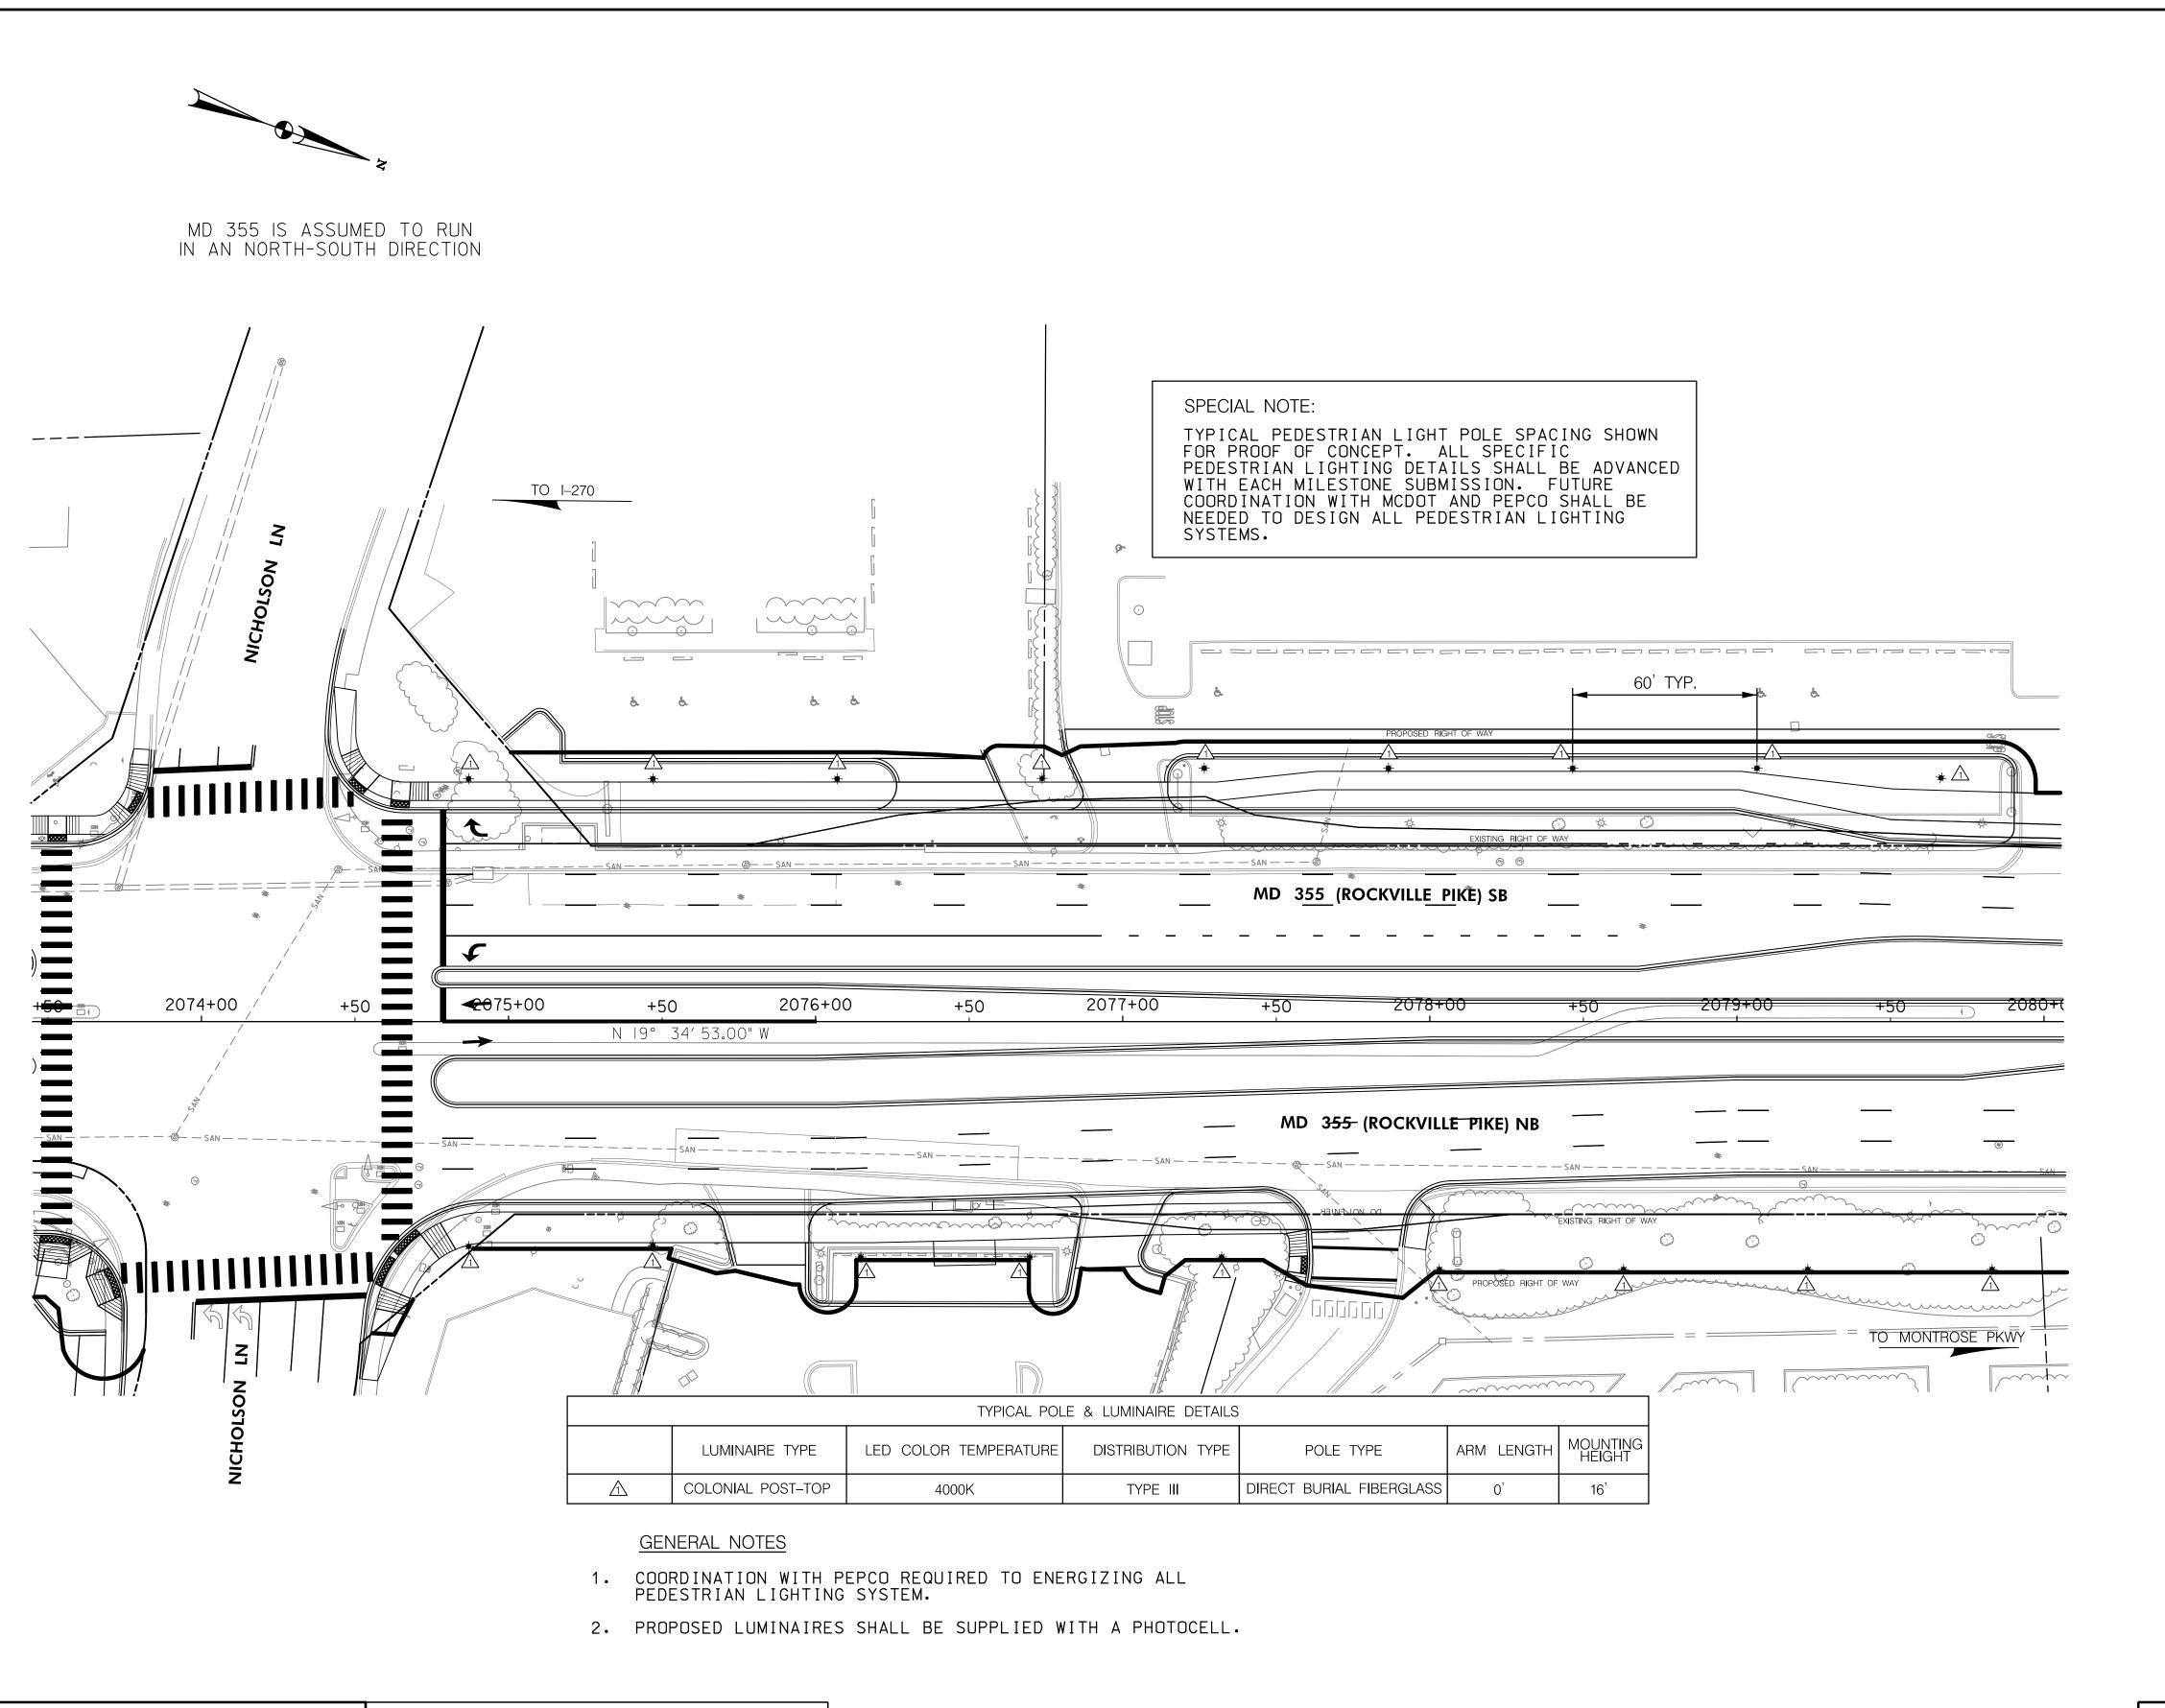



STATE HIGHWAY ADMINISTRATION

<u>SPECIFICATIONS FOR STREETLIGHT HARDWARE</u> IFB # 1063092

SPECIFICATIONS FOR STREETLIGHT HARDWARE

SPECIFICATIONS FOR STREETLIGHT HARDWARE

SPECIFICATIONS FOR STREETLIGHT HARDWARE

PHOTO CONTROL: TWIST-LOCK RECEPTACLE (eye by others)

FASTENERS: STAINLESS STEEL

OFFICE OF TRAFFIC & SAFETY
TRAFFIC ENGINEERING DESIGN DIVISION

MD 355 BUS RAPID TRANSIT (BRT)

REVISIONS	PEDESTRIAN LIGHT POLE DETAILS						
	SCALE 1" = 30'	DATE	12 / 2022	C	ONTRACT NO		
	DESIGNED BY DRAWN BY CHECKED BY MDE/PRD <	LHT SJW	_	TIMS NO.	MONTG0 150355	06.51	
	DRAWING NO.	LT -	04 OF	4	SHEET NO. 8	87 OF 887	

design design

T3 DESIGN
CORPORATION
10340 DEMOCRACY LN
SUITE 305
FAIRFAX, VA 22030
PHONE: 703-359-5861
www.t3design.us

PLAN SYMBOLS LEGEND

PROPOSED LED LUMINAIRE -

COLONIAL POST TOP, FIBERGLASS POLE

△ POLE & LUMINAIRE DETAILS

PLOTTED: 11/17/2022
FILE: pw:\\stantec-sc-pw.bentley.com:stantec-sc-pw-02\Documents\2026213106\700 CADD\713 Lighting T3\pLT-P04_Ped Lighting.dgn