DRAINAGE STATEMENT

I understand that DPS approval of this sediment control/stormwater management plan is for demonstrated compliance with required environmental runoff treatment standards. This DPS sediment control/stormwater management plan approval does not relieve me of professional responsibility. I have analyzed the proposed design for sediment control permit no. 294883 and hereby certify that, based upon my background, training and experience, I have determined that the proposed improvements shown on this plan meet relevant laws and regulations. I further acknowledge that I have analyzed the post development drainage patterns for this project from the standpoint of my responsibilities under current Maryland Law and have determined that if permission is required from adjacent property owners, I have obtained it and have made copies of those permissions available to DPS.

Jo J	8/14/2024
Engineer's Signature	Date
Michael W. Mercado, P.E.	

applicable exemption category below.

FOREST CONSERVATION PLAN SHEET - 2

18

Printed Name

TREE CANOPY REQUIREMENTS TABLE To be completed by the consultant and placed on the first sheet of the Sediment Control / Stormwater Management plan set for all projects. Exempt: Yes \square No \square If exempt under Section 55-5 of the Code, please check the

Total Property Area	Total Disturbed Area		
146,165 square feet	10,776square feet		
Shade Trees Required	Shade Trees Proposed to be Planted		
9	0		
Fee in Lieu (Trees Required – Trees Planted) x \$250	\$ 2,250		

Required Number of Shade Trees

ne	equired Number of	Shade frees	
Area (sq. of Disturb	ft.) of the Limits ance	Number of Shade Trees Required	
FROM 1 6,001 8,001 12,001 14,001	<u>TO</u> 6,000 8,000 12,000 14,000 40,000	3 6 9 12 15	

If the square footage of the limits of disturbance is more than 40,000, then the number of shade trees required must be calculated using the following formula:

(Number of Square Feet in Limits of Disturbance $\div 40,000$) × 15

EXEMPTION CATEGORIES:

☐ 55-5(a) any activity that is subject to Article II of Chapter 22A;
☐ 55-5(b) any commercial logging or timber harvesting operation with an approved exemption from Article II of Chapter 22A;
55-5(f) any activity conducted by the County Parks

existing access road, if the person performing the


naintenance has obtained all required permits 55-5(h) any stream restoration project if the person performing the work has obtained all necessary permits;

55-5(i) cutting or clearing any tree to comply with applicable provisions of any federal, state, or local law Department; overning safety of dams; 55-5(g) routine or emergency maintenance of an OTHER: Specify per Section 55-5 of the Code. existing stormwater management facility, including an

MONTGOMERY COUNTY DEPARTMENT OF TRANSPORTATION

AUTH LANE TO KERSEY ROAD PEDESTRIAN BRIDGE

C. I. P. PROJECT NO. 0502505

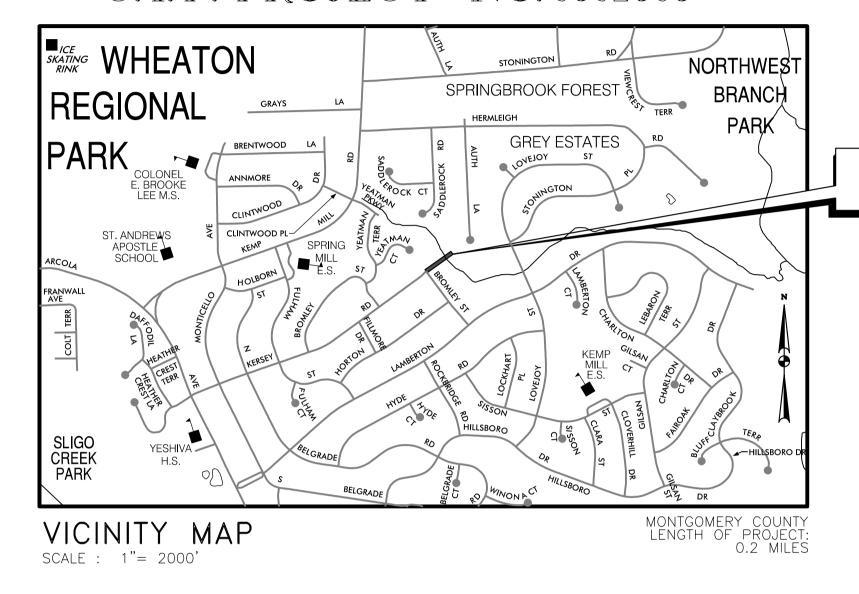

OWNER'S / DEVELOPER'S CERTIFICATION

I/We hereby certify that all clearing, grading, construction, and or development will be done pursuant to this plan and that any responsible personnel involved in the construction project will have a Certificate of Attendance at a Department of Natural Resources approved training program for the control of sediment and erosion before beginning the project.

8/19/2024	Jose Thommana
DATE	JOSE THOMMANA
	CHIEF, DIVISION OF TRANSPORTATION ENGINEERING

DESIGN CERTIFICATION

I hereby certify that this plan has been prepared in accordance with the "2011 Maryland Standards and Specification for Soil Erosion and Sediment Control," Montgomery County Department of Permitting Services Executive Regulations 5-90, 7-02AM and 36-90, and Montgomery County Department of Public Works and Transportation "Storm Drain Design Criteria" dated August 1988.

8/14/2024	of of
DATE	MICHAEL MERCADO, P.E. MERCADO CONSULTANTS, INC.

CERTIFICATION OF THE QUANTITIES

I hereby certify that the estimated total yards of excavation and fill as shown on this plan has been computed to 13.5 cubic yards of excavation, 13 cubic yards of fill and the total area to be disturbed as shown on these plans has been determined to be 10,776 square feet.

Jo J	8/14/2024
SIGNATURE	DATE
MICHAEL MERCADO, P.E.	38931
PRINTED NAME AND TITLE	REGISTRATION NUMBER

•	NO.	REVISION	DATE	BY	PROFESSIONAL CERTIFICATION:
					THE ESSISTANCE SETTING MISTA.
					I HEREBY CERTIFY THAT THESE DOCUMENTS WERE PREPARED OR APPROVED BY ME, AND THAT I AM A DULY LICENSED
MERCADO					PROFESSIONAL ENGINEER UNDER THE LAWS OF THE STATE
CONSULTANTS, INC.					OF MARYLAND.
					LICENSE NO: 38931 EXPIRATION DATE: 12-22-2025

RELATED REQUIRED PERMITS						
	IT IS THE RESPONSIBILTY OF PERMITTEE/OWNER OF THIS SITE TO OBTAIN ALL REQUIRED PERMITS PRIOR TO ISSUANCE OF THE APPROVED SEDIMENT CONTROL PERMIT					
TYPE OF PERMIT	REQD	NOT REQD	PERMIT #	EXPIRATION DATE	WORK RESTRICTION DATES	
MCDPS Floodplain District	X		405163			
WATERWAYS/WETLAND(S):						
o. Corps of Engineers	X		24-NT-3083/202460773	08/23/2029	March 1 through May 31	
b. MDE	X		24-NT-3083/202460773	08/23/2029	March 1 through May 31	
c. MDE Water Quality Certification		X				
MDE Dam Safety		X				
* DPS Roadside Trees Protection Plan	X		MCDOT BLANKET PERMIT NO. 361405	Approval Date		
N.P.D.E.S. NOTICE OF INTENT		X			DATE FILED	
FEMA LOMR (Required Post Construction)		X				
OTHERS:						
DPS Erosion and Sediment Control	X		294883			
MNCPPC Permit		X				
* A copy of the Roadside T	rees Protecti	on Plan mus	t be delivered to the sedimer	nt control inspector at the	e preconstruction meeting.	
OWNER / PERMIT APPLICANT INFORMATION						

MONTGOMERY COUNTY DEPARTMENT OF TRANSPORTATION

100 EDISON PARK DRIVE 4th FLOOR, GAITHERSBURG, MD 20878 (240) 777-7207

SEQUENCE OF CONSTRUCTION

CONTACT PERSON: RASHID ABRAMOV, P.E.

I. SEE SHEET SCOOO3 FOR SEQUENCE OF CONSTRUCTION.

GENERAL NOTES

- ALL CONSTRUCTION SHALL BE DONE IN ACCORDANCE WITH THE LATEST EDITION OF THE STANDARD SPECIFICATIONS OF THE MARYLAND STATE HIGHWAY ADMINISTRATION AND MONTGOMERY COUNTY DESIGN STANDARDS.
- INFORMATION CONCERNING UNDERGROUND UTILITIES WAS OBTAINED FROM AVAILABLE RECORDS, BUT THE CONTRACTOR MUST DETERMINE THE EXACT LOCATIONS AND ELEVATIONS OF THE LINES BY DIGGING TEST PITS BY HAND AT ALL UTILITY CROSSINGS, WELL IN ADVANCE OF TRENCHING. IF CLEARANCES ARE LESS THAN SHOWN OR SIX (6) INCHES, WHICHEVER IS LESS, CONTACT MONTGOMERY COUNTY DEPARTMENT OF TRANSPORTATION'S PROJECT INSPECTOR AND THE APPROPRIATE UTILITY OWNER BEFORE PROCEEDING WITH
- REPAIRS TO UTILITIES OR PROPERTY DAMAGE AS A RESULT OF THE CONTRACTOR'S NEGLIGENCE OR METHOD OF OPERATION MUST BE MADE AT THE CONTRACTOR'S EXPENSE BEFORE PROCEEDING WITH CONSTRUCTION.
- CALL "MISS UTILITY" AT 1-800-257-7777 FORTY-EIGHT (48) HOURS PRIOR TO BEGINNING
- EXCAVATION TO DETERMINE THE EXACT LOCATION OF EXISTING UTILITIES. CLEARING IS TO BE LIMITED TO THE "LIMIT OF GRADING" AS SHOWN ON THE PLANS.
- ALL GRADING SHALL BE DONE IN SUCH A MANNER AS TO PROVIDE POSITIVE DRAINAGE. ALL DISTURBED AREAS SHALL BE SEEDED AND MULCHED UNLESS OTHERWISE NOTED. THE CONTRACTOR SHALL OBTAIN A ROADSIDE TREE PERMIT FOR ANY MAINTENANCE,
- TREATMENT, PLANTING, REMOVAL, OR ROOT CUTTING ON TREES WITHIN THE PUBLIC RIGHT OF WAY. PERMIT REQUIREMENTS MAY BE OBTAINED FROM THE DEPARTMENT OF NATURAL
- RESOURCES, MARYLAND FOREST, PARK AND WILDLIFE SERVICE, TELEPHONE 301-854-6060. FOR CONSTRUCTION, ALL HORIZONTAL AND VERTICAL CONTROLS SHALL BE NAD 83 (2007) AND NAVD 88 DATUM

RECORD DRAWING CERTIFICATION

A record set of approved Sediment Control/Stormwater Management plans must be maintained on-site at all times. In addition to stormwater management items, these plans must include the number and location of all trees proposed to be planted to comply with the Tree Canopy Law. Any approved modifications of deletions of tormwater practices or tree canopy plantings or information must be shown on this record set of plans and on the Tree Canopy Requirements table. Upon completion the project, this record set of plans, including hereon this signed Record Drawing Certification, must be submitted to the MCDPS inspector. In addition to this Record Drawing Certification, a formal Stormwater Management As-Built submission [] is required | is not required for this project.

this project is subject to a Stormwater Records at:	Management Right of Entry and Maintenance Agreement, that document is recorded in Montgomery County Land	
iber N/A Folio N/A	This Record Drawing will serve as referenced in the recorded document.	
	letely represents the stormwater management practices and tree canopy plantings as they were constructed or planted. A onstructed per the approved Sediment Control / Stormwater Management plans or subsequent approved revisions."	Ш
No Signature Required	N/A	
)wner/Developer Signature	Date	

TECHNICAL REVIEW OF DPS APPROVAL OF A SEDIMENT CONTROL OR STORMWATER ADMINISTRATIVE REVIEW MANAGEMENT PLAN IS FOR DEMONSTRATED COMPLIANCE WIT SEDIMENT CONTROL MINIMUM ENVIRONMENTAL RUNOFF TREATMENT STANDARDS AND DOES NOT CREATE OR IMPLY ANY RIGHT TO DIVERT O CONCENTRATE RUNOFF ONTO ANY ADJACENT PROPERTY WITHOUT THAT PROPERTY OWNER'S PERMISSION. IT DOES NOT RELIEVE THE DESIGN ENGINEER OR OTHER RESPONSIBL PERSON OF PROFESSIONAL LIABILITY OR ETHICAL Bill Musico 09/02/24 Bill Musico 09/02/24 RESPONSIBILITY FOR THE ADEQUACY OF THE DRAINAGE DESIGN AS IT AFFECTS UPHILL OR DOWNHILL PROPERTIES REVIEWED REVIEWED DATE 294883 TECHNICAL REVIEW OF SMALL LOT STORMWATER MANAGEMENT DRAINAGE APPROVAL SEDIMENT CONTROL PERMIT NO. N/A: ☒ OR NO SWM 09/02/24 Bill Musico SM. FILE NO. Bill Musico 09/02/24 STORMWATER MANAGEMENT REVIEWED DATE REVIEWED DATE No SWM - No Waivers MCDPS APPROVAL OF THIS PLAN WILL EXPIRE NOTE: MCDPS APPROVAL DOES NOT NEGATE THE NEED FOR A MCDPS ACCESS PERMIT. TWO YEARS FROM THE DATE OF APPROVAL

IF THE PROJECT HAS NOT STARTED.	7, 100	
MONTGOMERY COUNTY DEPARTMENT OF	TRANSPORTATION	
DIVISION OF TRANSPORTATION ENG	GINEERING	
GAITHERSBURG, MARYLANE		
RECOMMENDED FOR APPROVAL		
Daniel M. Sherida	August 19, 2024	
Chief, Design Section	Date	

FIELD CHECK OF RECORD DRAWING BY MCDPS INSPECTOR: INITIALS:

AUTH LANE TO KERSEY ROAD PEDESTRIAN BRIDGE


TITLE SHEET

August 19, 2024 SCALE : AS SHOWN DATE: JULY, 2024 Chied, Division of Transportation Engineering Project No.: 0502505 SHEET 1 of 18 Designed by : MWM Drawn by :__NL Checked by : MWM

Digitally signed by Michael Mercado DN: cn=Michael Mercado, c=US, o=Mercado Consultants, Inc., ou=Mercado Consultants, Inc., email=mmercado@mercadoeng.com Date: 2024.09.03 11:39:59 -04'00'

PROJECT

LOCATION

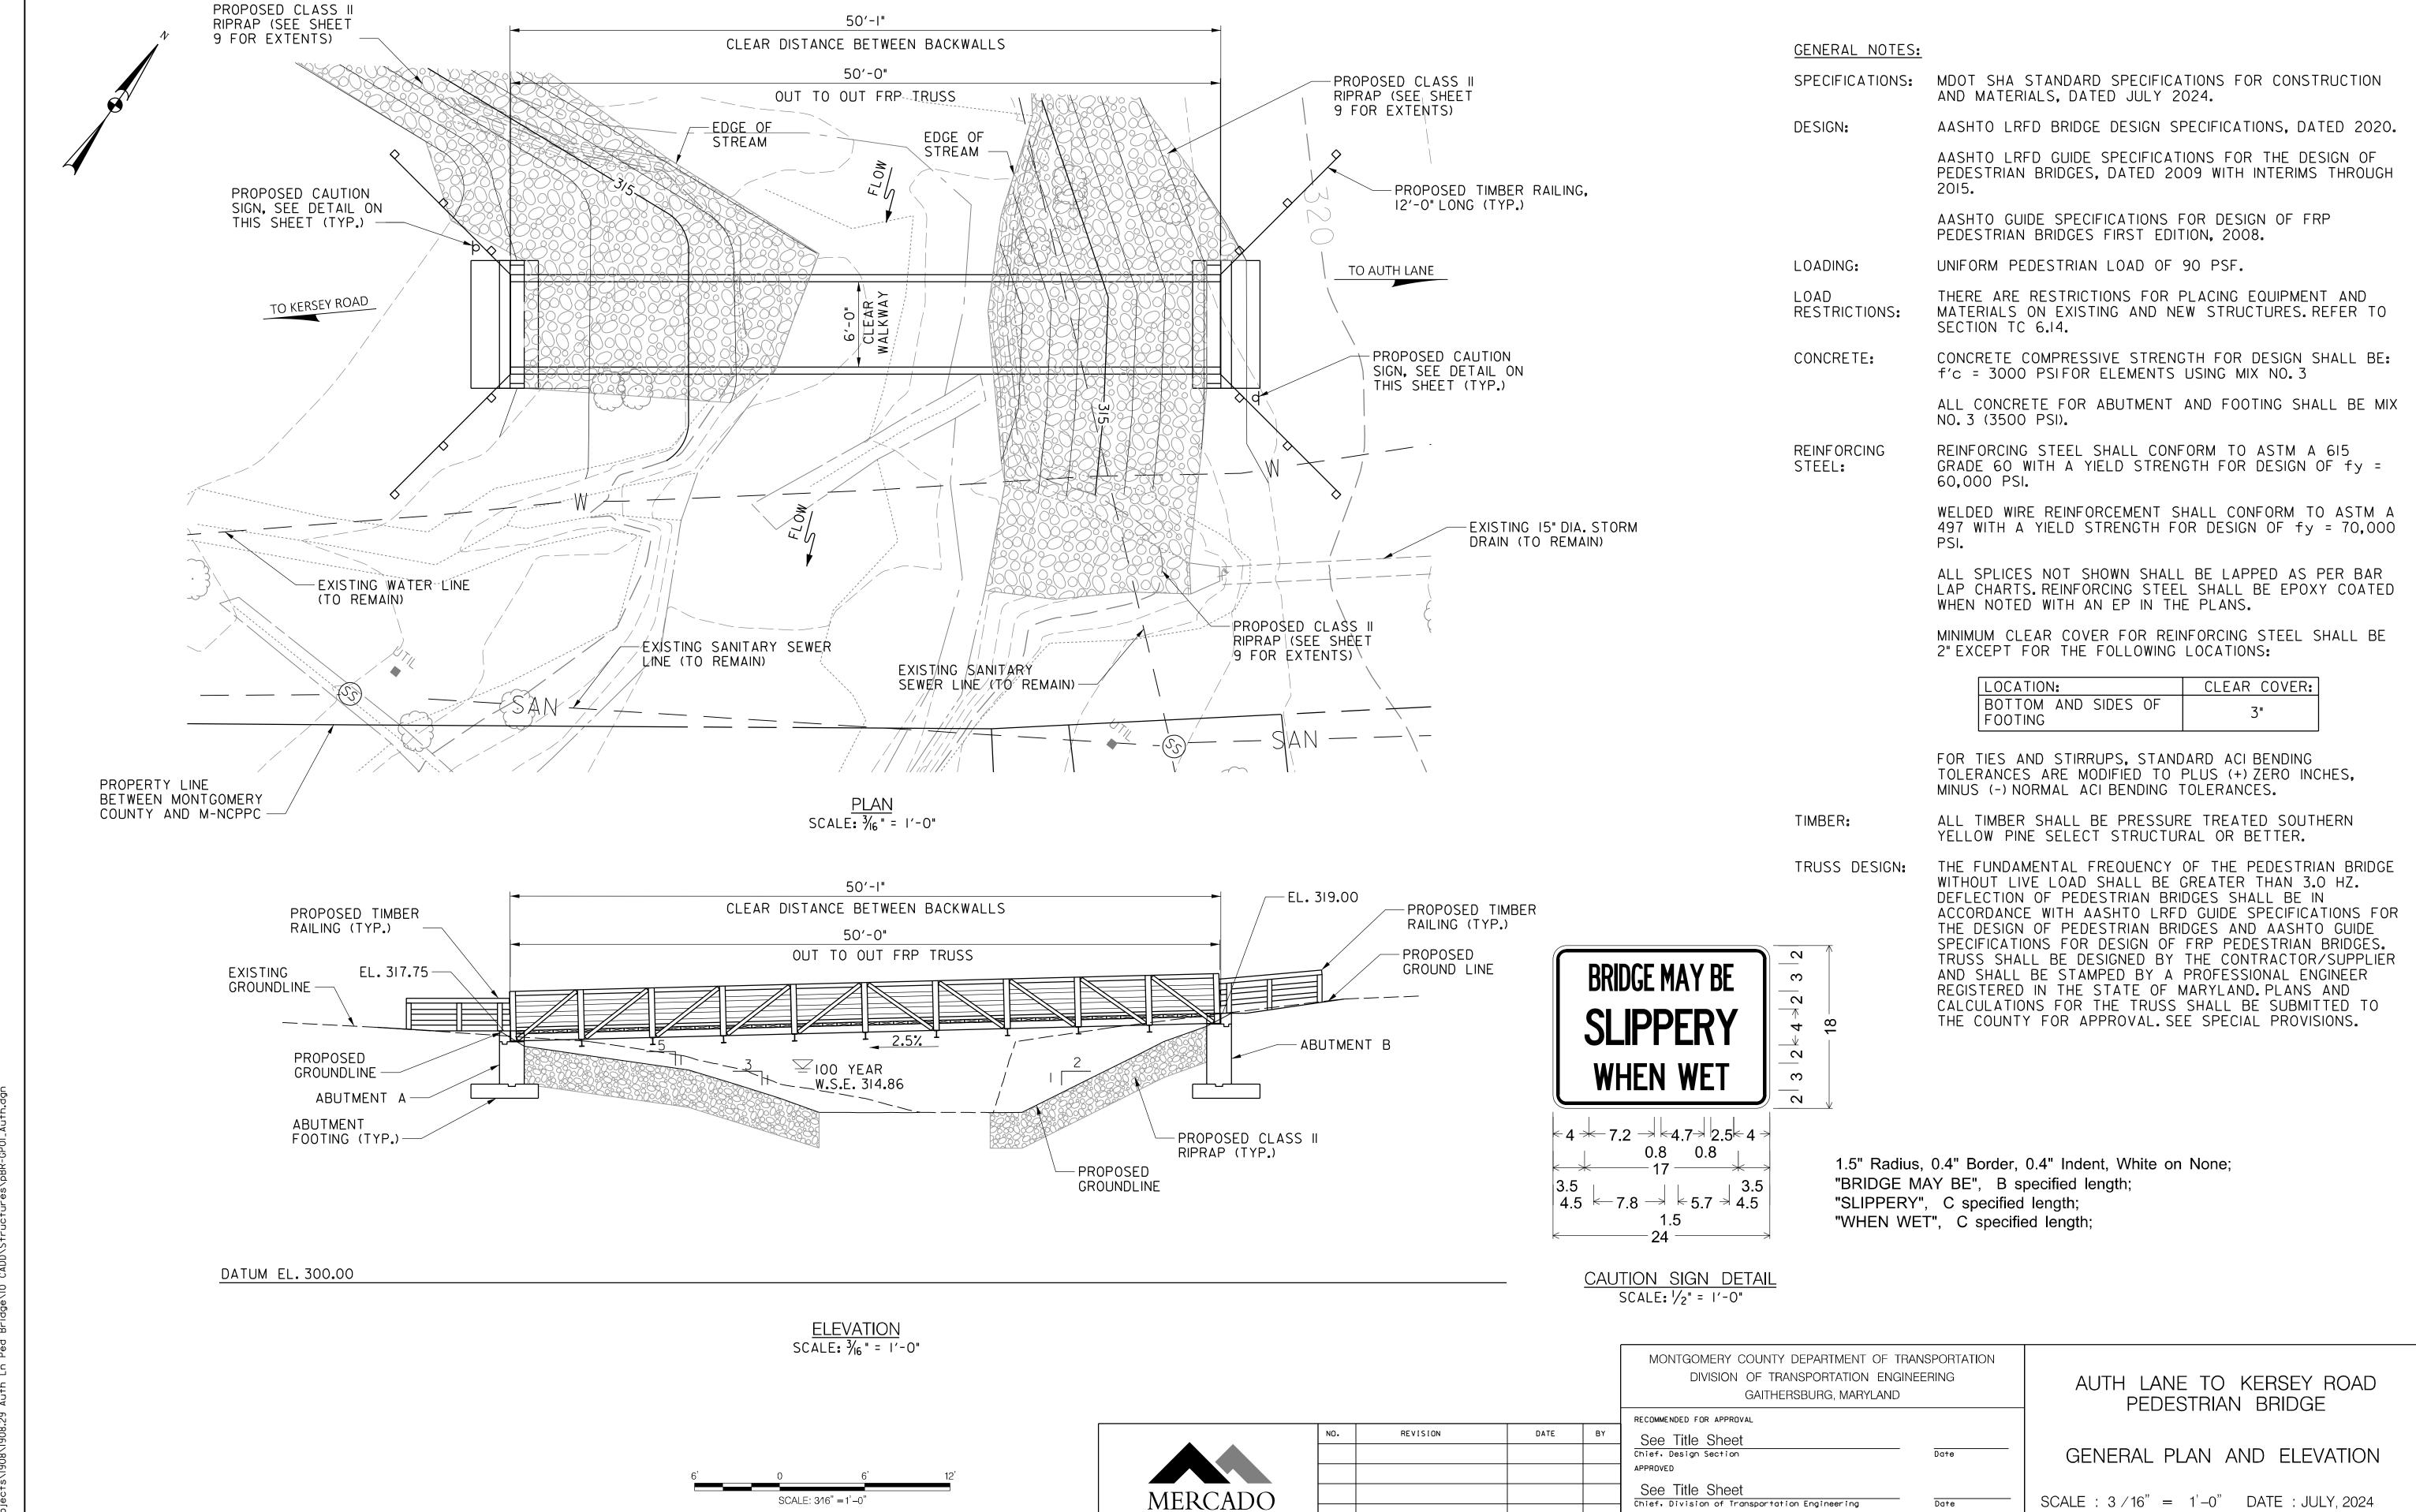


CONSULTANTS, INC.

Project No. : 0502505 SHEET 2 of 18

Designed by : MR Drawn by : MR

Checked by : __MWM

8/14/2024

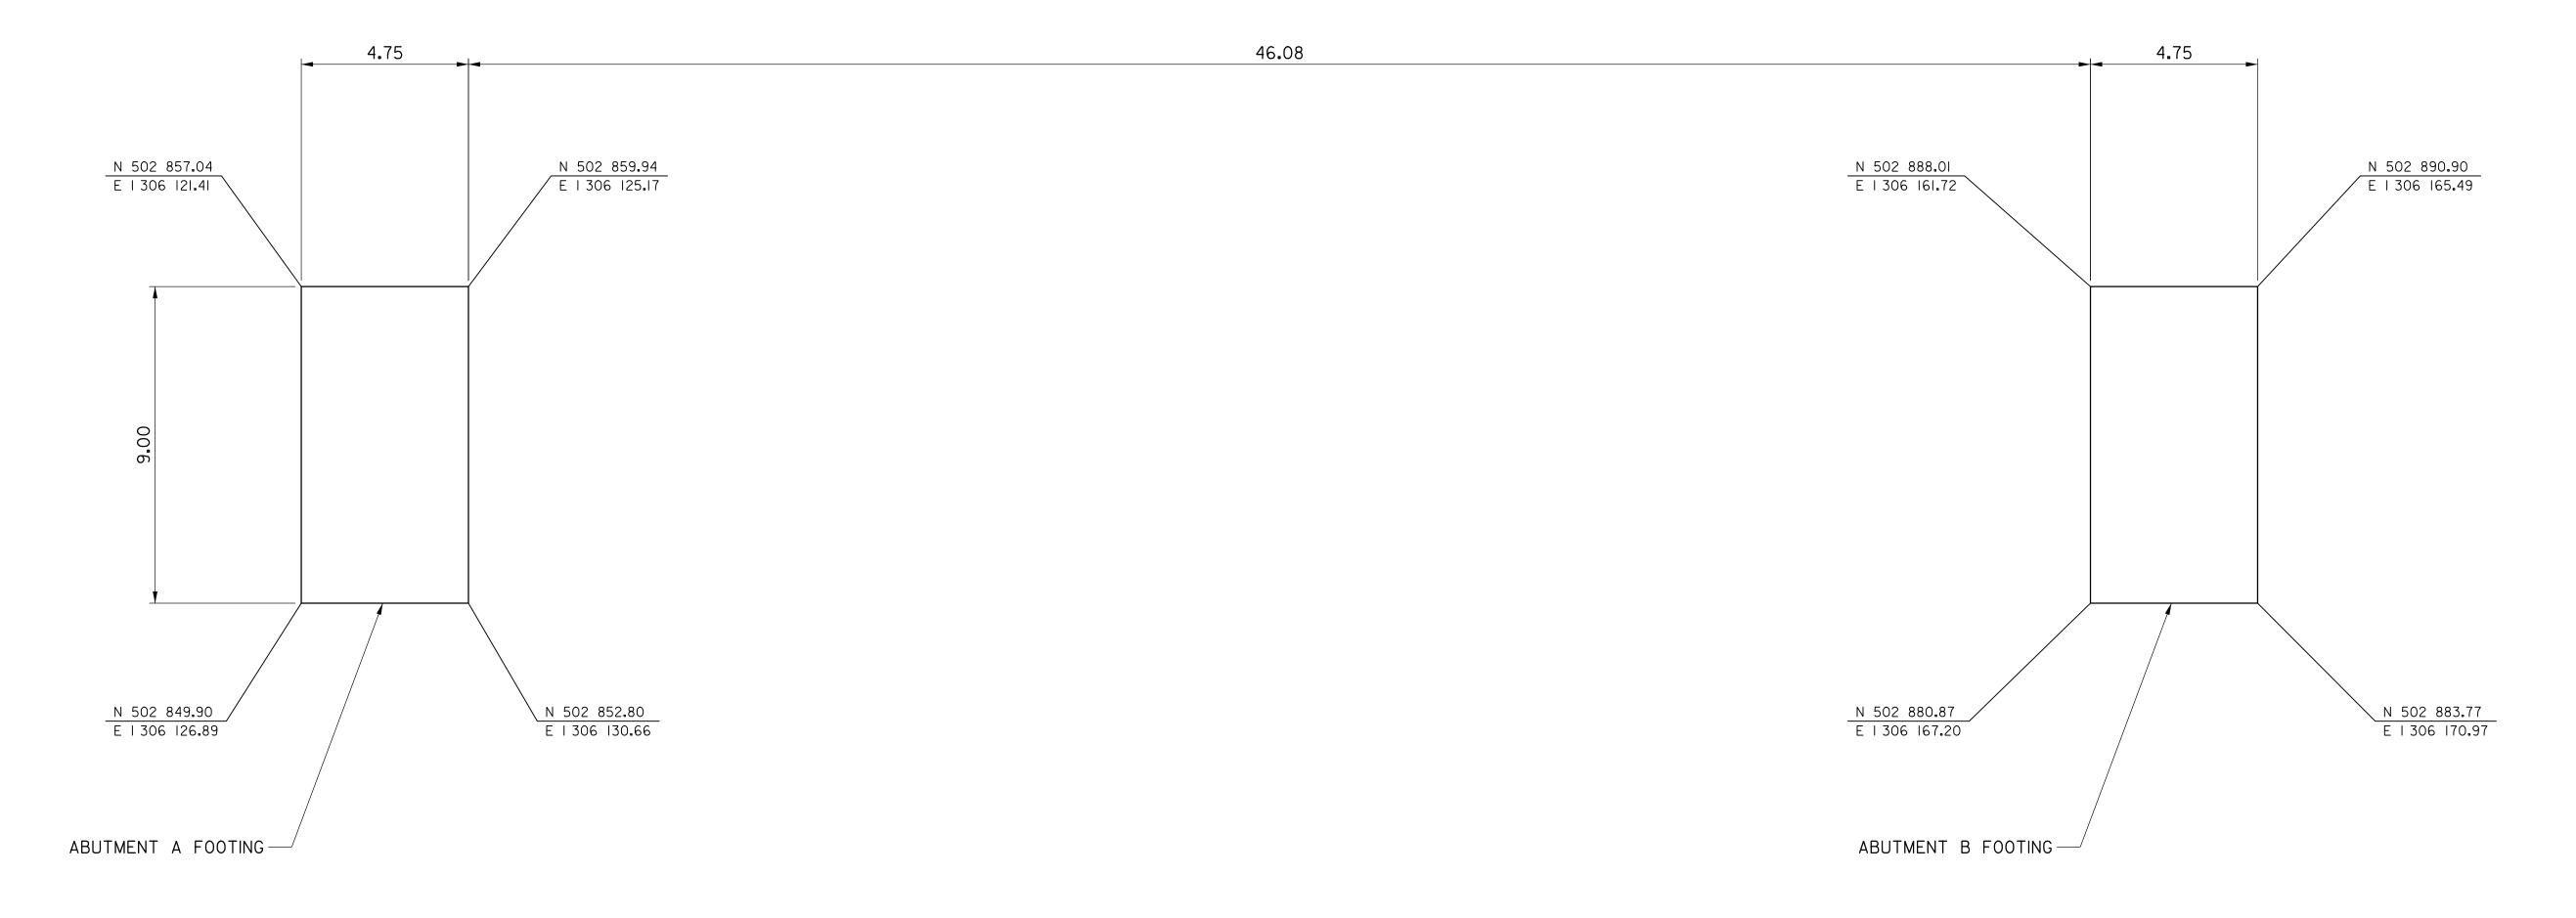

PLAN - GEOMETRIC LAYOUT SCALE: 3/8" = 1'-0"

NO. REVISION DATE BY

MERCADO

CONSULTANTS, INC.

GAITHERSBURG, MARYLAND

RECOMMENDED FOR APPROVAL

See Title Sheet
Chief, Design Section
APPROVED

See Title Sheet
Chief, Division of Transportation Engineering

Date

S

Checked by : <u>MWM</u>

MONTGOMERY COUNTY DEPARTMENT OF TRANSPORTATION
DIVISION OF TRANSPORTATION ENGINEERING

Designed by : MR Drawn by : MR

AUTH LANE TO KERSEY ROAD PEDESTRIAN BRIDGE


GEOMETRIC LAYOUT

SCALE: 3/8" = 1'-0" DATE: JULY, 2024

Project No.: 0502505 SHEET 3 of 18


/2024 ·ojects\l908\l908.29 Auth Ln Ped Brid


4 '	0	Δ'	8
	<u> </u>		
	SCALE: 3/	⁄8" =1'-0"	

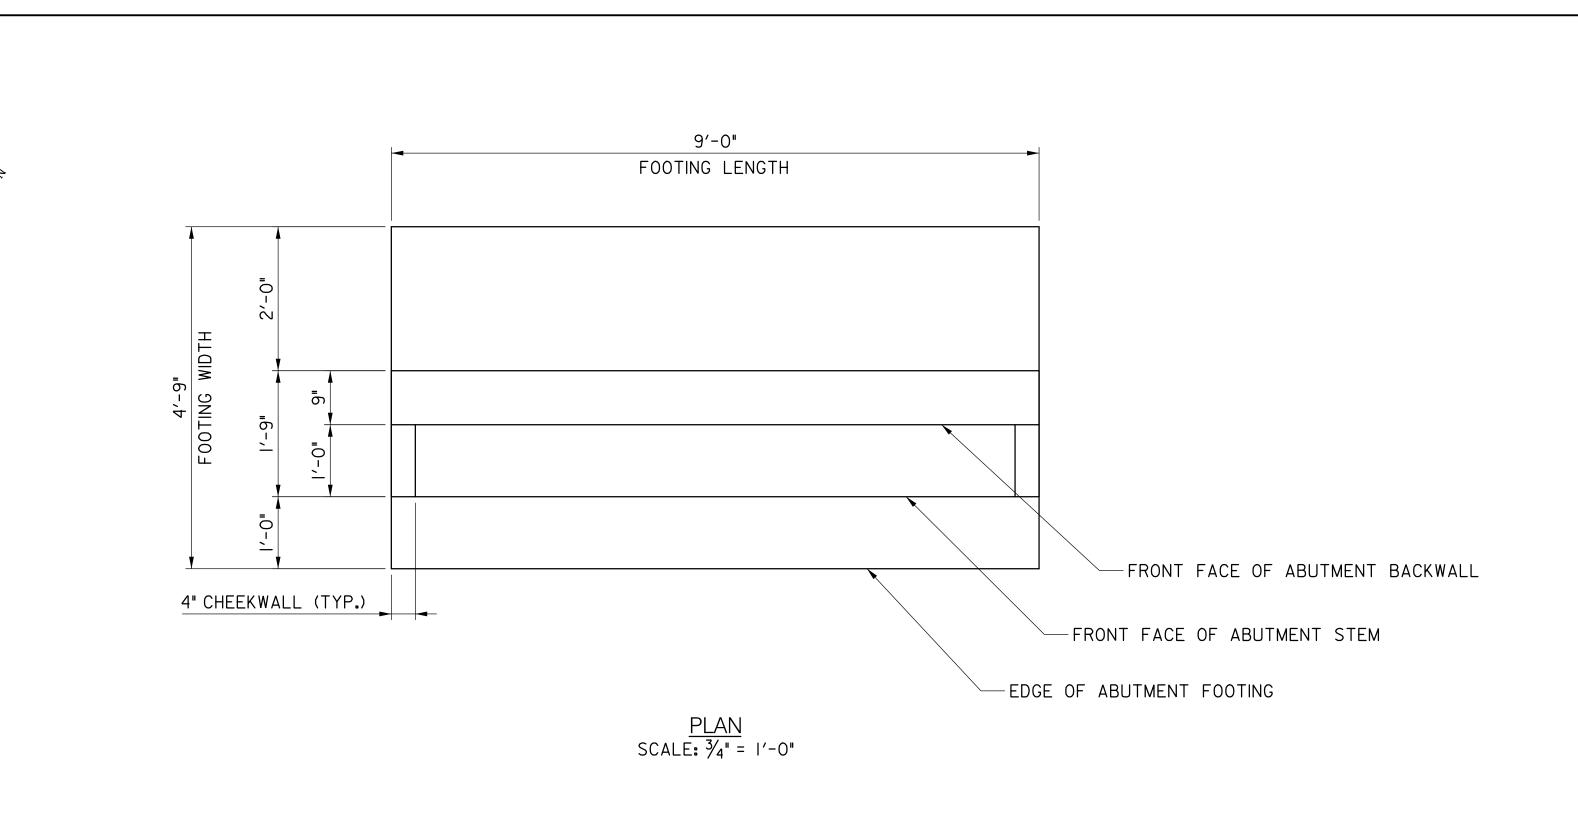

NOTES:

I. TOP OF ABUTMENT SEAT ELEVATION SHALL BE COORDINATED WITH FRP BRIDGE MANUFACTURER AND MAY VARY FROM THE ELEVATION SHOWN ON THIS SHEET.

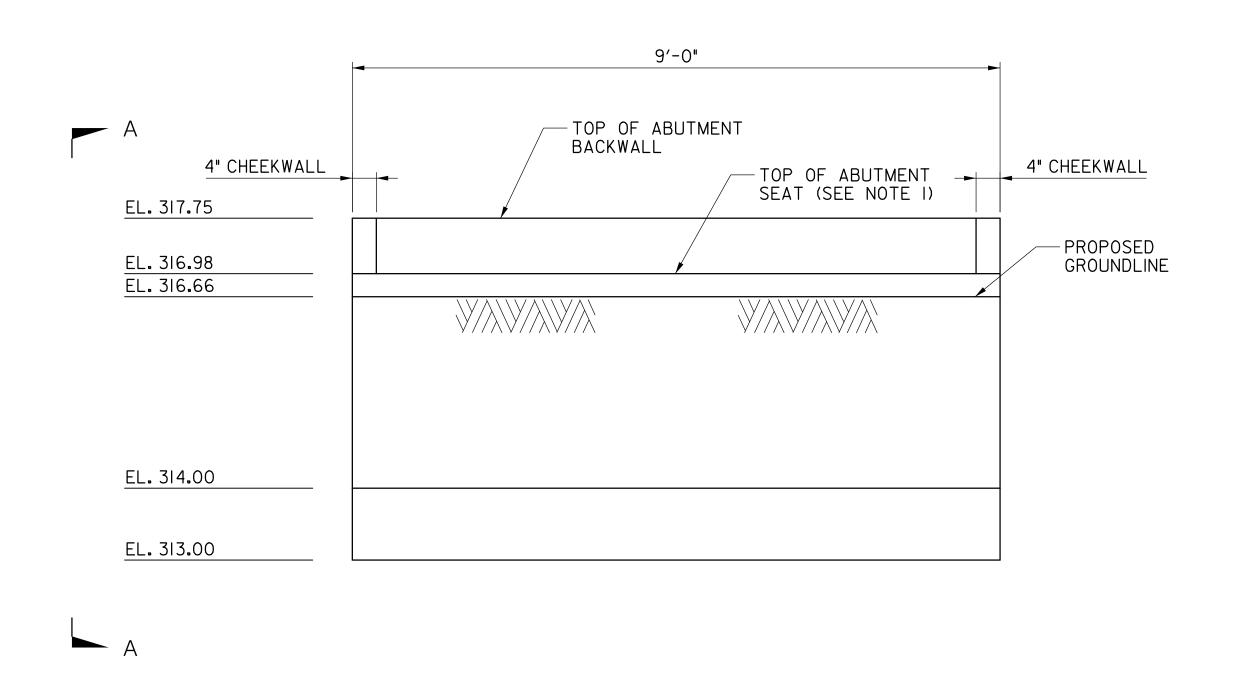

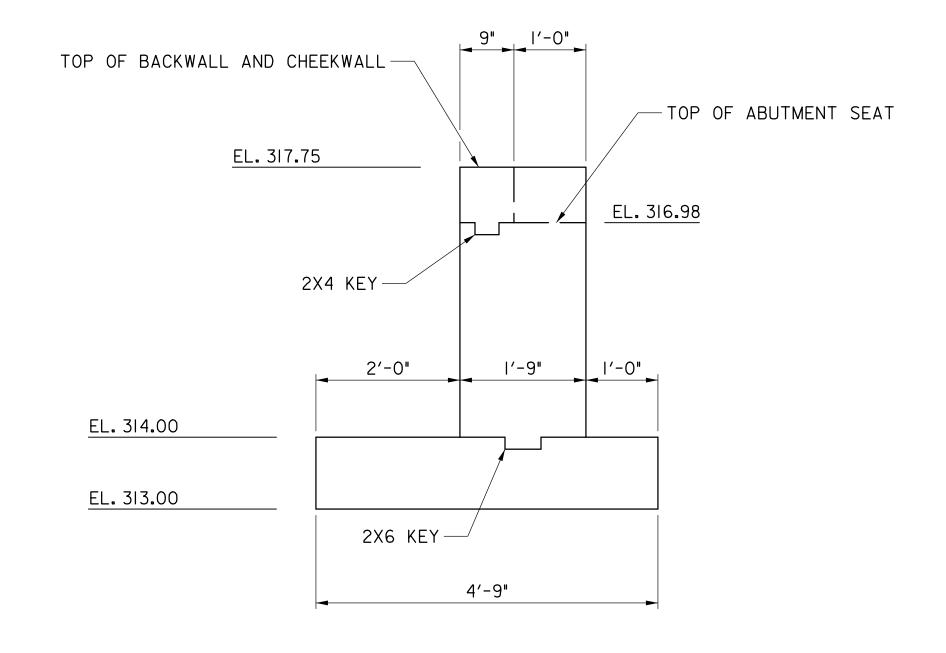

 $\frac{\text{VIEW A--A}}{\text{SCALE: } \frac{3}{4}" = 1'-0"}$

MONTGOMERY COUNTY DEPARTMENT OF TRANSPORTATION

ELEVATION
SCALE: 3/4" = 1'-0"

					DIVISION OF TRANSPORTATION ENG GAITHERSBURG, MARYLAND	
					RECOMMENDED FOR APPROVAL	
A .	NO.	REVISION	DATE	BY	See Title Sheet	
					Chief, Design Section	Date
					APPROVED	
					See Title Sheet	
MERCADO					Chief, Division of Transportation Engineering	Date
CONSULTANTS, INC.					Designed by : MR Drawn by : MR	Checked by :MWM


AUTH LANE TO KERSEY ROAD PEDESTRIAN BRIDGE

ABUTMENT A PLAN & ELEVATION

SCALE : 3/4" = 1'-0" DATE : JULY, 2024


DATUM 310.00

Project No. : 0502505 SHEET 4 of 18

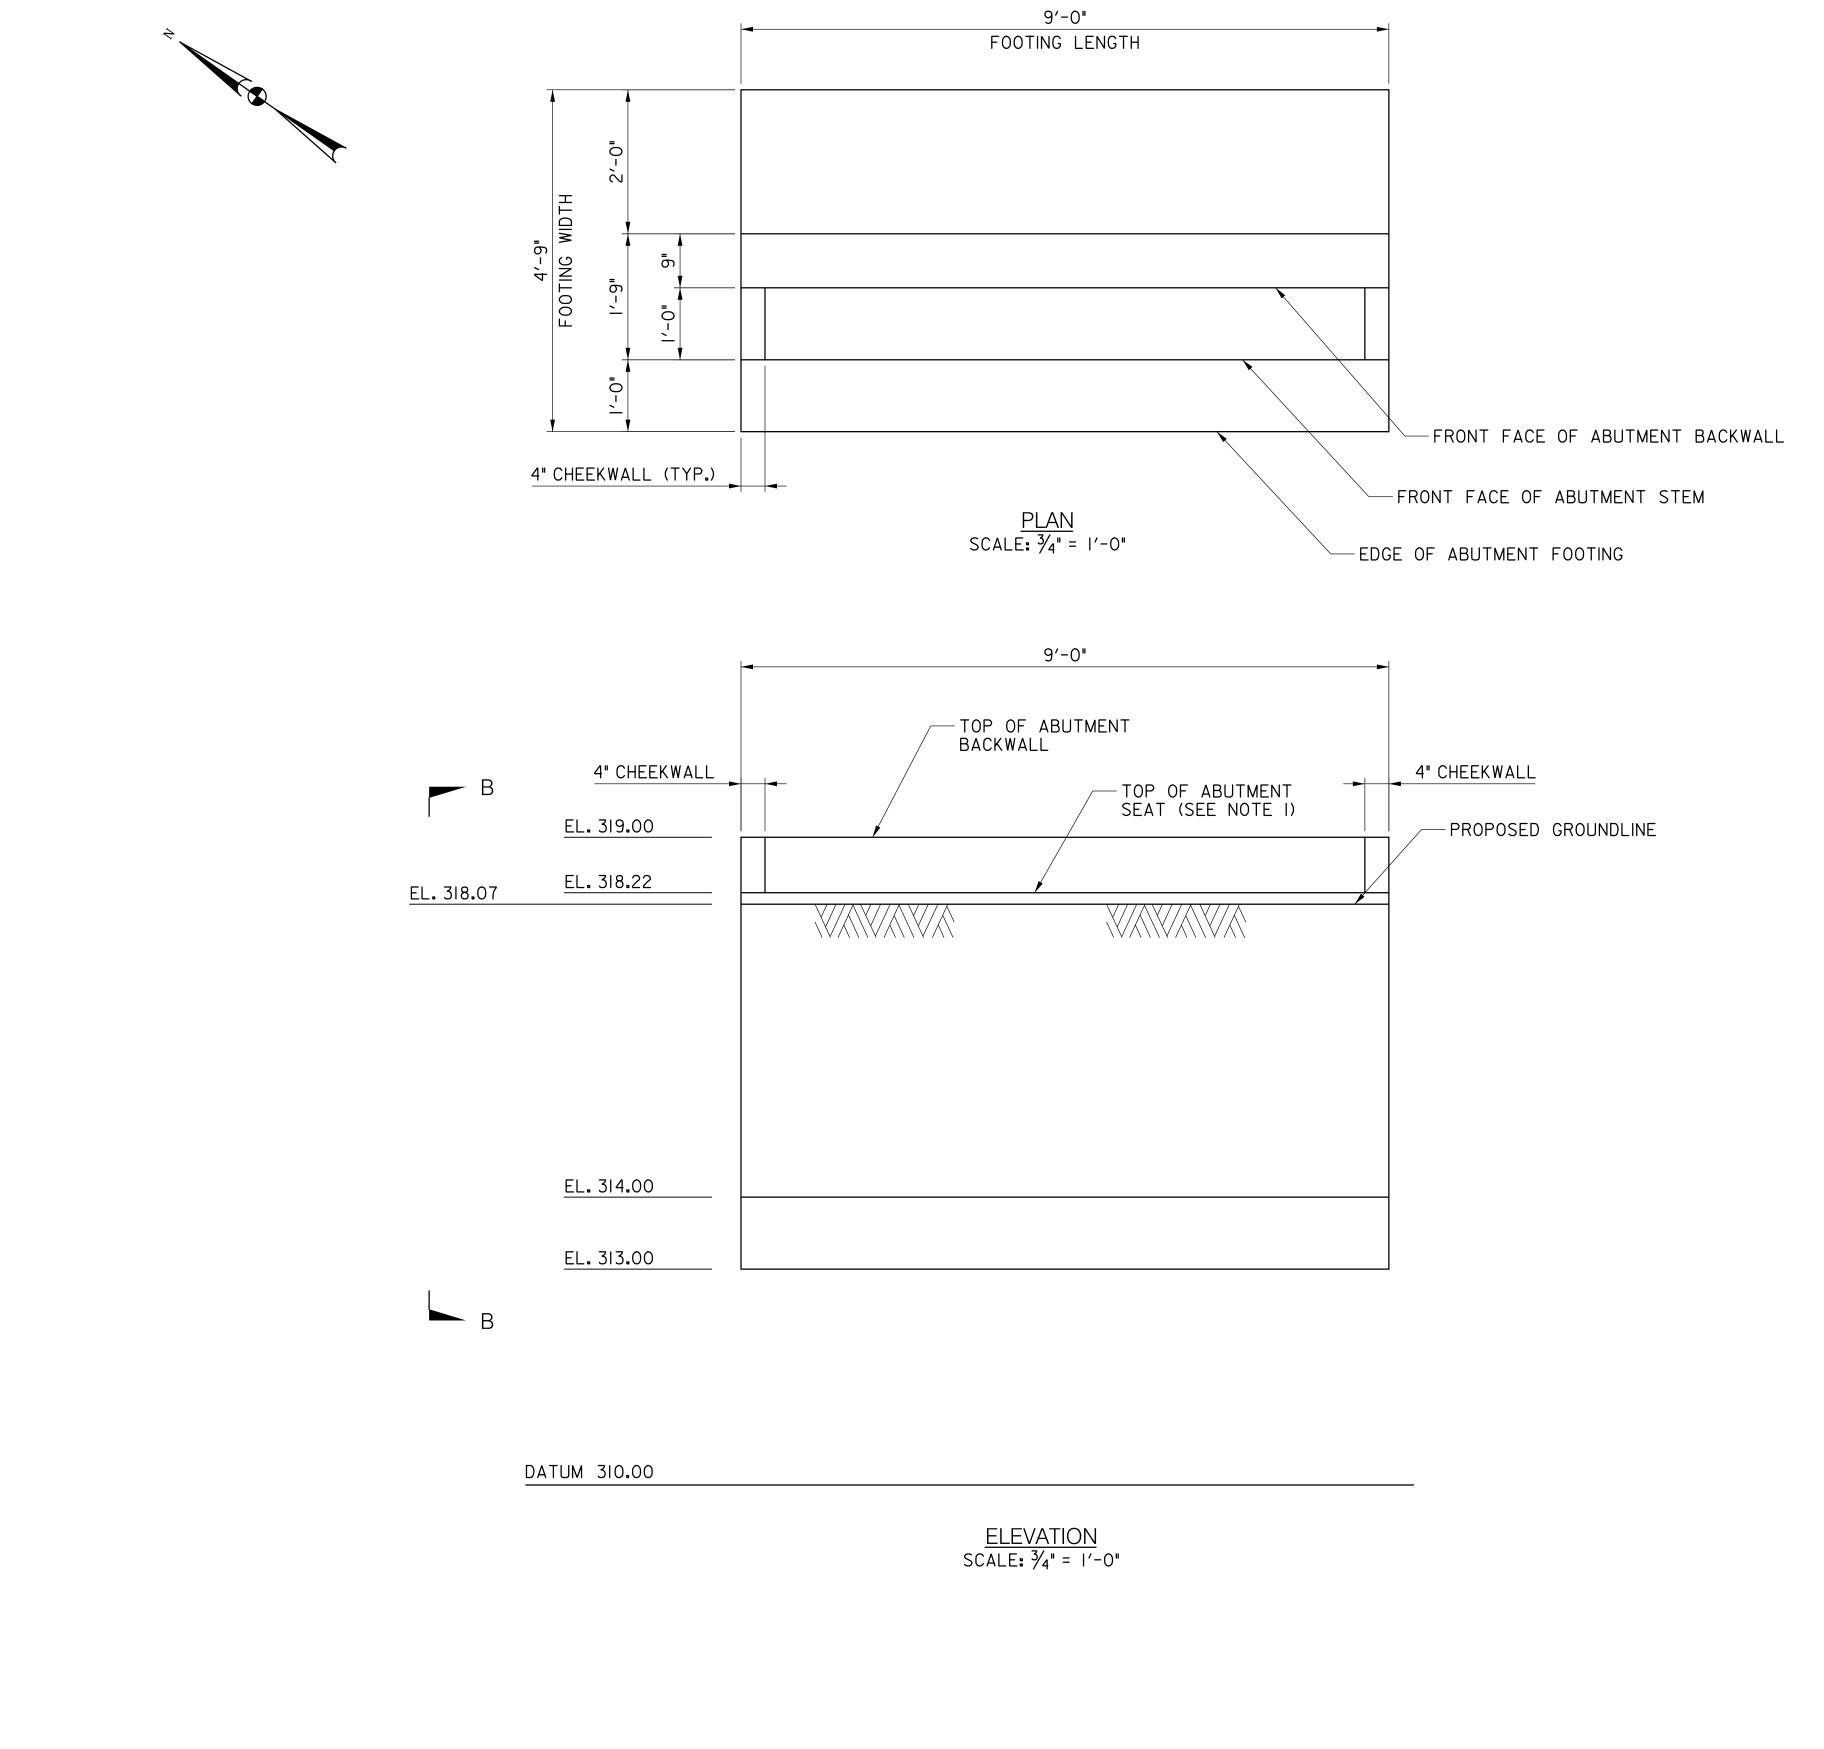

NOTES:

I. TOP OF ABUTMENT SEAT ELEVATION SHALL BE COORDINATED WITH FRP BRIDGE MANUFACTURER AND MAY VARY FROM THE ELEVATION SHOWN ON THIS SHEET.

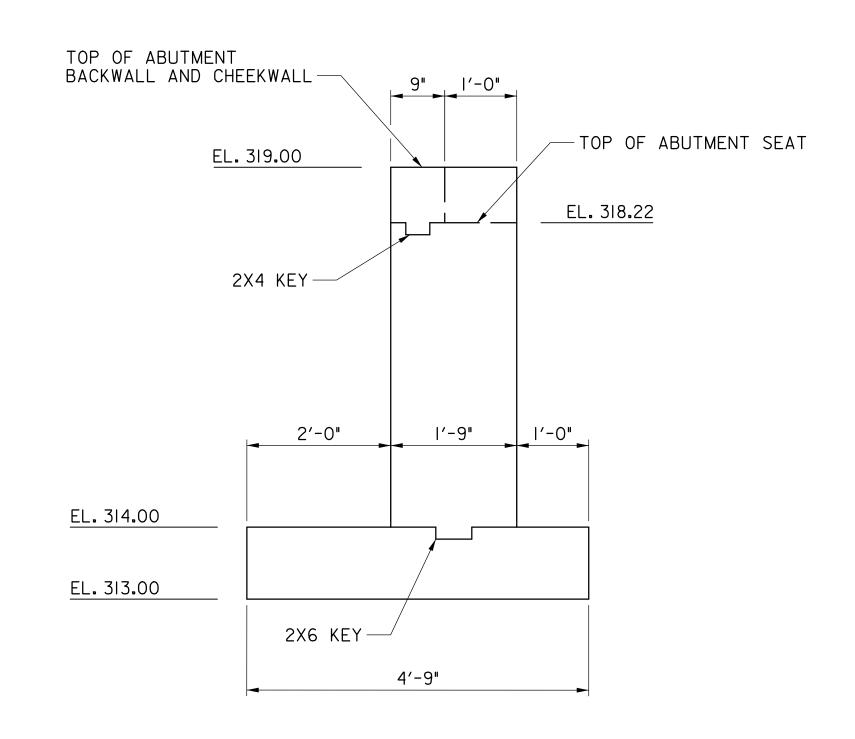

VIEW B-B SCALE: 3/4" = 1'-0"

MONTGOMERY COUNTY DEPARTMENT OF TRANSPORTATION

			DIVISION OF TRANSPORTATION ENG GAITHERSBURG, MARYLANI		
			RECOMMENDED FOR APPROVAL		
REVISION	DATE	BY	See Title Sheet Chief, Design Section APPROVED	Date	
			See Title Sheet Chief, Division of Transportation Engineering		SC
			Designed by : MR Drawn by : MR	Checked by :MWM	Pro


AUTH LANE TO KERSEY ROAD PEDESTRIAN BRIDGE


ABUTMENT B PLAN & ELEVATION


SCALE : 3/4" = 1'-0" DATE : JULY, 2024


MERCADO CONSULTANTS, INC.

Project No. : 0502505 SHEET 5 of 18

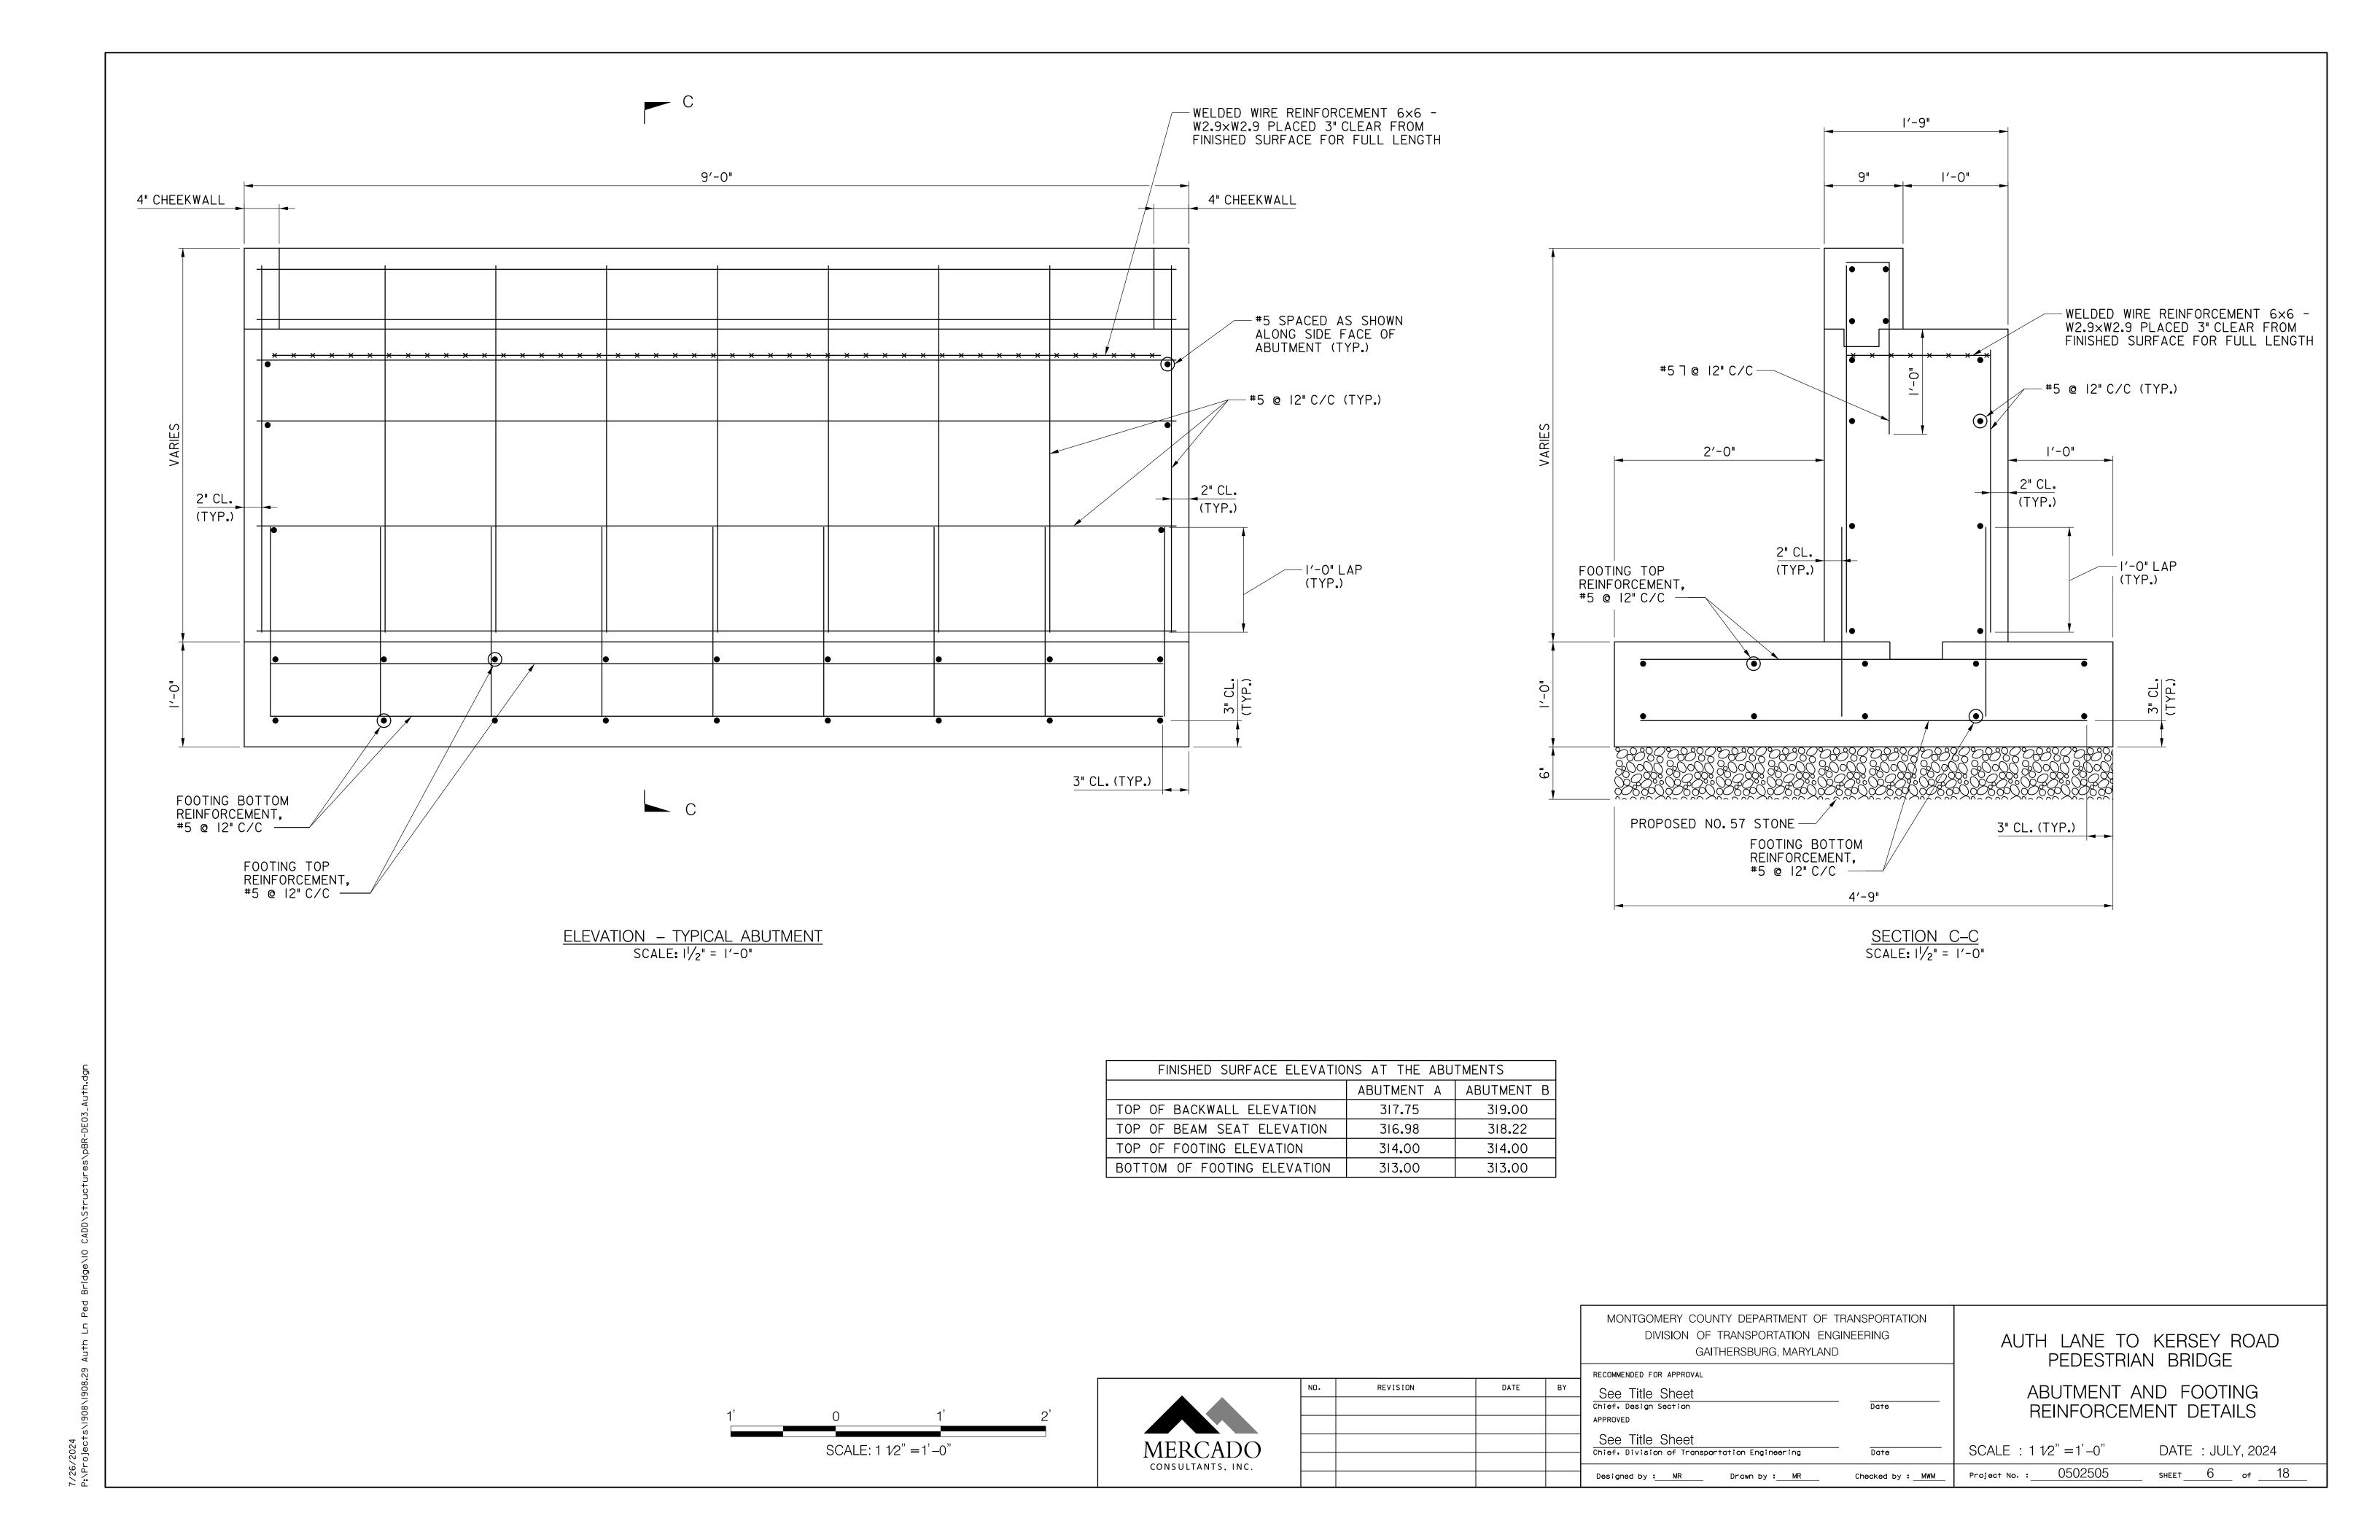

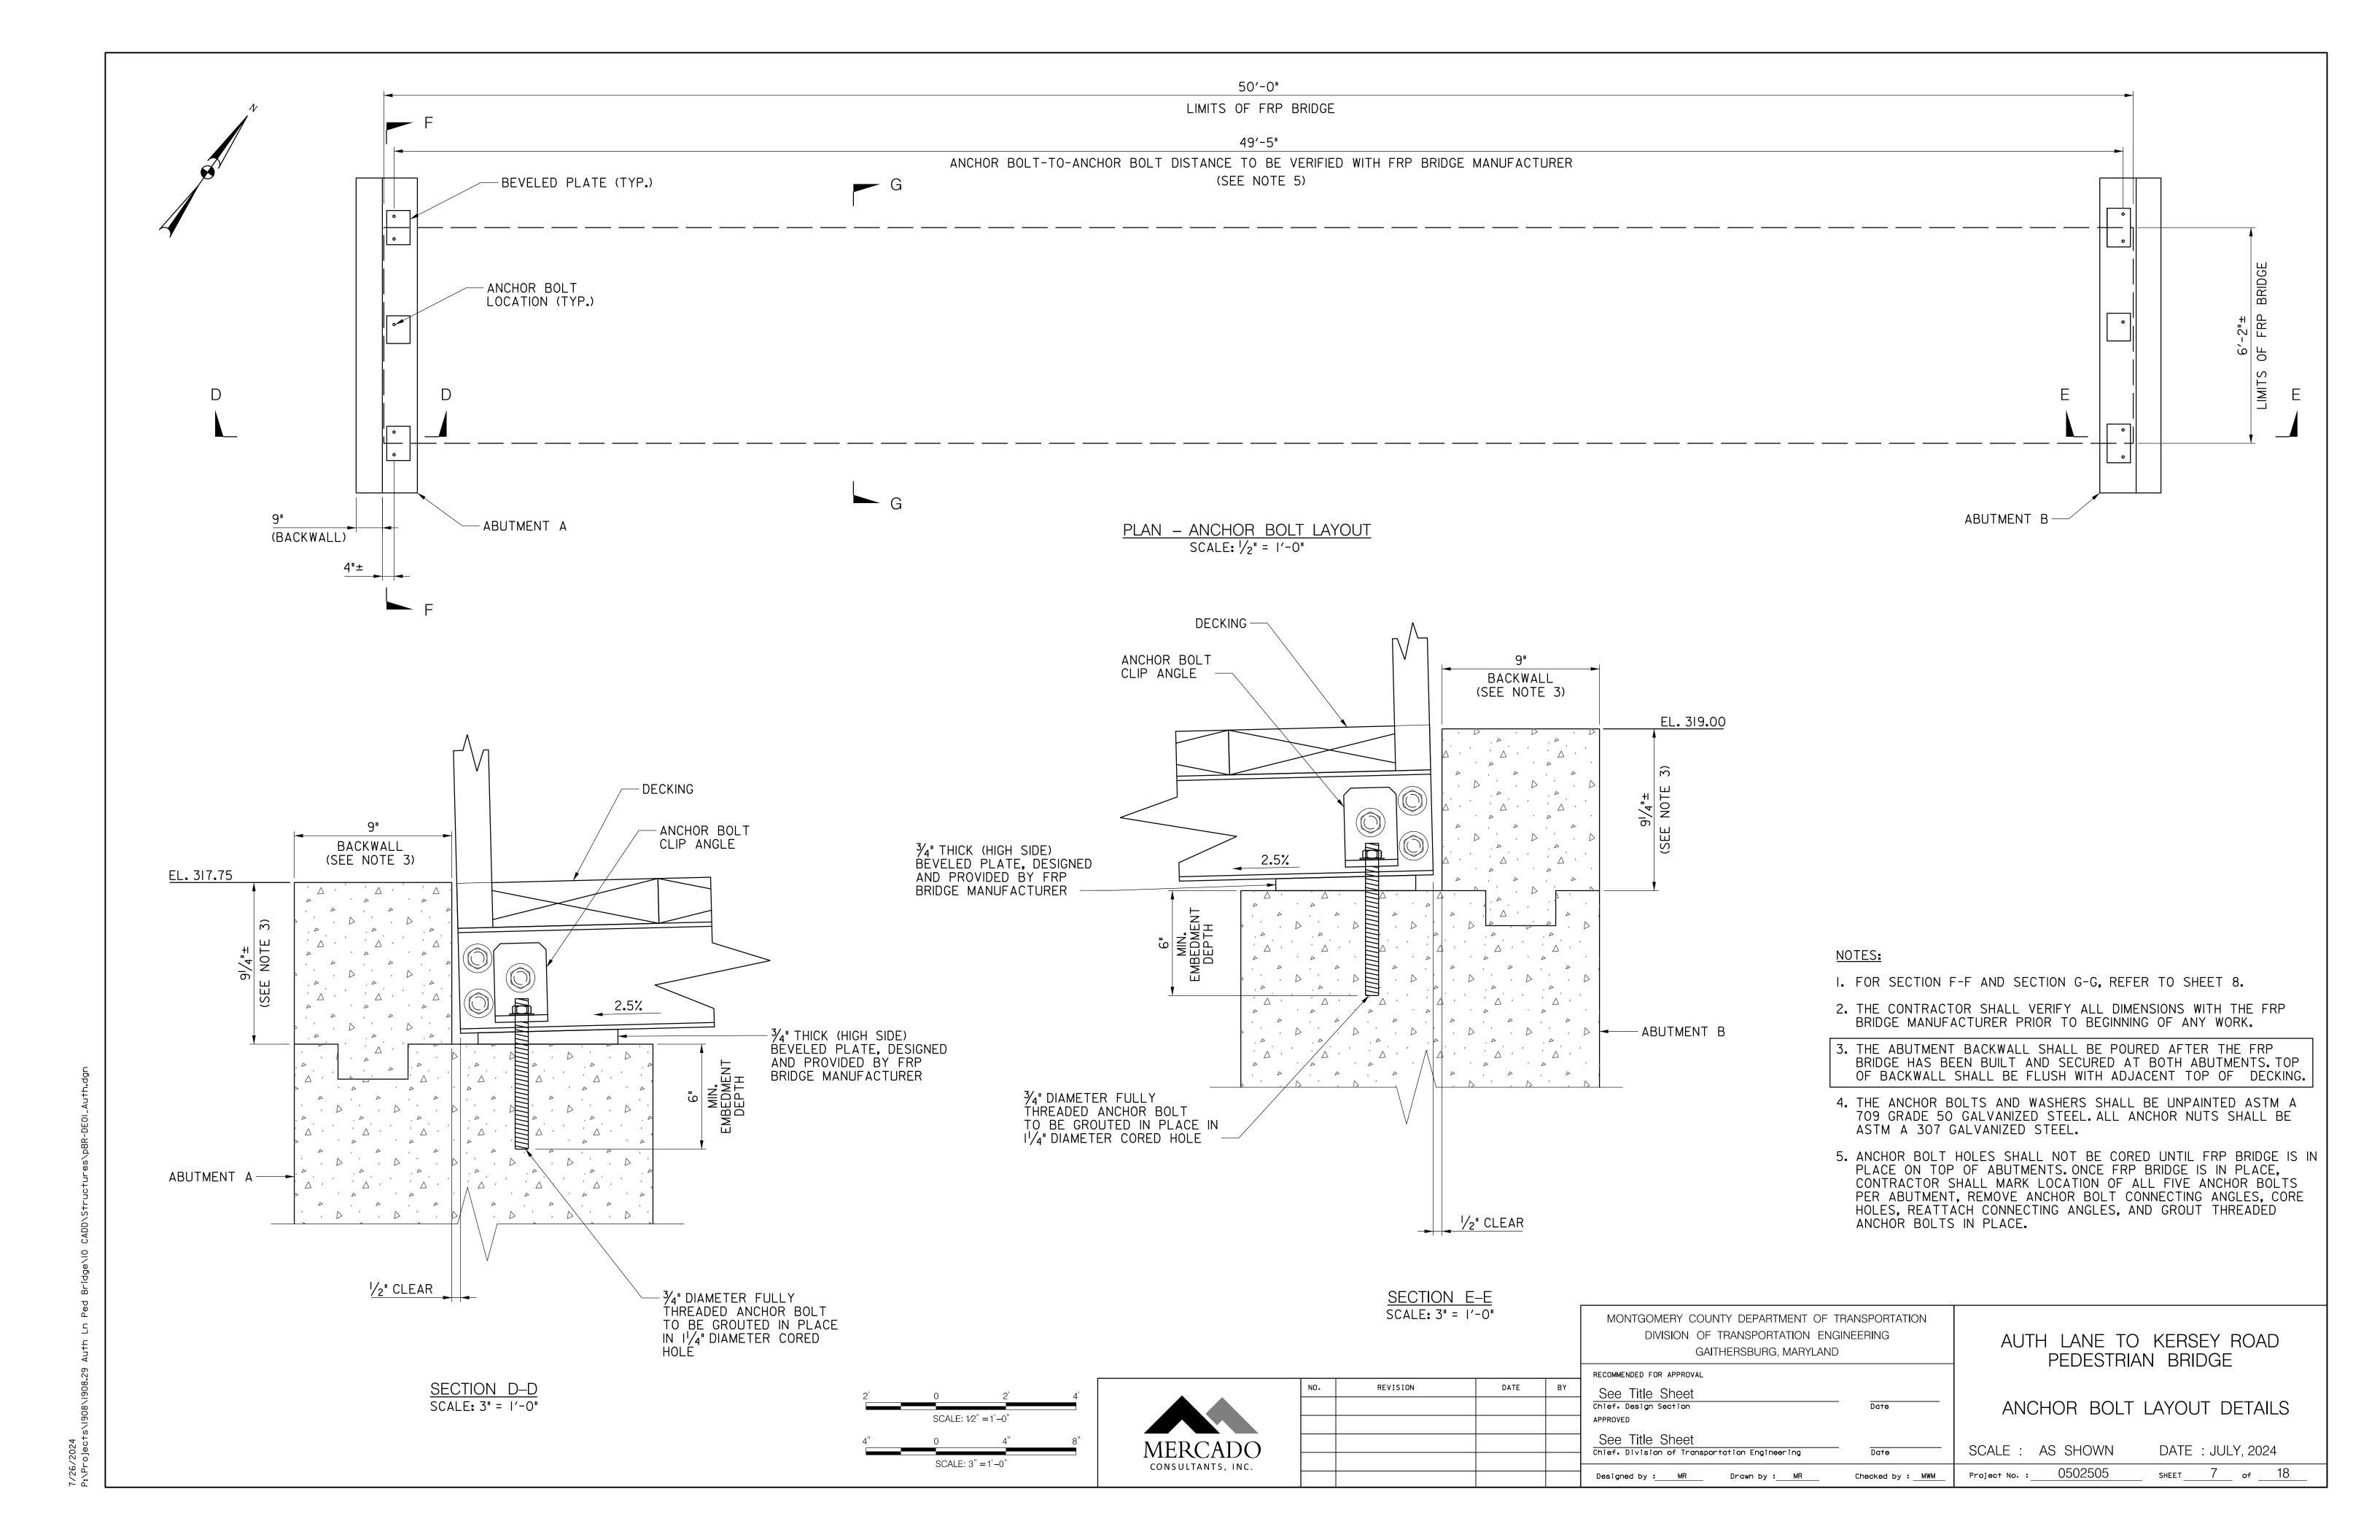

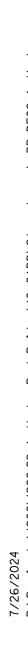

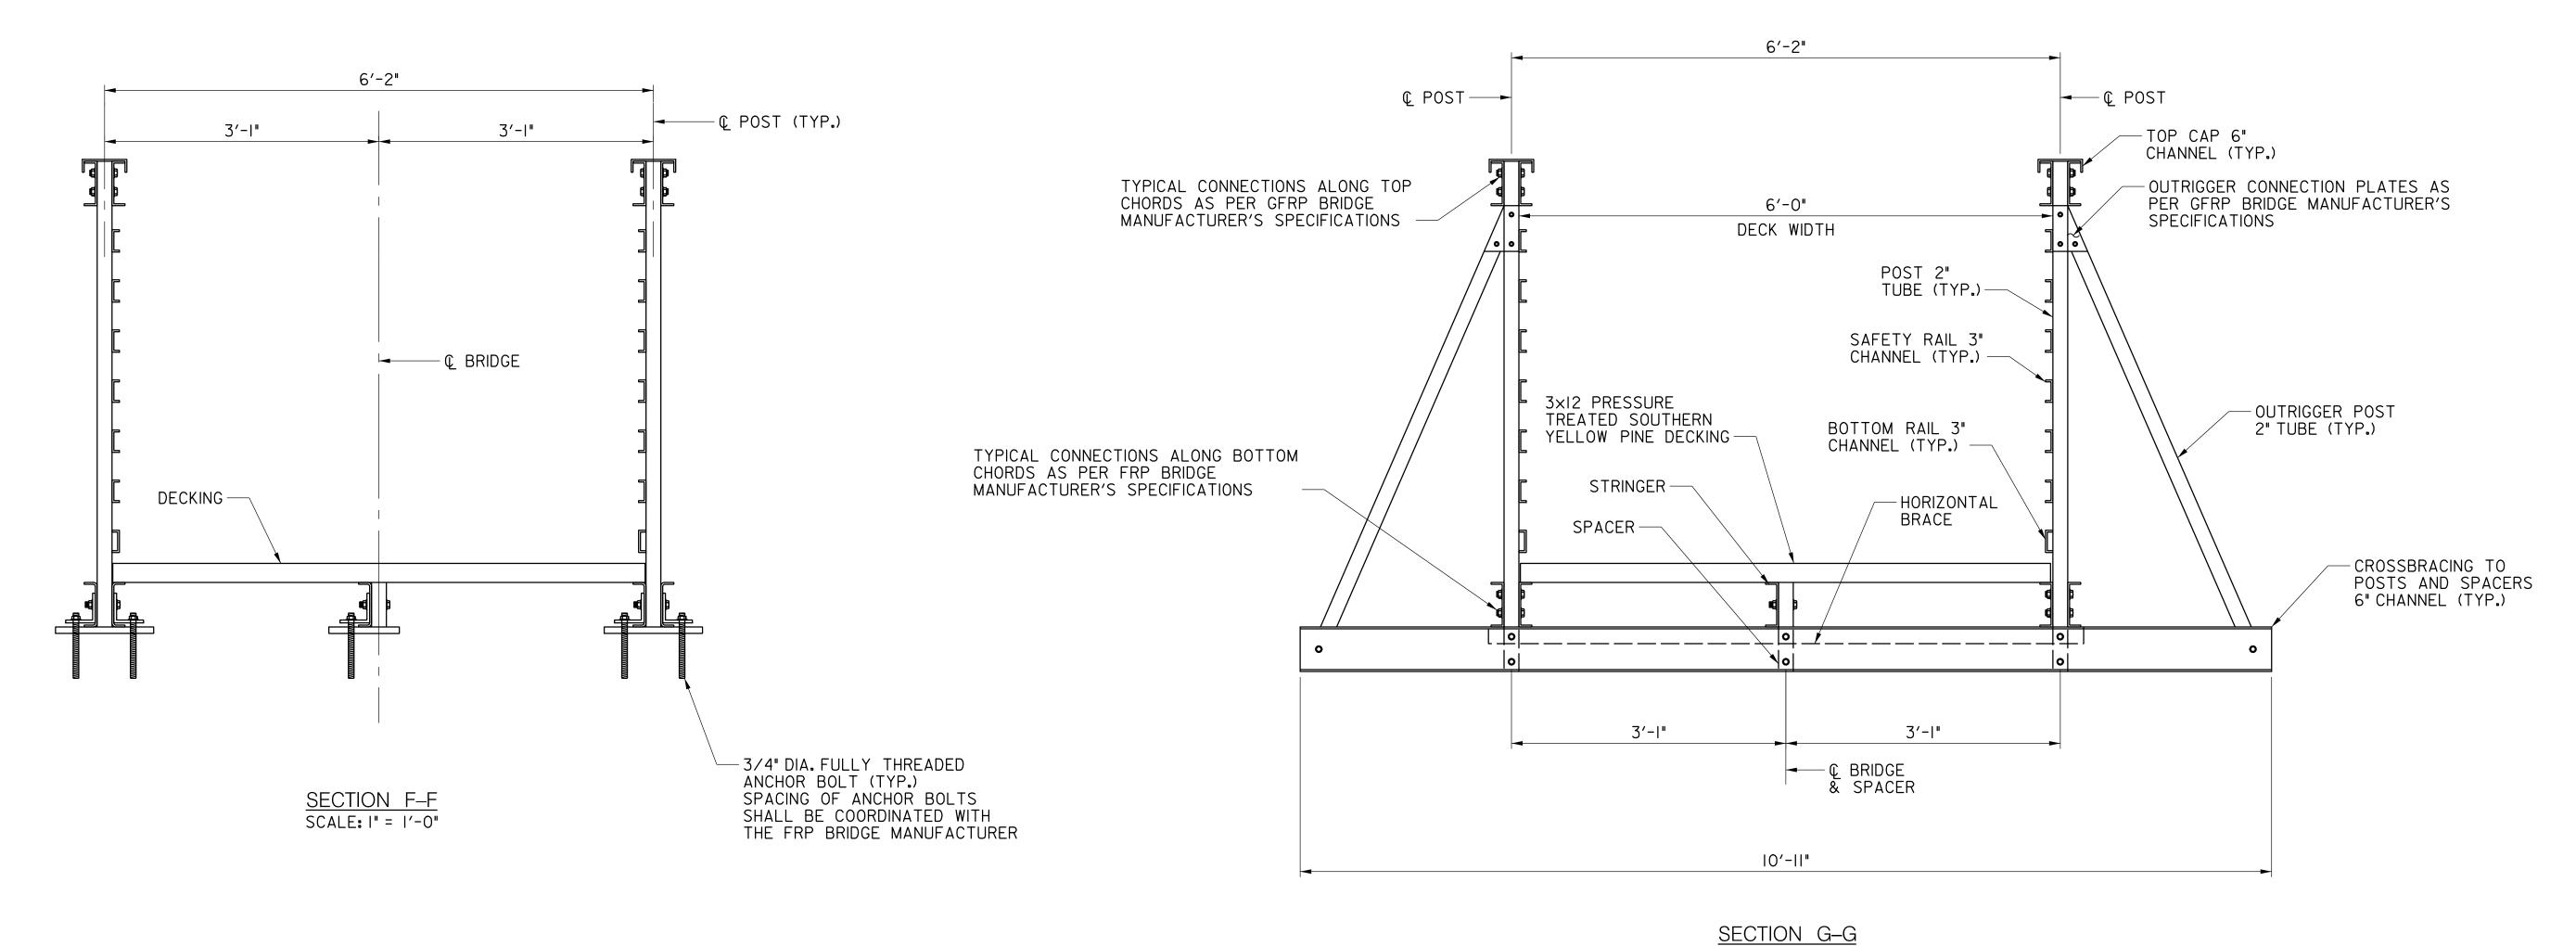


SCALE: I" = 1'-0"

NOTES:

- I. TRUSS DIMENSIONS SHOWN ARE APPROXIMATE. FINAL DIMENSIONS MAY VARY DEPENDING ON PREFABRICATED TRUSS MANUFACTURER DETAILS AND APPROVAL FROM THE COUNTY.
- 2. TIMBER DECKING SHALL BE PROVIDED AND INSTALLED BY THE CONTRACTOR IN THE FIELD.
- 3. ALL MEMBER CONNECTIONS SHALL BE AS PER FRP BRIDGE MANUFACTURER'S SPECIFICATIONS.
- 4. FOR LOCATIONS OF SECTIONS F-F AND G-G, SEE SHEET 7.

					MONTGOMERY COUNTY DEPARTMENT OF DIVISION OF TRANSPORTATION EN GAITHERSBURG, MARYLANI	GINEERING		O KERSEY ROAD AN BRIDGE
	NO.	REVISION	DATE	BY	RECOMMENDED FOR APPROVAL See Title Sheet Chief, Design Section APPROVED	Date	TYPICAL SECTIONS	
MERCADO					See Title Sheet Chief, Division of Transportation Engineering	Date	SCALE : 1" =1'-0"	DATE: JULY, 2024
CONSULTANTS, INC.					Designed by : MR Drawn by : MR	Checked by : <u>MWM</u>	Project No. : 0502505	SHEET <u>8</u> of <u>18</u>

0 1' 2' SCALE: 1" =1'-0"

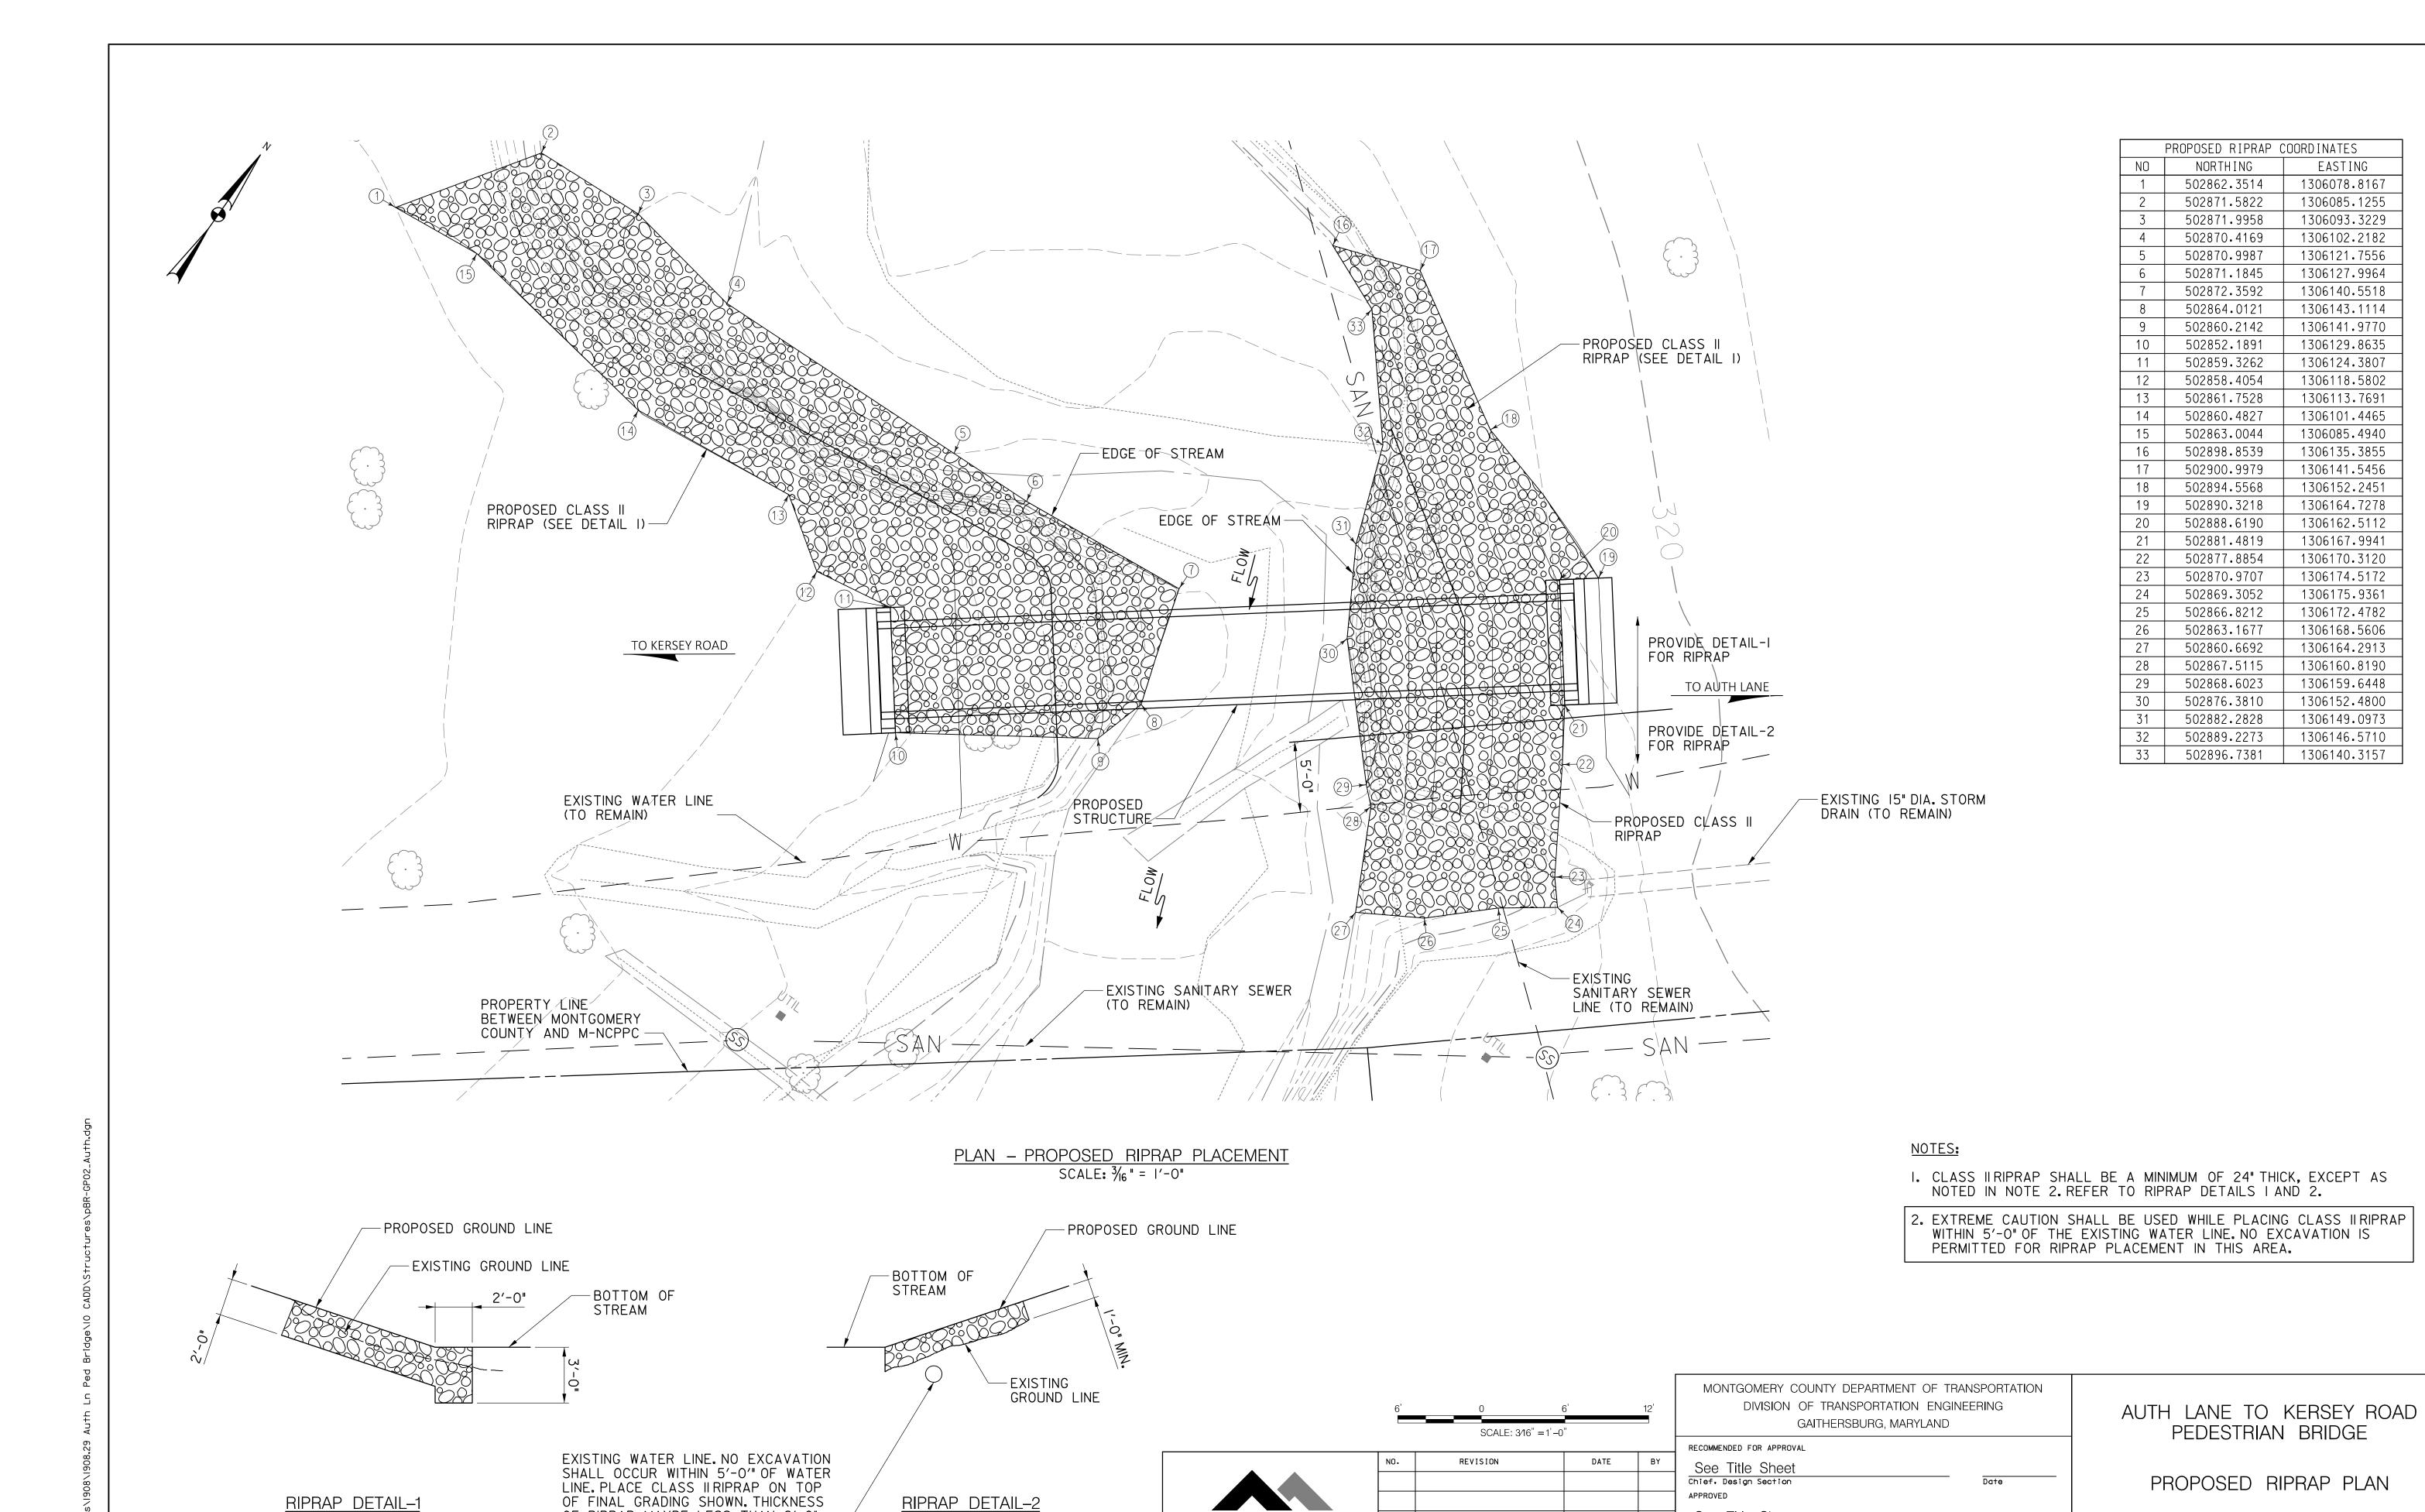

MERCADO

CONSULTANTS, INC.

See Title Sheet

Designed by : KW

Chief, Division of Transportation Engineering

Drawn by: NL

Checked by : <u>MWM</u>

SCALE: 3/16" = 1'-0" DATE: JULY, 2024


sheet <u>9</u> of <u>18</u>


Project No. : 0502505


OF RIPRAP MAYBE LESS THAN 2'-0"


SCALE: $\frac{1}{4}$ " = 1'-0"

SCALE: $\frac{1}{4}$ " = 1'-0"

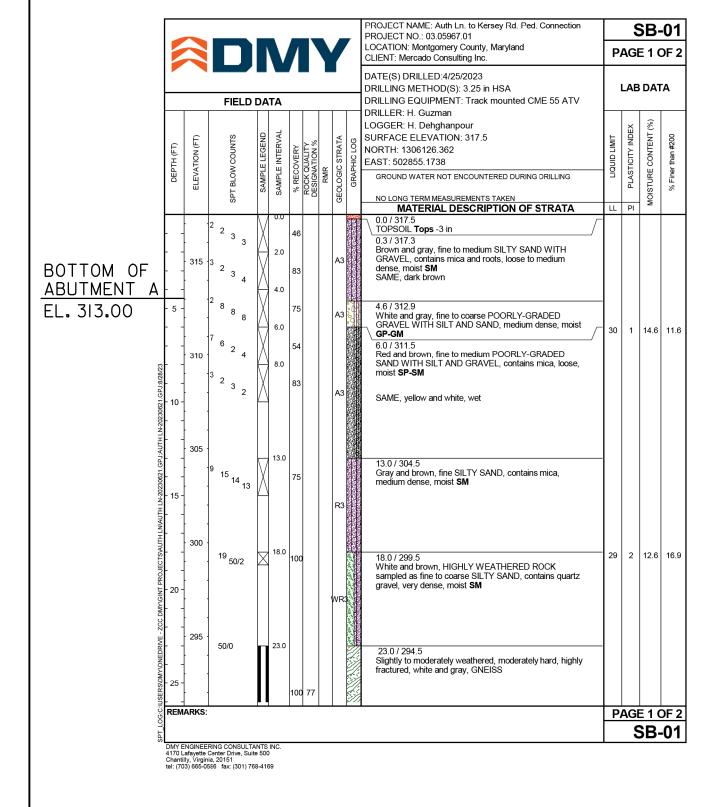

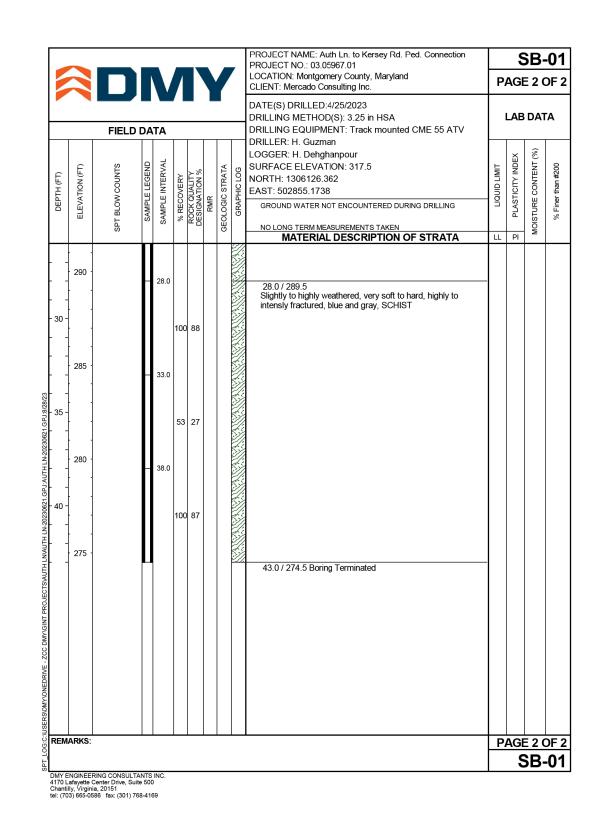

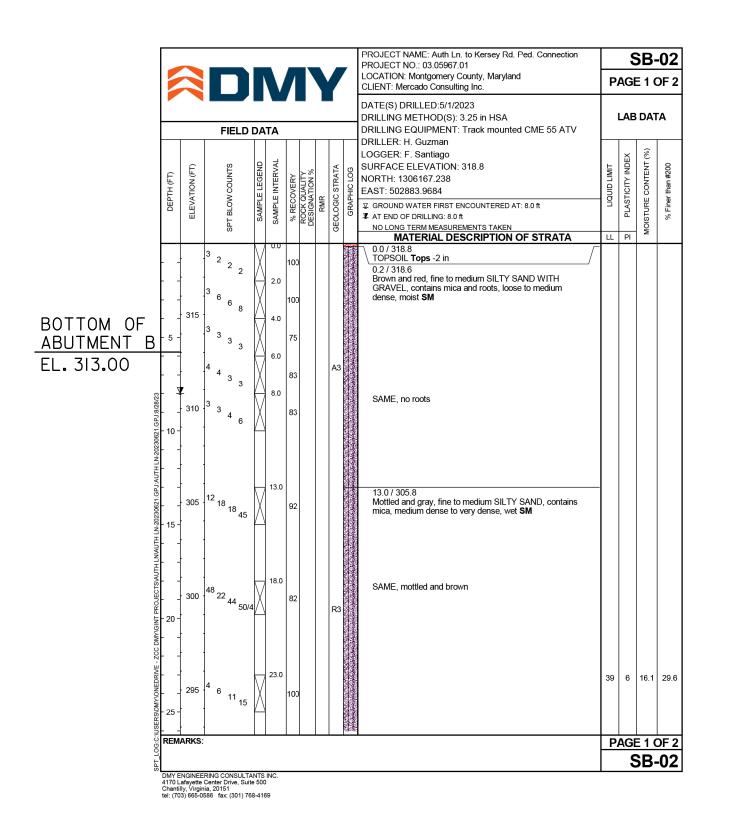


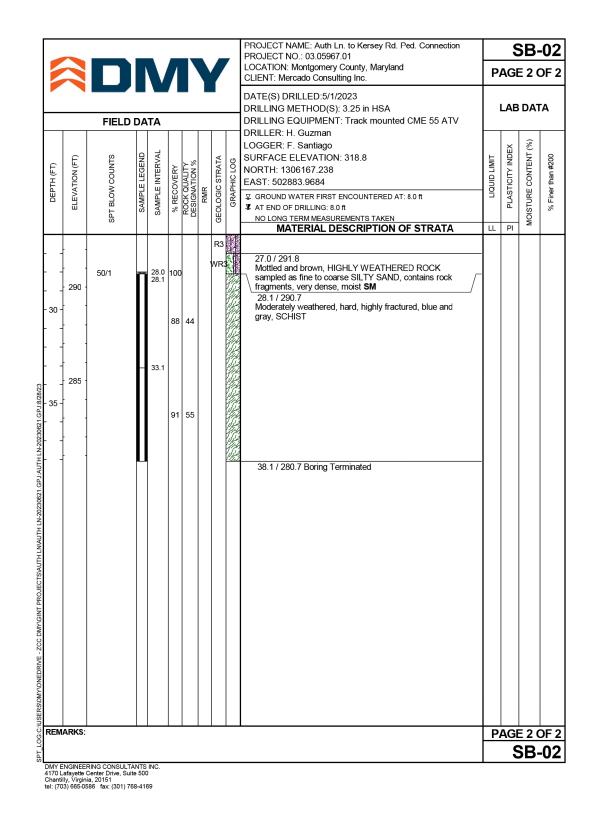

BORING AND DRIVE TESTS NO SCALE

NOTES:

- I. THE BORINGS AND DRIVE TESTS WERE TAKEN BETWEEN APRIL 25, 2023 AND MAY I, 2023 BY DMY ENGINEERING CONSULTANTS, INC.
- 2. THE BORING LOG SOIL SYMBOLS REFLECT ONLY MAJOR CONSTITUENTS, FOR MORE COMPLETE SOIL CHARACTERISTICS, REFER TO SOIL DESCRIPTIVE TEXT.
- 3. N= BLOWS ON A 2 INCH OD SPLIT BARREL SAMPLING SPOON BY 140 LB. DRIVE-WEIGHT FALLING 30 INCHES INDICATING SUCCESSIVE 6 INCH INCREMENTS OF PENETRATION. IN LIEU OF BLOWS PER FOOT, PENETRATION LESS THAN 6 INCHES ARE INDICATED BY 50 BLOWS OVER THE NEAREST INCH.
- 4. BORINGS AND SAMPLINGS CONFORM TO AASHTO DESIGNATIONS T-206, T-225 AND T-306.
- 5. SOIL HAS BEEN CLASSIFIED VISUALLY BY THE DRILLER.
- 6. THE INFORMATION PROVIDED IN THE BORING LOGS IS TRUE AND ACCURATE SOLELY FOR THE SPECIFIC LOCATIONS FOR WHICH BORINGS WERE DRILLED AND SOIL PROPERTIES WERE ANALYZED. THE BORING LOGS ARE PRESENTED FOR INFORMATIONAL PURPOSES ONLY.

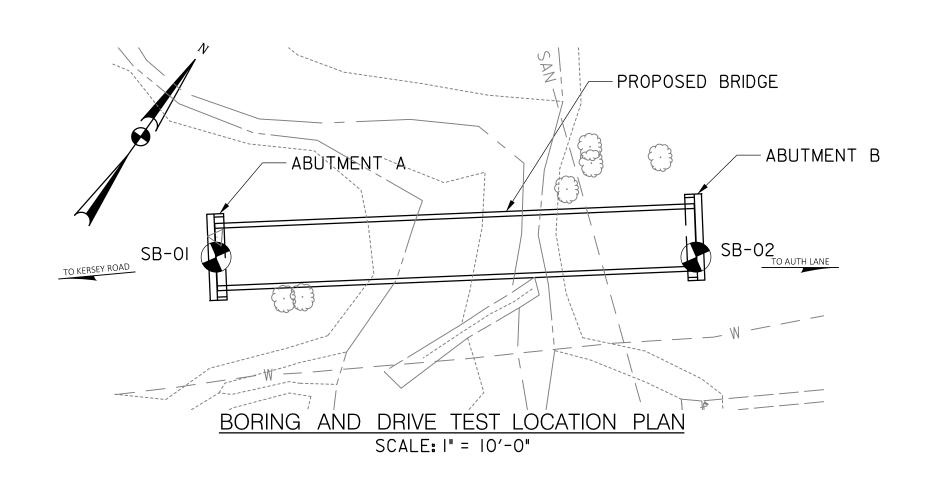

					MONTGOMERY COUNTY DEPARTMENT OF TOUR DIVISION OF TRANSPORTATION ENG. GAITHERSBURG, MARYLAND	GINEERING
	NO.	REVISION	DATE	ВУ	RECOMMENDED FOR APPROVAL	
MERCADO	140.	VEALSTON	DATE		See Title Sheet Chief, Design Section APPROVED See Title Sheet Chief, Division of Transportation Engineering	Date Date
CONSULTANTS, INC.					Designed by : ZK Drawn by : ZK	Checked by :MWM

BORINGS AND TEST DRIVES

AUTH LANE TO KERSEY ROAD PEDESTRIAN BRIDGE

SCALE : AS SHOWN DATE: JULY, 2024 SHEET 10 of 18

Project No. : 0502505



EROSION AND SEDIMENT CONTROL - GENERAL NOTES

STANDARD EROSION AND SEDIMENT CONTROL NOTES

- 1. THE PERMITTEE SHALL NOTIFY THE DEPARTMENT OF PERMITTING SERVICES (DPS) FORTY-EIGHT (48) HOURS BEFORE COMMENCING ANY LAND DISTURBING ACTIVITY AND, UNLESS WAIVED BY THE DEPARTMENT, SHALL BE REQUIRED TO HOLD A PRE-CONSTRUCTION MEETING BETWEEN THEM OR THEIR REPRESENTATIVE, THEIR ENGINEER AND AN AUTHORIZED REPRESENTATIVE OF THE DEPARTMENT.
- 2. THE PERMITTEE MUST OBTAIN INSPECTION AND APPROVAL BY DPS AT THE FOLLOWING POINTS: A. AT THE REQUIRED PRE-CONSTRUCTION MEETING.
- B. FOLLOWING INSTALLATION OF SEDIMENT CONTROL MEASURES AND PRIOR TO ANY OTHER LAND DISTURBING
- C. DURING THE INSTALLATION OF A SEDIMENT BASIN OR STORMWATER MANAGEMENT STRUCTURE AT THE REQUIRED INSPECTION POINTS (SEE INSPECTION CHECKLIST ON PLAN). NOTIFICATION PRIOR TO COMMENCING CONSTRUCTION IS MANDATORY.
- D. PRIOR TO REMOVAL OR MODIFICATION OF ANY SEDIMENT CONTROL STRUCTURE(S).
- E. PRIOR TO FINAL ACCEPTANCE.
- 3. THE PERMITTEE SHALL CONSTRUCT ALL EROSION AND SEDIMENT CONTROL MEASURES PER THE APPROVED PLAN AND CONSTRUCTION SEQUENCE, SHALL HAVE THEM INSPECTED AND APPROVED BY THE DEPARTMENT PRIOR TO BEGINNING ANY OTHER LAND DISTURBANCES, SHALL ENSURE THAT ALL RUNOFF FROM DISTURBED AREAS IS DIRECTED TO THE SEDIMENT CONTROL DEVICES, AND SHALL NOT REMOVE ANY EROSION OR SEDIMENT CONTROL MEASURE WITHOUT PRIOR PERMISSION FROM THE DEPARTMENT.
- 4. THE PERMITTEE SHALL PROTECT ALL POINTS OF CONSTRUCTION INGRESS AND EGRESS TO PREVENT THE DEPOSITION OF MATERIALS ONTO TRAVERSED PUBLIC THOROUGHFARE(S). ALL MATERIALS DEPOSITED ONTO PUBLIC THOROUGHFARE(S) SHALL BE REMOVED IMMEDIATELY.
- 5. THE PERMITTEE SHALL INSPECT PERIODICALLY AND MAINTAIN CONTINUOUSLY IN EFFECTIVE OPERATING CONDITION, ALL EROSION AND SEDIMENT CONTROL MEASURES UNTIL SUCH TIME AS THEY ARE REMOVED WITH PRIOR PERMISSION FROM THE DEPARTMENT. THE PERMITTEE IS RESPONSIBLE FOR IMMEDIATELY REPAIRING OR REPLACING ANY SEDIMENT CONTROL MEASURES WHICH HAVE BEEN DAMAGED OR REMOVED BY THE PERMITTEE OR ANY OTHER PERSON.
- 6. FOLLOWING INITIAL SOIL DISTURBANCE OR RE-DISTURBANCE, PERMANENT OR TEMPORARY STABILIZATION MUST BE COMPLETED WITHIN:

A) THREE (3) CALENDAR DAYS AS TO THE SURFACE OF ALL PERIMETER DIKES, SWALES, DITCHES, PERIMETER SLOPES AND ALL SLOPES STEEPER THAN 3 HORIZONTAL TO 1 VERTICAL (3:1); AND

B) SEVEN (7) CALENDAR DAYS AS TO ALL OTHER DISTURBED OR GRADED AREAS ON THE PROJECT SITE NOT UNDER ACTIVE GRADING.

ALL AREAS DISTURBED OUTSIDE OF THE PERIMETER SEDIMENT CONTROL SYSTEM MUST BE MINIMIZED AND STABILIZED IMMEDIATELY. MAINTENANCE MUST BE PERFORMED AS NECESSARY TO ENSURE CONTINUED STABILIZATION.

- 7. THE PERMITTEE SHALL APPLY SOD, SEED, AND ANCHORED STRAW MULCH, OR OTHER APPROVED STABILIZATION MEASURES TO ALL DISTURBED AREAS WITHIN SEVEN (7) CALENDAR DAYS AFTER STRIPPING AND GRADING ACTIVITIES HAVE CEASED ON THAT AREA. MAINTENANCE SHALL BE PERFORMED AS NECESSARY TO ENSURE CONTINUED STABILIZATION. ACTIVE CONSTRUCTION AREAS SUCH AS BORROW OR STOCKPILE AREAS, ROADWAY IMPROVEMENTS, AND AREAS WITHIN FIFTY (50) FEET OF A BUILDING UNDER CONSTRUCTION MAY BE EXEMPT FROM THIS REQUIREMENT, PROVIDED THAT EROSION AND SEDIMENT CONTROL MEASURES ARE INSTALLED AND MAINTAINED TO PROTECT THOSE AREAS.
- 8. PRIOR TO REMOVAL OF SEDIMENT CONTROL MEASURES, THE PERMITTEE SHALL STABILIZE ALL CONTRIBUTORY DISTURBED AREAS WITH REQUIRED SOIL AMENDMENTS AND TOPSOIL, USING SOD OR AN APPROVED PERMANENT SEED MIXTURE AND AN APPROVED ANCHORED MULCH. WOOD FIBER MULCH MAY ONLY BE USED IN SEEDING SEASON WHEN THE SLOPE DOES NOT EXCEED 10% AND GRADING HAS BEEN DONE TO PROMOTE SHEET FLOW DRAINAGE. AREAS BROUGHT TO FINISHED GRADE DURING THE SEEDING SEASON SHALL BE PERMANENTLY STABILIZED WITHIN SEVEN (7) CALENDAR DAYS OF ESTABLISHMENT. WHEN PROPERTY IS BROUGHT TO FINISHED GRADE DURING THE MONTHS OF NOVEMBER THROUGH FEBRUARY, AND PERMANENT STABILIZATION IS FOUND TO BE IMPRACTICAL, AN APPROVED TEMPORARY SEED AND STRAW ANCHORED MULCH SHALL BE APPLIED TO DISTURBED AREAS. THE FINAL PERMANENT STABILIZATION OF SUCH PROPERTY SHALL BE COMPLETED PRIOR TO THE FOLLOWING APRIL 15.
- 9. THE SITE PERMIT, WORK, MATERIALS, APPROVED SC/SM PLANS, AND TEST REPORTS SHALL BE AVAILABLE AT THE SITE FOR INSPECTION BY DULY AUTHORIZED OFFICIALS OF MONTGOMERY COUNTY.
- 10. SURFACE DRAINAGE FLOWS OVER UNSTABILIZED CUT AND FILL SLOPES SHALL BE CONTROLLED BY EITHER PREVENTING DRAINAGE FLOWS FROM TRAVERSING THE SLOPES OR BY INSTALLING MECHANICAL DEVICES TO LOWER THE WATER DOWN SLOPE WITHOUT CAUSING EROSION. DIKES SHALL BE INSTALLED AND MAINTAINED AT THE TOP OF CUT OR FILL SLOPES UNTIL THE SLOPE AND DRAINAGE AREA TO IT ARE FULLY STABILIZED, AT WHICH TIME THEY MUST BE REMOVED AND FINAL GRADING DONE TO PROMOTE SHEET FLOW DRAINAGE. MECHANICAL DEVICES MUST BE PROVIDED AT POINTS OF CONCENTRATED FLOW WHERE EROSION IS LIKELY TO OCCUR.
- 11. PERMANENT SWALES OR OTHER POINTS OF CONCENTRATED WATER FLOW SHALL BE STABILIZED WITHIN 3 CALENDAR DAYS OF ESTABLISHMENT WITH SOD OR SEED WITH AN APPROVED EROSION CONTROL MATTING OR BY OTHER APPROVED STABILIZATION MEASURES.

- 12. SEDIMENT CONTROL DEVICES SHALL BE REMOVED, WITH PERMISSION OF THE DEPARTMENT, WITHIN THIRTY (30) CALENDAR DAYS FOLLOWING ESTABLISHMENT OF PERMANENT STABILIZATION IN ALL CONTRIBUTORY DRAINAGE AREAS. STORMWATER MANAGEMENT STRUCTURES USED TEMPORARILY FOR SEDIMENT CONTROL SHALL BE CONVERTED TO THE PERMANENT CONFIGURATION WITHIN THIS TIME PERIOD AS WELL.
- 13. NO PERMANENT CUT OR FILL SLOPE WITH A GRADIENT STEEPER THAN 3:1 WILL BE PERMITTED IN LAWN MAINTENANCE AREAS OR ON RESIDENTIAL LOTS. A SLOPE GRADIENT OF UP TO 2:1 WILL BE PERMITTED IN NONMAINTENANCE AREAS PROVIDED THAT THOSE AREAS ARE INDICATED ON THE EROSION AND SEDIMENT CONTROL PLAN WITH A LOW-MAINTENANCE GROUND COVER SPECIFIED FOR PERMANENT STABILIZATION. SLOPE GRADIENT STEEPER THAN 2:1 WILL NOT BE PERMITTED WITH VEGETATIVE STABILIZATION.
- 14. THE PERMITTEE SHALL INSTALL A SPLASH BLOCK AT THE BOTTOM OF EACH DOWNSPOUT UNLESS THE DOWNSPOUT IS CONNECTED BY A DRAIN LINE TO AN ACCEPTABLE OUTLET.
- 15. FOR FINISHED GRADING, THE PERMITTEE SHALL PROVIDE ADEQUATE GRADIENTS SO AS TO PREVENT WATER FROM STANDING ON THE SURFACE OF LAWNS MORE THAN TWENTY—FOUR (24) HOURS AFTER THE END OF A RAINFALL, EXCEPT IN DESIGNATED DRAINAGE COURSES AND SWALE FLOW AREAS, WHICH MAY DRAIN AS LONG AS FORTY—EIGHT (48) HOURS AFTER THE END OF A RAINFALL.
- 16. SEDIMENT TRAPS OR BASINS ARE NOT PERMITTED WITHIN 20 FEET OF A BUILDING WHICH IS EXISTING OR UNDER CONSTRUCTION. NO BUILDING MAY BE CONSTRUCTED WITHIN 20 FEET OF A SEDIMENT TRAP OR BASIN.
- 17. ALL INLETS IN NON-SUMP AREAS SHALL HAVE ASPHALT BERMS INSTALLED AT THE TIME OF BASE PAVING ESTABLISHMENT.
- 18. THE SEDIMENT CONTROL INSPECTOR HAS THE OPTION OF REQUIRING ADDITIONAL SEDIMENT CONTROL MEASURES, AS DEEMED NECESSARY.
- 19. ALL TRAP ELEVATIONS ARE RELATIVE TO THE OUTLET ELEVATION, WHICH MUST BE ON EXISTING UNDISTURBED GROUND.
- 20. VEGETATIVE STABILIZATION SHALL BE PERFORMED IN ACCORDANCE WITH THE STANDARDS AND SPECIFICATIONS FOR SOIL EROSION AND SEDIMENT CONTROL.
- 21. SEDIMENT TRAP(S)/BASIN(S) SHALL BE CLEANED OUT AND RESTORED TO THE ORIGINAL DIMENSIONS WHEN SEDIMENT HAS ACCUMULATED TO THE POINT OF ONE-HALF (1/2) THE WET STORAGE DEPTH OF THE TRAP/BASIN (1/4 THE WET STORAGE DEPTH FOR ST-III) OR WHEN REQUIRED BY THE SEDIMENT CONTROL INSPECTOR.
- 22. SEDIMENT REMOVED FROM TRAPS/BASINS SHALL BE PLACED AND STABILIZED IN APPROVED AREAS, BUT NOT WITHIN A FLOODPLAIN.
- 23. ALL SEDIMENT BASINS AND TRAPS MUST BE SURROUNDED WITH A WELDED WIRE SAFETY FENCE. THE FENCE MUST BE AT LEAST 42 INCHES HIGH, HAVE POSTS SPACED NO FARTHER APART THAN 8 FEET, HAVE MESH OPENINGS NO GREATER THE TWO INCHES IN WIDTH AND FOUR INCHES IN HEIGHT, WITH A MINIMUM OF 14 GAUGE WIRE. SAFETY FENCE MUST BE MAINTAINED IN GOOD CONDITION AT ALL TIMES.
- 24. NO EXCAVATION IN THE AREAS OF EXISTING UTILITIES IS PERMITTED UNLESS THEIR LOCATION HAS BEEN DETERMINED. CALL "MISS UTILITY" AT 1-800-257-7777, 48 HOURS PRIOR TO THE START OF WORK.
- 25. OFF-SITE SPOIL OR BORROW AREAS MUST HAVE PRIOR APPROVAL BY DPS.
- 26. SEDIMENT TRAP/BASIN DEWATERING FOR CLEANOUT OR REPAIR MAY ONLY BE DONE WITH THE DPS INSPECTOR'S PERMISSION. THE INSPECTOR MUST APPROVE THE DEWATERING METHOD FOR EACH APPLICATION. THE FOLLOWING METHODS MAY BE CONSIDERED:
- A. PUMP DISCHARGE MAY BE DIRECTED TO ANOTHER ON—SITE SEDIMENT TRAP OR BASIN, PROVIDED IT IS OF SUFFICIENT VOLUME AND THE PUMP INTAKE IS FLOATED TO PREVENT AGITATION OR SUCTION OF DEPOSITED SEDIMENTS: OR
- B. THE PUMP INTAKE MAY UTILIZE A REMOVABLE PUMPING STATION AND MUST DISCHARGE INTO AN UNDISTURBED AREA THROUGH A NON-EROSIVE OUTLET; OR
- C. THE PUMP INTAKE MAY BE FLOATED AND DISCHARGE INTO A DIRT BAG (12 OZ. NON-WOVEN FABRIC), OR APPROVED EQUIVALENT, LOCATED IN AN UNDISTURBED BUFFER AREA.

REMEMBER: DEWATERING OPERATION AND METHOD MUST HAVE PRIOR APPROVAL BY THE DPS INSPECTOR.

- 27. THE PERMITTEE MUST NOTIFY THE DEPARTMENT OF ALL UTILITY CONSTRUCTION ACTIVITIES WITHIN THE PERMITTED LIMITS OF DISTURBANCE PRIOR TO THE COMMENCEMENT OF THOSE ACTIVITIES.
- 28. TOPSOIL MUST BE APPLIED TO ALL PERVIOUS AREAS WITHIN THE LIMITS OF DISTURBANCE PRIOR TO PERMANENT STABILIZATION IN ACCORDANCE WITH MDE "STANDARDS AND SPECIFICATIONS FOR SOIL PREPARATION, TOPSOILING, AND SOIL AMENDMENTS".

VEGETATIVE STABILIZATION PERMANENT AND TEMPORARY SEEDING, SODDING AND MULCHING

I. SITE PREPARATION

PERMANENT OR TEMPORARY STABILIZATION SHALL BE COMPLETED WITHIN (A.) SEVEN CALENDAR DAYS AS TO THE SURFACE OF ALL SEDIMENT CONTROL PRACTICES SUCH AS DIVERSIONS, GRADE STABILIZATION STRUCTURES, BERMS, DIKES, GRASSED WATERWAYS, SEDIMENT BASINS, PERIMETER SLOPES AND ALL SLOPES GREATER THAN 3 HORIZONTAL TO I VERTICAL (3:1) AND (B.) FOURTEEN DAYS AS TO ALL OTHER DISTURBED OR GRADED AREAS ON THE PROJECT SITE.

II. SEEDBED PREPARATION AND SEEDING APPLICATION

THE TOP LAYER OF SOIL SHALL BE LOOSENED, LIMED AND FERTILIZED BY RAKING, DISCING OR HARROWING OR OTHER ACCEPTABLE MEANS BEFORE SEEDING. FLAT AREAS AND SLOPES UP TO 3 TO I GRADE SHALL BE LOOSE AND FRIABLE TO A DEPTH OF AT LEAST 3 INCHES. SLOPES STEEPER THAN 3 TO I SHALL HAVE THE TOP I-3 INCHES OF SOIL LOOSE AND FRIABLE BEFORE SEEDING.

APPLY SEED UNIFORMLY WITH A CYCLONE SEEDER, DRILL CULTIPACKER, SEEDER OR HYDROSEEDER ON A FIRM MOIST SEEDBED.

III. SOIL AMENDMENTS

LIME AND FERTILIZE ACCORDING TO SOIL TESTS. IN LIEU OF SOIL TEST APPLY THE FOLLOWING:

DOLOMITIC: 2 TONS PER ACRE OR 92 LBS./1000 (PERMANENT AND SODDING) SQ. FT. LIMESTONE: I TON PER ACRE OR 46 LB./1000 SQ. FT. (TEMPORARY)
FERTILIZER: IO-IO-IO OR EQUIVALENT AT 1000 LBS. PER ACRE OR 23 LBS. PER 1000 SQ. FT. (PERMANENT AND SODDING) IO-IO-IO OR EQUIVALENT AT 600 LBS. PER ACRE OR I5 LBS./1000 SQ. FT. (TEMPORARY)

IV. SEDIMENT CONTROL PRACTICE SEEDING

SEED: ANNUAL RYEGRASS 40 LBS./ACRE OR 1.0 LBS./1000 SQ.FT. DATE: 3/I TO 5/I5 AND 8/I TO 10/I5 SEED: FOXTAIL MILLET 30 LBS./ACRE OR 0.7 LBS./1000 SQ.FT. DATE: 5/I6 TO 7/3I

V. TEMPORARY SEEDING: PER GROWING SEASON

SEED: ANNUAL RYEGRASS 40 LBS./ACRE OR 1.0 LBS./1000 SQ.FT. DATE: 3/I TO 5/I5 AND 8/I TO 10/I5 SEED: FOXTAIL MILLET 30 LBS./ACRE OR 0.7 LBS./1000 SQ.FT. DATE: 5/I6 TO 7/3I

VI. PERMANENT SEEDING

SEED: TALL FESCUE 60 LBS./ACRE OR 1.38 LBS./1000 SQ.FT. AND KENTUCKY BLUEGRASS 40 LBS./ ACRE OR 0.92 LBS./1000 SQ.FT.
DATE: 3/1 TO 10/15 IRRIGATION REQUIRED

VII. MULCHING

ALL SEEDINGS REQUIRE MULCHING. USE MULCH ONLY DURING NON-SEEDING DATES UNTIL SEEDING CAN BE DONE.

MULCH SHALL BE UNROTTED, UNCHOPPED SMALL GRAIN STRAW APPLIED AT A RATE OF $1\frac{1}{2}$ TO 2 TONS/ACRE OR 70-90 LBS./1000 SQ.FT. (2 BALES). MULCH MATERIALS SHALL BE RELATIVELY FREE OF ALL KINDS OF WEEDBEDS AND SHALL BE FREE OF PROHIBITED NOXIOUS WEEDS. SPREAD MULCH UNIFORMLY MECHANICALLY OR BY HAND. MULCH ANCHORING SHALL BE ACCOMPLISHED IMMEDIATELY AFTER MULCH PLACEMENT TO MINIMIZE LOSS BY WIND OR WATER. THIS MAY BE DONE BY MULCH NETTINGS, MULCH ANCHORING TOLL, PEG AND TWINE, OR LIQUID MULCH BINDERS.

LIQUID MULCH BINDER SHALL BE RAPID CURING APPLIED AT A RATE OF 200 GAL./ACRE OR 5 GAL./IOOO SQ.FT. SLOPES 8 FT. OR MORE HIGH USE 348 GAL/ACRE OR 8 GAL./IOOO SQ.FT.

VIII. SODDING

CLASS OF TURFGRASS SOD SHALL BE MARYLAND OR VIRGINIA STATE CERTIFIED, OR MARYLAND OR VIRGINIA STATE APPROVED SOD. SOD SHALL BE HARVESTED, DELIVERED AND INSTALLED WITHIN A PERIOD OF 36 HOURS. SOD IS TO BE LAID WITH THE LONG EDGES PARALLEL TO THE CONTOUR WITH STAGGERED JOINTS WITH ALL ENDS TIGHTLY ABUTTING AND NOT OVER LAPPING. SOD SHALL BE ROLLED AND THOROUGHLY WATERED WITHIN 8 HOURS OF INSTALLATION. DAILY WATERING TO MAINTAIN 4 INCH DEPTH OF MOISTURE FOR THE FIRST WEEK IS REQUIRED IN THE ABSENCE OF RAINFALL. SOD IS NOT TO BE APPLIED ON FROZEN GROUND.

IX. MAINTENANCE

A. IRRIGATION: WHEN SOIL MOISTURE BECOMES DEFICIENT, IRRIGATE TO PREVENT LOSS OF STAND OF PROTECTIVE VEGETATION.

B. REPAIRS: IF STAND IS INADEQUATE FOR EROSION CONTROL, OVERSEED AND FERTILIZE USING HALF OF THE RATES ORIGINALLY APPLIED. IF STAND IS OVER 60% DAMAGED, REESTABLISH FOLLOWING ORIGINAL RATES AND PROCEDURES.

NOTES: USE OF THIS INFORMATION DOES NOT PRECLUDE MEETING ALL THE REQUIREMENTS OF THE 2011 MARYLAND STANDARDS AND SPECIFICATIONS FOR SOIL EROSION AND SEDIMENT CONTROL VEGETATIVE PRACTICES.

SC0002

AUTH LANE TO KERSEY ROAD

					GAITHERSBURG, MARYLAND)	PEDESTRI	AN BRIDGE
	NO.	REVISION	DATE	ВҮ	recommended for approval See Title Sheet			
					Chief, Design Section APPROVED	Date		EDIMENT CONTROL TES
MERCADO					See Title Sheet Chief, Division of Transportation Engineering	Date	SCALE : NONE	DATE: JULY, 2024
CONSULTANTS, INC.					Designed by: MWM Drawn by: NL	Checked by : MWM	Project No. : 0502505	SHEET 11 of 18

MONTGOMERY COUNTY DEPARTMENT OF TRANSPORTATION
DIVISION OF TRANSPORTATION ENGINEERING



EROSION AND SEDIMENT CONTROL SEQUENCE OF CONSTRUCTION

- I. PRIOR TO CLEARING TREES, INSTALLING SEDIMENT CONTROL MEASURES, OR GRADING, A PRECONSTRUCTION MEETING MUST BE CONDUCTED ON-SITE WITH THE MONTGOMERY COUNTY DEPARTMENT OF PERMITTING SERVICES (MCDPS) SEDIMENT CONTROL INSPECTOR (240) 777-03II (48 HOURS NOTICE) AND THE MNCPPC, PLANNING DEPARTMENT, PLANS ENFORCEMENT INSPECTOR (30I) 495-4550 (48 HOURS NOTICE), THE OWNERS REPRESENTATIVE, AND THE SITE ENGINEER. IN ORDER FOR THE MEETING TO OCCUR, THE APPLICANT MUST PROVIDE ONE PAPER SET OF APPROVED SEDIMENT CONTROL PLANS TO MCDPS SEDIMENT CONTROL INSPECTOR AT THE PRECONSTRUCTION MEETING. IF NO PLANS ARE PROVIDED, THE MEETING SHALL NOT OCCUR AND WILL NEED TO BE RESCHEDULED PRIOR TO COMMENCING ANY WORK.
- 2. THE LIMITS OF DISTURBANCE MUST BE FIELD MARKED PRIOR TO CLEARING OF TREES, INSTALLATION OF SEDIMENT CONTROL MEASURES, CONSTRUCTION, OR OTHER LAND DISTURBING ACTIVITIES.
- 3. THE PERMITTEE MUST OBTAIN WRITTEN APPROVAL FROM THE MNCPPC INSPECTOR, CERTIFYING THAT THE LIMITS OF DISTURBANCE AND TREE PROTECTION MEASURES ARE CORRECTLY MARKED AND INSTALLED PRIOR TO COMMENCING ANY CLEARING.
- 4. CLEAR AND GRADE FOR INSTALLATION OF SEDIMENT CONTROL DEVICES.
- 5. INSTALL SEDIMENT CONTROL DEVICES. TRAPS AND BASINS SHALL BE CONSTRUCTED PRIOR TO CONSTRUCTION OF ANY EARTH DIKES THAT CONVEY DRAINAGE TO A TRAP AND/OR BASIN.
- 6. ONCE THE SEDIMENT CONTROL DEVICES ARE INSTALLED, THE PERMITTEE MUST OBTAIN WRITTEN APPROVAL FROM THE MCDPS INSPECTOR BEFORE PROCEEDING WITH ANY ADDITIONAL CLEARING, GRUBBING OR GRADING.
- 7. ESTABLISH STREAM DIVERSION. PLACE TEMPORARY SAND BAG DIVERSION DIKES AT THE UPSTREAM AND DOWNSTREAM ENDS OF THE PROPOSED BRIDGE LOCATION. INSTALL PUMP AROUND PRACTICE.
- 8. CONSTRUCT CAST-IN-PLACE FOOTINGS, ABUTMENTS, AND BACK WALL.
- 9. INSTALL CLASS II RIPRAP.
- IO. INSTALL FRP PEDESTRIAN BRIDGE.
- II. REFORM AND STABILIZE ALL DISTURBED AREAS AT THE END OF EACH DAY.
- 12 ALL SEDIMENT CONTROL DEVICES SHALL REMAIN IN PLACE UNTIL THE CONSTRUCTION AREA IS STABILIZED INCLUDING VEGETATIVE ESTABLISHMENT. UPON STABILIZATION OF THE SITE AND WITH WRITTEN APPROVAL FROM THE MCDPS INSPECTOR, REMOVE SEDIMENT CONTROL MEASURES AND STABILIZE THOSE AREAS DISTURBED BY THE DEVICES.

SC0003

MERCADO CONSULTANTS, INC.

NO.

RECOMMENDED FOR APPROVAL

See Title Sheet

Chief, Design Section

APPROVED

See Title Sheet

Chief, Division of Transportation Engineering

Designed by :___KW_____ Drawn by :___KW______

GAITHERSBURG, MARYLAND

APPROVAL

Sheet
Crion

Date

SCALE

Checked by : __MWM__

MONTGOMERY COUNTY DEPARTMENT OF TRANSPORTATION
DIVISION OF TRANSPORTATION ENGINEERING

AUTH LANE TO KERSEY ROAD PEDESTRIAN BRIDGE


EROSION AND SEDIMENT CONTROL SEQUENCE OF CONSTRUCTION

SCALE: NONE

Project No.: 0502505

DATE: JULY, 2024

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SAND BAG DIVERSION DIKE

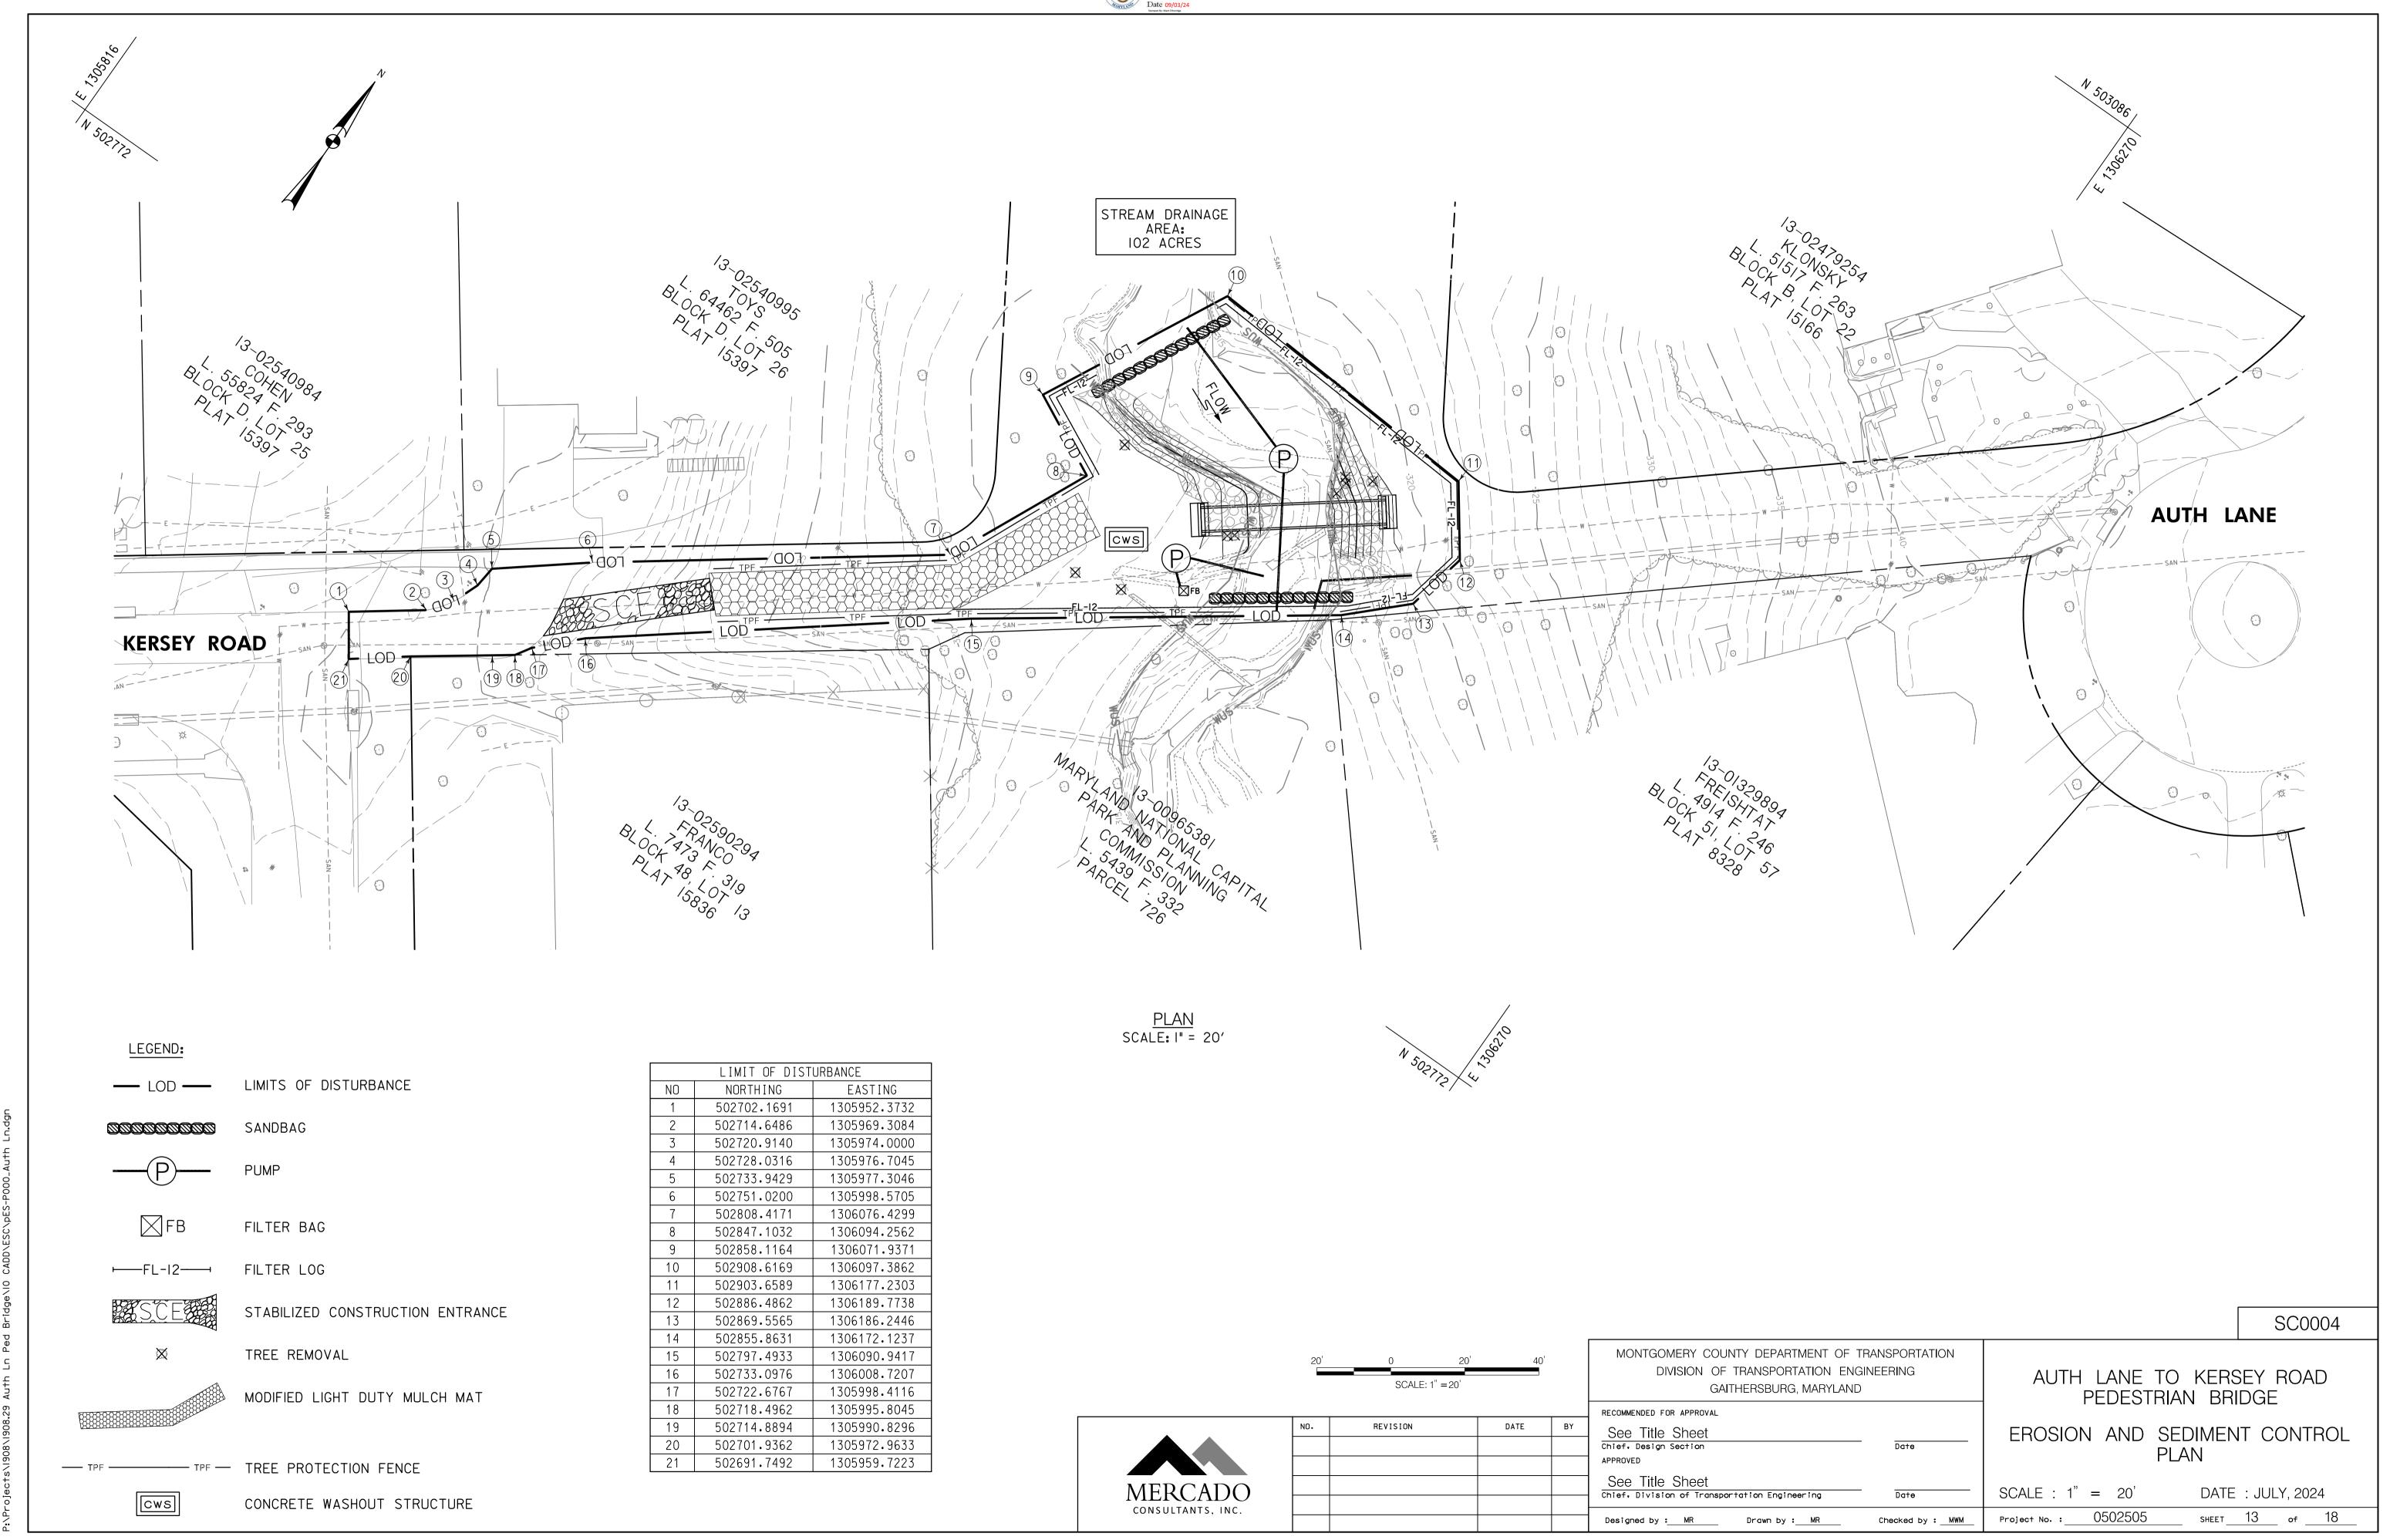I. DESCRIPTION

THE WORK SHALL CONSIST OF INSTALLING FLOW DIVERSIONS FOR THE PURPOSE OF EROSION CONTROL WHEN CONSTRUCTION ACTIVITIES TAKE PLACE WITHIN THE STREAM CHANNEL.


II. MATERIAL SPECIFICATIONS


- I. SAND BAGS: SAND BAGS SHALL CONSIST OF MATERIALS WHICH ARE RESISTANT TO ULTRA-VIOLET RADIATION, TEARING, AND PUNCTURE AND SHALL BE WOVEN TIGHTLY ENOUGH TO PREVENT LEAKAGE OF FILL MATERIAL (I.E., SAND, FINE GRAVEL, ETC.).
- 2. SHEETING: SHEETING SHALL CONSIST OF POLYETHYLENE OR OTHER MATERIAL WHICH IS IMPERVIOUS AND RESISTANT TO PUNCTURE AND TEARING.


III. CONSTRUCTION REQUIREMENTS


- I. ALL EROSION AND SEDIMENT CONTROL DEVICES SHALL BE INSTALLED AS A FIRST ORDER OF WORK.


 2. THE DIVERSION STRUCTURE SHALL BE INSTALLED FROM UPSTREAM TO DOWNSTREAM.
- 3. THE HEIGHT OF THE DIVERSION STRUCTURE SHALL BE AS SHOWN ON THESE PLANS. BASE FLOW IS DEFINED AS THE WATER DEPTH A MINIMUM OF 48 HOURS AFTER A RAIN EVENT.
- 4. ALL EXCAVATED MATERIALS SHALL BE DISPOSED AND STABILIZED IN AN APPROVED AREA OUTSIDE THE 100 YEAR FLOODPLAIN UNLESS OTHERWISE AUTHORIZED BY THE ENGINEER AND THE MDE FIELD
- INSPECTOR.
 5. SEDIMENT LADEN WATER FROM THE CONSTRUCTION AREA SHALL BE PUMPED TO THE SEDIMENT BAG.
- 6. SHEETING ON THE DIVERSION SHALL BE POSITIONED SUCH THAT THE UPSTREAM PORTION COVERS
- THE DOWNSTREAM PORTION WITH AT LEAST A 18 INCH OVERLAP.
- 7. PRIOR TO THE REMOVAL OF THESE TEMPORARY STRUCTURES, ANY ACCUMULATED SEDIMENT SHALL BE REMOVED, DEPOSITED AND STABILIZED IN AN APPROVED AREA OUTSIDE THE 100 YEAR FLOODPLAIN UNLESS OTHERWISE DIRECTED BY THE ENGINEER AND SEDIMENT CONTROL INSPECTOR.
- 8. SEDIMENT CONTROL DEVICES SHALL REMAIN IN PLACE UNTIL ALL DISTURBED AREAS ARE STABILIZED IN ACCORDANCE WITH AN EROSION AND SEDIMENT CONTROL PLAN AND THE INSPECTION AUTHORITY APPROVES THEIR REMOVAL.

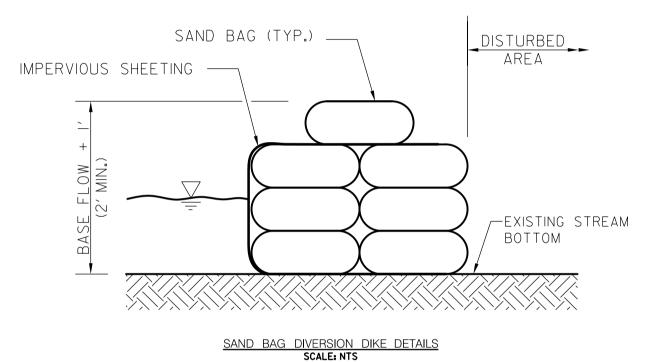


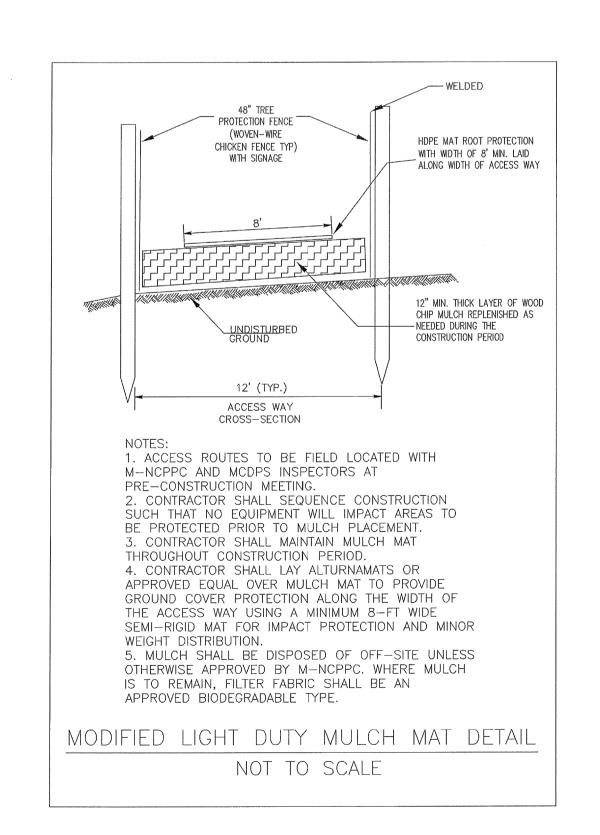

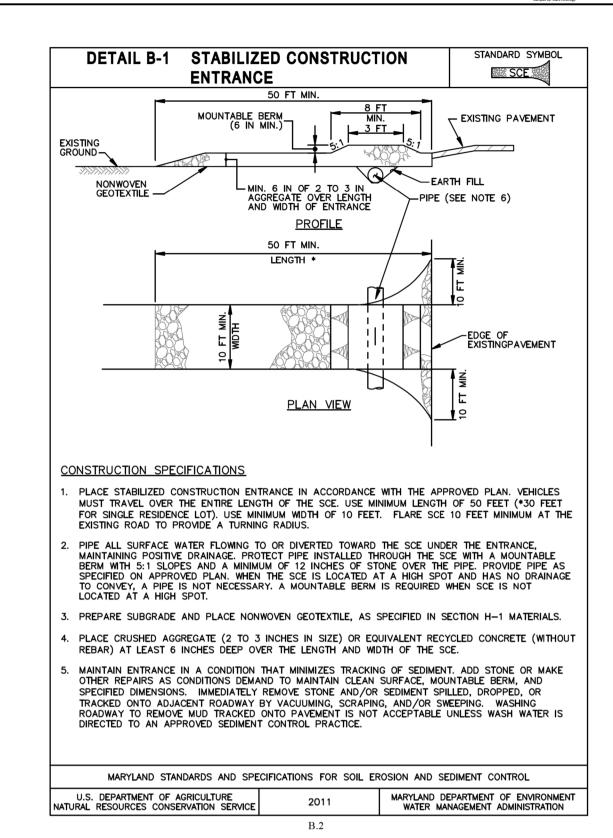

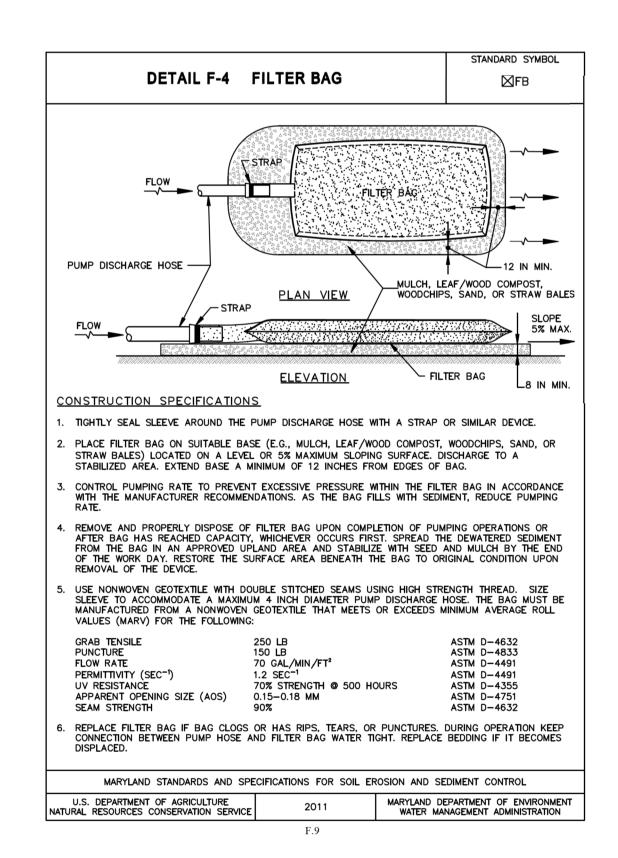

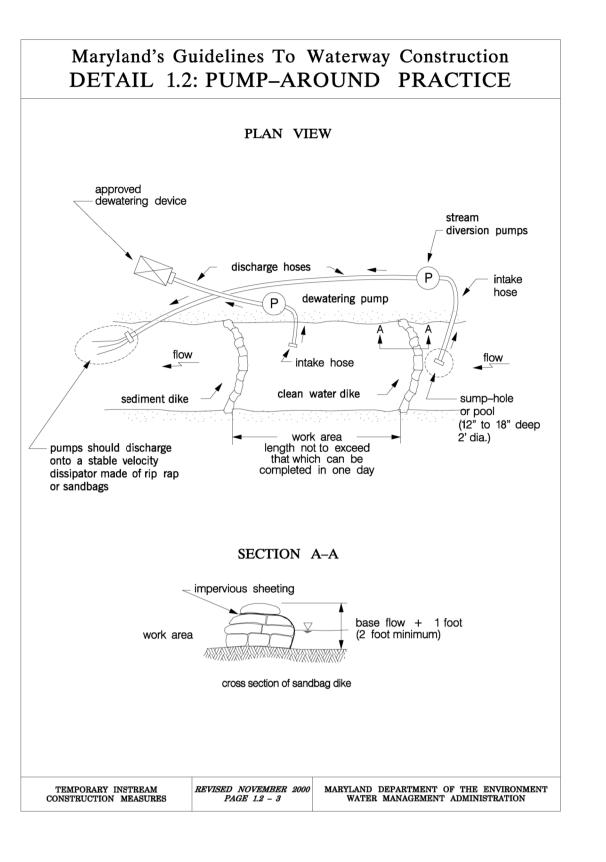

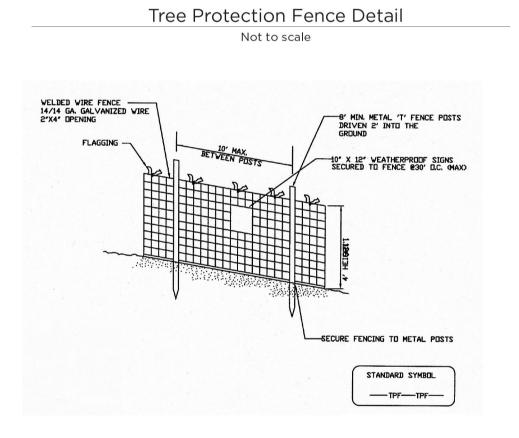


NOTES

CONSULTANTS, INC.

- 1. Practice may be combined with sediment control fencing.
- 2. Location and limits of fencing should be coordinated in field with arborist.
- 3. Boundaries of protection area should be staked
- prior to installing protective device.
 4. Root damage should be avoided.
- 5. Protection signage is required.
- 6. Fencing shall be maintained throughout construction.

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	DETAIL E-6 FILTER LOG	STANDARD SYMBOL FL-18- DESIGNATION FL-18 REFERS TO 18 INCH DIAMETER FILTER LOG
		18 INCH DIAMETER FILTER LOG
<u>CC</u>	NSTRUCTION SPECIFICATIONS	
1.	PRIOR TO INSTALLATION, CLEAR ALL OBSTRUCTIONS INCLUDING ROCKS, CLOD THAN ONE INCH THAT MAY INTERFERE WITH PROPER FUNCTION OF FILTER LO	
2.	FILL LOG NETTING UNIFORMLY WITH COMPOST (IN ACCORDANCE WITH SECTION OTHER APPROVED BIODEGRADABLE MATERIAL TO DESIRED LENGTH SUCH THA	
3.	INSTALL FILTER LOGS PERPENDICULAR TO THE FLOW DIRECTION AND PARALL THE BEGINNING AND END OF THE INSTALLATION POINTING SLIGHTLY UP THE SHAPE AT EACH END TO PREVENT BYPASS.	
4.	FOR UNTRENCHED INSTALLATION BLOW OR HAND PLACE MULCH OR COMPOSITIONS SLOPE ALONG LOG.	ON UPHILL SIDE OF THE
5.	STAKE FILTER LOG EVERY 4 FEET OR CLOSER ALONG ENTIRE LENGTH OF LOGROUND A MINIMUM OF 4 INCHES AND STAKE LOG EVERY 8 FEET OR CLOSE	
6.	USE STAKES WITH A MINIMUM NOMINAL CROSS SECTION OF 2X2 INCH AND CATTAIN A MINIMUM OF 12 INCHES INTO THE GROUND AND 3 INCHES PROTRU	OF SUFFICIENT LENGTH TO DING ABOVE LOG.
7.	WHEN MORE THAN ONE LOG IS NEEDED, OVERLAP ENDS 12 INCHES MINIMUM	AND STAKE.
8.	REMOVE SEDIMENT WHEN IT HAS ACCUMULATED TO A DEPTH OF $\mbox{\fontfamily}$ The expreplace mulch. Replace filter log if torn. Reinstall filter log if u dislodging occurs. Replace clogged filter logs. For permanent approximations by the expression of the property of the	NDERMINING OR LICATIONS, ESTABLISH AND
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	MARYLAND STANDARDS AND SPECIFICATIONS FOR SOIL EROSION AND SE	
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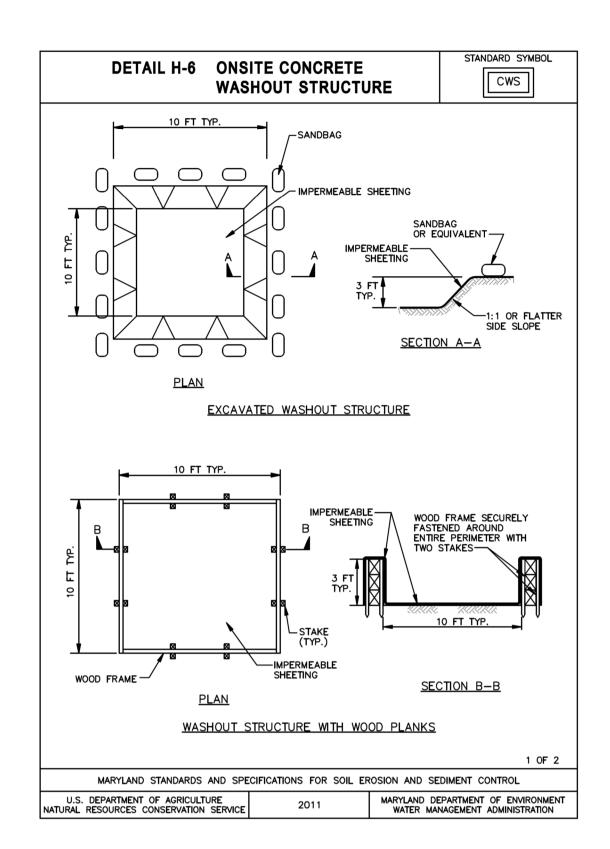
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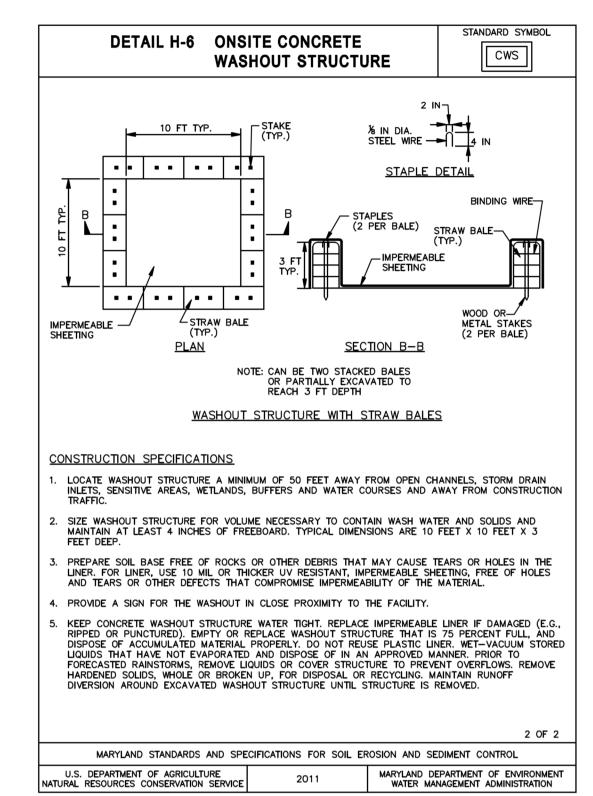
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			Chief, Design Section APPROVED	Date	STANDARD I	
			See Title Sheet Chief, Division of Transportation Engineering	Date	SCALE : NONE	DATE: JULY, 2024
			Designed by : ZK Drawn by : NL	Checked by : <u>MWM</u>	Project No. : 0502505	SHEET 14 of 18

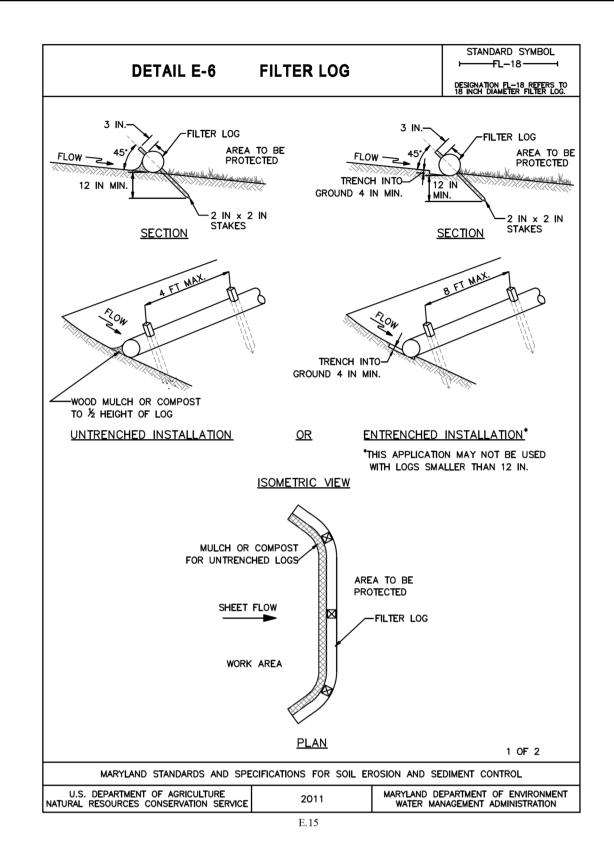MONTGOMERY COUNTY DEPARTMENT OF TRANSPORTATION

DIVISION OF TRANSPORTATION ENGINEERING





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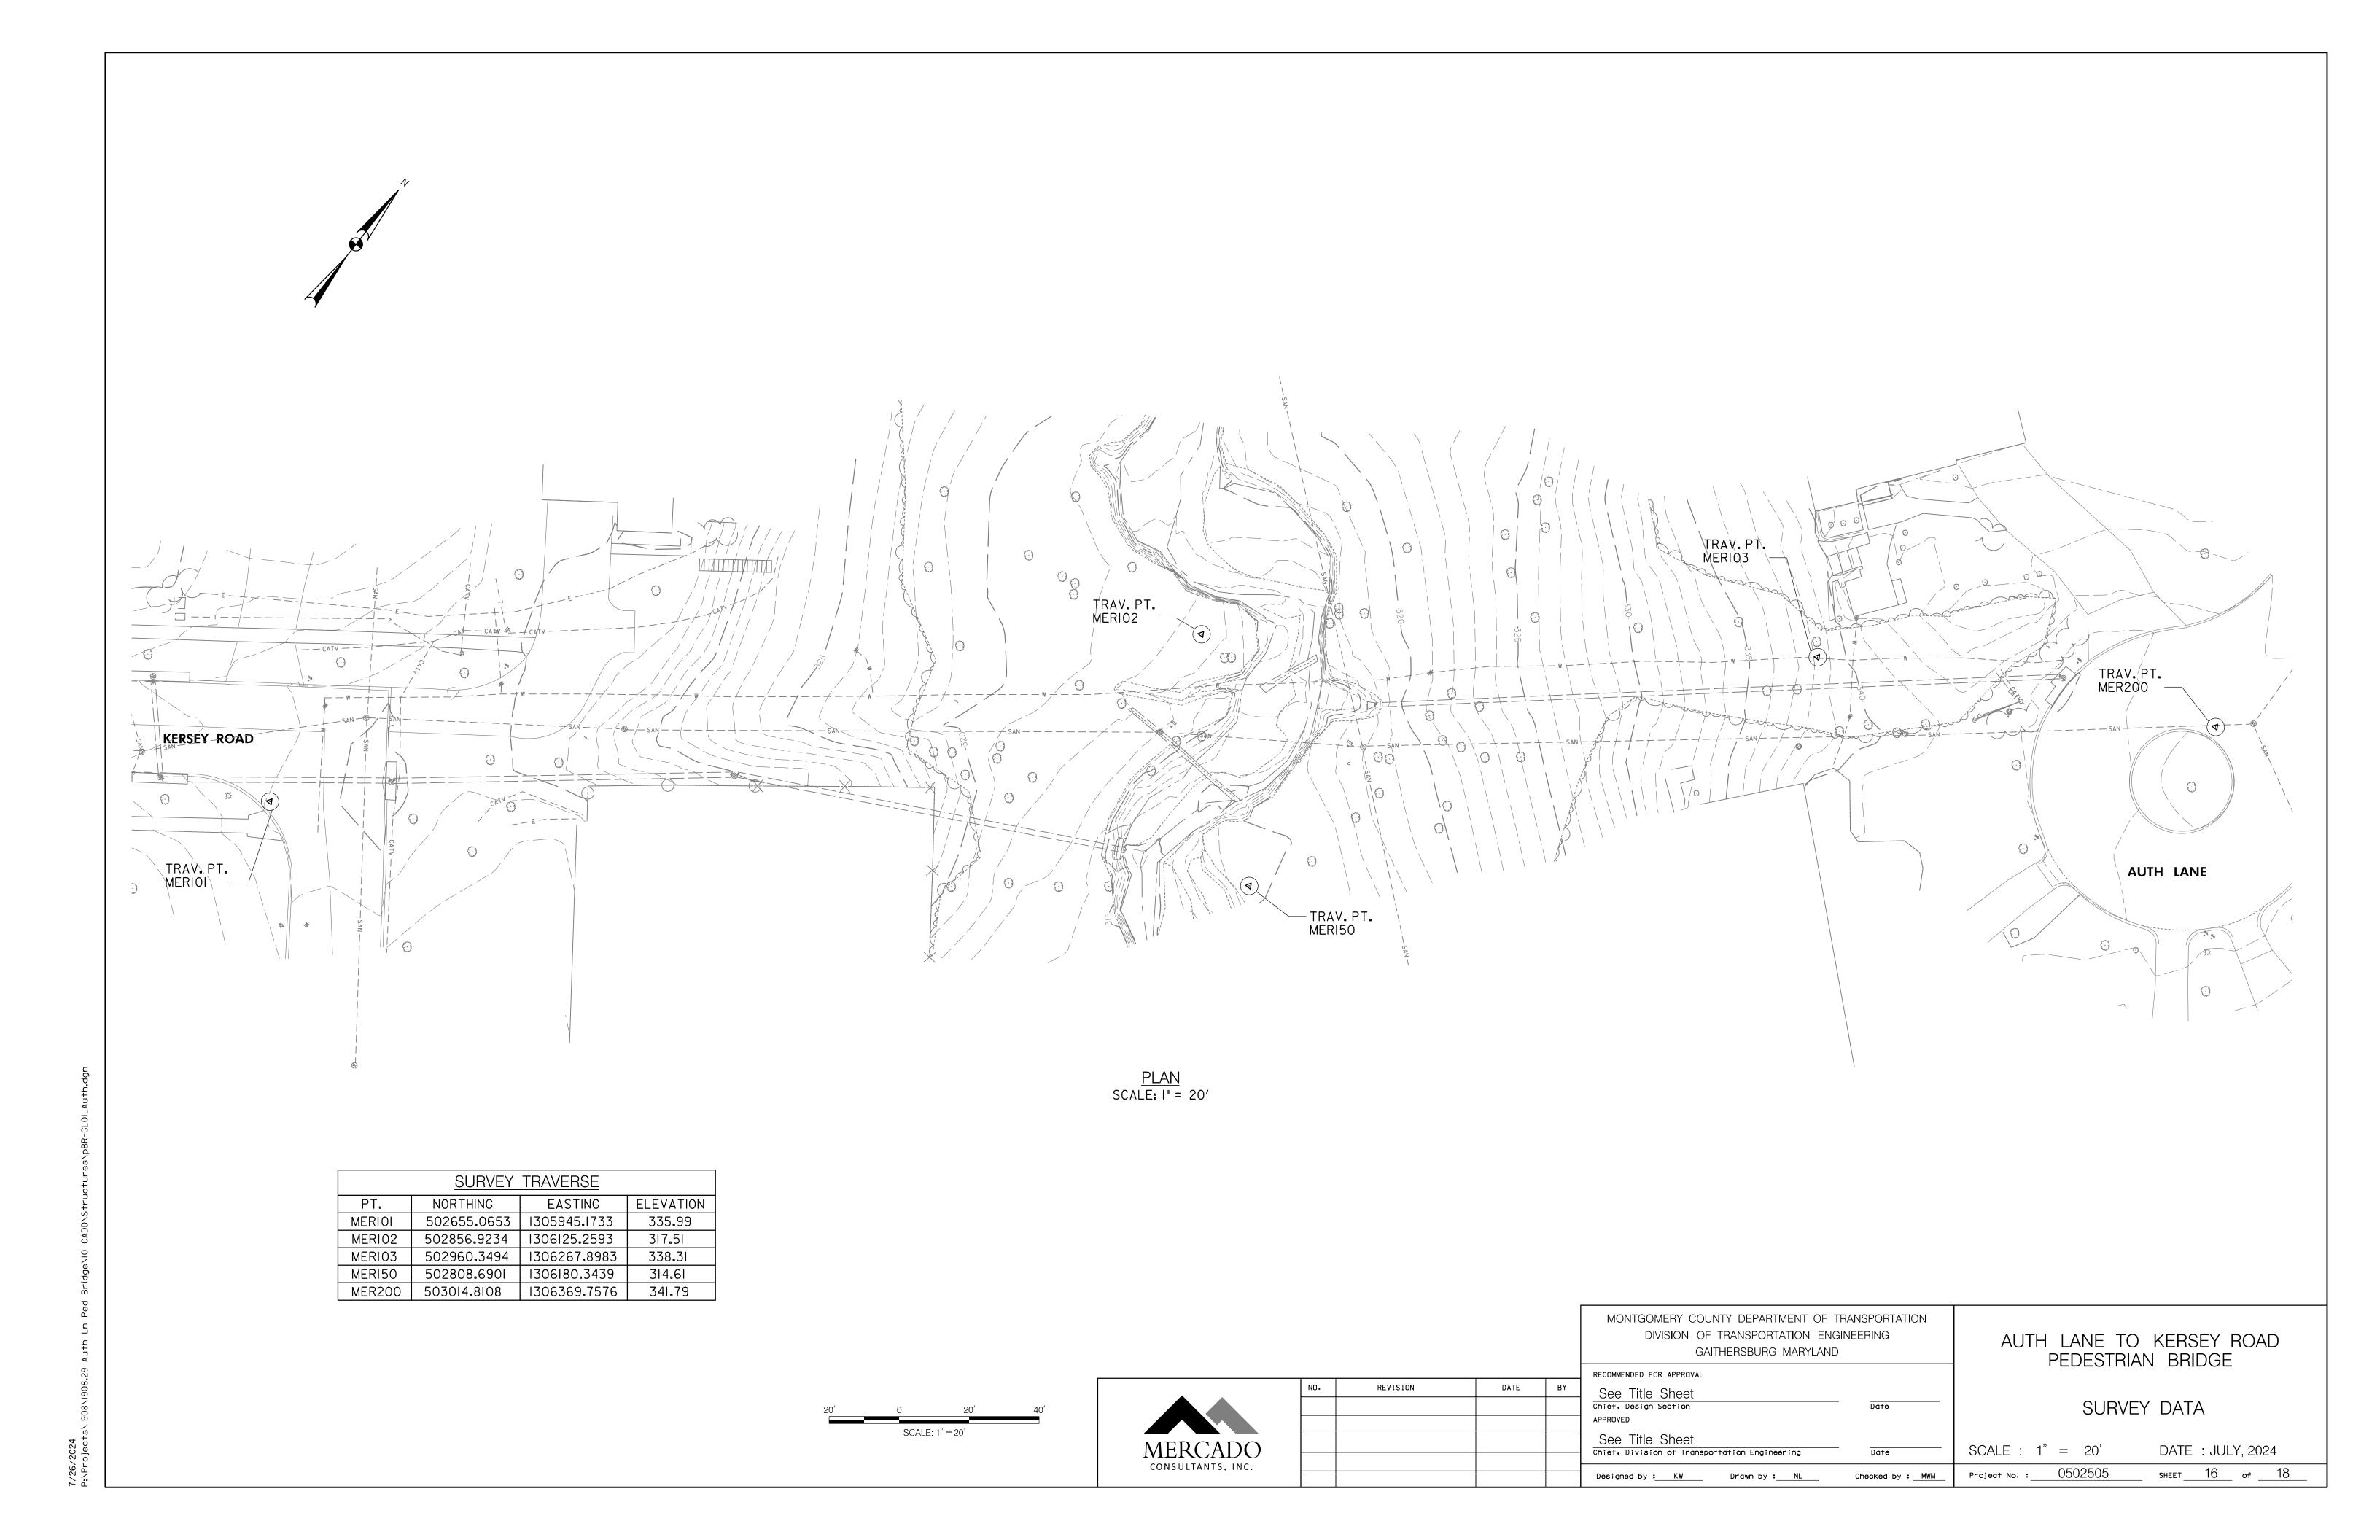
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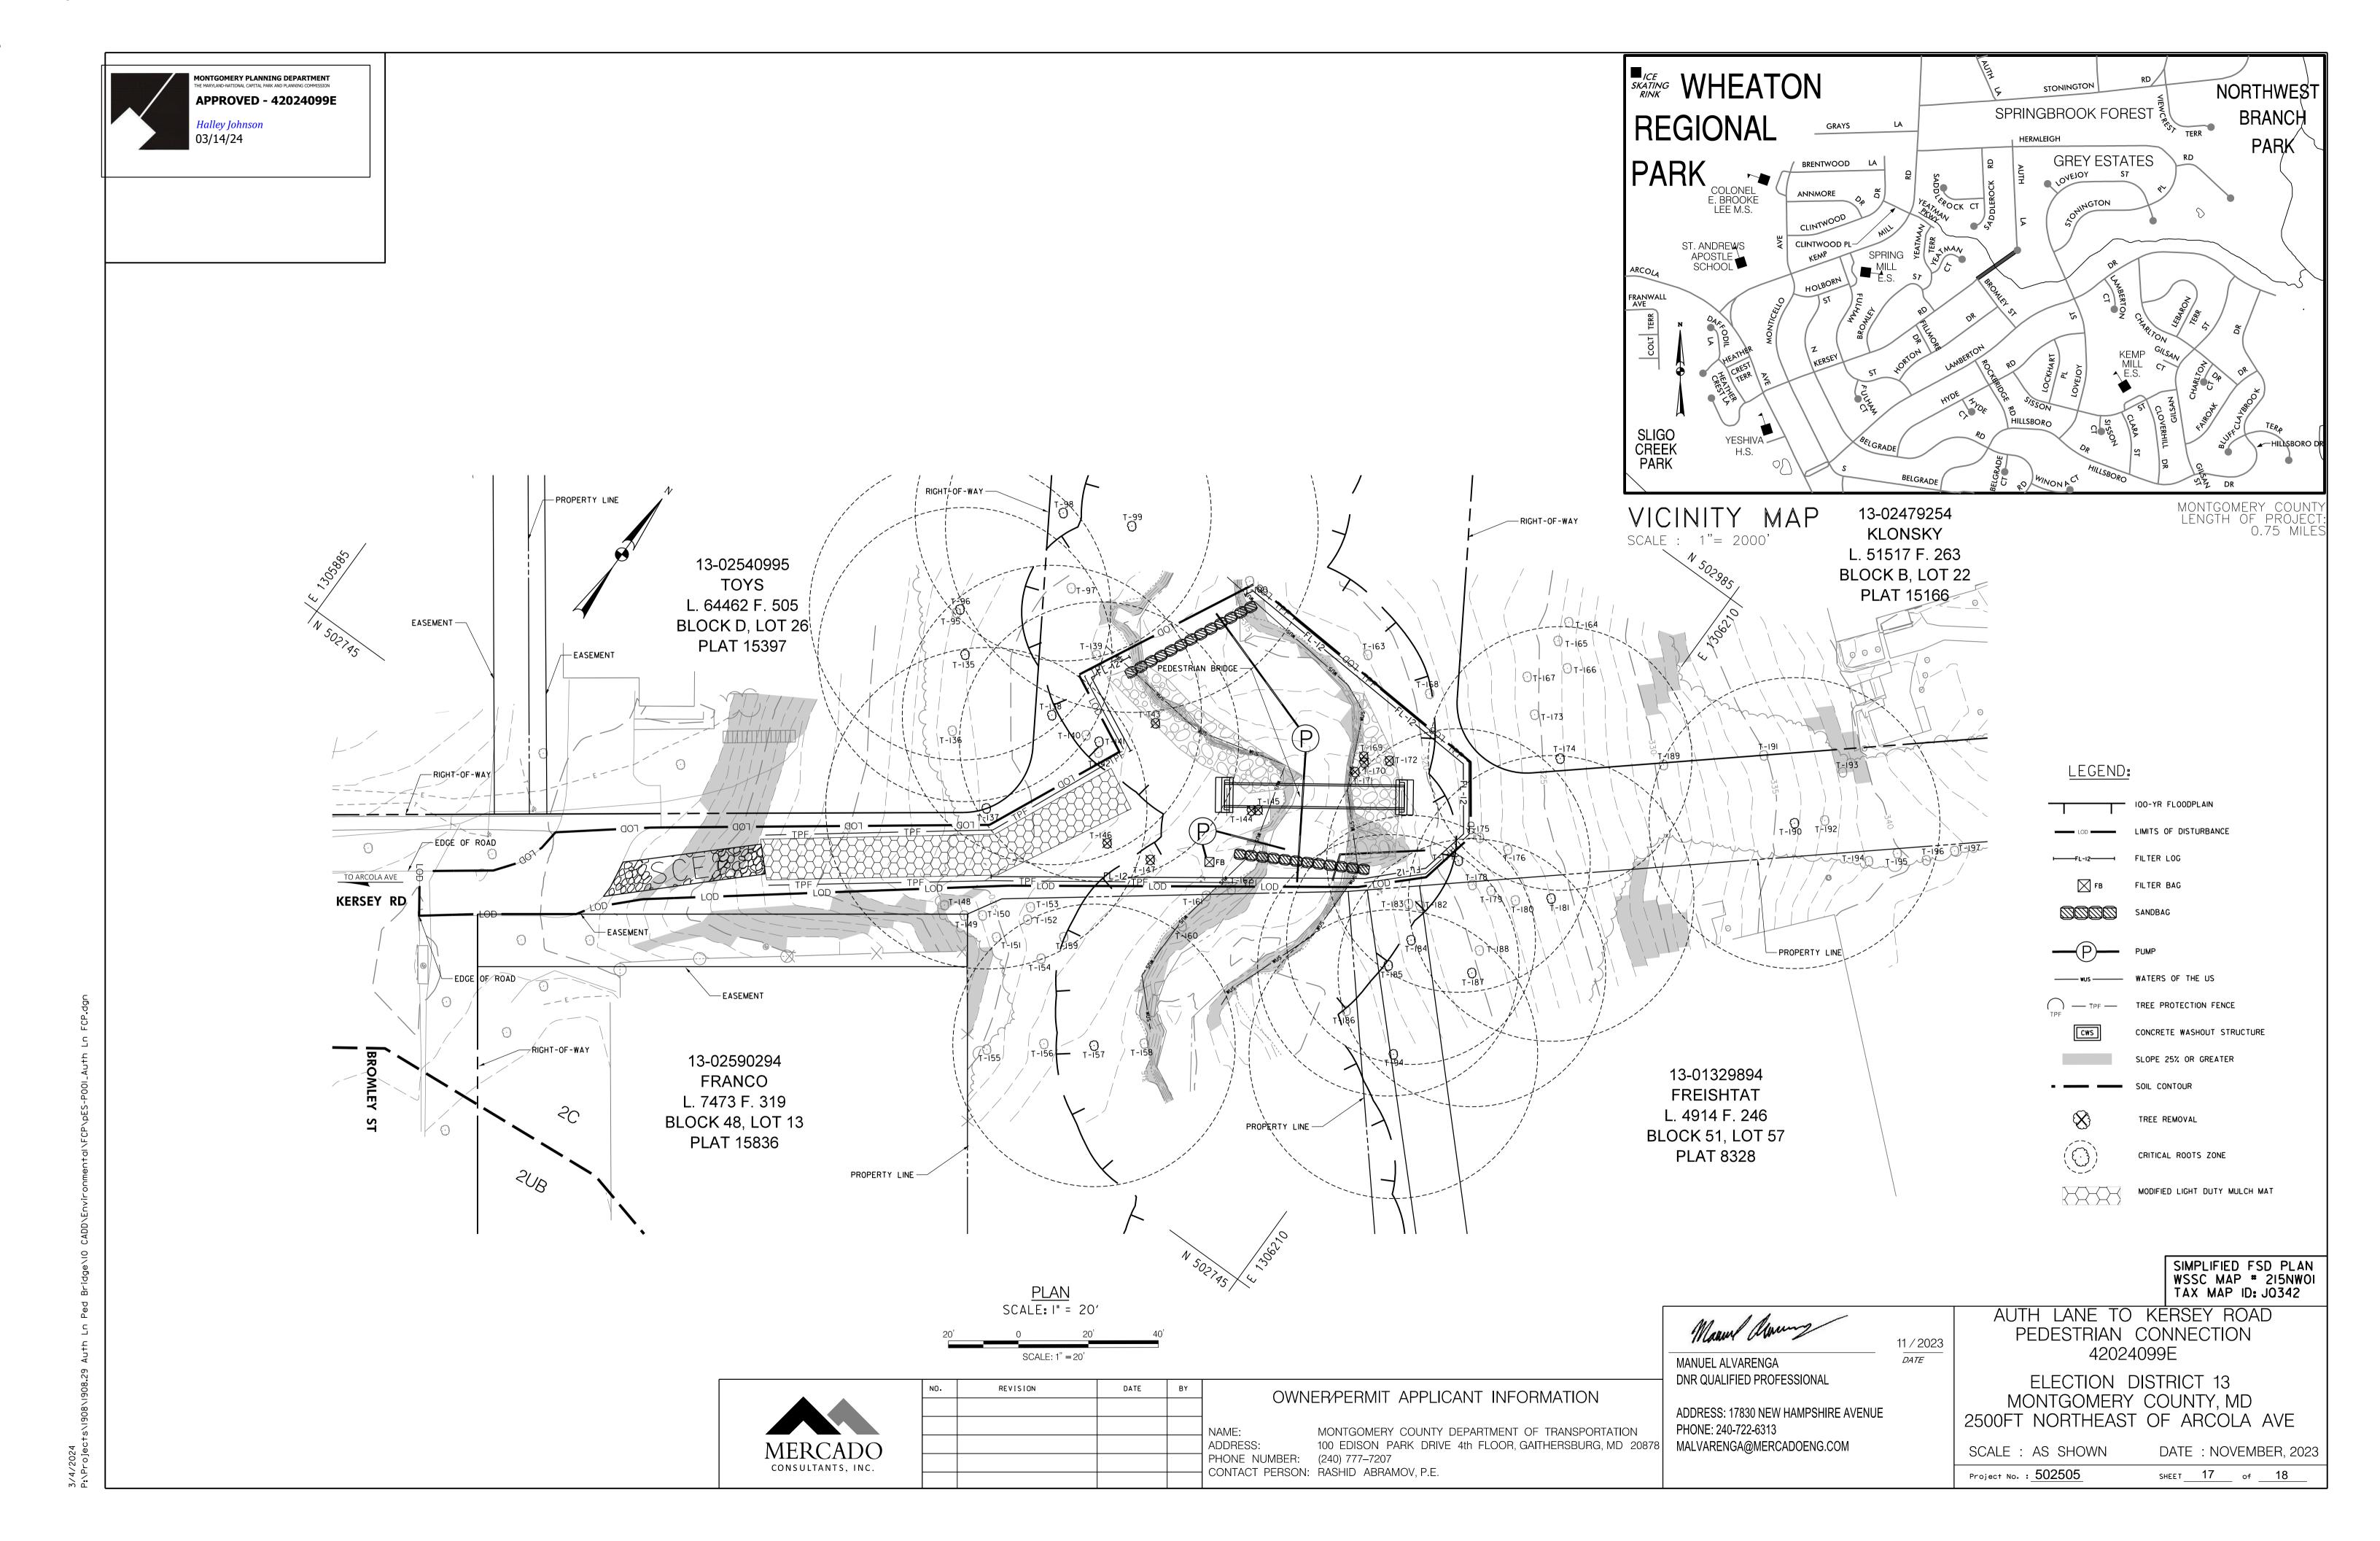
AUTH LANE TO KERSEY ROAD

GAITHERSBURG, MARYLAND PEDESTRIAN BRIDGE RECOMMENDED FOR APPROVAL REVISION See Title Sheet EROSION AND SEDIMENT CONTROL Chief, Design Section STANDARD DETAILS - 2 APPROVED See Title Sheet SCALE : NONE DATE: JULY, 2024 Chief, Division of Transportation Engineering Project No. : 0502505 SHEET 15 of 18 Designed by : ZK Drawn by : NL Checked by : <u>MWM</u>

MONTGOMERY COUNTY DEPARTMENT OF TRANSPORTATION DIVISION OF TRANSPORTATION ENGINEERING

MERCADO CONSULTANTS, INC.	






1. ACCESS ROUTES TO BE FIELD LOCATED WITH M-NCPPC AND MCDPS INSPECTORS AT PRE-CONSTRUCTION MEETING. 2. CONTRACTOR SHALL SEQUENCE CONSTRUCTION SUCH THAT NO EQUIPMENT WILL IMPACT AREAS TO BE PROTECTED PRIOR TO MULCH PLACEMENT. . CONTRACTOR SHALL MAINTAIN MULCH MAT HROUGHOUT CONSTRUCTION PERIOD. 4. CONTRACTOR SHALL LAY ALTURNAMATS OR APPROVED EQUAL OVER MULCH MAT TO PROVIDE GROUND COVER PROTECTION ALONG THE WIDTH OF THE ACCESS WAY USING A MINIMUM 8-FT WIDE SEMI-RIGID MAT FOR IMPACT PROTECTION AND MINOR WEIGHT DISTRIBUTION 5. MULCH SHALL BE DISPOSED OF OFF-SITE UNLESS OTHERWISE APPROVED BY M-NCPPC. WHERE MULCH IS TO REMAIN, FILTER FABRIC SHALL BE AN APPROVED BIODEGRADABLE TYPE.

MODIFIED LIGHT DUTY MULCH MAT DETAIL NOT TO SCALE

Tree Protection Fence Detail

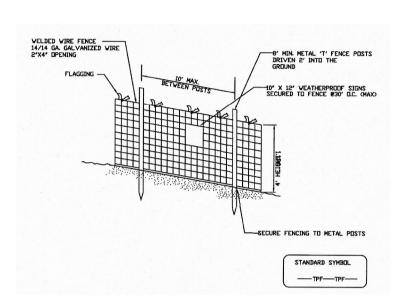

NOTES

- 1. Practice may be combined with sediment control
- Location and limits of fencing should be
- coordinated in field with arborist.
- Boundaries of protection area should be staked prior to installing protective device.
- Root damage should be avoided. Protection signage is required.
- Fencing shall be maintained throughout

Montgomery County Planning Department ■ M-NCPPC MontgomeryPlanning.org

RESOURCE DATA TABLE

Туре	Acreage
Forest	0.09
Wetland	0
Forest in Wetlands	0
Floodplain	0.08
Forest in Floodplain	0.08
Stream Buffer	0.1
Forest in Stream Buffer	0.09

NOTE:

- I. PROPOSED AREA OF FOREST TO BE DISTRUB IS 0.09 ACRES
- 2.WATERSHED: ANACOSTIA RIVER
- 3-MARYLAND STREAM USE CLASS: IV
- 4. SPECIAL PROTECTION AREA OR PATUXENT RIVER PRIMARY MANAGEMENT AREA: N/A
- 5. SOURCE OF 100-YEAR FLOODPLAIN: GENERATED
- 6.WETLAND INFORMATION SOURCE: N/A.
- 7. FEDERAL OR MARYLAND RARE, THREATENED, OR ENDANGERED SPECIES: NONE

- 8. THERE ARE NO HISTORIC SITES WITHIN THE
- IO.TREES THAT ARE AT LEAST 75 PERCENT OF THE CURRENT STATE CHAMPION: NONE
- OF TREES FORESTRY: DIAMETER TAPE AT DBH OF
- QUALIFIED PROFESSIONAL
- 13.FIELD WORK CONDUCTED: NOVEMBER 3, 2022 (FIELD)
- 14.PROJECT OCCURS WITHIN MONTGOMERY COUNTY RIGHT-OF-WAY AND THE TOTAL AREA WITHIN THE LIMIT OF DISTRUBANCE IS 10,474 SF. THIS PROJECT IS SUBMITTED UNDER SECTION 22A-5 EXEMPTION

PROJECT TRACT

9. NATIONAL, STATE, OR COUNTY CHAMPION TREES:

II. METHOD AND TOOL USED TO MEASURE DIAMETER

12.CONDUCTING FIELD WORK: MANUEL ALVARENGA DNR

& NOVEMBER 15,2022 (TREE SURVEY)

CATEGORY E.

MERCADO	
CONSULTANTS, INC.	

			ER/PERMII APPLII
		OVVIN	
		NAME:	MONTGOMERY COUNTY
		ADDRESS:	100 EDISON PARK DRIV
		PHONE NUMBER:	(240) 777–7207
		CONTACT PERSON:	RASHID ABRAMOV, P.E.

TREE INVENTORY TABLE

ICommon name

Tulip poplar

stern cottonwo

Tulip poplar

Tulip poplar

Tulip poplar

Tulip poplar

While mallberry

merican sycamor

Tulip poplar

Black walnut

Tulip poplar

Tulip poplar

Tulip poplar

merican sycamore

Dead

Tulip poplar

Tulip poplar

Tulip poplar

Dead

Red oak

Red maple

Лосkernut hickorv

Tulip poplar

Tulip poplar

Tulip poplar

Tulip poplar

Tulip poplar

White oak

Red oak

Tulip poplar

White oak

Tulip poplar

Tulip poplar

Black cherry

White oak

Eastern white pine

Eastern white pine

Eastern white pine

Eastern white pine

Tulip poplar

Tulip poplar

Tulip poplar

Red maple

Tulip poplar

Tulip poplar

Tulip poplar

REVISION

Scientific name

Liriodendron tulipifera

Populus deltoides

Liriodendron tulipifera

Liriodendron tulipifera

Liriodendron tulipifera

Liriodendron tulipifera

Morus alba

Platanus occidentalis

Liriodendron tulipifera

Liriodendron tulipifera

Liriodendron tulipifera

Liriodendron tulipifera

Platanus occidentalis

Lignum mortuum

Liriodendron tulipifera

Liriodendron tulipifera

Liriodendron tulipifera

Lignum mortuum

Quercus rubra

Acer rubrum

Carva tomentosa

Liriodendron tulipifera

Liriodendron tulipifera

Liriodendron tulipifera

Liriodendron tulipifera

Liriodendron tulipifera

Quercus alba

Quercus rubra

Liriodendron tulipifera

Liriodendron tulipifera Liriodendron tulipifera

Quercus alba

Liriodendron tulipifera

Liriodendron tulipifera

Prunus serotina

Quercus alba

Pinus strobus

Pinus strobus

Pinus strobus

Pinus strobus

Liriodendron tulipifera

Liriodendron tulipifera

Liriodendron tulipifera

Acer rubrum

Liriodendron tulipifera

Liriodendron tulipifera

Liriodendron tulipifera

DATE BY

Juglans nigra

Tree#

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NO.

OWNER/PERMIT APPLICANT INFORMATION MONTGOMERY COUNTY DEPARTMENT OF TRANSPORTATION 100 EDISON PARK DRIVE 4th FLOOR, GAITHERSBURG, MD 20878 NUMBER: (240) 777–7207

Specimen Trees

Trees to Remove

Notes

Vine growth

Dieback

Lean

Suckering, Lean

Suckering, Bark damadse

Edgeofstream

Exposed Roofs on stream Edge

Lean

Dieback, Abnormal growth

Abnormal growth pattern

Cavities, Dieback

Bark Peeling

Bark Peeling, Co-dom

Bark Peeling, Co-dom

Suckering, Cavity

Exposed roots, hollow, On the edge of stream

Exposed roots, hollow, On the edge of stream

Condition

Good

Fair

Fair

Good

Good

Good

Fair

Good

Good

Good

Dead

Fair

Fair

Good

Dead

Good

Good

Good

Good

Good

Good

Fair

Good

Fair

Good

Poor

Poor

Good

Good

Good

Poor

Good

Good

Good

Good

Good

Fair

Fair

dbh

28.0

7.0

30.6

28.5

17.0

8.1

26.6

21.7

10.4

6.5

19.1

9.4

18.1

16.5

12.2

8.9

10.5

8.2

13.6

13.1

10.9

8.4

26.9

18.3

8.6

11.3

7.4

17.1

22.0

20.1

18.5

7.5

7.8

18.1

10.6

19.7

23.1

10.2

10.2

25.1

20

20.7

25.1

12.2

12.9

11.6

27.2

7.9

14.2

23.7

24.9

18.6

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17.6

27.7

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18.8

15.7

27.5

22.3

28.7

9.9

28.2

35.5

20.2

SEQUENCE OF EVENTS

PRE-CONSTRUCTION I. AN ON-SITE PRE-CONSTRUCTION MEETING IS REQUIRED AFTER THE LIMITS OF DISTURBANCE HAVE BEEN STAKED AND FLAGGED AND BEFORE ANY LAND DISTURBANCE.

2. THE PROPERTY OWNER MUST ARRANGE FOR THE MEETING AND FOLLOWING PEOPLE SHOULD MUST PARTICIPATE AT THE PRE-CONSTRUCTION MEETING: THE PROPERTY OWNER OR THEIR REPRESENTATIVE. CONSTRUCTION SUPERINTENDENT, INTERNATIONAL SOCIETY OF ARBORICULTURE (ISA) CERTIFIED ARBORIST/MARYLAND LICENSED TREE EXPERT (REPRESENTING OWNER) THAT WILL IMPLEMENT THE TREE PROTECTION MEASURES. THE PLANNING DEPARTMENT FOREST CONSERVATION INSPECTOR, AND MONTGOMERY COUNTY DEPARTMENT OF PERMITTING SERVICES (DPS) SEDIMENT CONTROL INSPECTOR. THE PURPOSE OF THIS MEETING IS VERIFY THE LIMITS OF DISTURBANCE AND DISCUSS SPECIFIC TREE PROTECTION AND TREE CARE MEASURES SHOWN ON THE APPROVED PLAN. NO LAND DISTURBANCE SHALL BEGIN BEFORE TREE PROTECTION AND STRESS-REDUCTION MEASURES HAVE BEEN IMPLEMENTED AND APPROVED BY THE PLANNING

DEPARTMENT'S FOREST CONSERVATION INSPECTOR. A. TYPICAL TREE PROTECTION DEVICES INCLUDE: I.CHAIN LINK FENCE (FOUR FEET HIGH) II.SUPER SILT FENCE WITH WIRE STRUNG BETWEEN THE SUPPORT POLES (MINIMUM 4 FEET HIGH) WITH HIGH VISIBILITY FLAGGING. III.14 GAUGE, 2 INCH X 4 INCH WELDED WIRE FENCING SUPPORTED BY STEEL T-BAR POSTS (MINIMUM 4 FEET HIGH) WITH HIGH VISIBILITY FLAGGING

B. TYPICAL STRESS REDUCTION MEASURES MAY INCLUDE, BUT ARE NOT LIMITED TO: I.ROOT PRUNING WITH A ROOT CUTTER OR VIBRATORY PLOW DESIGNED FOR THAT PURPOSE. TRENCHERS ARE NOT ALLOWED, UNLESS APPROVED BY THE FOREST CONSERVATION INSPECTOR ILCROWN REDUCTION OR PRUNING III.WATERING IV.FERTILIZING V.VERTICAL MULCHING VI.ROOT AERATION SYSTEMS MEASURES NOT SPECIFIED ON THE FOREST CONSERVATION PLAN MAY BE REQUIRED AS DETERMINED BY THE FOREST CONSERVATION INSPECTOR IN COORDINATION WITH THE PROPERTY OWNER'S ARBORIST

3. A MARYLAND LICENSED TREE EXPERT MUST PERFORM, OR DIRECTLY SUPERVISE, THE IMPLEMENTATION OF ALL STRESS REDUCTION MEASURES. DOCUMENTATION OF THE PROCESS (INCLUDING PHOTOGRAPHS) MAY BE REQUIRED BY THE FOREST CONSERVATION INSPECTOR, AND WILL BE DETERMINED AT THE PRE-CONSTRUCTION MEETING.

4. TEMPORARY TREE PROTECTION DEVICES MUST BE INSTALLED PER THE APPROVED FOREST CONSERVATION PLAN, EXEMPTION PLAN, OR TREE SAVE PLAN AND PRIOR TO ANY LAND DISTURBANCE. THE FOREST CONSERVATION INSPECTOR, IN COORDINATION WITH THE DPS SEDIMENT CONTROL INSPECTOR. MAY MAKE FIELD ADJUSTMENTS TO INCREASE THE SURVIVABILITY OF TREES AND FOREST SHOWN AS SAVED ON THE APPROVED PLAN.

5. TREE PROTECTION FENCING MUST BE INSTALLED AND MAINTAINED BY THE PROPERTY OWNER FOR THE DURATION OF CONSTRUCTION PROJECT AND MUST NOT BE ALTERED WITHOUT PRIOR APPROVAL FROM THE FOREST CONSERVATION INSPECTOR. ALL CONSTRUCTION ACTIVITY WITHIN PROTECTED TREE AND FOREST AREAS IS PROHIBITED. THIS INCLUDES THE FOLLOWING ACTIVITIES: A.PARKING OR DRIVING OF EQUIPMENT, MACHINERY OR VEHICLES OF ANY TYPE. B.STORAGE OF ANY CONSTRUCTION MATERIALS, EQUIPMENT, STOCKPILING, FILL, DEBRIS, ETC. C.DUMPING OF ANY CHEMICALS (I.E., PAINT THINNER), MORTAR OR CONCRETE REMAINDER, TRASH, GARBAGE, OR DEBRIS OF ANY KIND. D.FELLING OF TREES INTO A PROTECTED AREA. E.TRENCHING OR GRADING FOR UTILITIES. IRRIGATION. DRAINAGE, ETC.

5. FOREST AND TREE PROTECTION SIGNS MUST BE INSTALLED AS REQUIRED BY THE FOREST CONSERVATION INSPECTOR. THE SIGNS MUST BE WATERPROOF AND WORDING PROVIDED IN BOTH ENGLISH AND SPANISH. DURING CONSTRUCTION

7. PERIODIC INSPECTIONS WILL BE MADE BY THE FOREST CONSERVATION INSPECTOR. CORRECTIONS AND REPAIRS TO TREE PROTECTION DEVICES MUST BE COMPLETED WITHIN THE TIME FRAME GIVEN BY THE INSPECTOR.

8. THE PROPERTY OWNER MUST IMMEDIATELY NOTIFY THE FOREST CONSERVATION INSPECTOR OF ANY DAMAGE TO TREES, FORESTS, UNDERSTORY, GROUND COVER, AND ANY OTHER UNDISTURBED AREAS SHOWN ON THE APPROVED PLAN. REMEDIAL ACTIONS, AND THE RELATIVE TIME FRAMES TO RESTORE THESE AREAS, WILL BE DETERMINED BY THE FOREST CONSERVATION INSPECTOR. POST-CONSTRUCTION

9. AFTER CONSTRUCTION IS COMPLETED, BUT BEFORE TREE PROTECTION DEVICES HAVE BEEN REMOVED. THE PROPERTY OWNER MUST REQUEST A FINAL INSPECTION WITH THE FOREST CONSERVATION INSPECTOR. AT THE FINAL INSPECTION, THE FOREST CONSERVATION INSPECTOR MAY REQUIRE ADDITIONAL CORRECTIVE MEASURES. WHICH MAY INCLUDE: A.REMOVAL, AND POSSIBLE REPLACEMENT, OF DEAD, DYING, OR HAZARDOUS TREES B.PRUNING OF DEAD OR DECLINING LIMBS C.SOILAERATION D.FERTILIZATION E.WATERING F.WOUND REPAIR

G.CLEAN UP OF RETENTION AREAS, INCLUDING TRASH REMOVAL

LAFTER THE FINAL INSPECTION AND COMPLETION OF ALL CORRE CONSERVATION INSPECTOR WILL REQUEST ALL TEMPORARY TREE AND FOREST PROTECTION DEVICES BE REMOVED FROM THE SITE. REMOVAL OF TREE PROTECTION DEVICES THAT ALSO OPERATE FOR EROSION AND SEDIMENT CONTROL MUST BE COORDINATED WITH BOTH DPS AND THE FOREST CONSERVATION INSPECTOR AND CANNOT BE REMOVED WITHOUT PERMISSION OF THE FOREST CONSERVATION INSPECTOR. NO ADDITIONAL GRADING, SODDING, OR BURIAL MAY TAKE

PLACE AFTER THE TREE PROTECTION FENCING IS REMOVED.

II. LONG-TERM PROTECTION MEASURES, INCLUDING PERMANENT SIGNAGE, MUST BE INSTALLED PER THE APPROVED PLAN. INSTALLATION WILL OCCUR AT THE APPROPRIATE TIME DURING THE CONSTRUCTION PROJECT. REFER TO THE APPROVED PLAN DRAWING FOR THE LONG-TERM PROTECTION MEASURES TO BE INSTALLED

11/2023

DATE

SOIL SURVEY

Map Unit Symbol	Map Unit Name	K-Factor (Whole Soil)	Hydric Rating	Hydrologic Soil Group	Drainage Rating	Serpentine Soil	Prime Agricultural
2C	Glenelg silt loam, 8 to 15 percent slopes	0.37	0	В	Well drained	No	Yes
2UB	Glenelg-Urban land complex, 0 to 8 percent slopes percent slopes	0.28	0	В	Well drained	No	No

SIMPLIFIED FSD PLAN WSSC MAP # 215NWOI TAX MAP ID: JQ342

Manuel Claring

MANUEL ALVARENGA DNR QUALIFIED PROFESSIONAL

ADDRESS: 17830 NEW HAMPSHIRE AVENUE PHONE: 240-722-6313 MALVARENGA@MERCADOENG.COM

AUTH LANE TO KERSEY ROAD PEDESTRIAN CONNECTION

42024099E TREE TABLE **ELECTION DISTRICT 13** MONTGOMERY COUNTY, MD 2500FT NORTHEAST OF ARCOLA AVE

SCALE : AS SHOWN Project No. : 502505

DATE: NOVEMBER, 2023

SHEET 18 of 18