INDEX OF CHEETO

S-11

S-16

GENERAL NOTES

SEDIMENT CONTROL.

SHALL BE SEEDED AND MULCHED.

OF HIS RESPONSIBILITY TO COMPLETE SUCH WORK.

32

INDE	EX OF	SHEETS
NO.	SHEET NO.	TITLE
1	T-1	TITLE SHEET
2	TS-01	TYPICAL SECTIONS & PAVING DETAILS
3	GL-01	GEOMETRIC LAYOUT
46 4-5	PS-01 TO	ROADWAY PLAN (2 SHEETS) (2 SHEETS)
6A	PS-02 PS-03	TURNAROUND SITE PLAN AND DETAILS
7	ES-01	EROSION AND SEDIMENT CONTROL NOTES (1 OF 3)
8	ES-02	EROSION AND SEDIMENT CONTROL DETAILS (2 OF 3)
9	E9-03	EROSION AND SEDIMENT CONTROL PLAN (20F 2)
10	SW-01	STORM DRAIN PLAN VIEW
11	SW 02	STORMWATER MANACEMENT PLAN VIEW
12	SW-03	STORM DRAIN PROFILES, SCHEDULES AND DETAILS
13	OW-04	CTORM WATER MANAGEMENT DETAILS
14	SN-01	SIGNING AND PAVEMENT MARKING
14A 15-16	SN-02 LP-01 TO	CROSSWALK LIGHTING PLAN (2 SHEETS)
	LP-02	
17	LP-03	LIGHTING NOTES
18	MT-01	MAINTENANCE OF TRAFFIC NOTES
19	MT-02	FLAGGING OPERATION
20	MT-03	DETOUR PLAN
21	S-1	BRIDGE GENERAL NOTES
22	S-2	BRIDGE GENERAL PLAN AND ELEVATION
23-29	S-3 TO	FRAMING PLAN (7 SHEETS)
	S-9	

DECK JOINT REPAIR AND DRAIN TROUGH DETAILS

DRAINAGE TROUGH AT BUTTRESS ELEVATION

SIDEWALK AND CURB JOINT SEAL DETAILS

1. ALL CONSTRUCTION SHALL BE DONE IN ACCORDANCE WITH MARYLAND DOT SHA STANDARD

SPECIFICATIONS FOR CONSTRUCTION AND MATERIALS DATED JULY 2021, INCLUDING REVISIONS

STANDARDS, AND 2011 MARYLAND STANDARDS AND SPECIFICATIONS FOR SOIL EROSION AND

THE EXISTING UTILITIES AND OBSTRUCTION SHOWN ARE FROM THE AVAILABLE RECORDS AND

4. ALL GRADING SHALL BE DONE IN SUCH A MANNER AS TO PROVIDE POSITIVE DRAINAGE.

THEREOF AND ADDITIONS THERETO AND SPECIAL PROVISIONS, BOOK OF STANDARDS FOR HIGHWAYS,

INCIDENTAL STRUCTURES AND TRAFFIC CONTROL APPLICATIONS, MONTGOMERY COUNTY DOT DESIGN

SHALL BE FIELD VERIFIED BY THE CONTRACTOR PRIOR TO CONSTRUCTION. NECESSARY PRECAUTIONS

REPAIRED BY THE CONTRACTOR IN COORDINATION WITH THE UTILITY OWNER AT NO COST TO THE COUNTY.

SHALL BE USED BY THE CONTRACTOR TO PROTECT EXISTING UTILITIES, AND ANY DAMAGE TO THE UTILITIES DUE TO THE CONTRACTOR'S NEGLIGENCE OR METHOD OF OPERATION SHALL BE IMMEDIATELY

5. DISTURBED AREAS ADJACENT TO ESTABLISHED LAWNS SHALL BE SODDED. OTHER DISTURBED AREAS

6. IT SHALL BE DISTINCTLY UNDERSTOOD THAT FAILURE TO MENTION SPECIFICALLY ANY WORK WHICH

7. THE CONTRACTOR SHALL CALL "MISS UTILITY" (1-800-257-7777) A MINIMUM OF 48 HOURS IN

PLANS ONLY. FOR DETAILED INFORMATION SEE THE APPROPRIATE RIGHT-OF-WAY PLATS.

9. ACCESS TO ADJACENT EXISTING HOMES' ENTRANCE SHALL BE MAINTAINED DURING CONSTRUCTION.

THE FOLLOWING STANDARDS (CONSTRUCTION AND TEMPORARY

a. 620.02 - STANDARD TYPES A & B CONCRETE CURB AND COMBINATION CONCRETE

http://apps.roads.maryland.gov/businesswithsha/bizStdsSpecs/desManualStdPub

ALL ITEMS ARE TO BE CONSTRUCTED IN ACCORDANCE WITH THE CURRENT VERSION OF THE

FOR ALL STANDARDS REFERRED TO ON THE PLANS THE CONTRACTOR MUST GO TO

THE BOOK OF STANDARDS WHICH WILL HAVE THE MOST CURRENT VERSION. THE

TRAFFIC CONTROL) ARE REQUIRED FOR THIS PROJECT:

WOULD NATURALLY BE REQUIRED TO COMPLETE THE PROJECT SHALL NOT RELIEVE THE CONTRACTOR

8. RIGHT-OF-WAY AND EASEMENT LINES SHOWN ON THESE PLANS ARE FOR ASSISTANCE IN INTERPRETING

ADVANCE OF ANY EXCAVATION AND /OR DIGGING TO DETERMINE THE LOCATION OF UNDERGROUND UTILITIES.

PARAPET JOINT REPAIR (4 SHEETS)

CONCRETE SPALL REPAIR DETAILS

DOWNSPOUT DETAILS

3. CLEARING IS TO BE LIMITED TO THE "LOD" AS SHOWN ON THE PLANS.

MONTGOMERY COUNTY DEPARTMENT OF TRANSPORTATION REHABILITATION OF BRIDGE NO. M-0229 ON BRIGHTON DAM ROAD OVER BRIGHTON DAM

C. I. P. PROJECT NO. 0501907

SUNSHINE Triadelphia PROJECT LOCATION Reservoir BRIDGE NO. M-0229 CLARKSVILLE 216 HIGHLAND BRINKLOW TANTERRA

VICINITY MAP

I HEREBY CERTIFY THAT THESE DOCUMENTS WERE PREPARED OR APPROVED BY ME, AND THAT I AM A DULY LICENSED PROFESSIONAL ENGINEER UNDER THE LAWS OF THE STATE OF MARYLAND. LICENSE NO. 28888 EXPIRATION DATE 06-20-2023

90% PLAN SUBMISSION June 28, 2022

RELATED REQUIRED PERMITS IT IS THE RESPONSIBILTY OF PERMITTEE/OWNER OF THIS SITE TO OBTAIN ALL REQUIRED PERMITS PRIOR TO ISSUANCE OF APPROVED WATERWAYS/WETLAND(S): X . MDE Water Quality MDE Dam Safety N.P.D.E.S. NOTICE OF INTENT DNR Roadside Tree Permit MCDPS Roadside Tree Plan MNCPPC FCP Exemption HOWARD COUNTY DPW

OWNER/PERMIT APPLICANT INFORMATION

MONTGOMERY COUNTY DEPARTMENT OF TRANSPORTATION 100 EDISON PARK DRIVE, 4TH FLOOR, GAITHERSBURG, MD 20878

PHONE NUMBER: (240) 777-7220 CONTACT PERSON: TIMOTHY H. CUPPLES

OWNER'S CERTIFICATION

I HEREBY CERTIFY THAT ALL CLEARING, GRADING, CONSTRUCTION AND/OR DEVELOPMENT WILL BE DONE PURSUANT TO THIS PLAN AND THAT ANY RESPONSIBLE PERSONNEL INVOLVED IN THE CONSTRUCTION PROJECT WILL HAVE A CERTIFICATE OF ATTENDANCE AT A DEPARTMENT OF NATURAL RESOURCES APPROVED TRAINING PROGRAM FOR THE CONTROL OF SEDIMENT AND EROSION BEFORE BEGINNING THE PROJECT.

DATE

TIMOTHY H. CUPPLES CHIEF, DIVISION OF TRANSPORTATION ENGINEERING

DESIGN CERTIFICATION

I HEREBY CERTIFY THAT THIS PLAN HAS BEEN PREPARED IN ACCORDANCE WITH THE "2011 MARYLAND STANDARDS AND SPECIFICATIONS FOR SOIL EROSION AND SEDIMENT CONTROL", MONTGOMERY COUNTY DEPARTMENT OF PERMITTING SERVICES EXECUTIVE REGULATIONS 5-90, 7-02AM AND 36-90, AND MONTGOMERY COUNTY DEPARTMENT OF TRANSPORTATION "STORM DRAIN DESIGN CRITERIA" DATED JUNE 2014.

DATE

PRINTED NAME: DEGANG LI. MD. REGISTRATION NO.: 28888

DESIGN TRAFF	IC DATA	1	
ROADWAY	BRIGHTON	N DAM ROAD	
CONTROLS / YEARS	2021	2041	
AVERAGE DAILY TRAFFIC (A.D.T.)	5685	8450	
% TRUCKS - A.D.T.	5.1%	6%	
DESIGN SPEED	30 M.P.H		
FUNCTIONAL CLASSIFICATION	MAJOR (COLLECTOR	
CONTROL OF ACCESS	NC	NE	
POSTED SPEED	30	M.P.H.	

DATUM

HORIZONTAL DATUM	NAD 83 / 91
VERTICAL DATUM	NAVD 88

PROFESSIONAL CERTIFICATION

OWNER/ADDRESS:

MONTGOMERY COUNTY DEPARTMENT OF TRANSPORTATION DEPARTMENT OF TRANSPORTATION GAITHERSBURG, MARYLAND 100 EDISON PARK DRIVE GAITHERSBURG, MARYLAND RECOMMENDED FOR APPROVAL Chief, Design Section Date DIVISION OF TRANSPORTATION ENGINEERING APPROVED CONSTRUCTION SECTION 240-777-7210 Chief, Division of Transportation Engineering Date DESIGN SECTION 240-777-7221 Drawn by: DL Checked by: DHM III REVISION

T-1

TITLE SHEET

REHABILITATION OF BRIDGE NO. M-0229

ON BRIGHTON DAM ROAD OVER

BRIGHTON DAM

of 38 0501907 SHEET Project No. :


MODELNAME: \$MODELNAME\$


CURB & GUTTER


BOOK OF STANDARDS CAN BE ACCESSED AT:


/publicationsonline/ohd/bookstd/index.asp

REFERENCED STANDARD AT THE TIME OF CONSTRUCTION.

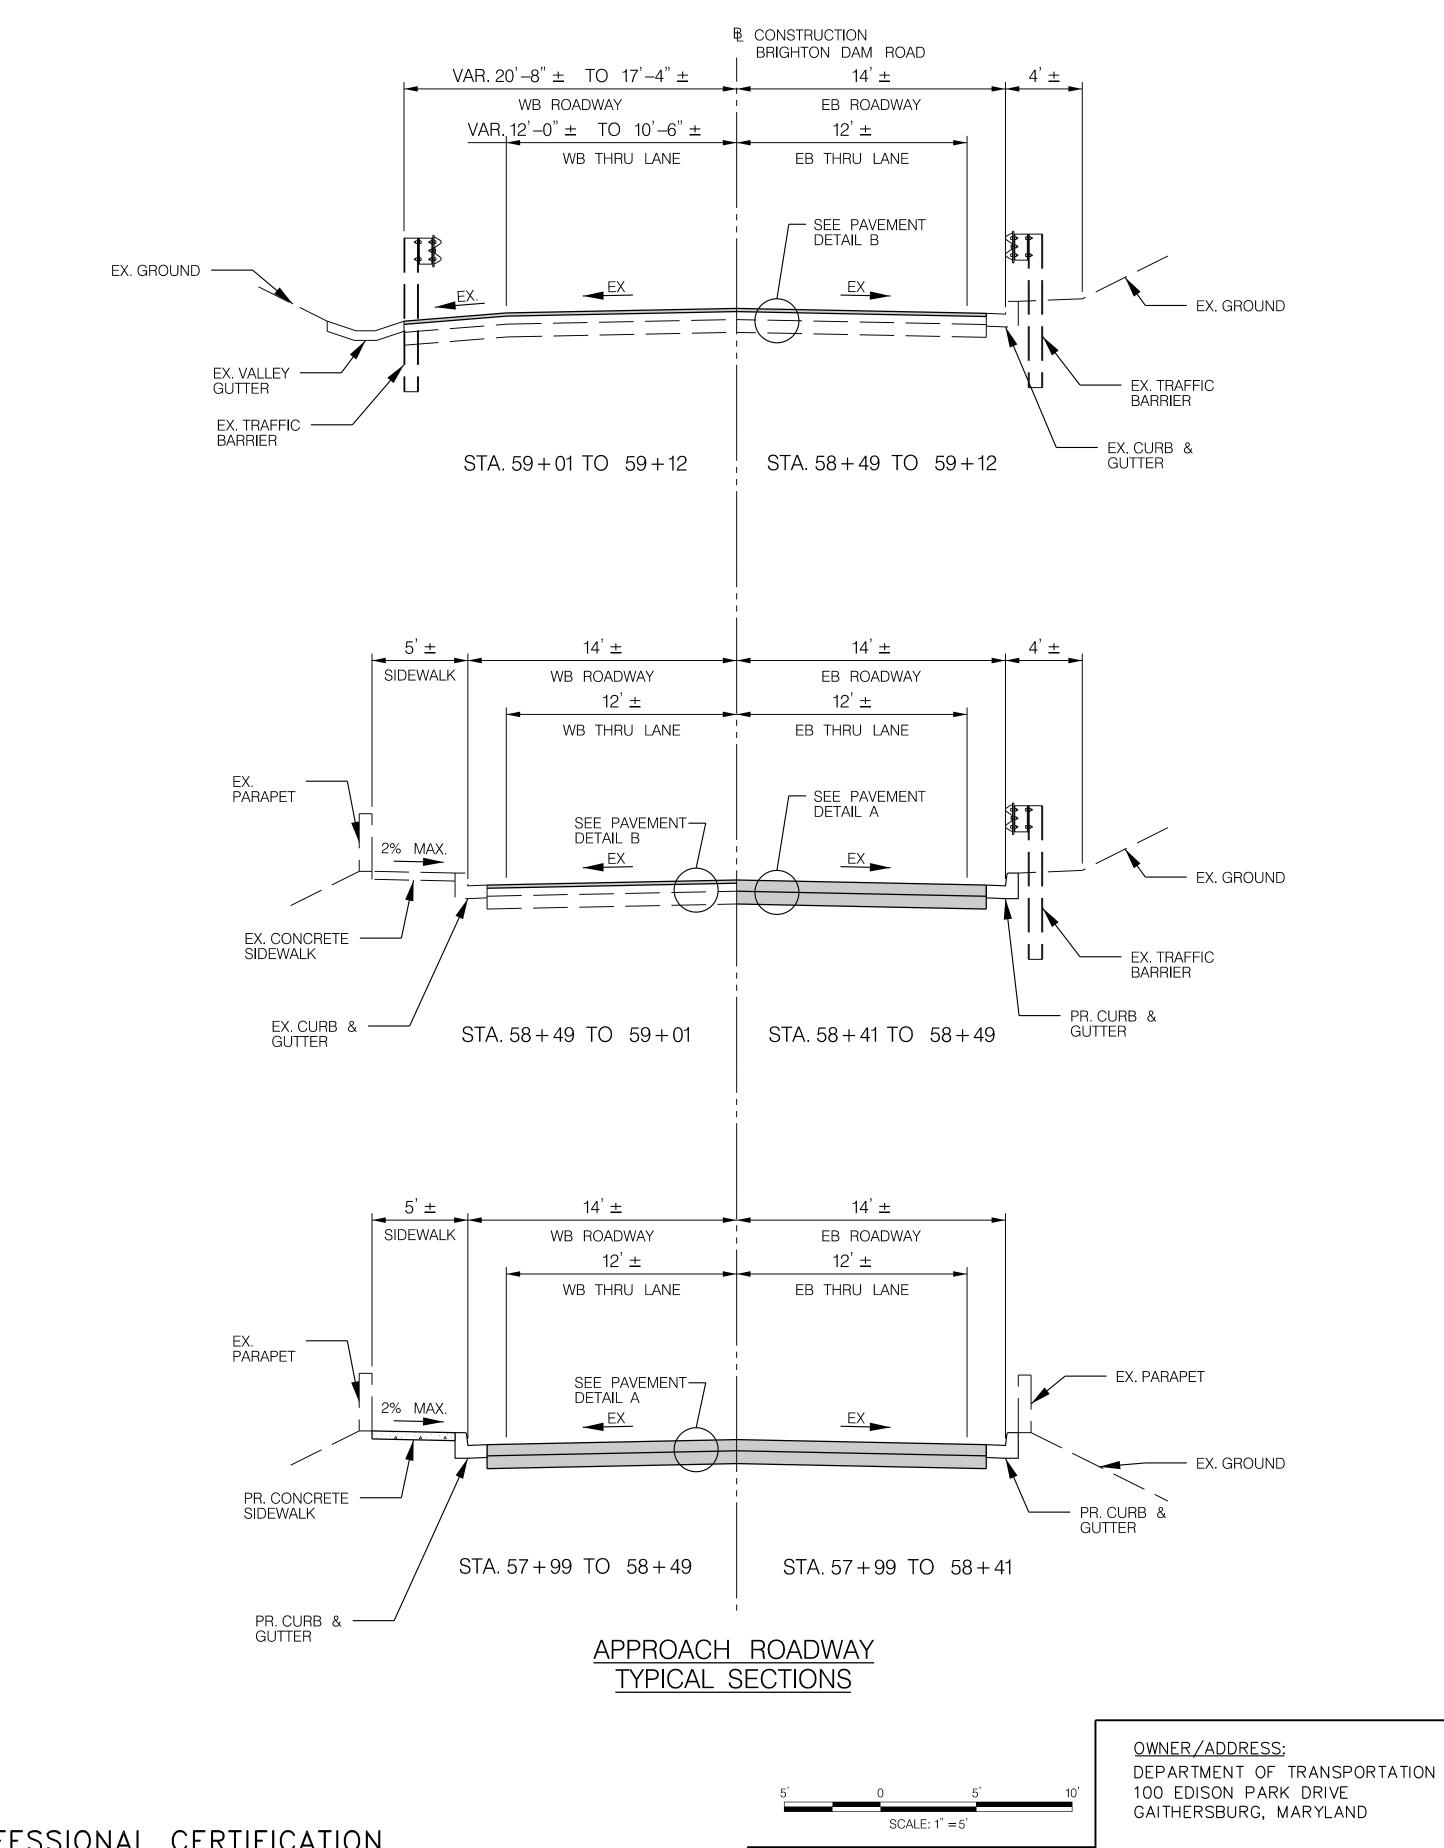

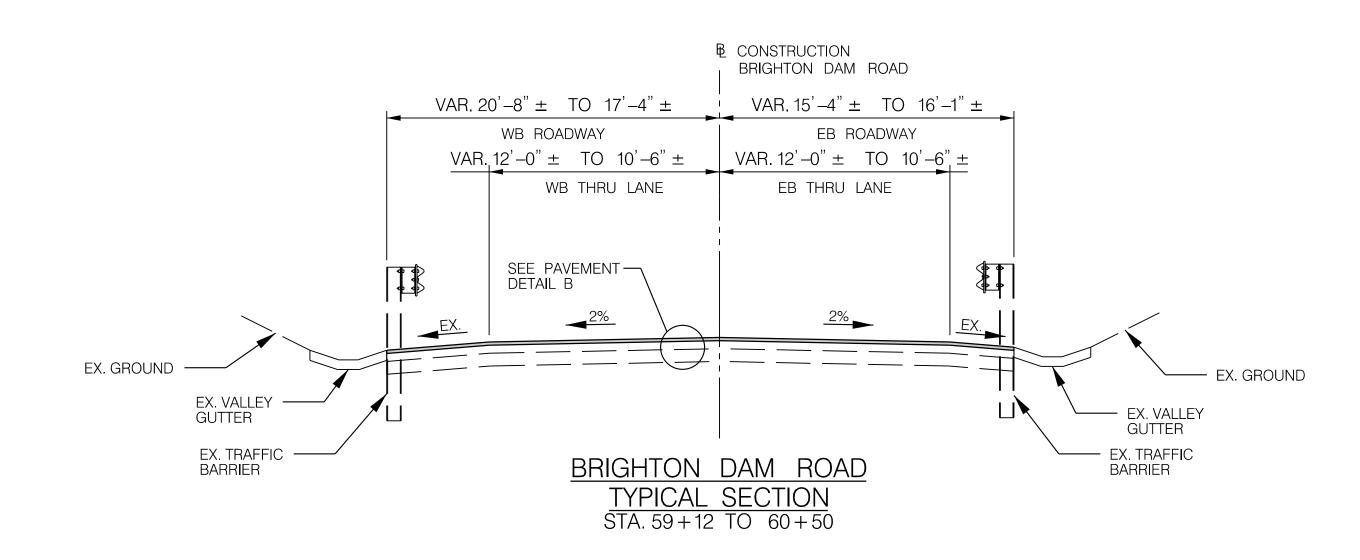

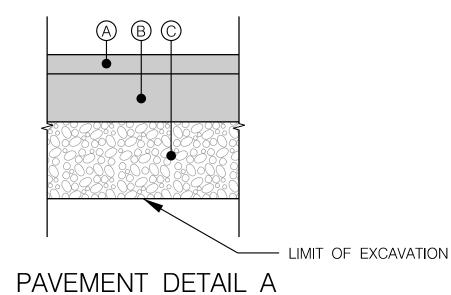

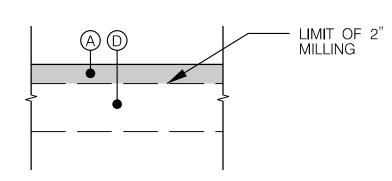

PAVEMENT DETAIL B N.T.S.

PAVEMENT DETAILS

- (A) 2" SUPERPAVE ASPHALT MIX 9.5MM FOR SURFACE, PG 64S-22, LEVEL 2
- B 5" SUPERPAVE ASPHALT MIX 25.0MM FOR BASE 64S-22, LEVEL 2 NOTE: PLACE 1-2" AND 1-3" LIFTS
- © 8" GRADED AGGREGATE BASE COURSE NOTE: PLACE 2-4" LIFTS
- D EX. PAVEMENT
- (E) 2" SUPERPAVE ASPHALT MIX 12.5MM FOR SURFACE, PG 70-22 LEVEL 3
- (F) 2" SUPERPAVE ASPHALT MIX 12.5MM FOR SURFACE, PG 64-22 LEVEL 3
- © 7" SUPERPAVE ASPHALT MIX 19.0MM FOR BASE 64-22, LEVEL 3 NOTE: PLACE 2-2" AND 1-3" LIFTS
- H 13" GRADED AGGREGATE BASE COURSE NOTE: PLACE 2-4" AND 1-3" LIFTS

TS-01

MONTGOMERY COUNTY DEPARTMENT OF TRANSPORTATION GAITHERSBURG, MARYLAND RECOMMENDED FOR APPROVAL Chief, Design Section Date APPROVED Chief, Division of Transportation Engineering Date Designed by: DHM III Drawn by: DHM III Checked by: DL REVISION DATE

REHABILITATION OF BRIDGE NO. M-0229ON BRIGHTON DAM ROAD OVER BRIGHTON DAM

- LIMIT OF EXCAVATION

TYPICAL SECTIONS & PAVING DETAILS

0501907 SHEET 02 of 38 Project No. :

PROFESSIONAL CERTIFICATION


I HEREBY CERTIFY THAT THESE DOCUMENTS WERE PREPARED OR APPROVED BY ME, AND THAT I AM A DULY LICENSED PROFESSIONAL ENGINEER UNDER THE LAWS OF THE STATE OF MARYLAND. LICENSE NO. <u>46328</u> EXPIRATION DATE <u>12-31-2022</u>


DIVISION OF TRANSPORTATION ENGINEERING CONSTRUCTION SECTION
240-777-7210
DESIGN SECTION 240-777-7221


MODELNAME: \$MODELNAME\$


PAVEMENT DETAIL C


SEE SHEET PS-03 FOR LOCATION

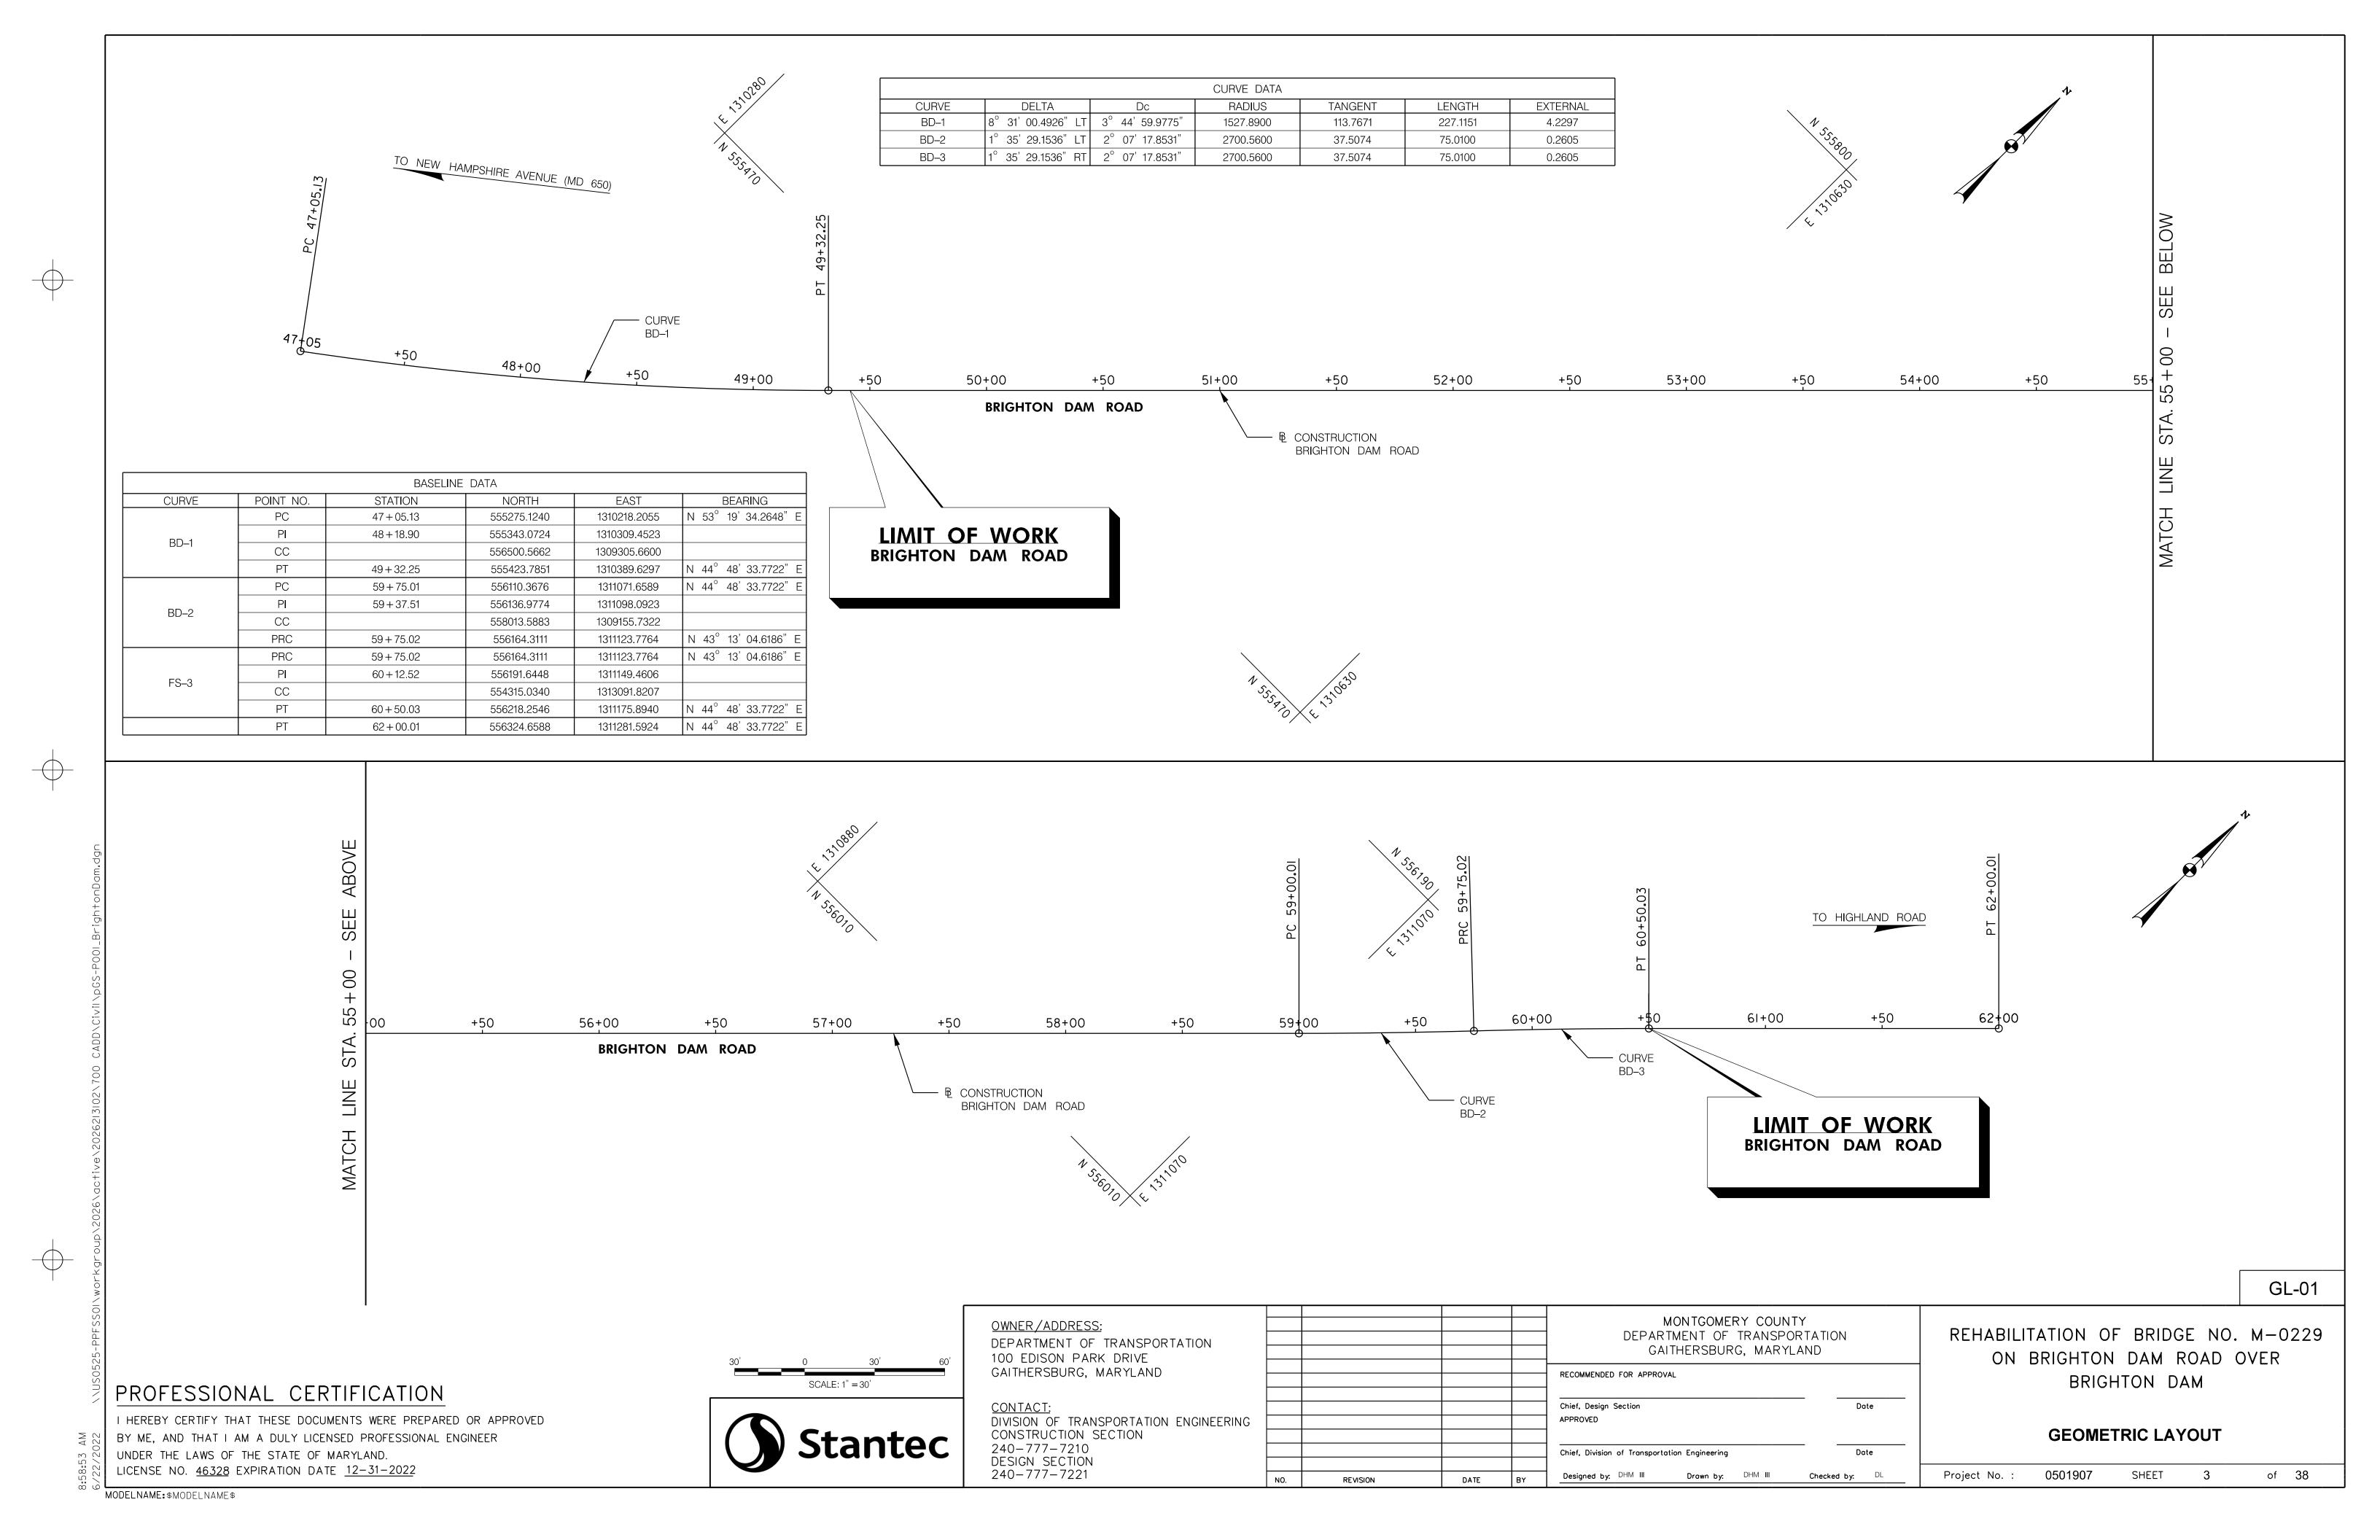

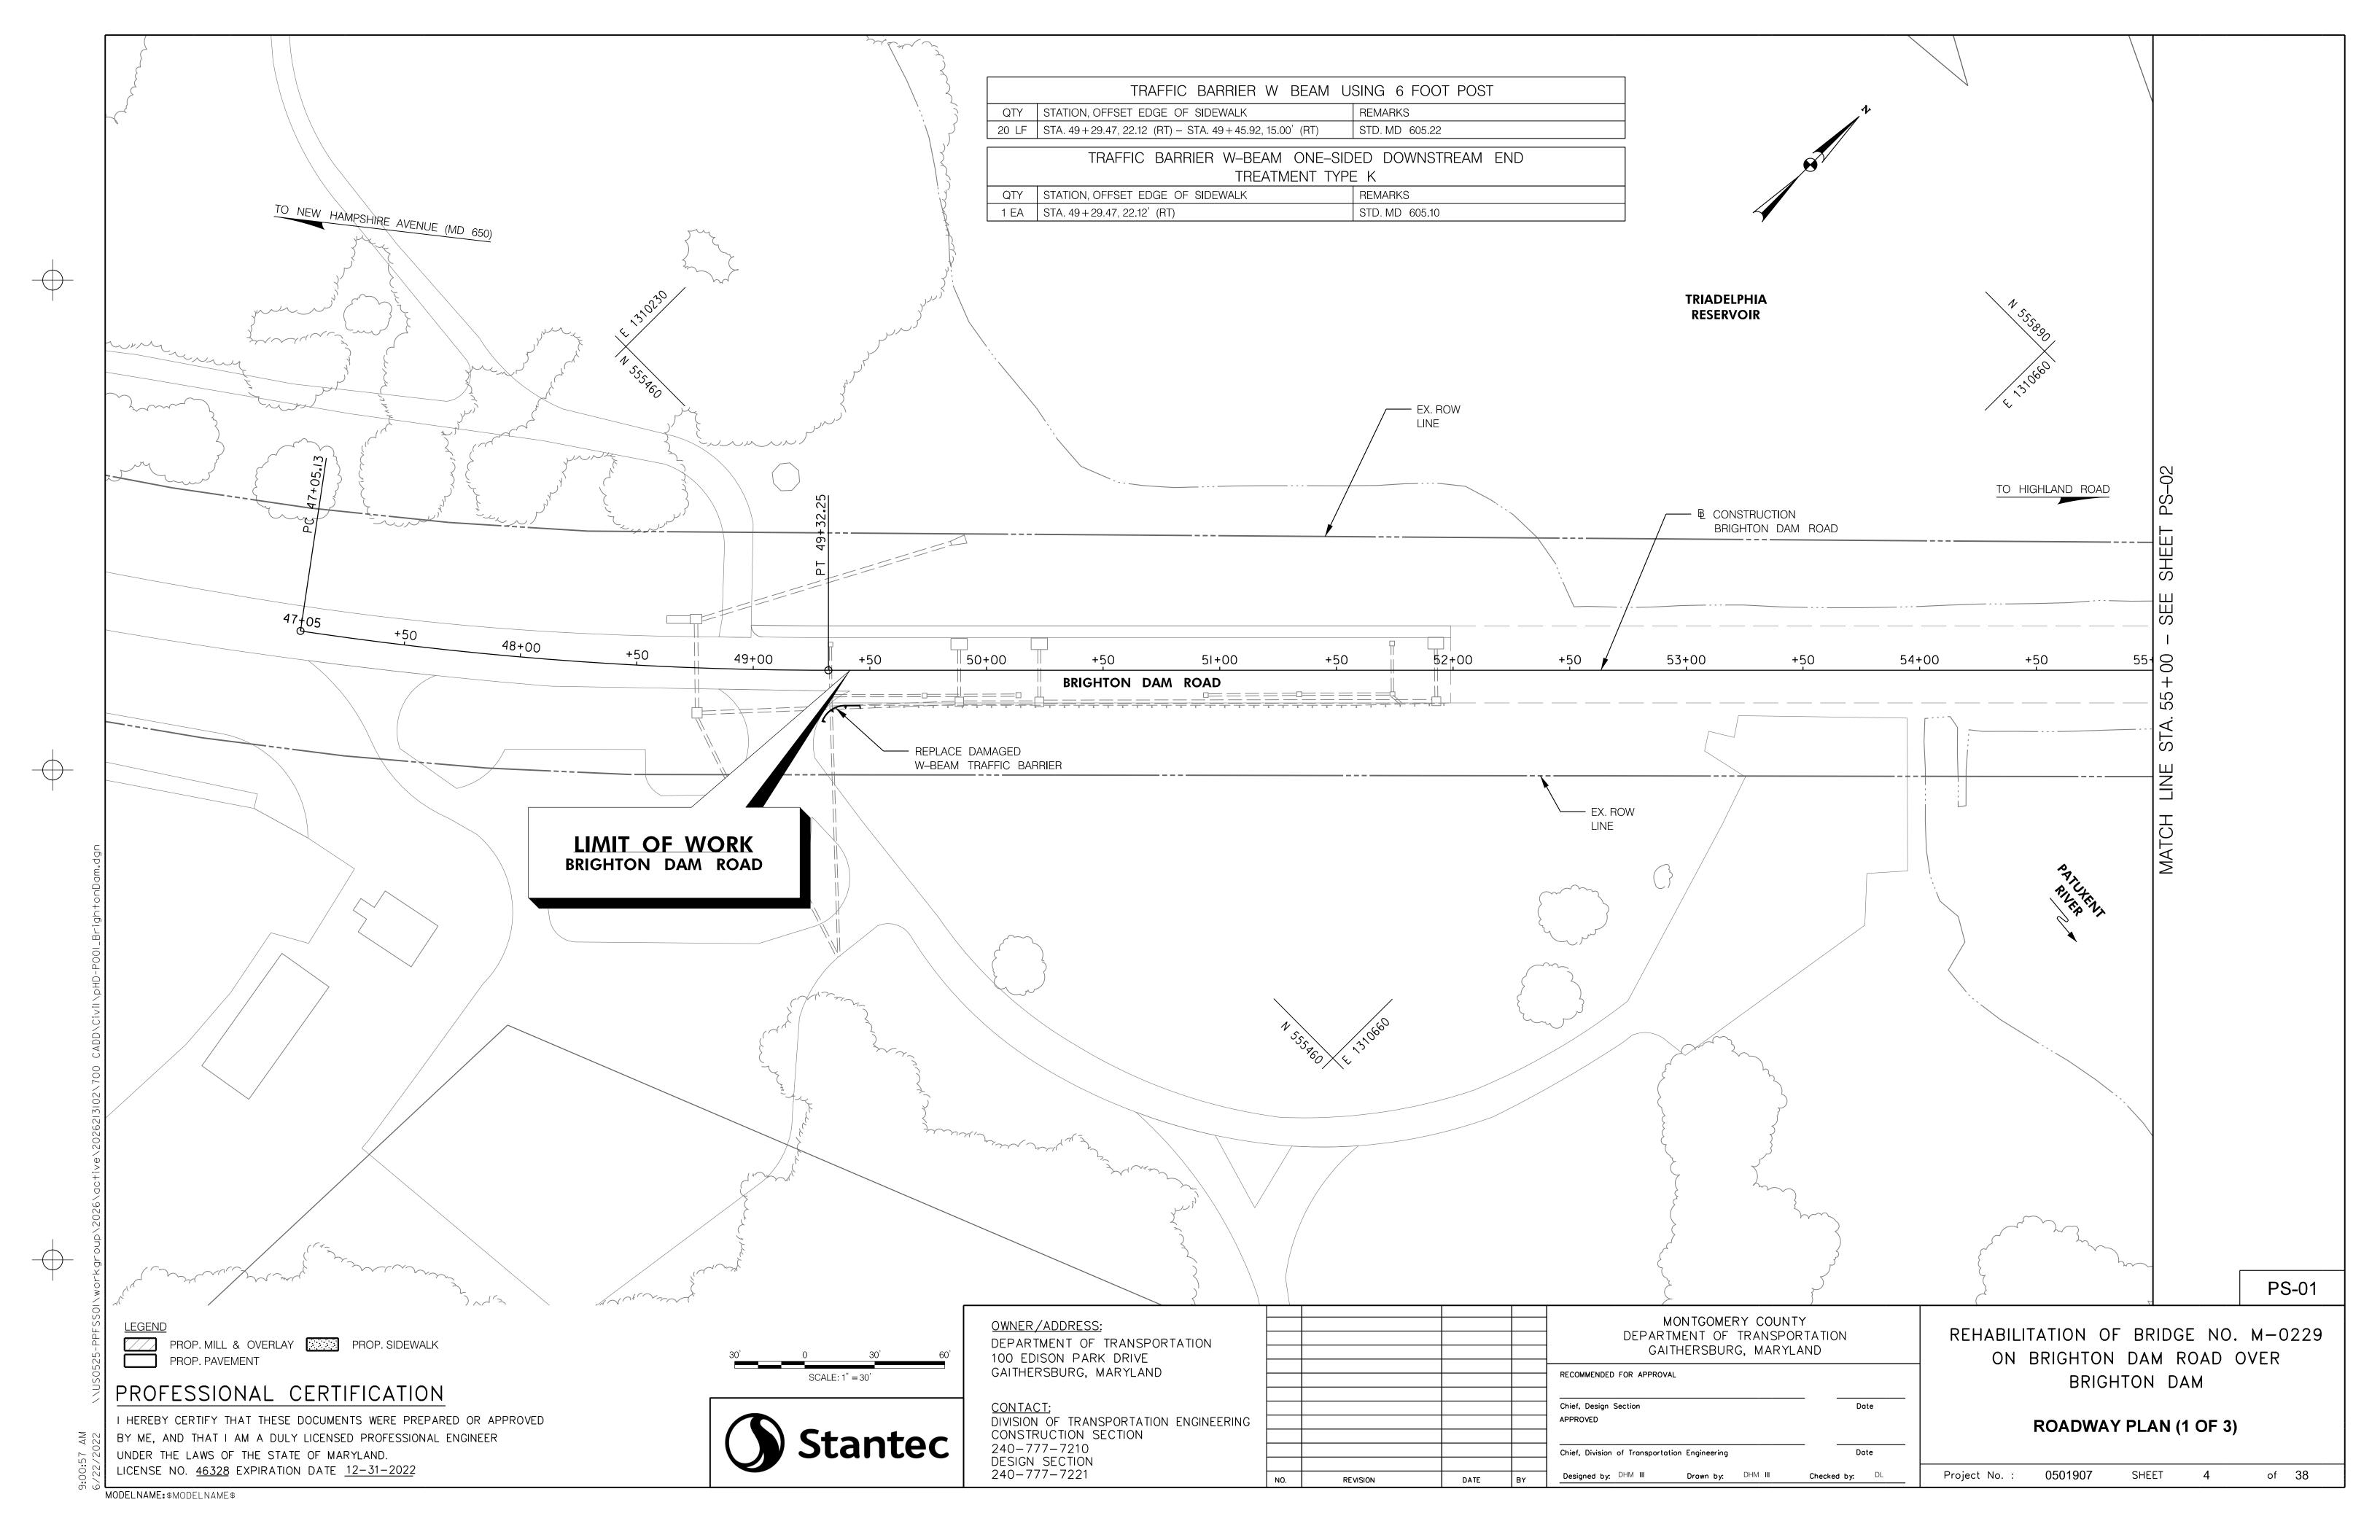

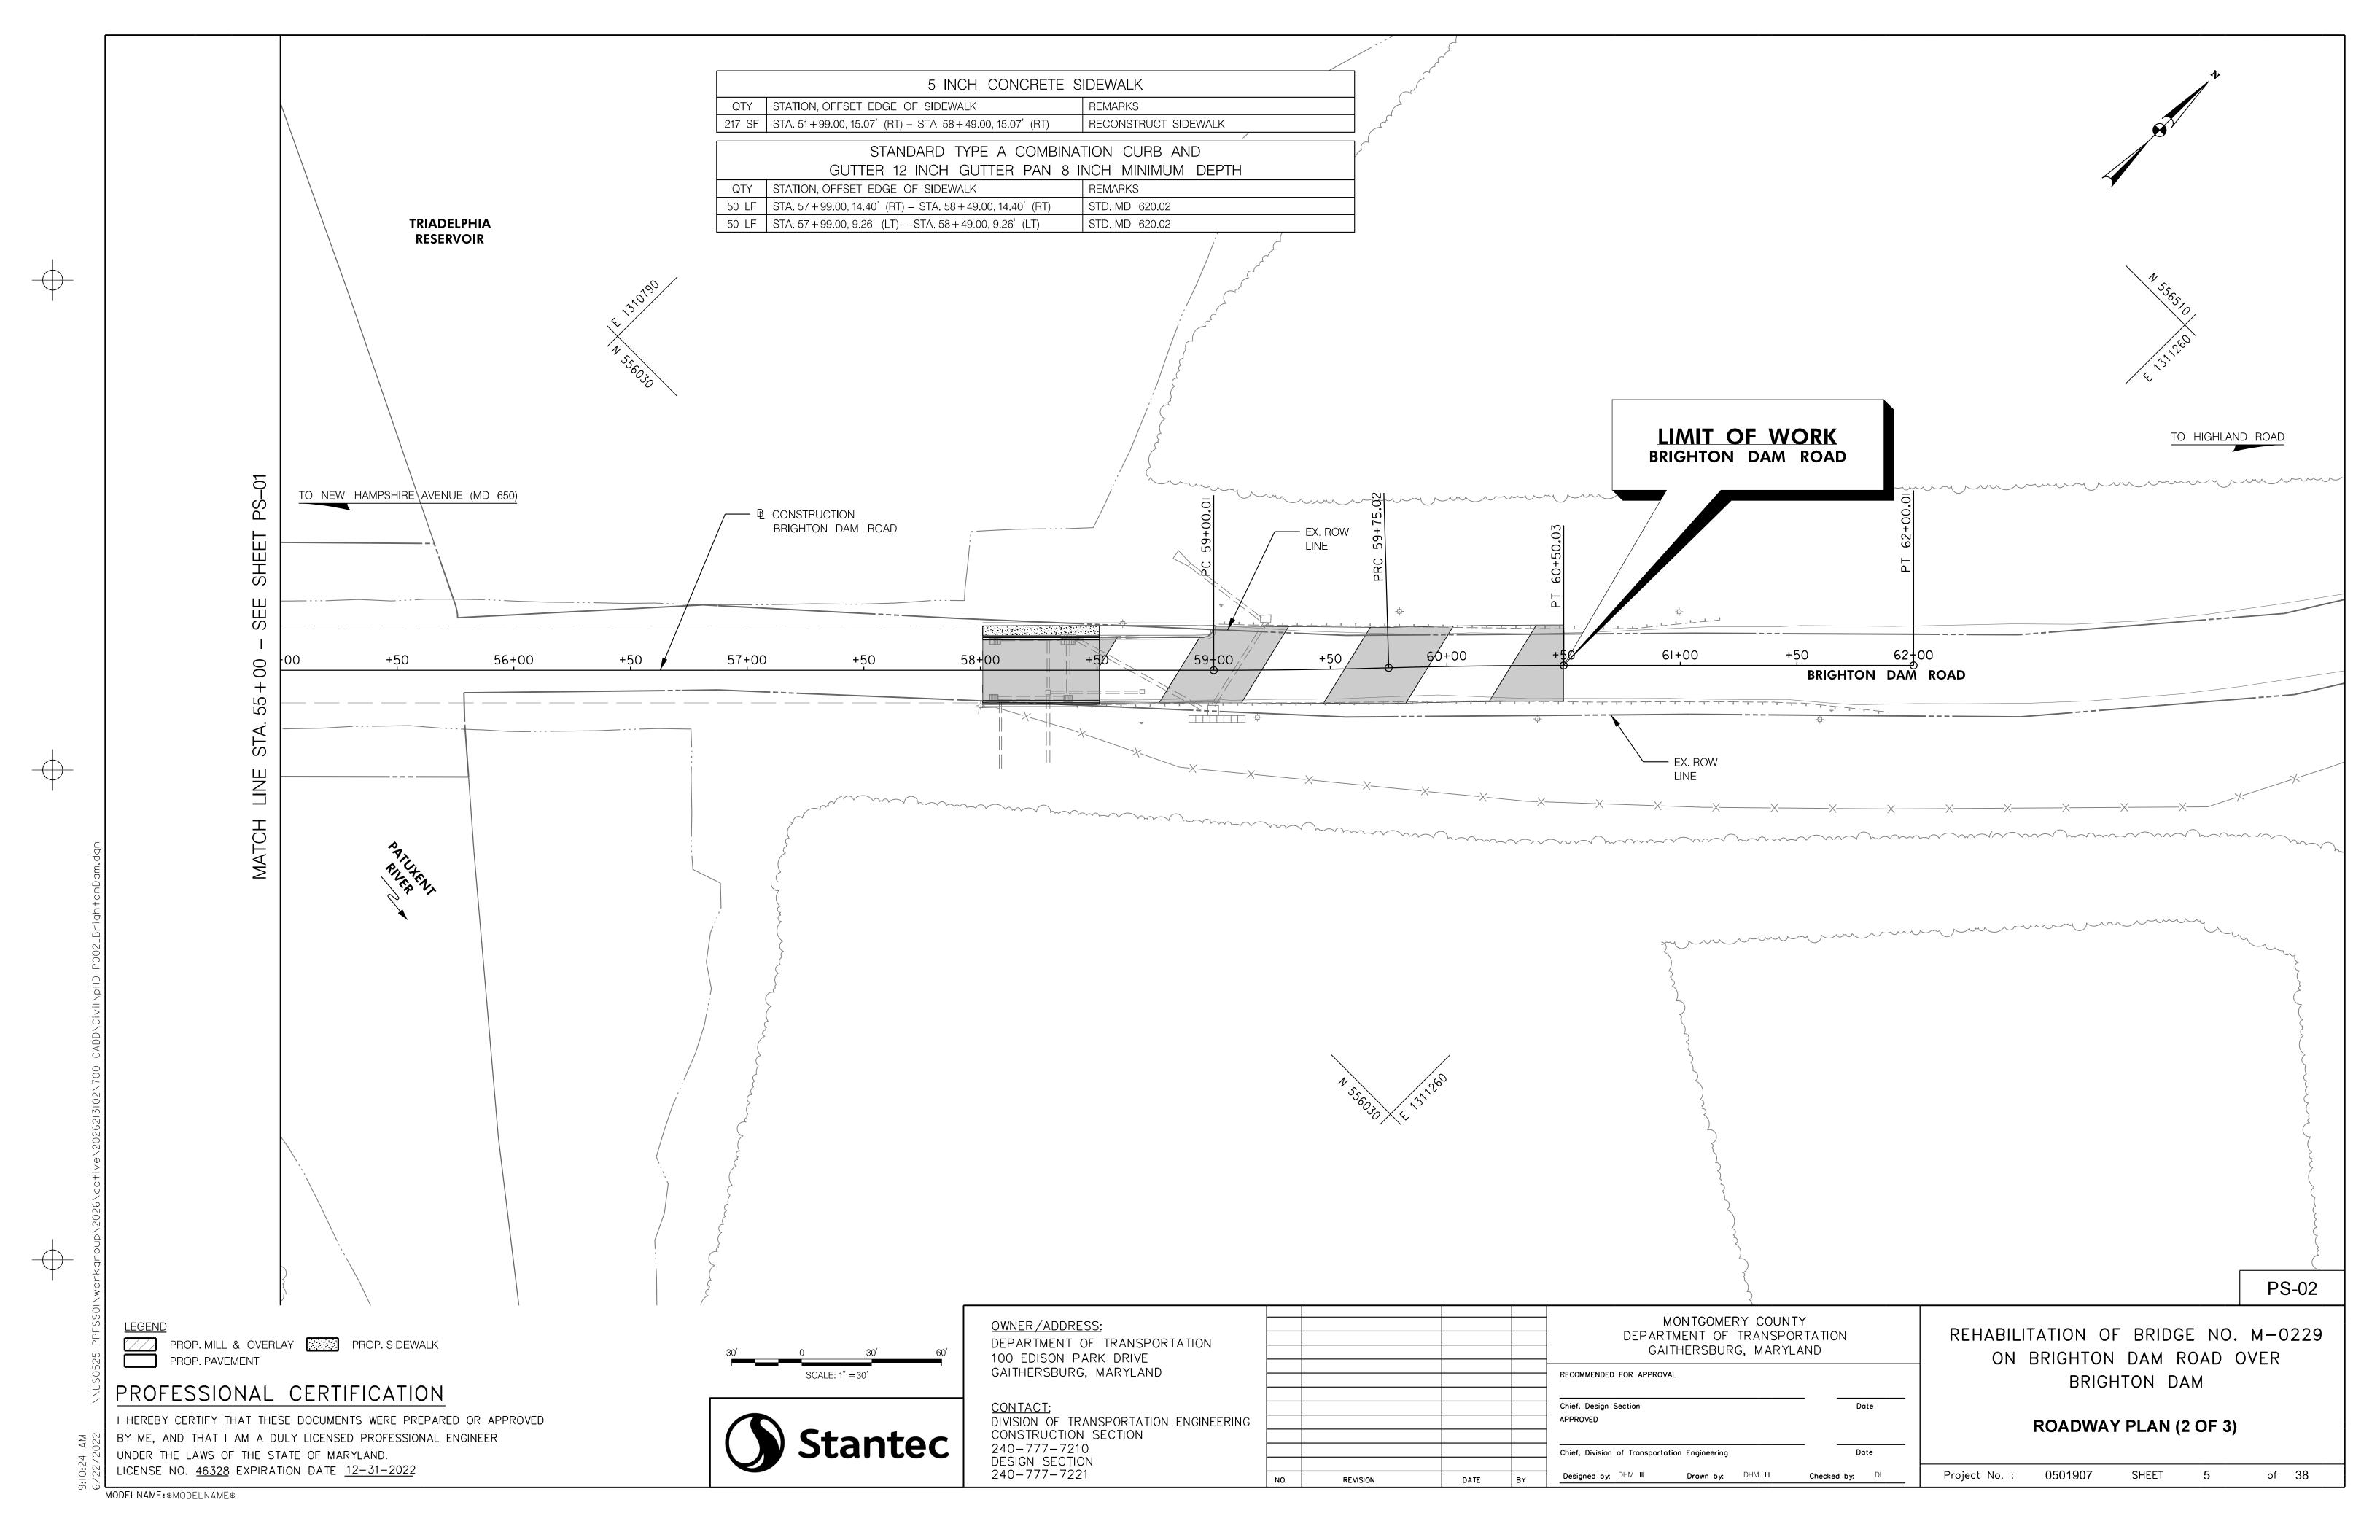

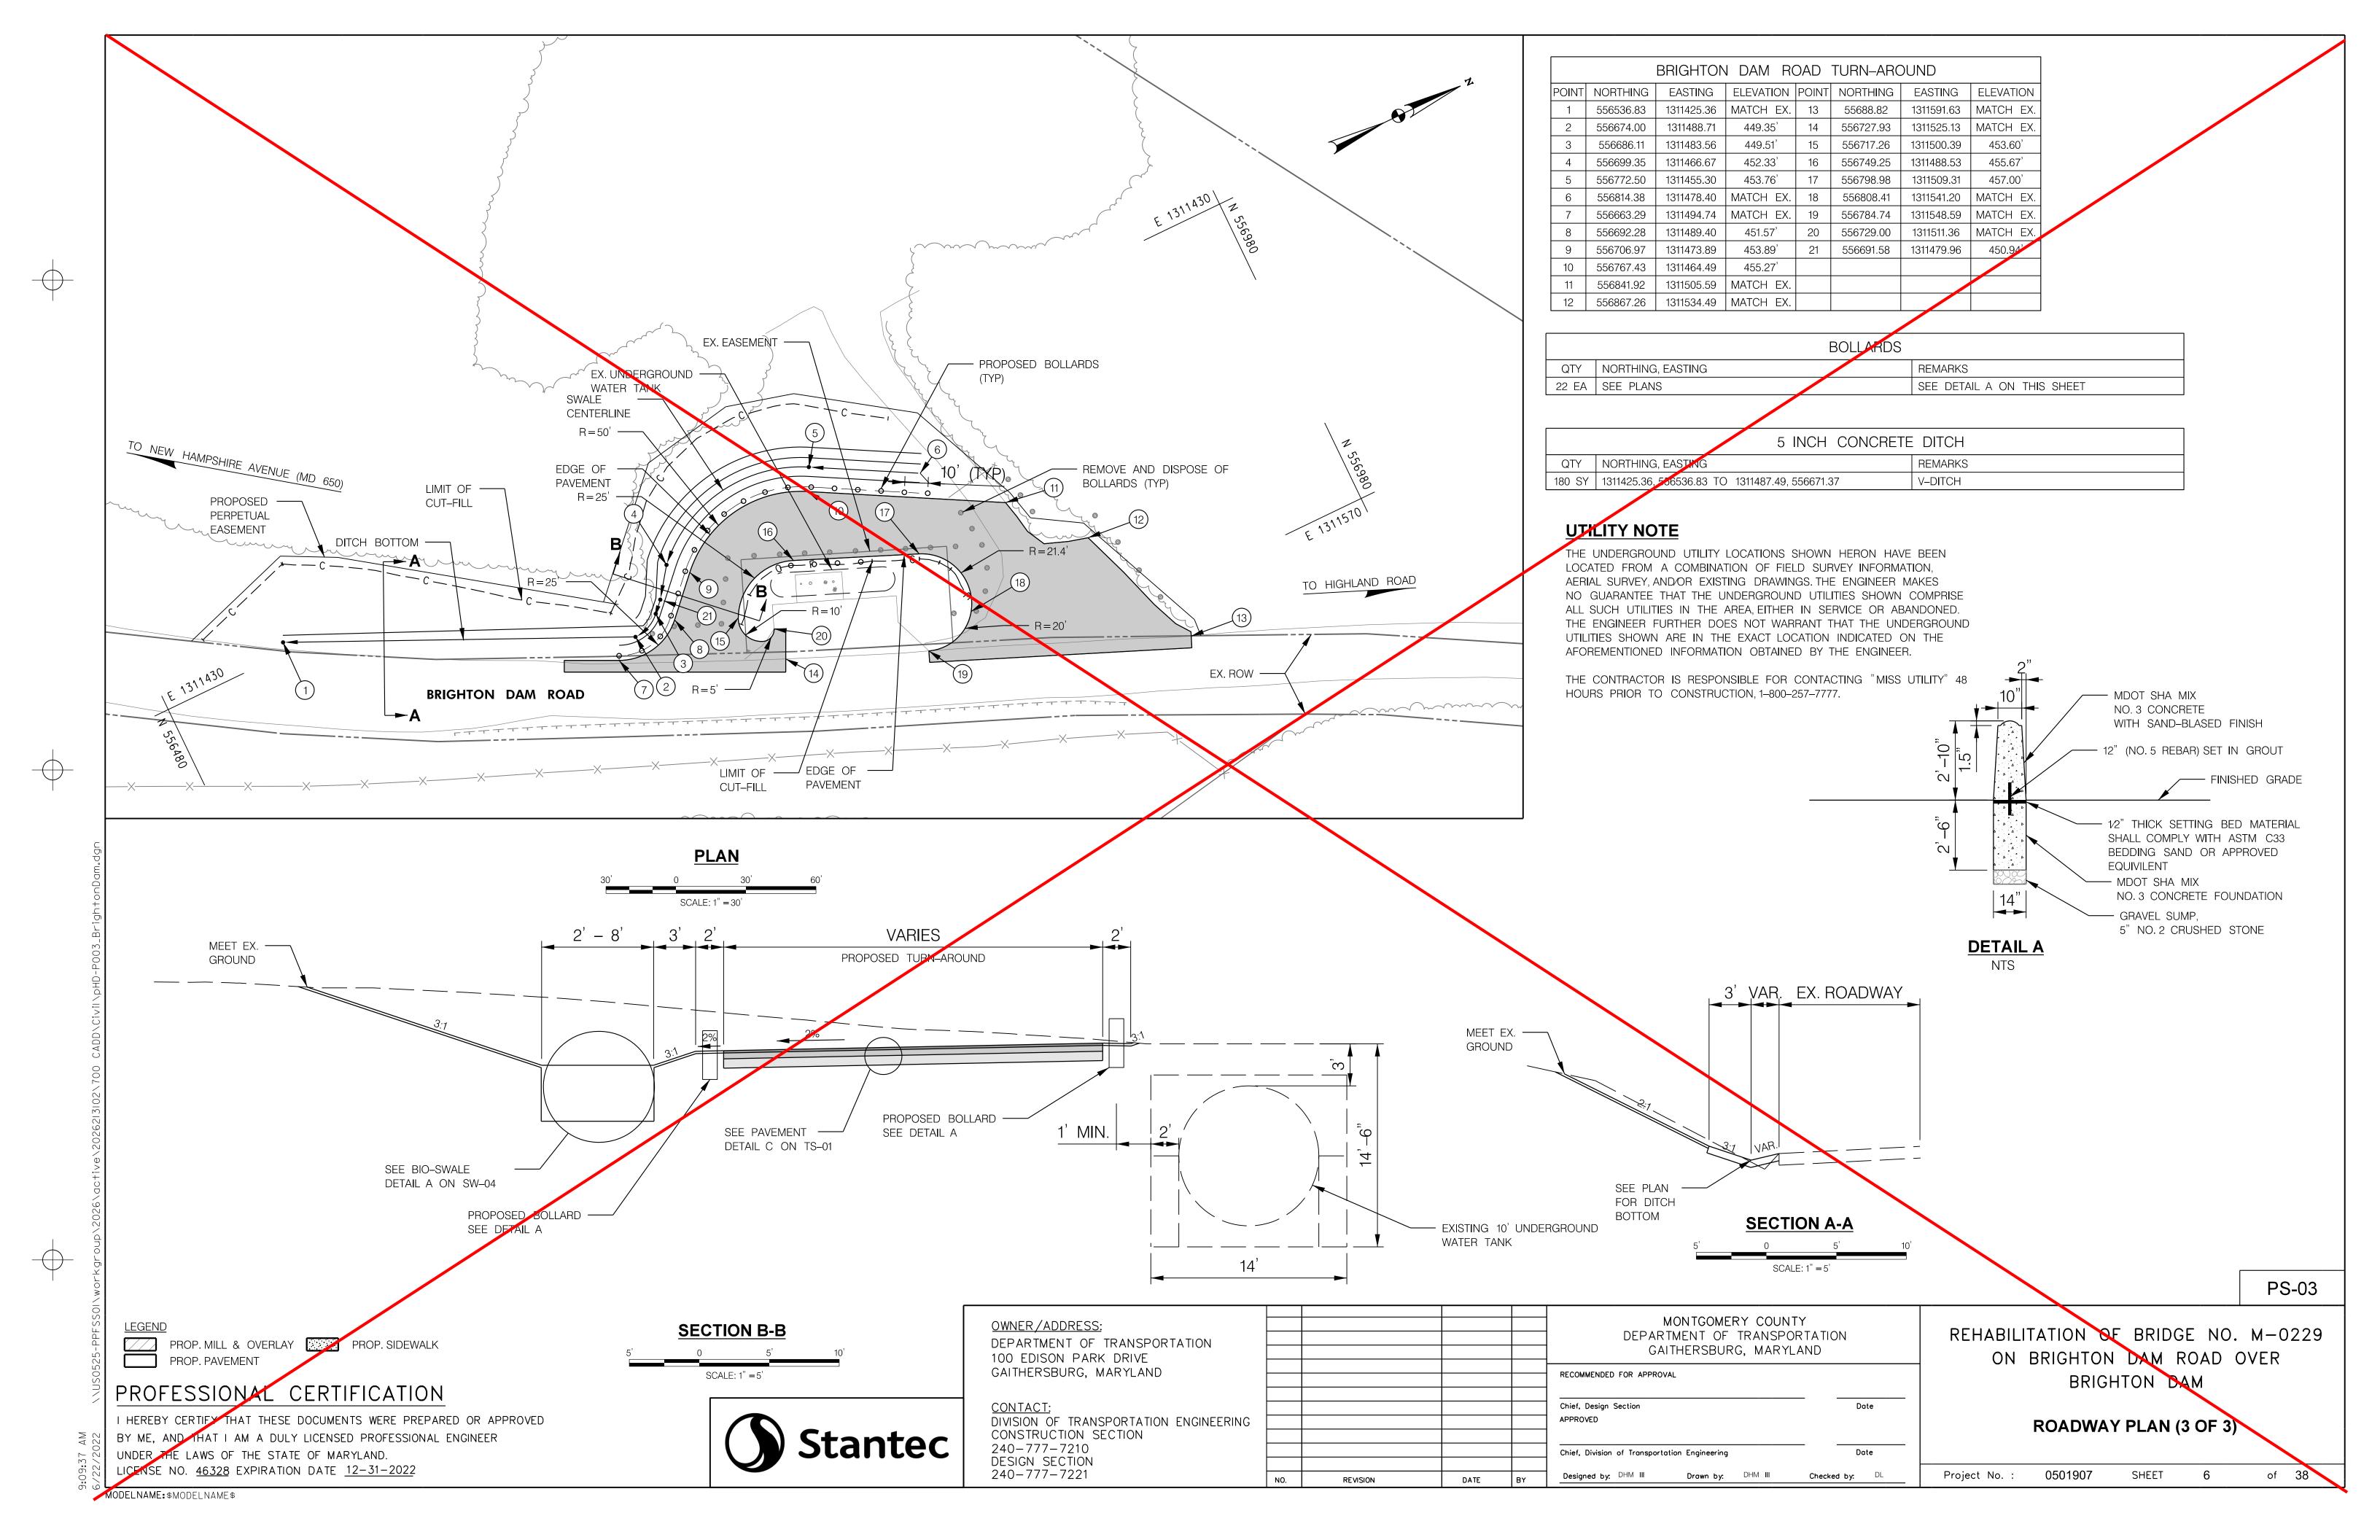

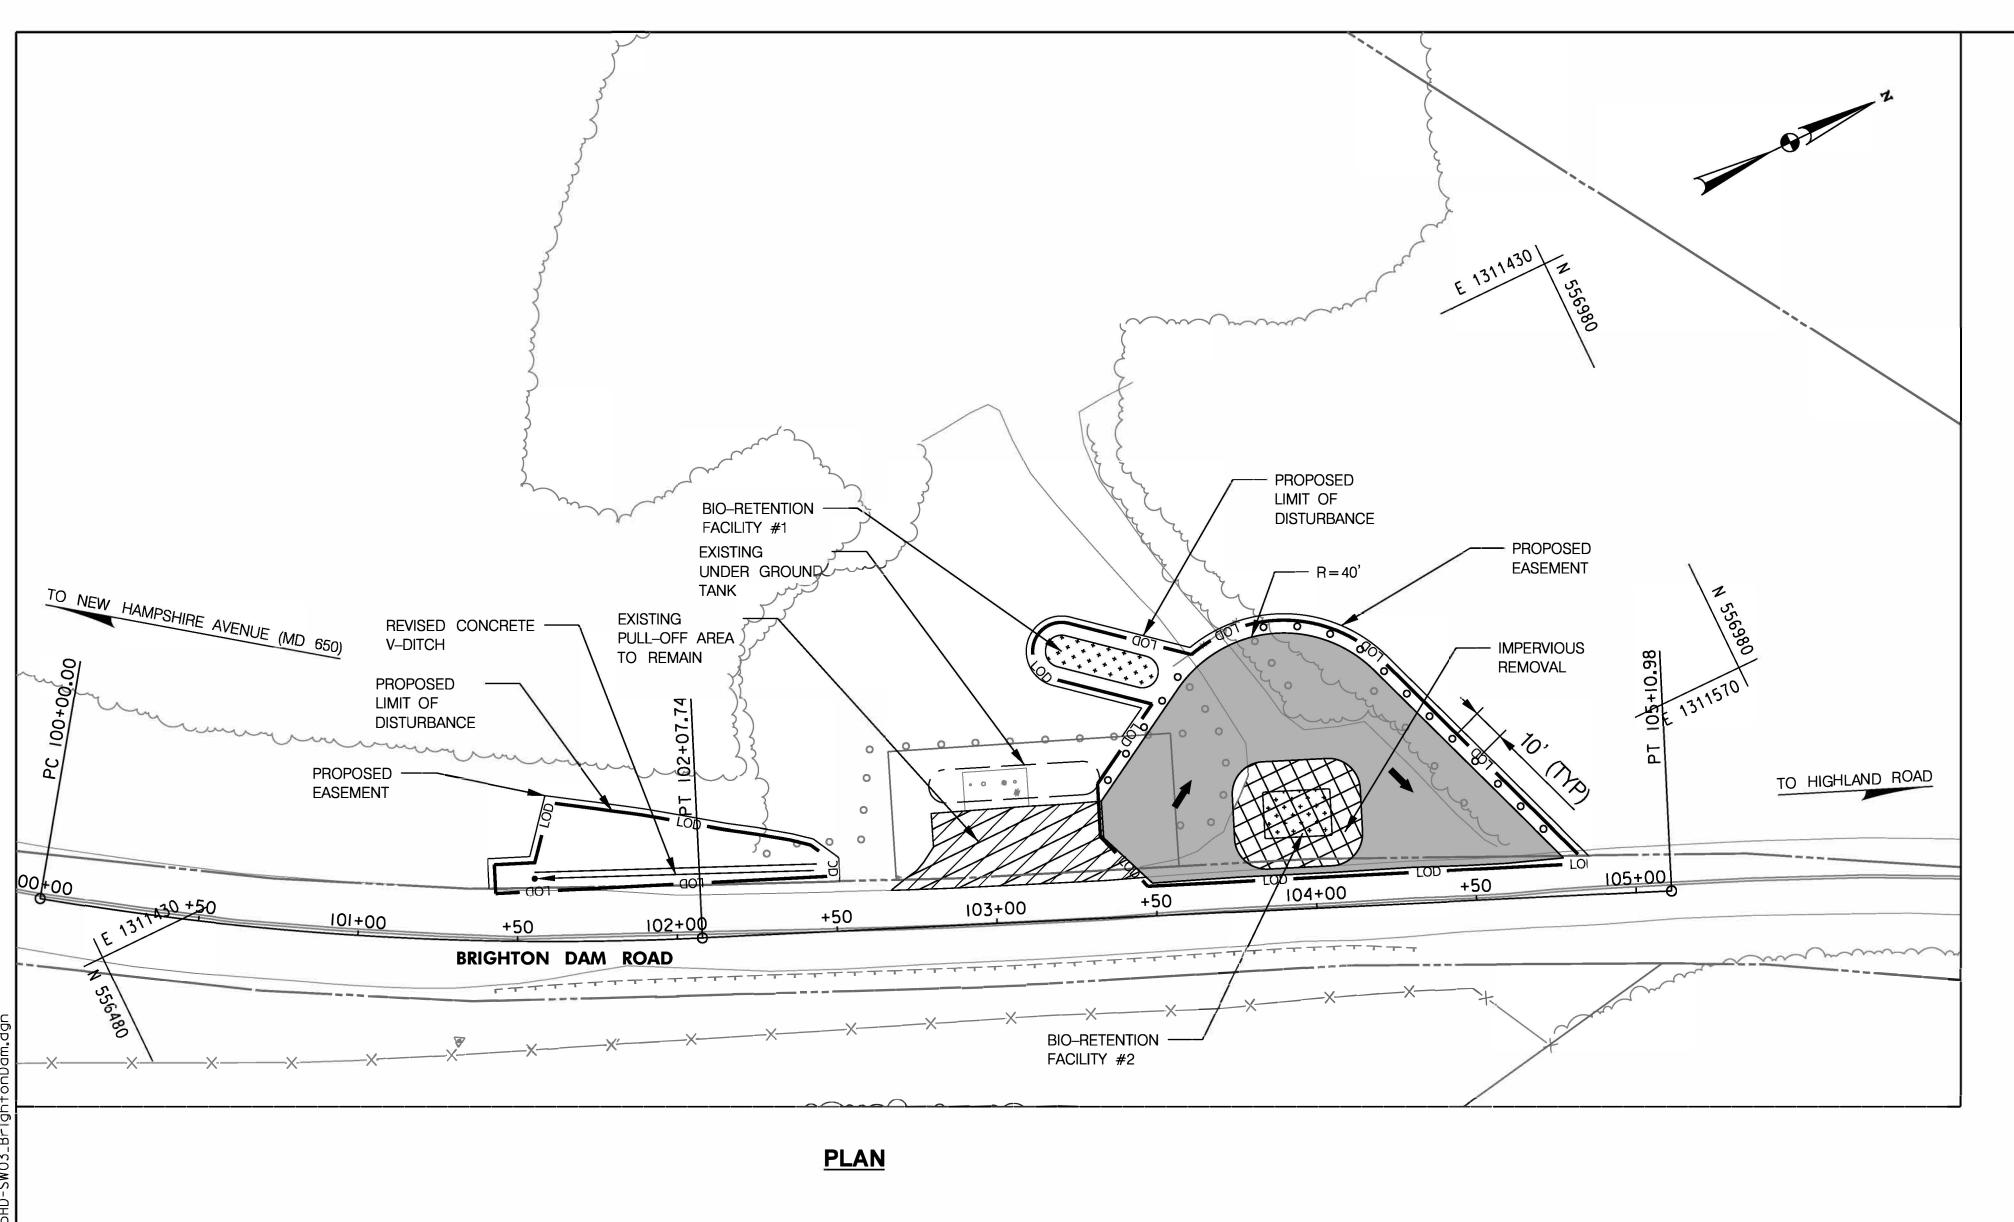


NEW IMPERVIOUS = 3563 SF 1221 SF IMPERVIOUS REMOVAL = TOTAL LOD = 10018 SF

UTILITY NOTE

THE UNDERGROUND UTILITY LOCATIONS SHOWN HERE ON HAVE BEEN LOCATED FROM A COMBINATION OF FIELD SURVEY INFORMATION, AERIAL SURVEY, AND/OR EXISTING DRAWINGS. THE ENGINEER MAKES NO GUARANTEE THAT THE UNDERGROUND UTILITIES SHOWN COMPRISE ALL SUCH UTILITIES IN THE AREA, EITHER IN SERVICE OR ABANDONED. THE ENGINEER FURTHER DOES NOT WARRANT THAT THE UNDERGROUND UTILITIES SHOWN ARE IN THE EXACT LOCATION INDICATED ON THE AFOREMENTIONED INFORMATION OBTAINED BY THE ENGINEER.


THE CONTRACTOR IS RESPONSIBLE FOR CONTACTING "MISS UTILITY" 48 HOURS PRIOR TO CONSTRUCTION, 1-800-257-7777. MDOT SHA MIX NO. 3 CONCRETE WITH SAND-BLASTED FINISH - 12" (NO. 5 REBAR) SET IN GROUT FINISHED GRADE - 1/2" THICK SETTING BED MATERIAL SHALL COMPLY WITH ASTM C33 BEDDING SAND OR APPROVED **EQUIVILENT** - MDOT SHA MIX NO. 3 CONCRETE FOUNDATION 14" GRAVEL SUMP, 5" NO. 2 CRUSHED STONE **DETAIL A**

<u>LEGEND</u>

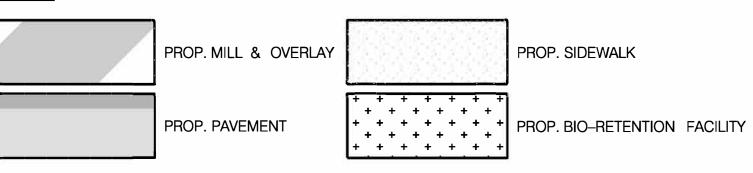

PROFESSIONAL CERTIFICATION

I HEREBY CERTIFY THAT THESE DOCUMENTS WERE PREPARED OR APPROVED BY ME, AND THAT I AM A DULY LICENSED PROFESSIONAL ENGINEER UNDER THE LAWS OF THE STATE OF MARYLAND. LICENSE NO. <u>46328</u> EXPIRATION DATE <u>12-31-2022</u>

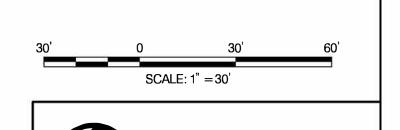

OWNER/ADDRESS: DEPARTMENT OF TRANSPORTATION 100 EDISON PARK DRIVE GAITHERSBURG, MARYLAND

	TRANSPORTATION	ENGINEERING
240-777-7 DESIGN SEC		
240-777-7	· · · · ·	

		-		MONTGOMERY COUNTY DEPARTMENT OF TRANSPORTATION GAITHERSBURG, MARYLAND
			14	RECOMMENDED FOR APPROVAL
		· · · · · · · · · · · · · · · · · · ·		Chief, Design Section Dote
-				
5		a s	10 10	Chief, Division of Tronsportotion Engineering Date
n	RF MSON	DATE	RY	Designed by: DHM III Drawn by: DHM III Checked by:. DL .

REHABILITATION OF BRIDGE NO. M-0229ON BRIGHTON DAM ROAD OVER

TURNAROUND SITE PLAN

BRIGHTON DAM

Project No.: 0501907 SHEET 6A

MODELNAME: \$MODELNAME\$

PS-03

AND DETAILS - CONCEPT

STANDARD SEDIMENT CONTROL NOTES

- 1. A pre-construction meeting must occur with the Howard County Department of Public Works, Construction Inspection Division (CID), 410-313-1855 after the future LOD and protected areas are marked clearly in the field. A minimum of 48 hour notice to CID must be given at the following stages:
 - a. Prior to the start of earth disturbance,
 - Upon completion of the installation of perimeter erosion and sediment controls, but before
 - proceeding with any other earth disturbance or grading,
 - c. Prior to the start of another phase of construction or opening of another grading unit,
 - d. Prior to the removal or modification of sediment control practices.

Other building or grading inspection approvals may not be authorized until this initial approval by the inspection agency is made. Other related state and federal permits shall be referenced, to ensure coordination and to avoid conflicts with this plan.

- All vegetative and structural practices are to be installed according to the provisions of this plan and are to be in conformance with the 2011 MARYLAND STANDARDS AND SPECIFICATIONS FOR SOIL EROSION AND SEDIMENT CONTROL, and revisions thereto.
- Following initial soil disturbance or re-disturbance, permanent or temporary stabilization is required within three (3) calendar days as to the surface of all perimeter controls, dikes, swales, ditches, perimeter slopes, and all slopes steeper than 3 horizontal to 1 vertical (3:1); and seven (7) calendar days as to all other disturbed areas on the project site except for those areas under active grading.
- All disturbed areas must be stabilized within the time period specified above in accordance with the 2011 MARYLAND STANDARDS AND SPECIFICATIONS FOR SOIL EROSION AND SEDIMENT CONTROL for topsoil (Sec. B-4-2), permanent seeding (Sec. B-4-5), temporary seeding (Sec. B-4-4) and mulching (Sec. B-4-3). Temporary stabilization with mulch alone can only be applied between the fall and spring seeding dates if the ground is frozen. Incremental stabilization (Sec. B-4-1) specifications shall be enforced in areas with >15* of cut and/or fill. Stockpiles (Sec. B-4-8) in excess of 20 ft. must be benched with stable outlet. All concentrated flow, steep slope, and highly erodible areas shall receive soil stabilization matting (Sec. B-4-6).
- All sediment control structures are to remain in place, and are to be maintained in operative condition until permission for their removal has been obtained from the CID.
- 6. Site Analyaisis:

Total Area of Site: Acres Acres Area Disturbed: .53 Area to be roofed or paved: .21 Acres .32 Acres Area to be vegetatively stabilized: Total Cut: 1861 Cu. Yds. Total Fill: 0 Cu. Yds.

Offsite waste/borrow area location:

- 7. Any sediment control practice which is disturbed by grading activity for placement of utilities must be repaired on the same day of disturbance.
- Additional sediment control must be provided, if deemed necessary by the CID. The site and all controls shall be inspected by the contractor weekly; and the next day after each rain event. A written report by the contractor, made available upon request, is part of every inspection and should include:
 - * Inspection date
 - Inspection type (routine, pre-storm event, during rain event)
 - Name and title of inspector
 - Weather information (current conditions as well as time and amount of last recorded precipitation)
 - Brief description of project*s status (e.g., percent complete) and/or current activities
 - Evidence of sediment discharges
 - Identification of plan deficiencies
 - Identification of sediment controls that require maintenance
 - Identification of missing or improperly installed sediment controls
 - Compliance status regarding the sequence of construction and stabilization requirements
 - Photographs
 - Monitoring/sampling
 - Maintenance and/or corrective action performed
- Other inspection items as required by the General Permit for Stormwater Associated with Construction Activities (NPDES, MDE).
- Trenches for the construction of utilities is limited to three pipe lengths or that which can and shall be back-filled and stabilized by the end of each workday, whichever is shorter.
- 10. Any major changes or revisions to the plan or sequence of construction must be reviewed and approved by the HSCD prior to proceeding with construction. Minor revisions may allowed by the CID per the list of HSCD-approved field changes.
- Disturbance shall not occur outside the L.O.D. A project is to be sequenced so that grading activities begin on one grading unit (maximum acreage of 20 ac. per grading unit) at a time. Work may proceed to a subsequent grading unit when at least 50 percent of the disturbed area in the preceding grading unit has been stabilized and approved by the CID. Unless otherwise specified and approved by the HSCD, no more than 30 acres cumulatively may be disturbed at a given time.
- Wash water from any equipment, vehicles, wheels, pavement, and other sources must be treated in a sediment basin or other approved washout structure.
- Topsoil shall be stockpiled and preserved on-site for redistribution onto final grade.
- 14. All Silt Fence and Super Silt Fence shall be placed on-the-contour, or be imbricated at 25* maximum intervals, with lower ends curled uphill by 2* in elevation.
- 15. Stream channels must not be disturbed during the following restricted time periods (inclusive):
 - Use I and IP March 1 June 15
 - * Use III and IIIP October 1 April 30
 - * Use IV March 1 May 31
- 16. A copy of this plan, the 2011 MARYLAND STANDARDS AND SPECIFICATIONS FOR SOIL EROSION AND SEDIMENT CONTROL, and associated permits shall be on-site and available when the site is active.

PROFESSIONAL CERTIFICATION

I HEREBY CERTIFY THAT THESE DOCUMENTS WERE PREPARED OR APPROVED BY ME, AND THAT I AM A DULY LICENSED PROFESSIONAL ENGINEER UNDER THE LAWS OF THE STATE OF MARYLAND. LICENSE NO. <u>46328</u> EXPIRATION DATE <u>12-31-2022</u>



____AGIP ТВ AT-GRADE INLET PROTECTION PERMANENT SOIL STABILIZATION MATTING-TYPE B TEMPORARY ACCESS BRIDGE ● ● **●** RB **BAFFLE BOARDS** PERMANENT SOIL STABILIZATION MATTING-TYPE C **TEMPORARY ACCESS CULVERT** BENCHING PIPE OUTLET SEDIMENT TRAP ST I ST-I **BENCHING** TEMPORARY ASPHALT BERM _____ T<u>AB</u>___ NOTE: DESIGNATION PSD-12 [__]сві PIPE SLOPE DRAIN TBD **CATCH BASIN INSERT** PSD - 12 **TEMPORARY BARRIER DIVERSION** REFERS TO PIPE SLOPE DRAIN WITH 12 IN PIPE **NOTE: DESIGNATION CWD-12** TGOS CLEAR WATER DIVERSION PIPE REFERS TO CLEAR WATER CWD - 12 **PLUNGE POOL** TEMPORARY GABION OUTLET STRUCTURE **DIVERSION WITH 12 INCH PIPE.** PORTABLE SEDIMENT TANK ⊠PST TEMPORARY SOIL STABILIZATION MATTING-TYPE A CLEAR WATER PIPE COIP **COMBINATION INLET PROTECTION REMOVABLE PUMPING STATION** ⊠RPS TEMPORARY SOIL STABILIZATION MATTING-TYPE E DODODO CWS RRP CONCRETE WASHOUT STRUCTURE RIPRAP INFLOW PROTECTION TEMPORARY SOIL STABILIZATION MATTING-TYPE D ST-III **CURB INLET PROTECTION** RIPRAP OUTLET SEDIMENT TRAP ST III TEMPORARY STONE OUTLET STRUCTURE TSOS **NOTE: PLACE DESIGNATION** ROPI **DIVERSION FENCE ROCK OUTLET PROTECTION I** TEMPORARY SWALE ├── DF ─── (A-1, B-2, ETC.) ON FLOW = CHANNEL SIDE OF SWALE. **NOTE: PLACE DESIGNATION** ROPII **▲**-I VDDD **EARTH DIKE VERTICAL DRAW-DOWN DEVICE ROCK OUTLET PROTECTION II** (A-1, B-2, ETC.) ON FLOW **CHANNEL SIDE OF DIKE.** ROPIII WR ES **EMERGENCY SPILLWAY WASH RACK OPTION ROCK OUTLET PROTECTION III FILTER BAG** ——SF—— ⊠FB SILT FENCE CHESAPEAKE BAY CRITICAL AREA —— CBCA —— I---FB-A ---I **SILT FENCE ON PAVEMENT** FILTER BERM ——SF0P—— DRAINAGE BOUNDARY I---FB-B ---I **NOTE: DESIGNATION FL-18** -----FL-18------FILTER LOG SOD EXISTING CONTOURS REFERS TO FILTER LOG * * * * * * WITH 18 INCH DIAMETER. GP GABION INFLOW PROTECTION STABILIZED CONSTRUCTION ENTRANCE (SCE) LIMIT OF DISTURBANCE (LOD) —— LOD — [__]GIP SIP **GABION INLET PROTECTION** STANDARD INLET PROTECTION **PROPOSED CONTOURS** HDDD HORIZONTAL DRAW-DOWN DEVICE STOCKPILE AREA **TEMPORARY ORANGE CONSTRUCTION FENCE (TOCF)** LIMIT OF DISTURBANCE STONE CHECK DAM TREE PROTECTION FENCE —— TPF —— ——LOD—— ST-II MEDIAN INLET PROTECTION STONE/RIPRAP OUTLET SEDIMENT TRAP ST II WETLAND \bullet \bullet \bullet \bullet \bullet MEDIAN SUMP INLET PROTECTION **SUBSURFACE DRAINS** WETLAND BUFFER — в — MB **MOUNTABLE BERM SUMP PIT** ⊠SP 100-YEAR FLOODPLAIN PDS-I € € € ⊢—SSF——I PERIMETER DIKE/SWALE **SUPER SILT FENCE**

STANDARD SYMBOLS

BEFORE BEGINNING CONSTRUCTION MISS UTILITY 1–800–257–7777 AT LEAST 48 HOURS PRIOR TO EXCAVATION

ES-01

0501907

Project No.

OWNER/ADDRESS: DEPARTMENT OF TRANSPORTATION 100 EDISON PARK DRIVE GAITHERSBURG, MARYLAND

CONTACT:	
DIVISION OF TRANSPORTATION	ENGINEERING
CONSTRUCTION SECTION	
240-777-7210	
DESIGN SECTION	
240-777-7221	

	MONTOOMEDY COUNTY	
	MONTGOMERY COUNTY	
	DEPARTMENT OF TRANSPORTATION	
	GAITHERSBURG, MARYLAND	
ŀ		
	RECOMMENDED FOR APPROVAL	
	Chief, Design Section	Date

Chief, Division of Transportation Engineering

Drawn by: DHM III

Date

Checked by: DL

APPROVED

REVISION


REHABILITATION OF BRIDGE NO. M-0229ON BRIGHTON DAM ROAD OVER BRIGHTON DAM

> **EROSION AND SEDIMENT CONTROL NOTES (1 OF 3)**

> > SHEET

MODELNAME: \$MODELNAME\$


of 38

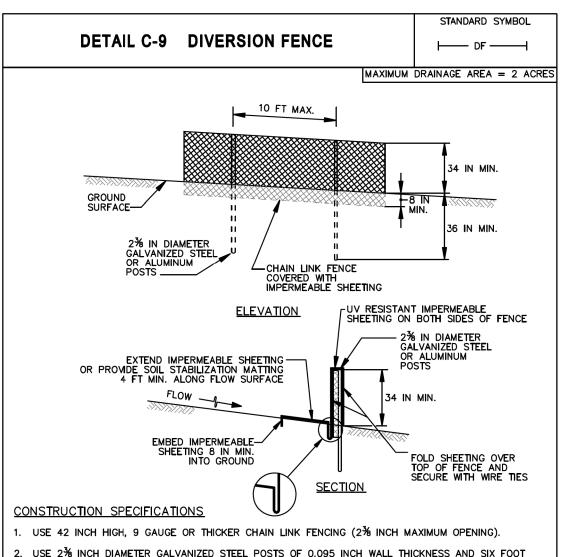

- 2. USE 2% INCH DIAMETER GALVANIZED STEEL POSTS OF 0.095 INCH WALL THICKNESS AND SIX FOOT LENGTH SPACED NO FURTHER THAN 10 FEET APART. THE POSTS DO NOT NEED TO BE SET IN CONCRETE.
- 3. FASTEN CHAIN LINK FENCE SECURELY TO THE FENCE POSTS WITH WIRE TIES.
- 4. SECURE 10 MIL OR THICKER UV RESISTANT, IMPERMEABLE SHEETING TO CHAIN LINK FENCE WITH TIES SPACED EVERY 24 INCHES AT TOP, MID SECTION, AND BELOW GROUND SURFACE.
- 5. EXTEND SHEETING A MINIMUM OF 4 FEET ALONG FLOW SURFACE AND EMBED END A MINIMUM OF 8 INCHES INTO GROUND. SOIL STABILIZATION MATTING MAY BE USED IN LIEU OF IMPERMEABLE SHEETING ALONG FLOW SURFACE.
- 6. WHEN TWO SECTIONS OF SHEETING ADJOIN EACH OTHER, OVERLAP BY 6 INCHES AND FOLD WITH SEAM FACING DOWNGRADE.
- . KEEP FLOW SURFACE ALONG DIVERSION FENCE AND POINT OF DISCHARGE FREE OF EROSION. REMOVE ACCUMULATED SEDIMENT AND DEBRIS. MAINTAIN POSITIVE DRAINAGE. REPLACE IMPERMEABLE SHEETING IF TORN. IF UNDERMINING OCCURS, REINSTALL FENCE.

MARYLAND STANDARDS AND SPECIFICATIONS FOR SOIL EROSION AND SEDIMENT CONTROL

U.S. DEPARTMENT OF AGRICULTURE NATURAL RESOURCES CONSERVATION SERVICE MARYLAND DEPARTMENT OF ENVIRONMENT WATER MANAGEMENT ADMINISTRATION

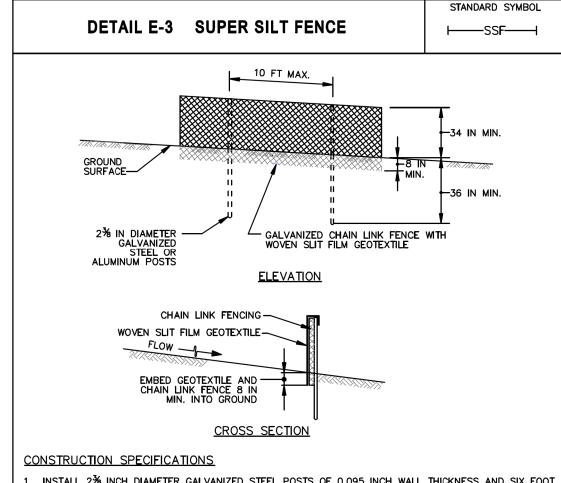

- INSTALL 2% INCH DIAMETER GALVANIZED STEEL POSTS OF 0.095 INCH WALL THICKNESS AND SIX FOOT LENGTH SPACED NO FURTHER THAN 10 FEET APART. DRIVE THE POSTS A MINIMUM OF 36 INCHES
- . FASTEN 9 GAUGE OR HEAVIER GALVANIZED CHAIN LINK FENCE (2% INCH MAXIMUM OPENING) 42 INCHES IN HEIGHT SECURELY TO THE FENCE POSTS WITH WIRE TIES OR HUG RINGS.
- FASTEN WOVEN SLIT FILM GEOTEXTILE AS SPECIFIED IN SECTION H-1 MATERIALS, SECURELY TO THE
- UPSLOPE SIDE OF CHAIN LINK FENCE WITH TIES SPACED EVERY 24 INCHES AT THE TOP AND MID SECTION. EMBED GEOTEXTILE AND CHAIN LINK FENCE A MINIMUM OF 8 INCHES INTO THE GROUND.
- WHERE ENDS OF THE GEOTEXTILE COME TOGETHER, THE ENDS SHALL BE OVERLAPPED BY 6 INCHES, FOLDED, AND STAPLED TO PREVENT SEDIMENT BY PASS.
- EXTEND BOTH ENDS OF THE SUPER SILT FENCE A MINIMUM OF FIVE HORIZONTAL FEET UPSLOPE AT 45 DEGREES TO THE MAIN FENCE ALIGNMENT TO PREVENT RUNOFF FROM GOING AROUND THE ENDS
- . PROVIDE MANUFACTURER CERTIFICATION TO THE INSPECTION/ENFORCEMENT AUTHORITY SHOWING THAT GEOTEXTILE USED MEETS THE REQUIREMENTS IN SECTION H-1 MATERIALS.
- REMOVE ACCUMULATED SEDIMENT AND DEBRIS WHEN BULGES DEVELOP IN FENCE OR WHEN SEDIMENT REACHES 25% OF FENCE HEIGHT. REPLACE GEOTEXTILE IF TORN. IF UNDERMINING OCCURS, REINSTALL CHAIN LINK FENCING AND GEOTEXTILE.

MARYLAND STANDARDS AND SPECIFICATIONS FOR SOIL EROSION AND SEDIMENT CONTROL U.S. DEPARTMENT OF AGRICULTURE
NATURAL RESOURCES CONSERVATION SERVICE

MARYLAND DEPARTMENT OF ENVIRONMENT WATER MANAGEMENT ADMINISTRATION



PROFESSIONAL CERTIFICATION

I HEREBY CERTIFY THAT THESE DOCUMENTS WERE PREPARED OR APPROVED BY ME, AND THAT I AM A DULY LICENSED PROFESSIONAL ENGINEER UNDER THE LAWS OF THE STATE OF MARYLAND. LICENSE NO. <u>46328</u> EXPIRATION DATE <u>12-31-2022</u>



OWNER/ADDRESS: DEPARTMENT OF TRANSPORTATION 100 EDISON PARK DRIVE GAITHERSBURG, MARYLAND

<u>CONTACT:</u> DIVISION OF TRANSPORTATION ENGINEERING CONSTRUCTION SECTION 240-777-7210 DESIGN SECTION 240-777-7221

				MONTGOMERY COUNTY DEPARTMENT OF TRANSPORTATION GAITHERSBURG, MARYLAND	
				RECOMMENDED FOR APPROVAL	
				Chief, Design Section D	Date
				Chief, Division of Transportation Engineering	Oate
NO.	REVISION	DATE	BY	Designed by: DHM III Drawn by: DHM III Checked by:	DL

ES-02


REHABILITATION OF BRIDGE NO. M-0229ON BRIGHTON DAM ROAD OVER BRIGHTON DAM


EROSION AND SEDIMENT


0501907 SHEET 8 Project No. : of 38

MODELNAME: \$MODELNAME\$

CONTROL DETAILS (2 OF 3)

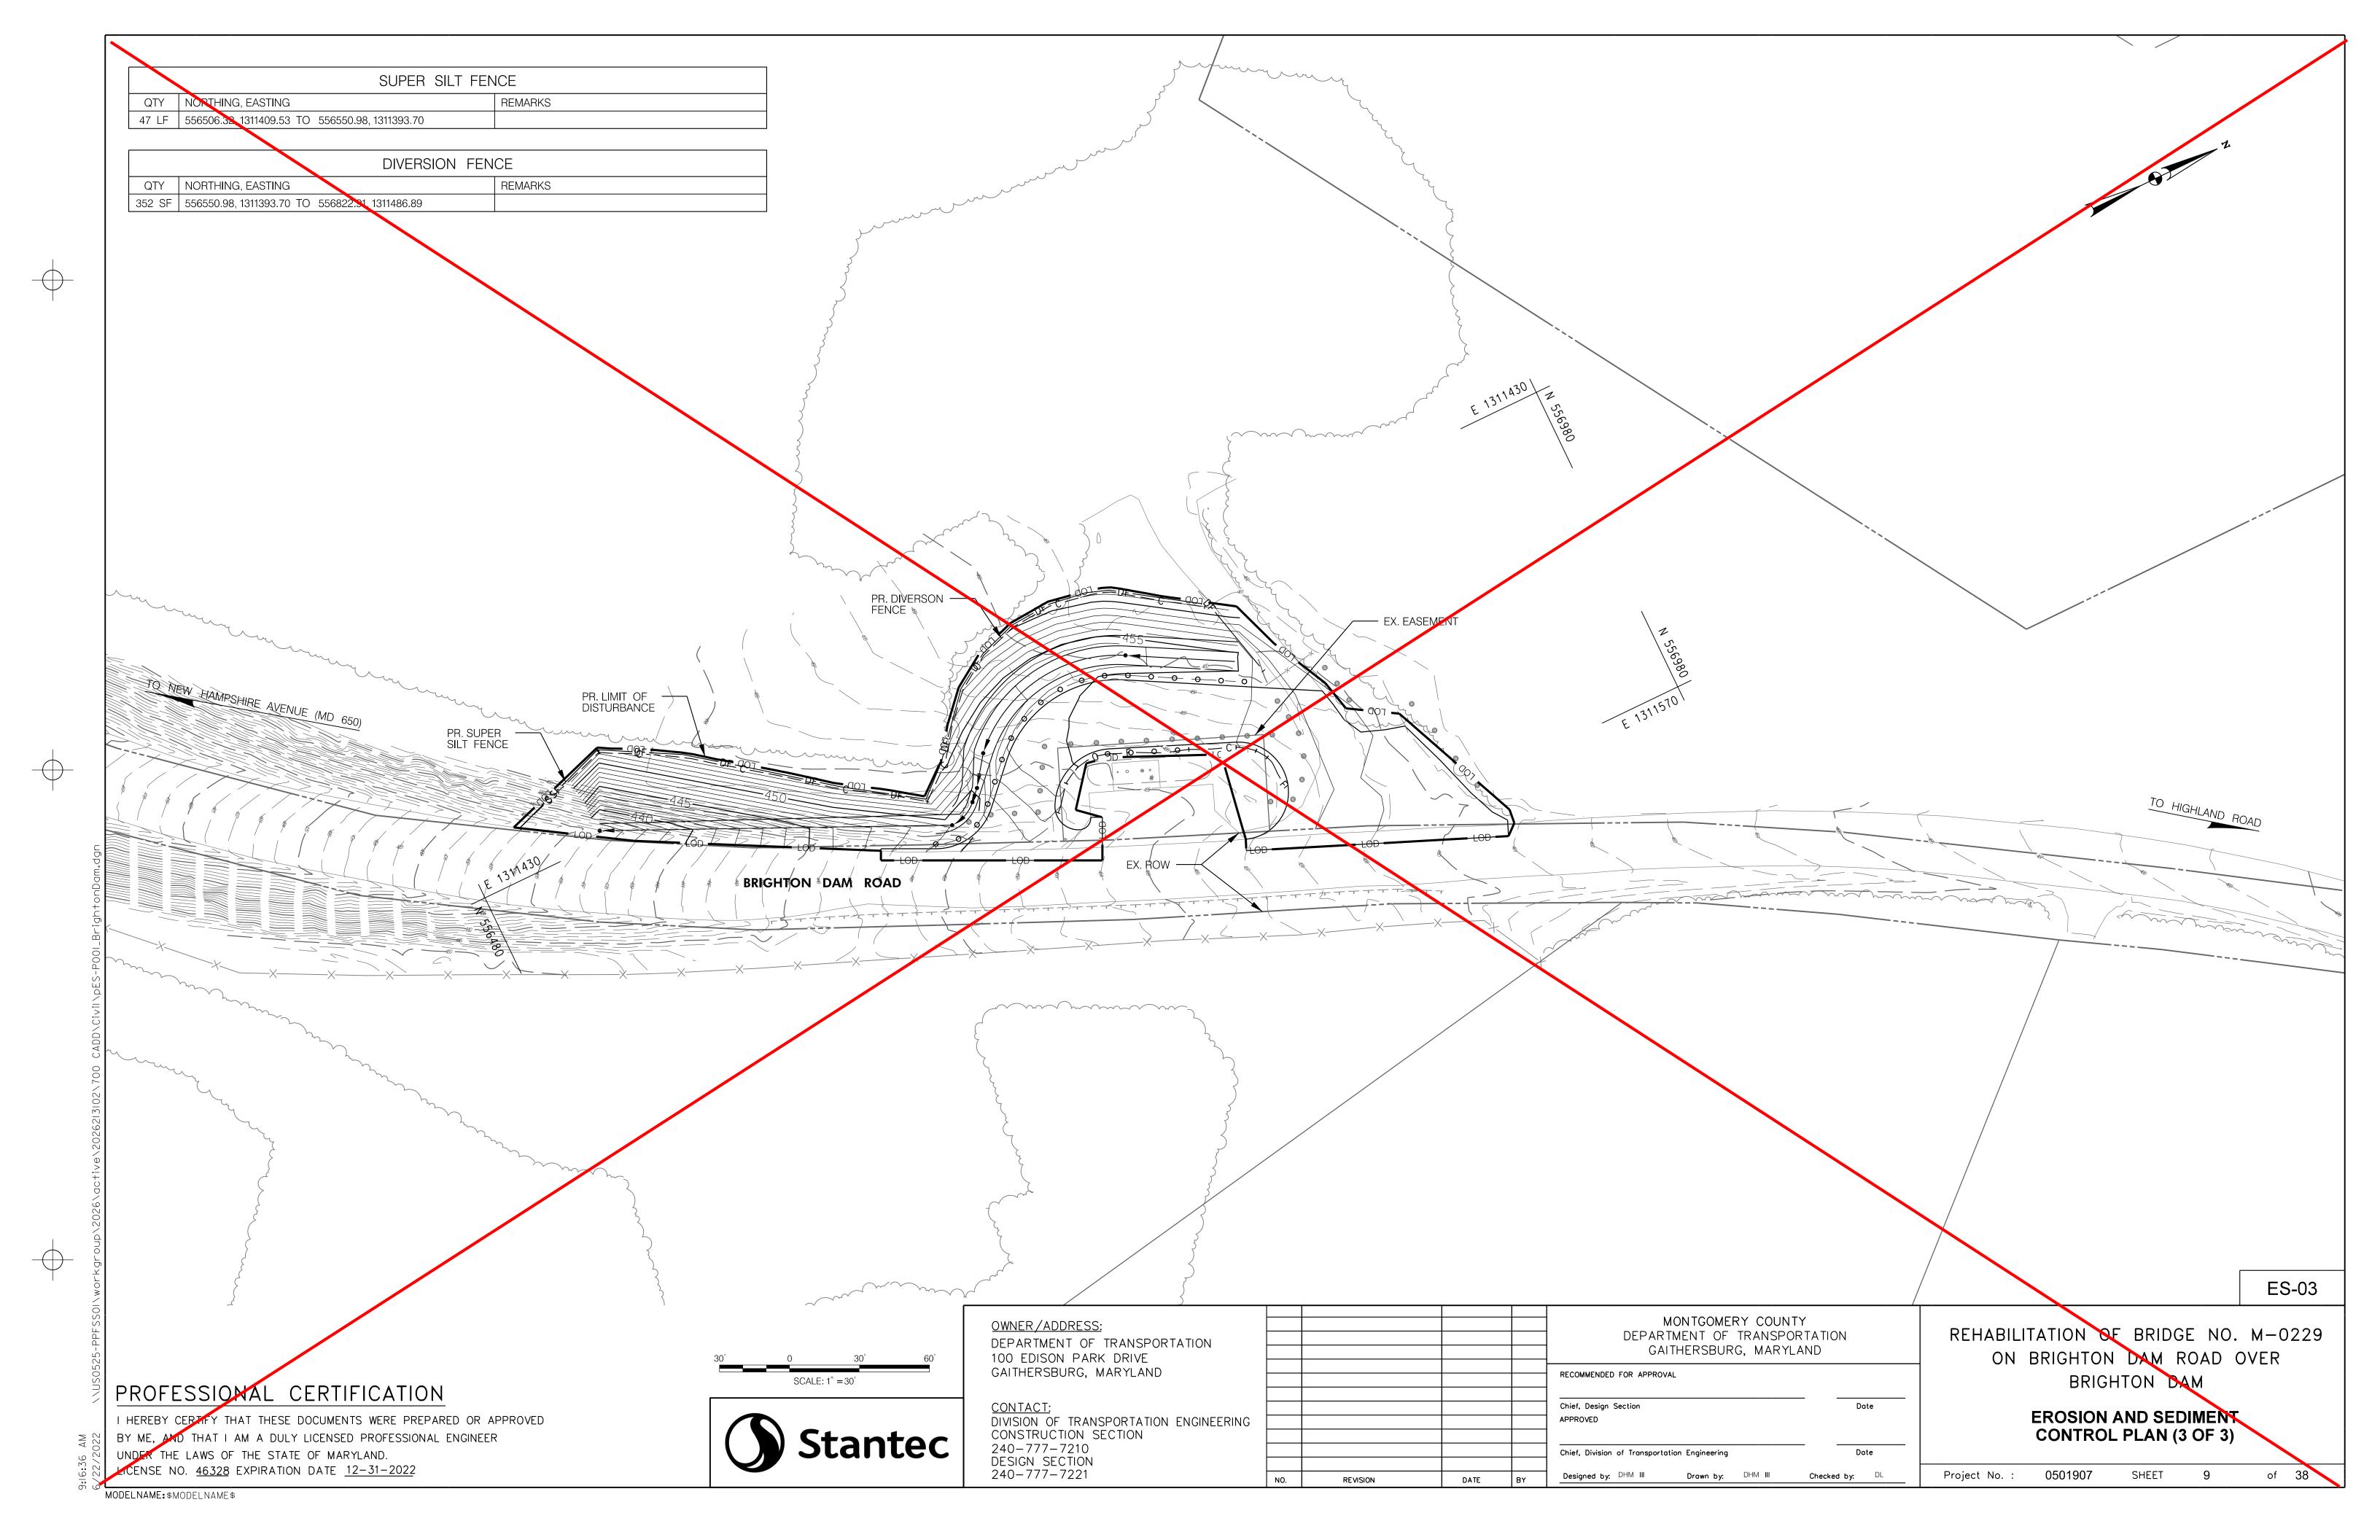

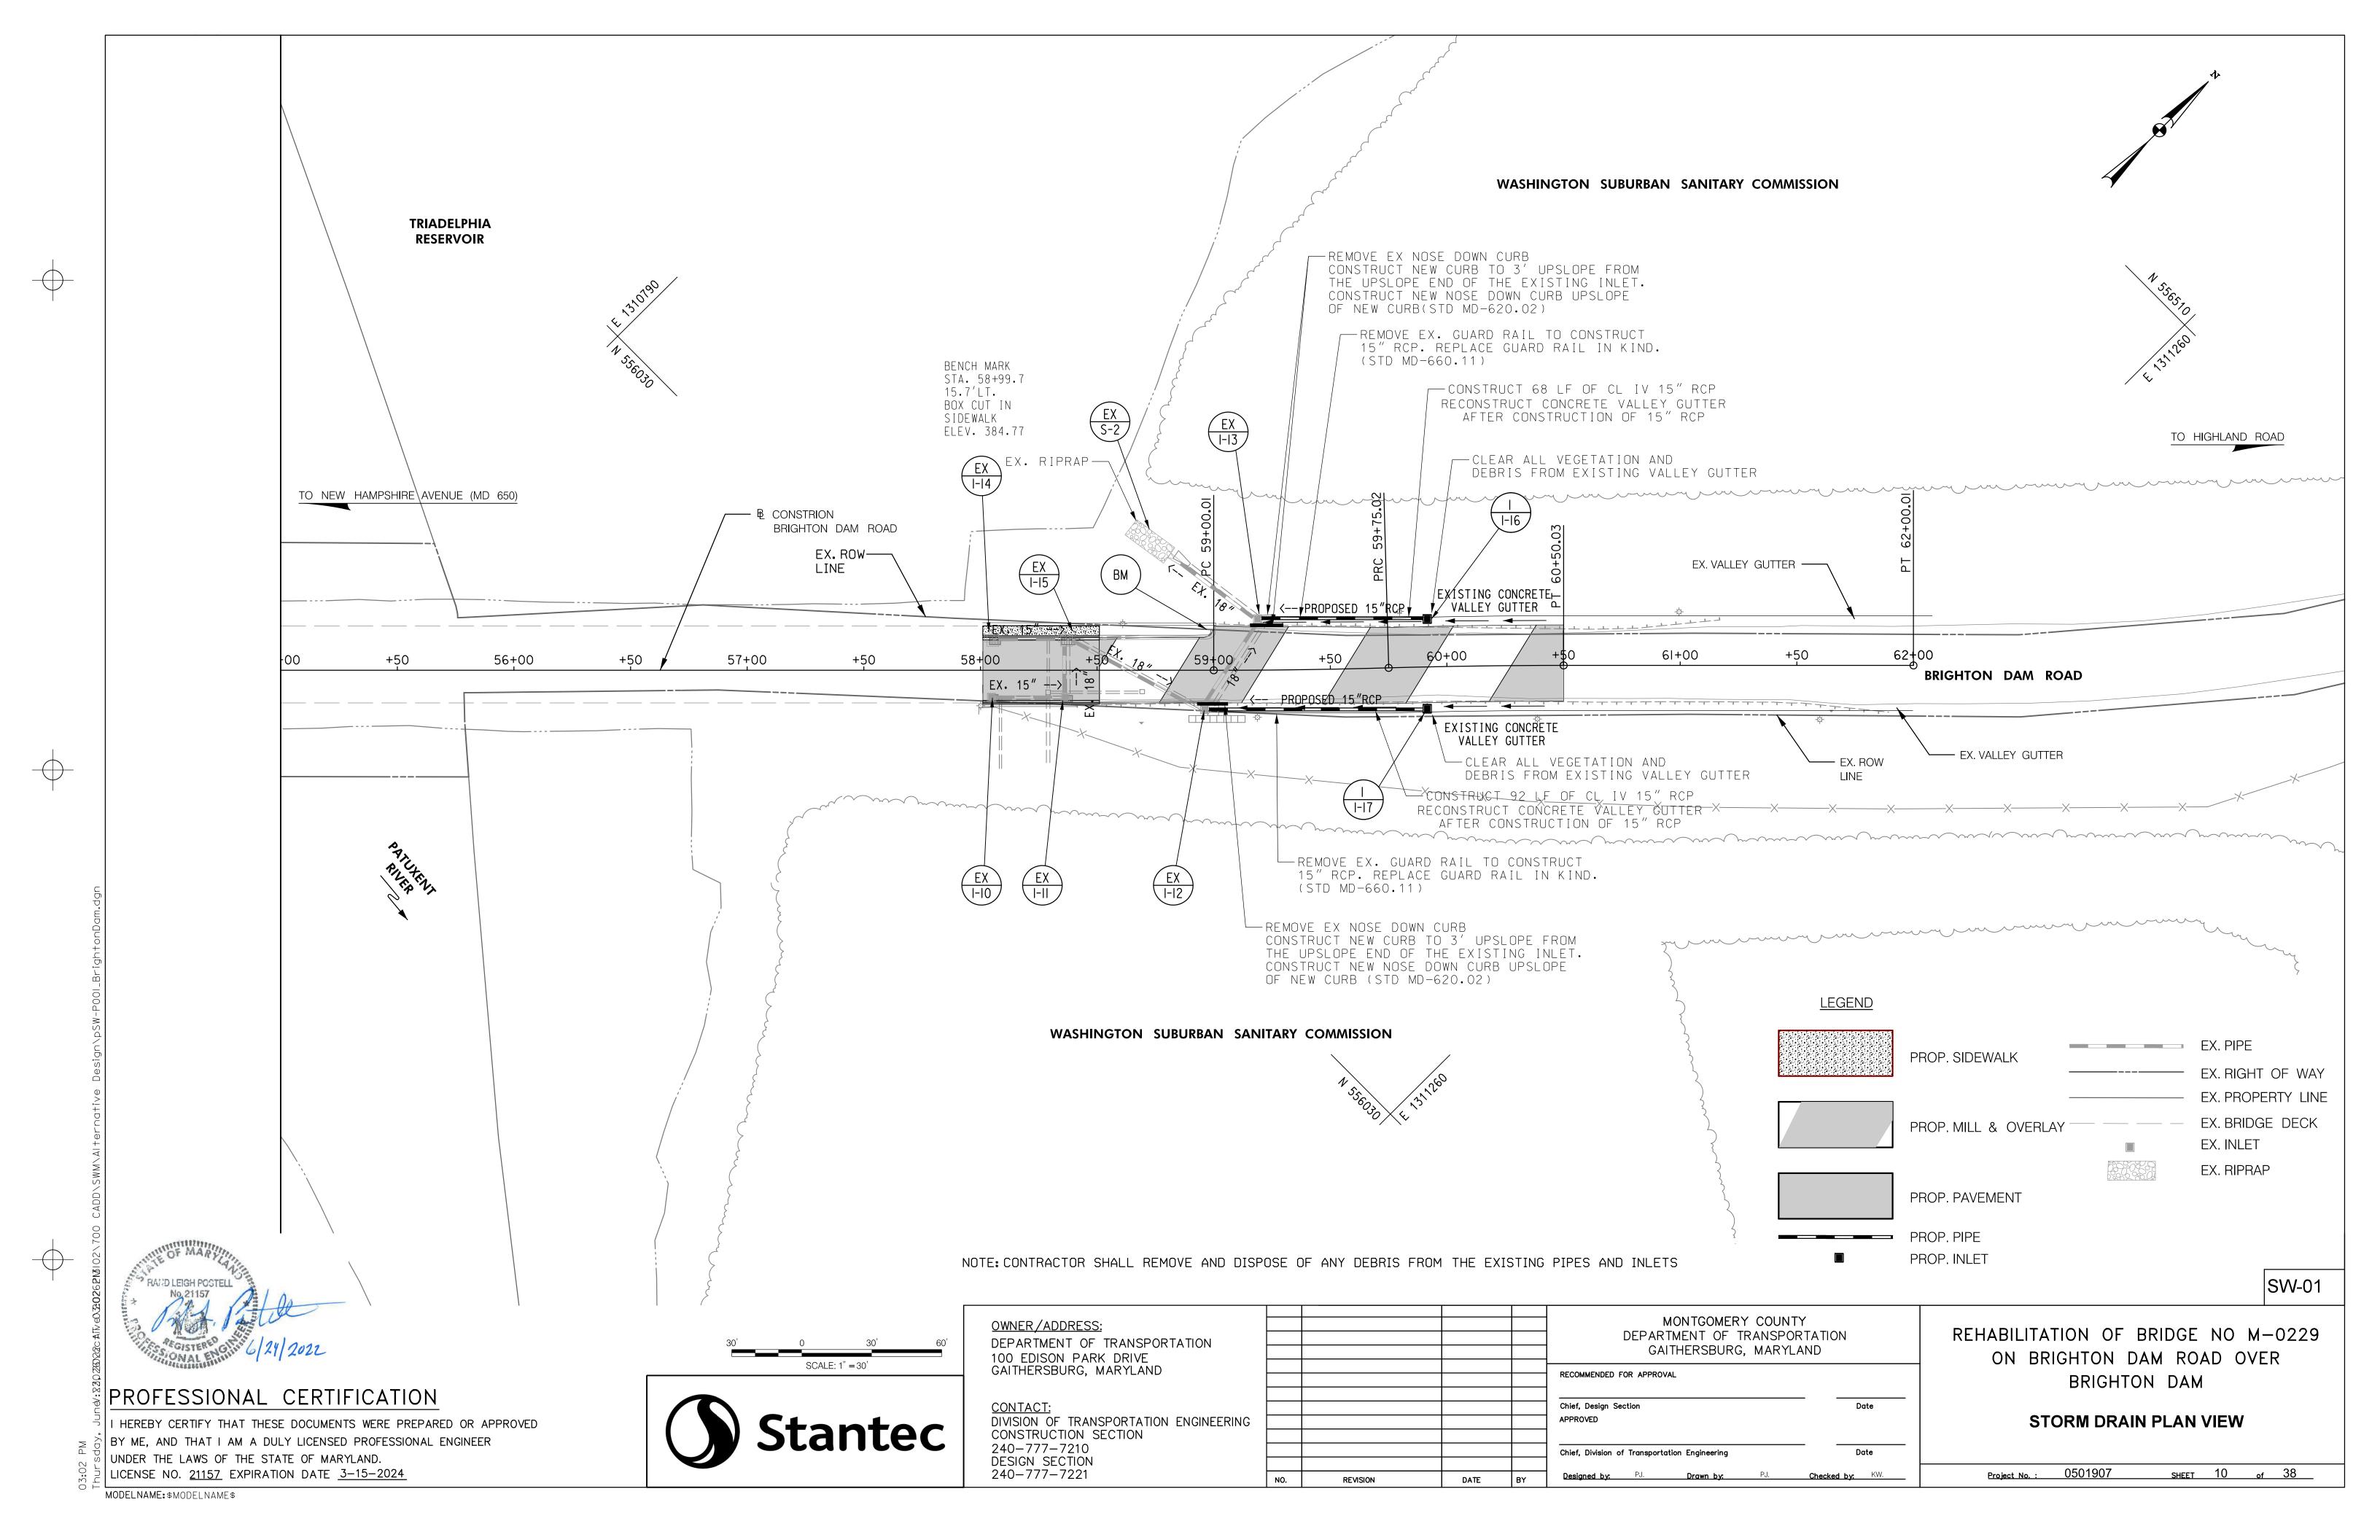

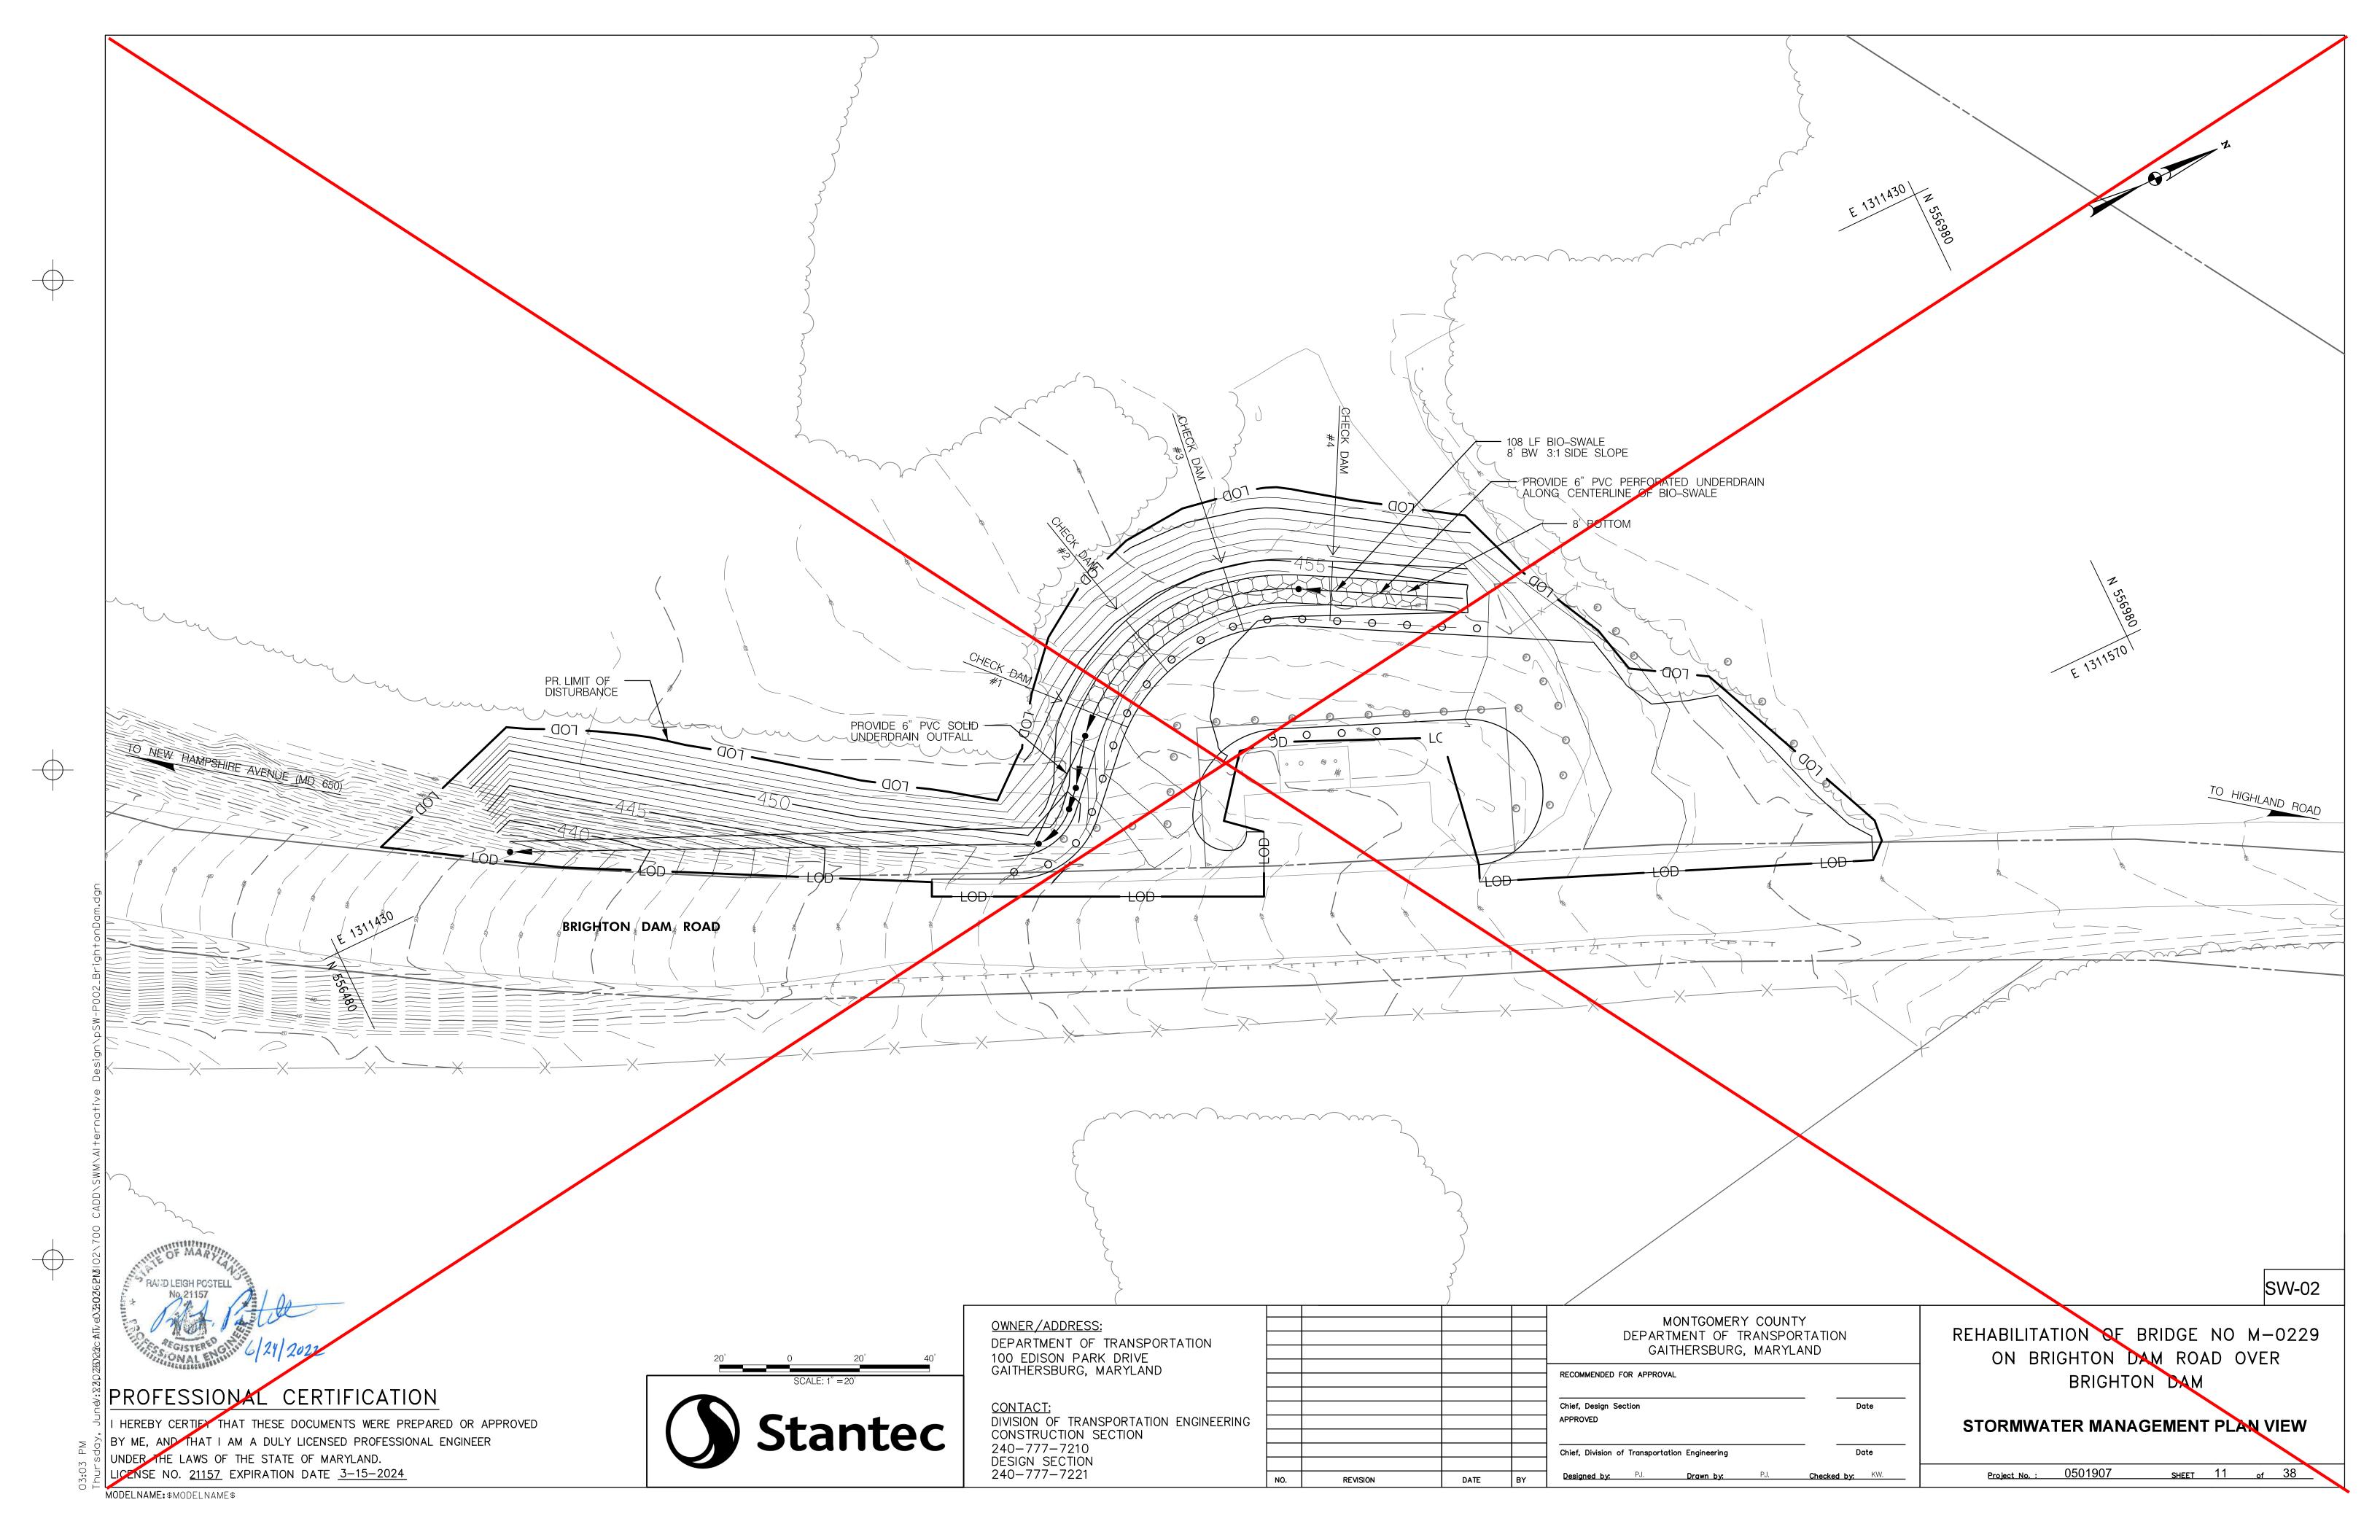

PROFESSIONAL CERTIFICATION

I HEREBY CERTIFY THAT THESE DOCUMENTS WERE PREPARED OR APPROVED BY ME, AND THAT I AM A DULY LICENSED PROFESSIONAL ENGINEER UNDER THE LAWS OF THE STATE OF MARYLAND. LICENSE NO. <u>21157</u> EXPIRATION DATE <u>3-15-2024</u>

SCALE: NTS

1. CONCRETE VALLEY GUTTER SHALL MEET THE

2. MAXIMUM SPACING BETWEEN JOINTS SHALL

SPECIFICATIONS FOR CONSTRUCTION AND MATERIALS OF CONCRETE COMBINATION CURB AND GUTTER.

BE 10 FEET.

— 6" CONCRETE

—— 4" BASE COURSE USING GRADED AGGREGATE

VALLEY GUTTER

CONCRETE VALLEY GUTTER DETAIL

OWNER/ADDRESS: DEPARTMENT OF TRANSPORTATION 100 EDISON PARK DRIVE GAITHERSBURG, MARYLAND

CONTACT: DIVISION OF TRANSPORTATION ENGINEERING CONSTRUCTION SECTION 240-777-7210 DESIGN SECTION 240-777-7221

				DEPARTMENT OF TRANSPORTA GAITHERSBURG, MARYLAND	
				RECOMMENDED FOR APPROVAL	
				Chief, Design Section APPROVED	Date
				Chief, Division of Transportation Engineering	Date
NO.	REVISION	DATE	BY	Designed by: PJ. Drawn by: PJ. Ch	ecked by: KW.

BRIGHTON DAM

REHABILITATION OF BRIDGE NO M-0229

ON BRIGHTON DAM ROAD OVER

SW-03

STORM DRAIN PROFILES, SCHEDULES AND DETAILS

SHEET 12 of 38

NOTE: CONTRACTOR SHALL REMOVE AND DISPOSE OF ANY DEBRIS FROM THE EXISTING PIPES AND INLETS

400

SCALE: V: 1" = 5' H: 1" = 30'

	PIPE SHEDULE						
	LOCATION	SIZE	LENGTH				
	I-16 TO EX. I-13	15" RCP CL. 4	68 L.F.				
	I-17 TO EX. I-12	15" RCP CL. 4	92 L.F.				
I.							

I NII IN /IDED L	LOCA	TION	TVDE	ELEV <i>A</i>	ATION	CTANDADD
NUMBER S	STATION	OFFSET	TYPE	TOP	INVERT	STANDARD
I-16	59+89	18 LT.	SINGLE OPENING K INLET	390.5	385.2	MD-378.03
I-17	59+89	16 RT.	SINGLE OPENING K INLET	390.5	385.5	MD-378.03

MONTGOMERY COUNTY

STRUCTURE SCHEDULE									
VILIVADED	LOCA	TION	TYPE	ELEV <i>A</i>	ATION	STANDARD			
NUMBER	STATION	OFFSET	ITPE	TOP	INVERT	STANDARD			
I-16	59+89	18 LT.	SINGLE OPENING K INLET	390.5	385.2	MD-378.03			
I-17	59+89	16 RT.	SINGLE OPENING K INLET	390.5	385.5	MD-378.03			

EX 1-13

VALLEY ---

18" (S-2)-

GUTTER

TRANS.

EX. CONCRETE —

15" R.C.P.

@ 7.1%

NOTE: EX CONCRETE VALLEY GUTTER AND VALLEY GUTTER

TRANSITION BETWEEN EX. I-12 AND I-17 SHALL BE REMOVED TO CONSTRUCT 15" RCP BETWEEN EX. I-12 AND I-17. UPON COMPLETION OF 15" RCP, THE CONCRETE VALLEY GUTTER AND VALLEY GUTTER TRANSITION SHALL BE RECONSTRUCTED

INV = 385.5 -

VALLEY GUTTER

— EX. VALLEY

GUTTER

1-12

EX. GRADE

└ 379.0

 $\left| \frac{1}{2} \right| = 377.0$ 377.5 $\int \left| \frac{18}{18} \right| = 15$

EX. 18" R.C.C.P.

CL 4 @ 1.2%

VALLEY GUTTER ^L 384.1 INV = 385.2377.0 $^{\circ}$. (2) NOTE: EX CONCRETE VALLEY GUTTER AND VALLEY GUTTER TRANSITION BETWEEN EX. I–13 AND I–16 SHALL BE REMOVED TO CONSTRUCT 15" RCP BETWEEN EX. I–13 AND I–16. UPON


EX. VALLEY GUTTER TRANS. EX. GRADE — - 376.1 EX. RIPRAP —


COMPLETION OF 15" RCP, THE CONCRETE VALLEY GUTTER AND VALLEY GUTTER TRANSITION SHALL BE RECONSTRUCTED


EX. HOT MIX ASPHALT SHOULDER


EX. CONCRETE


Project No.: 0501907

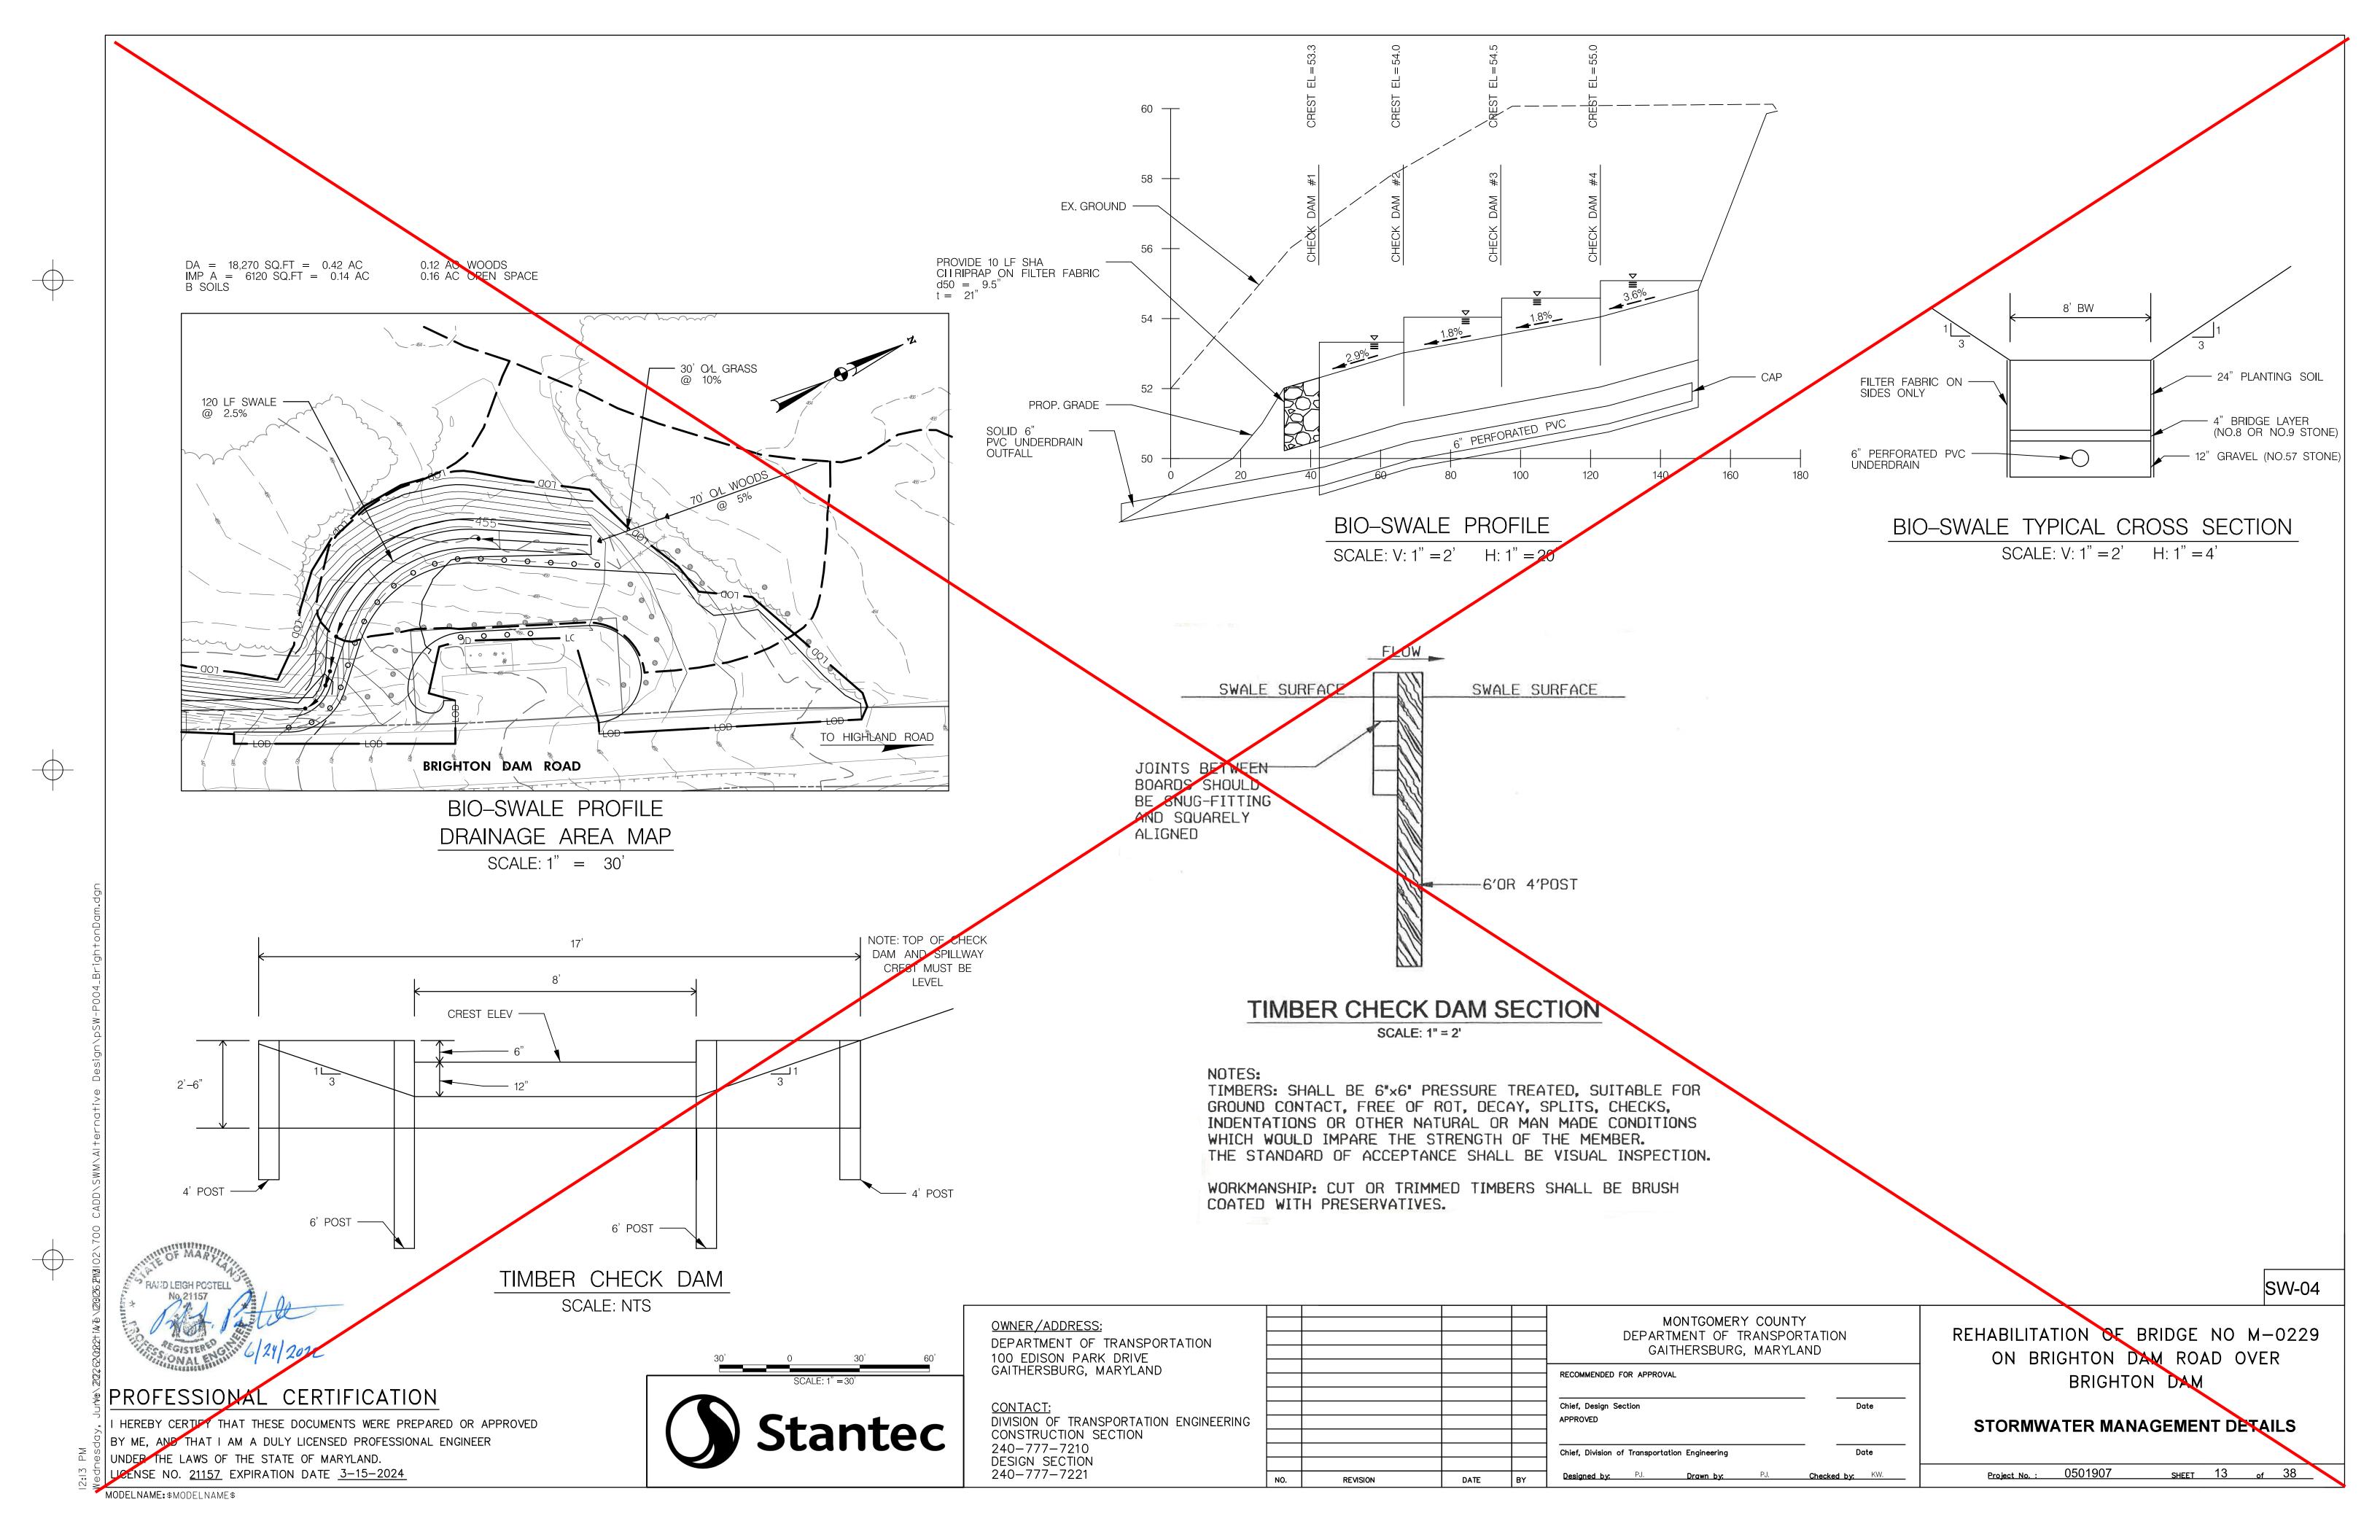

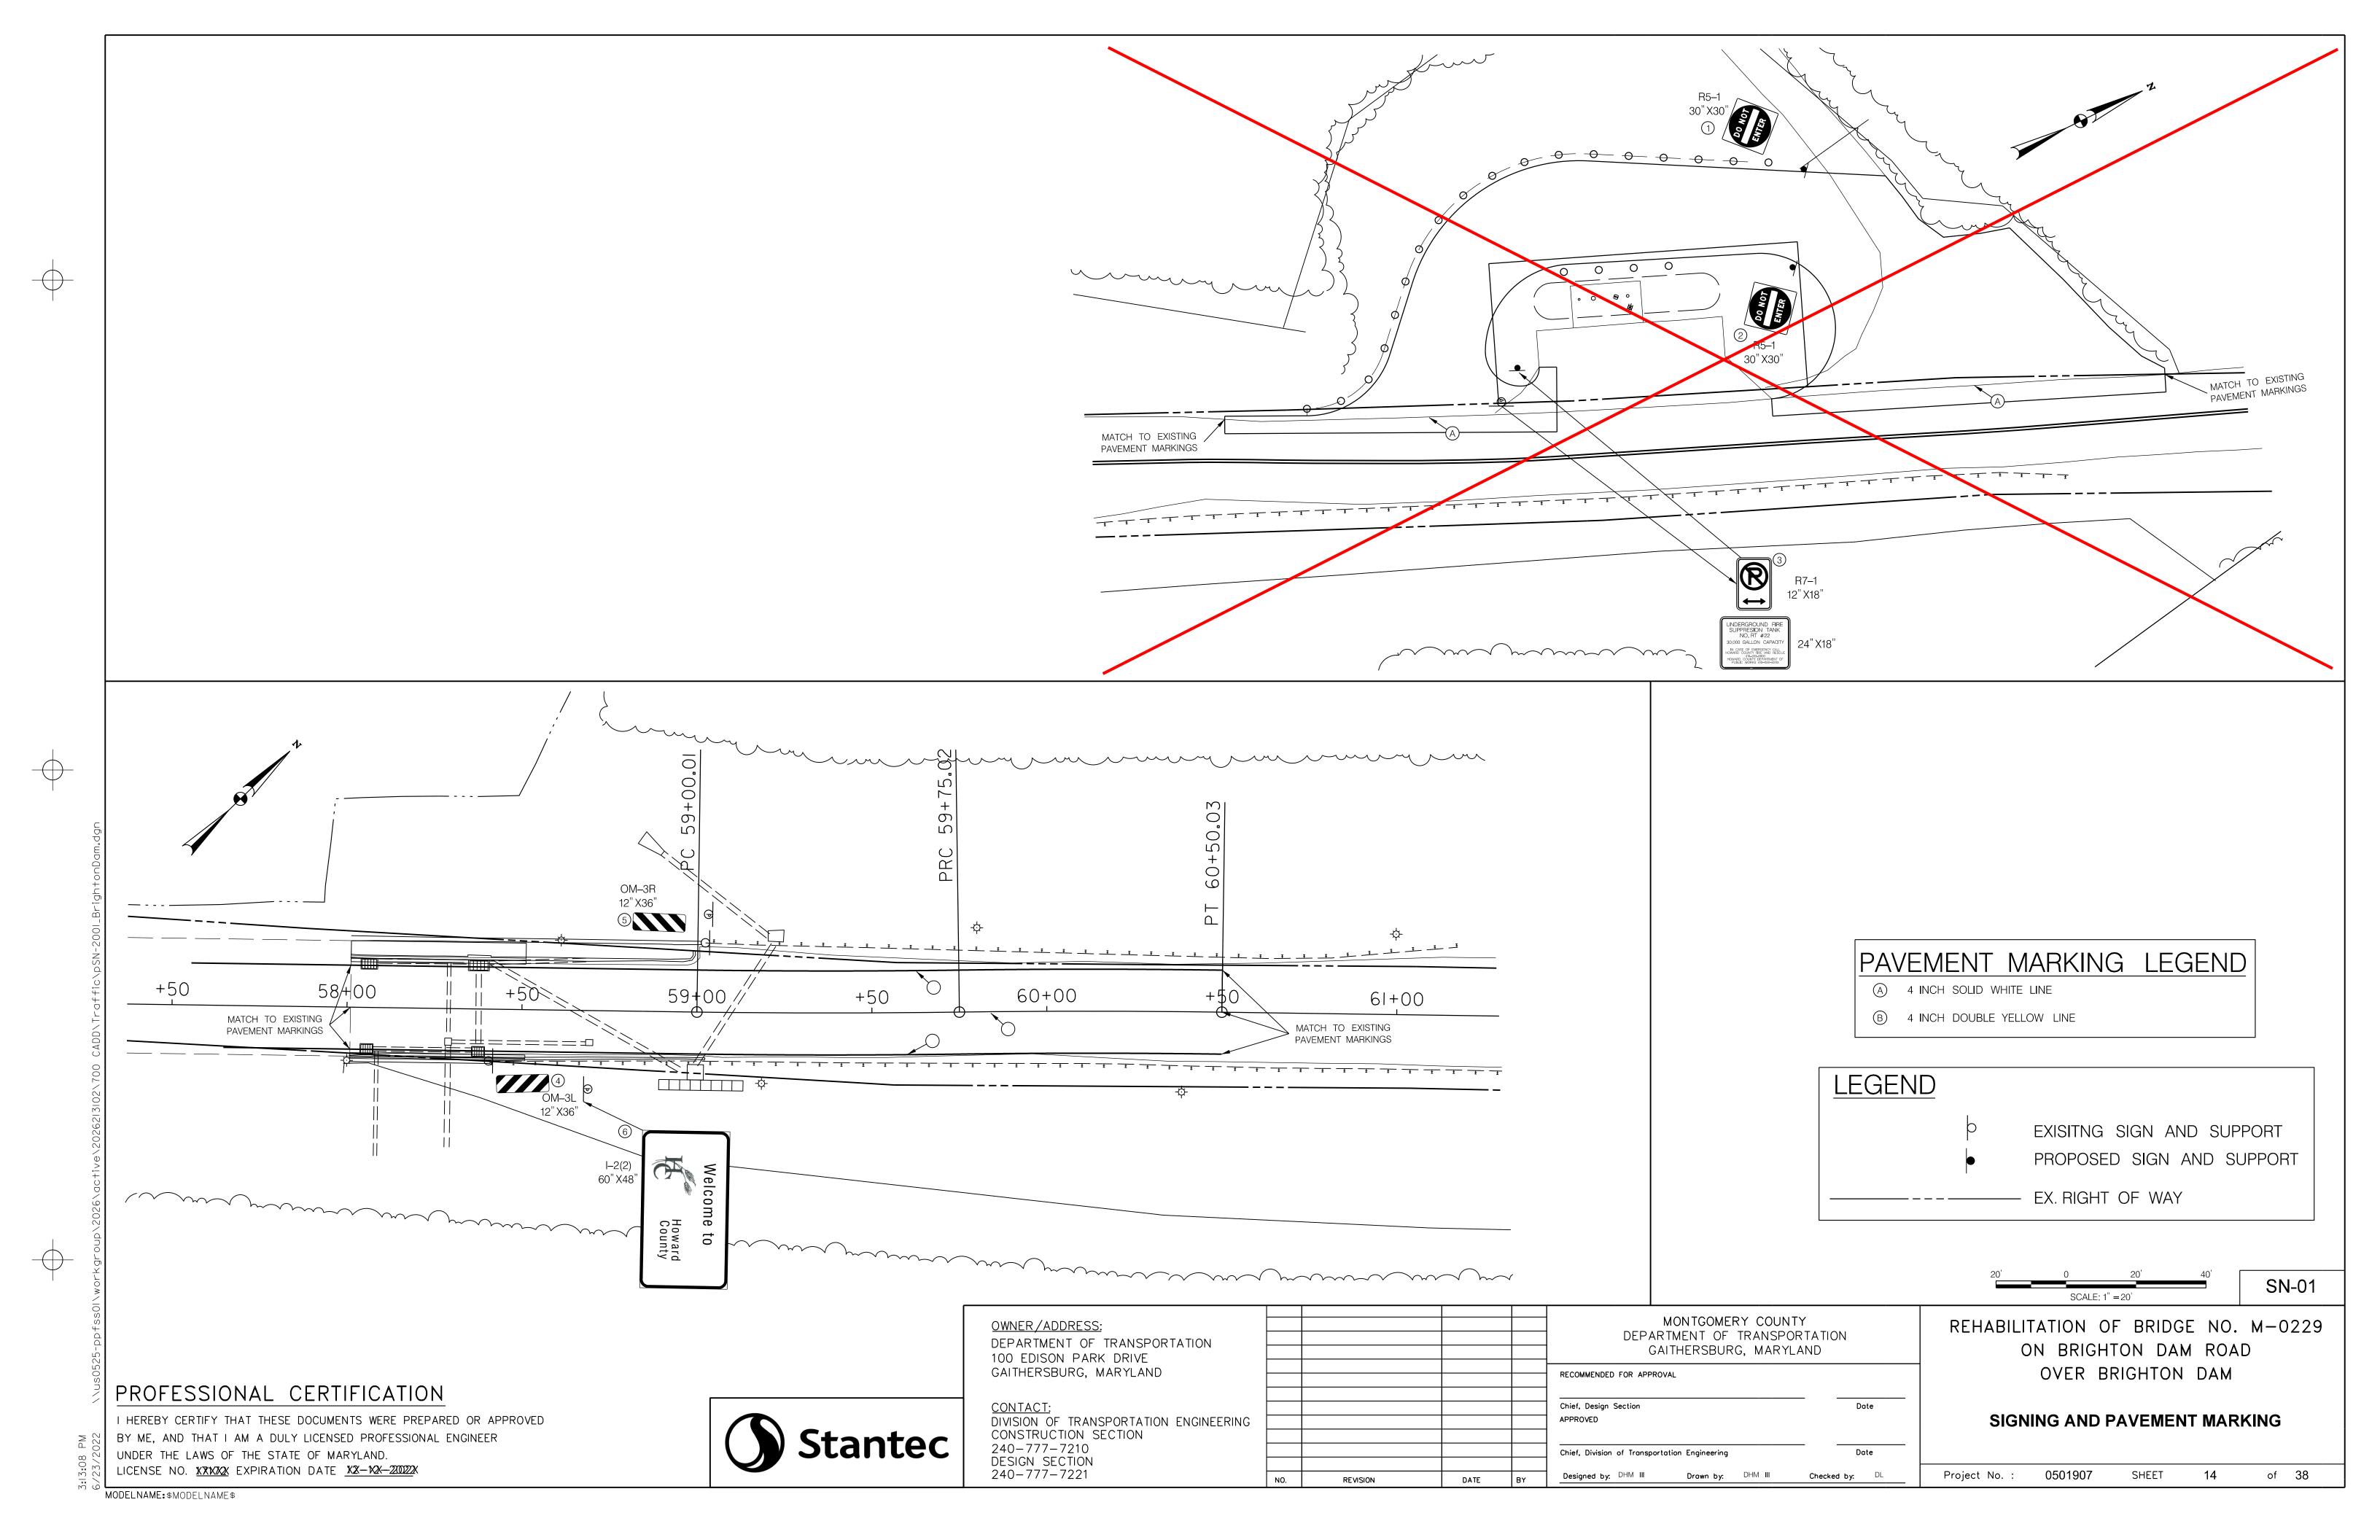


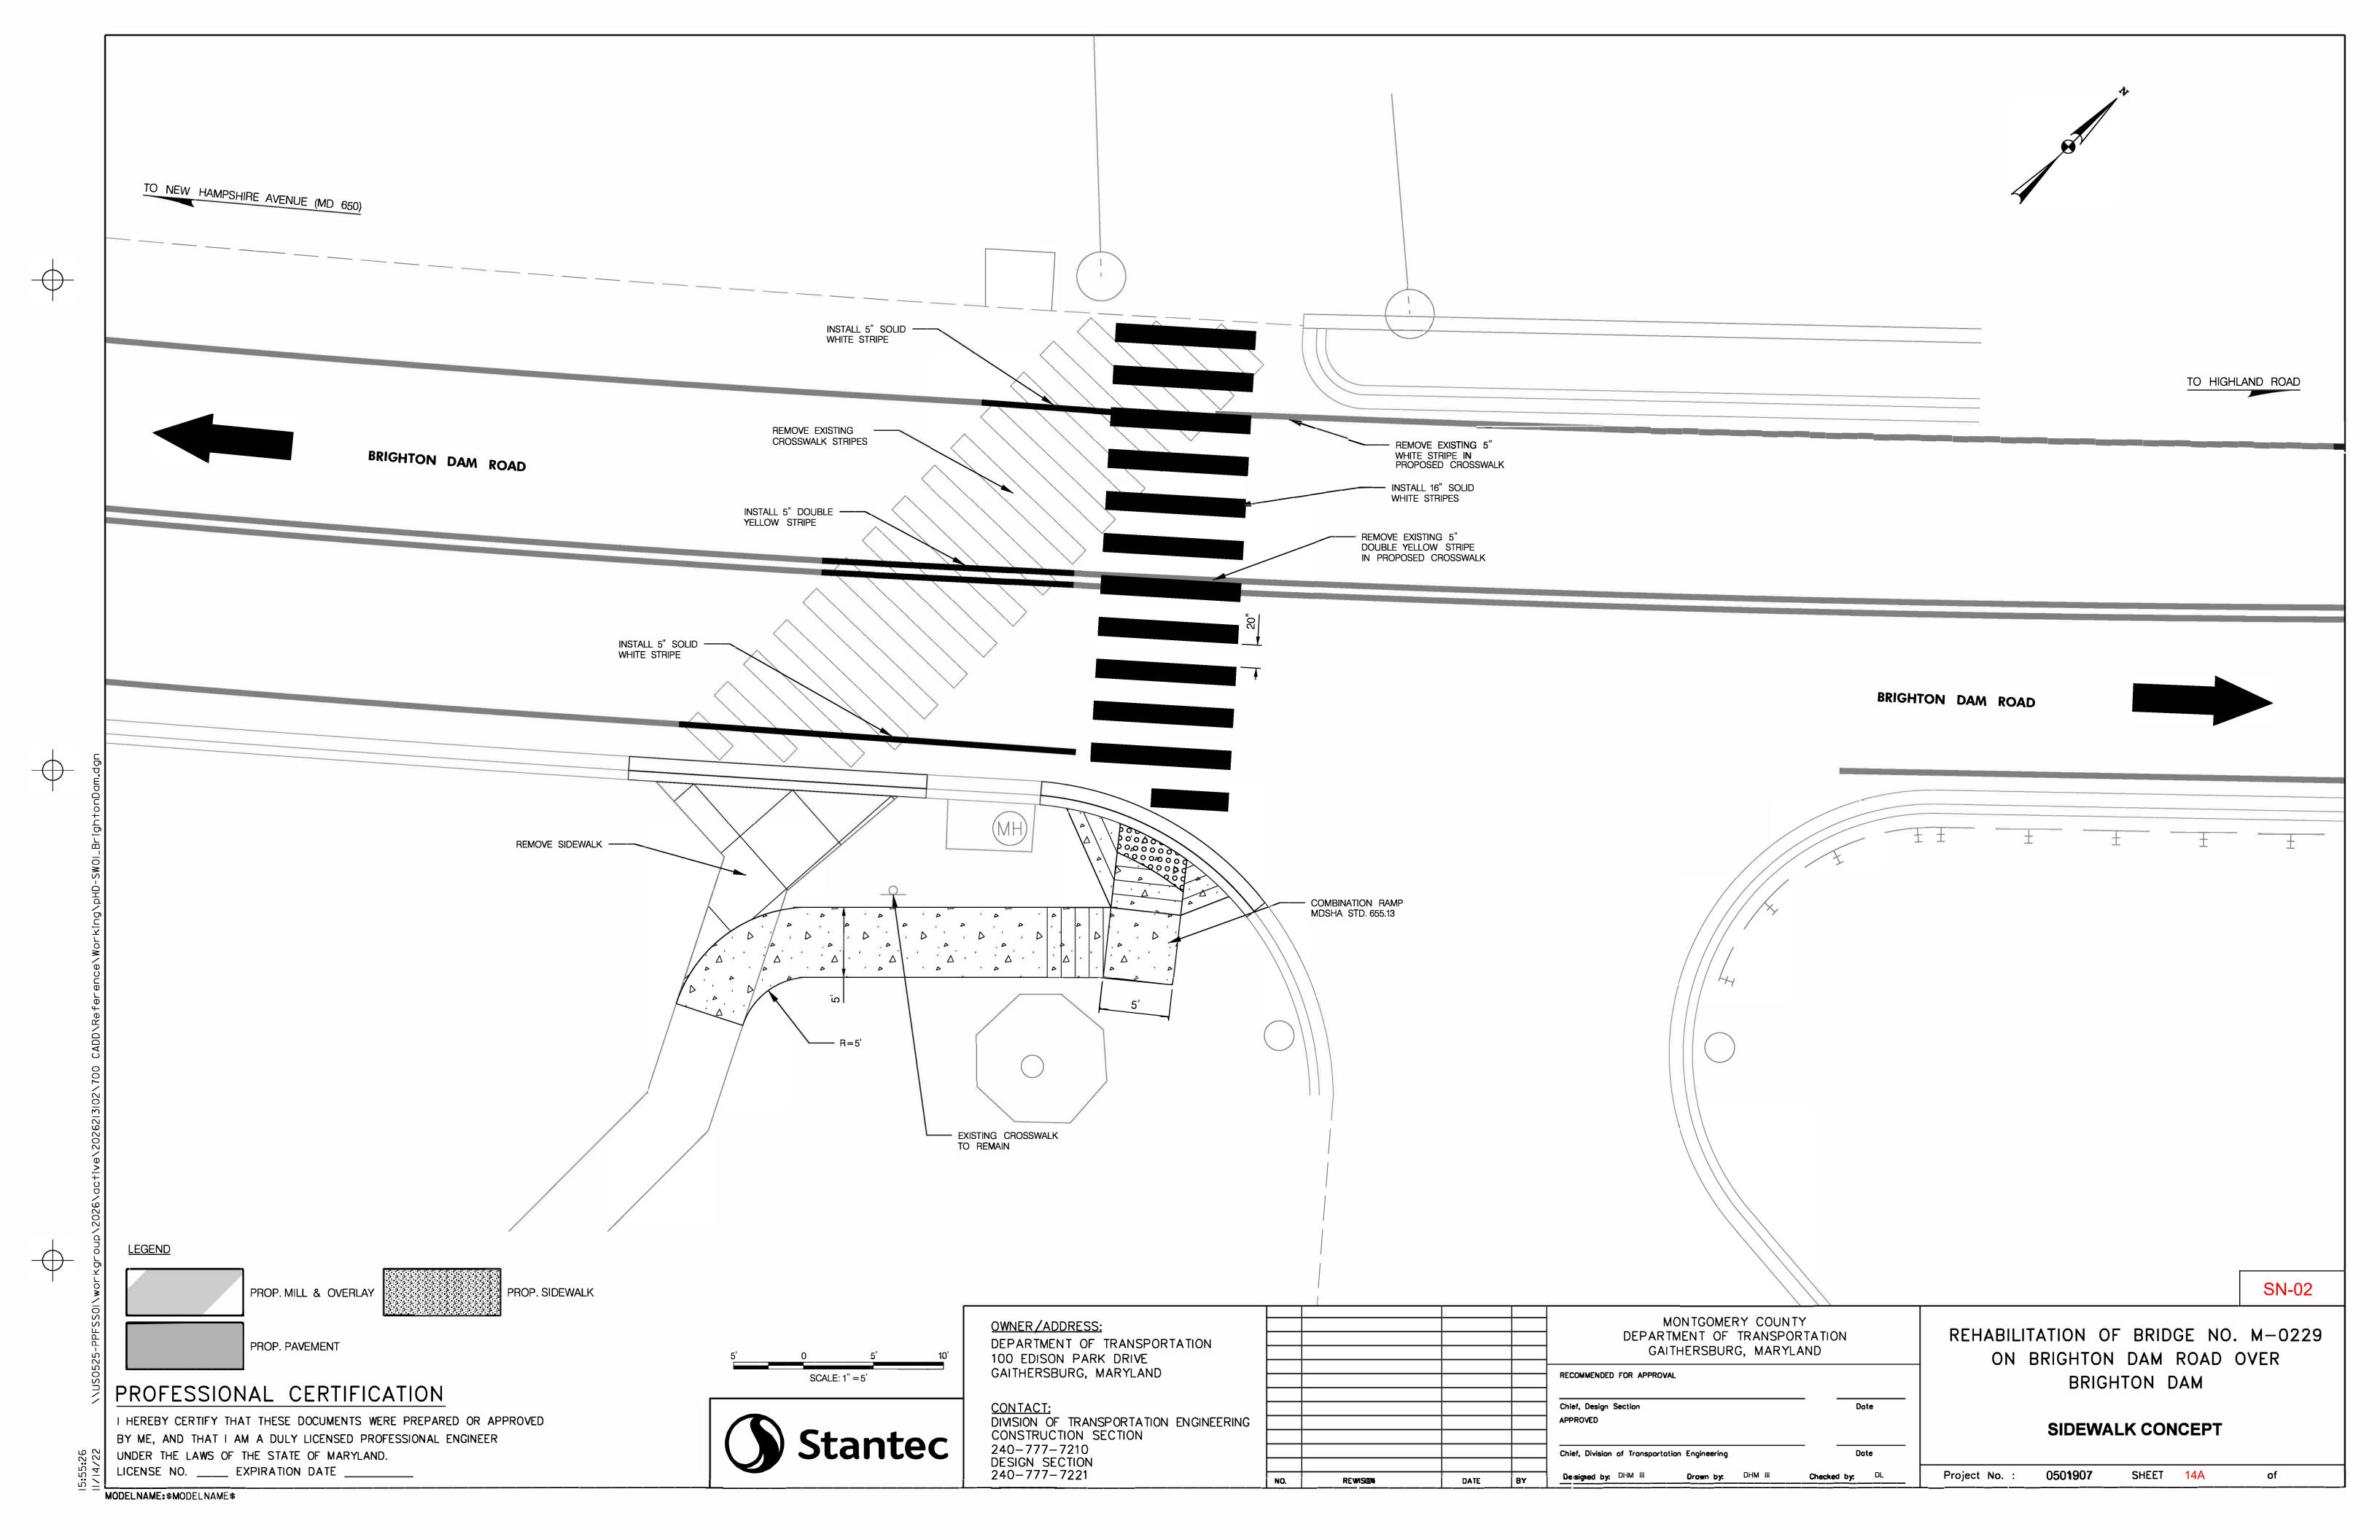

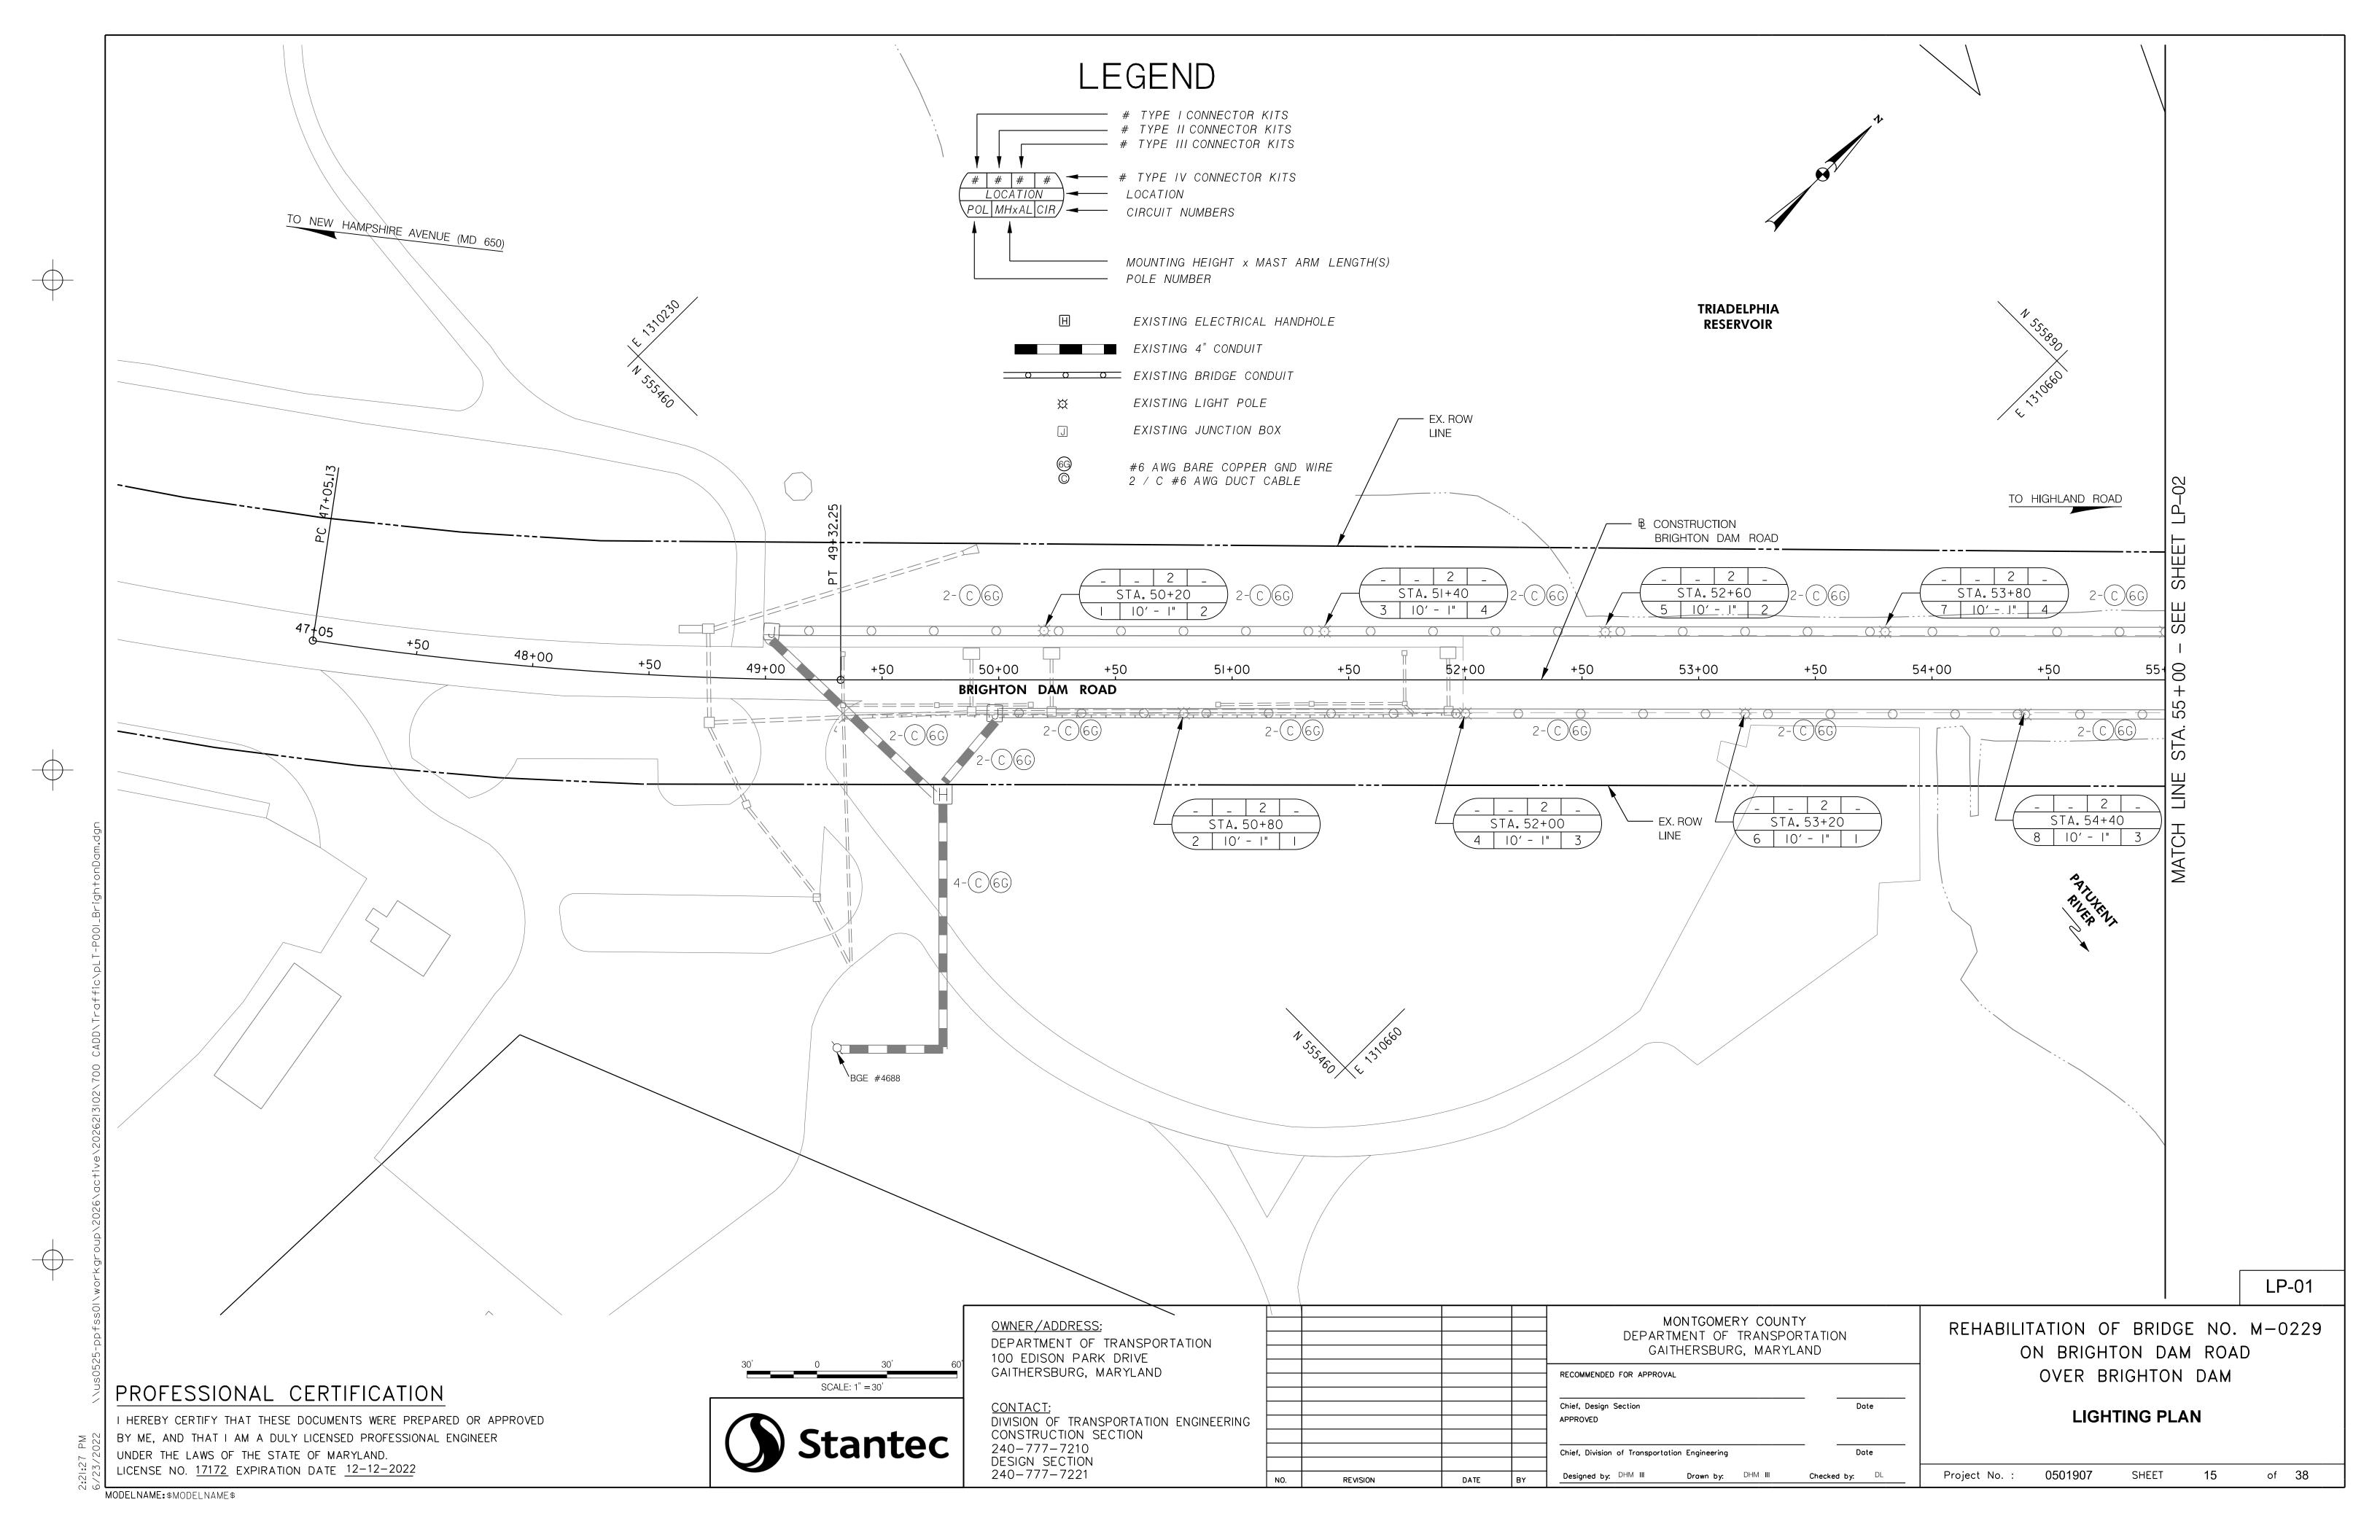

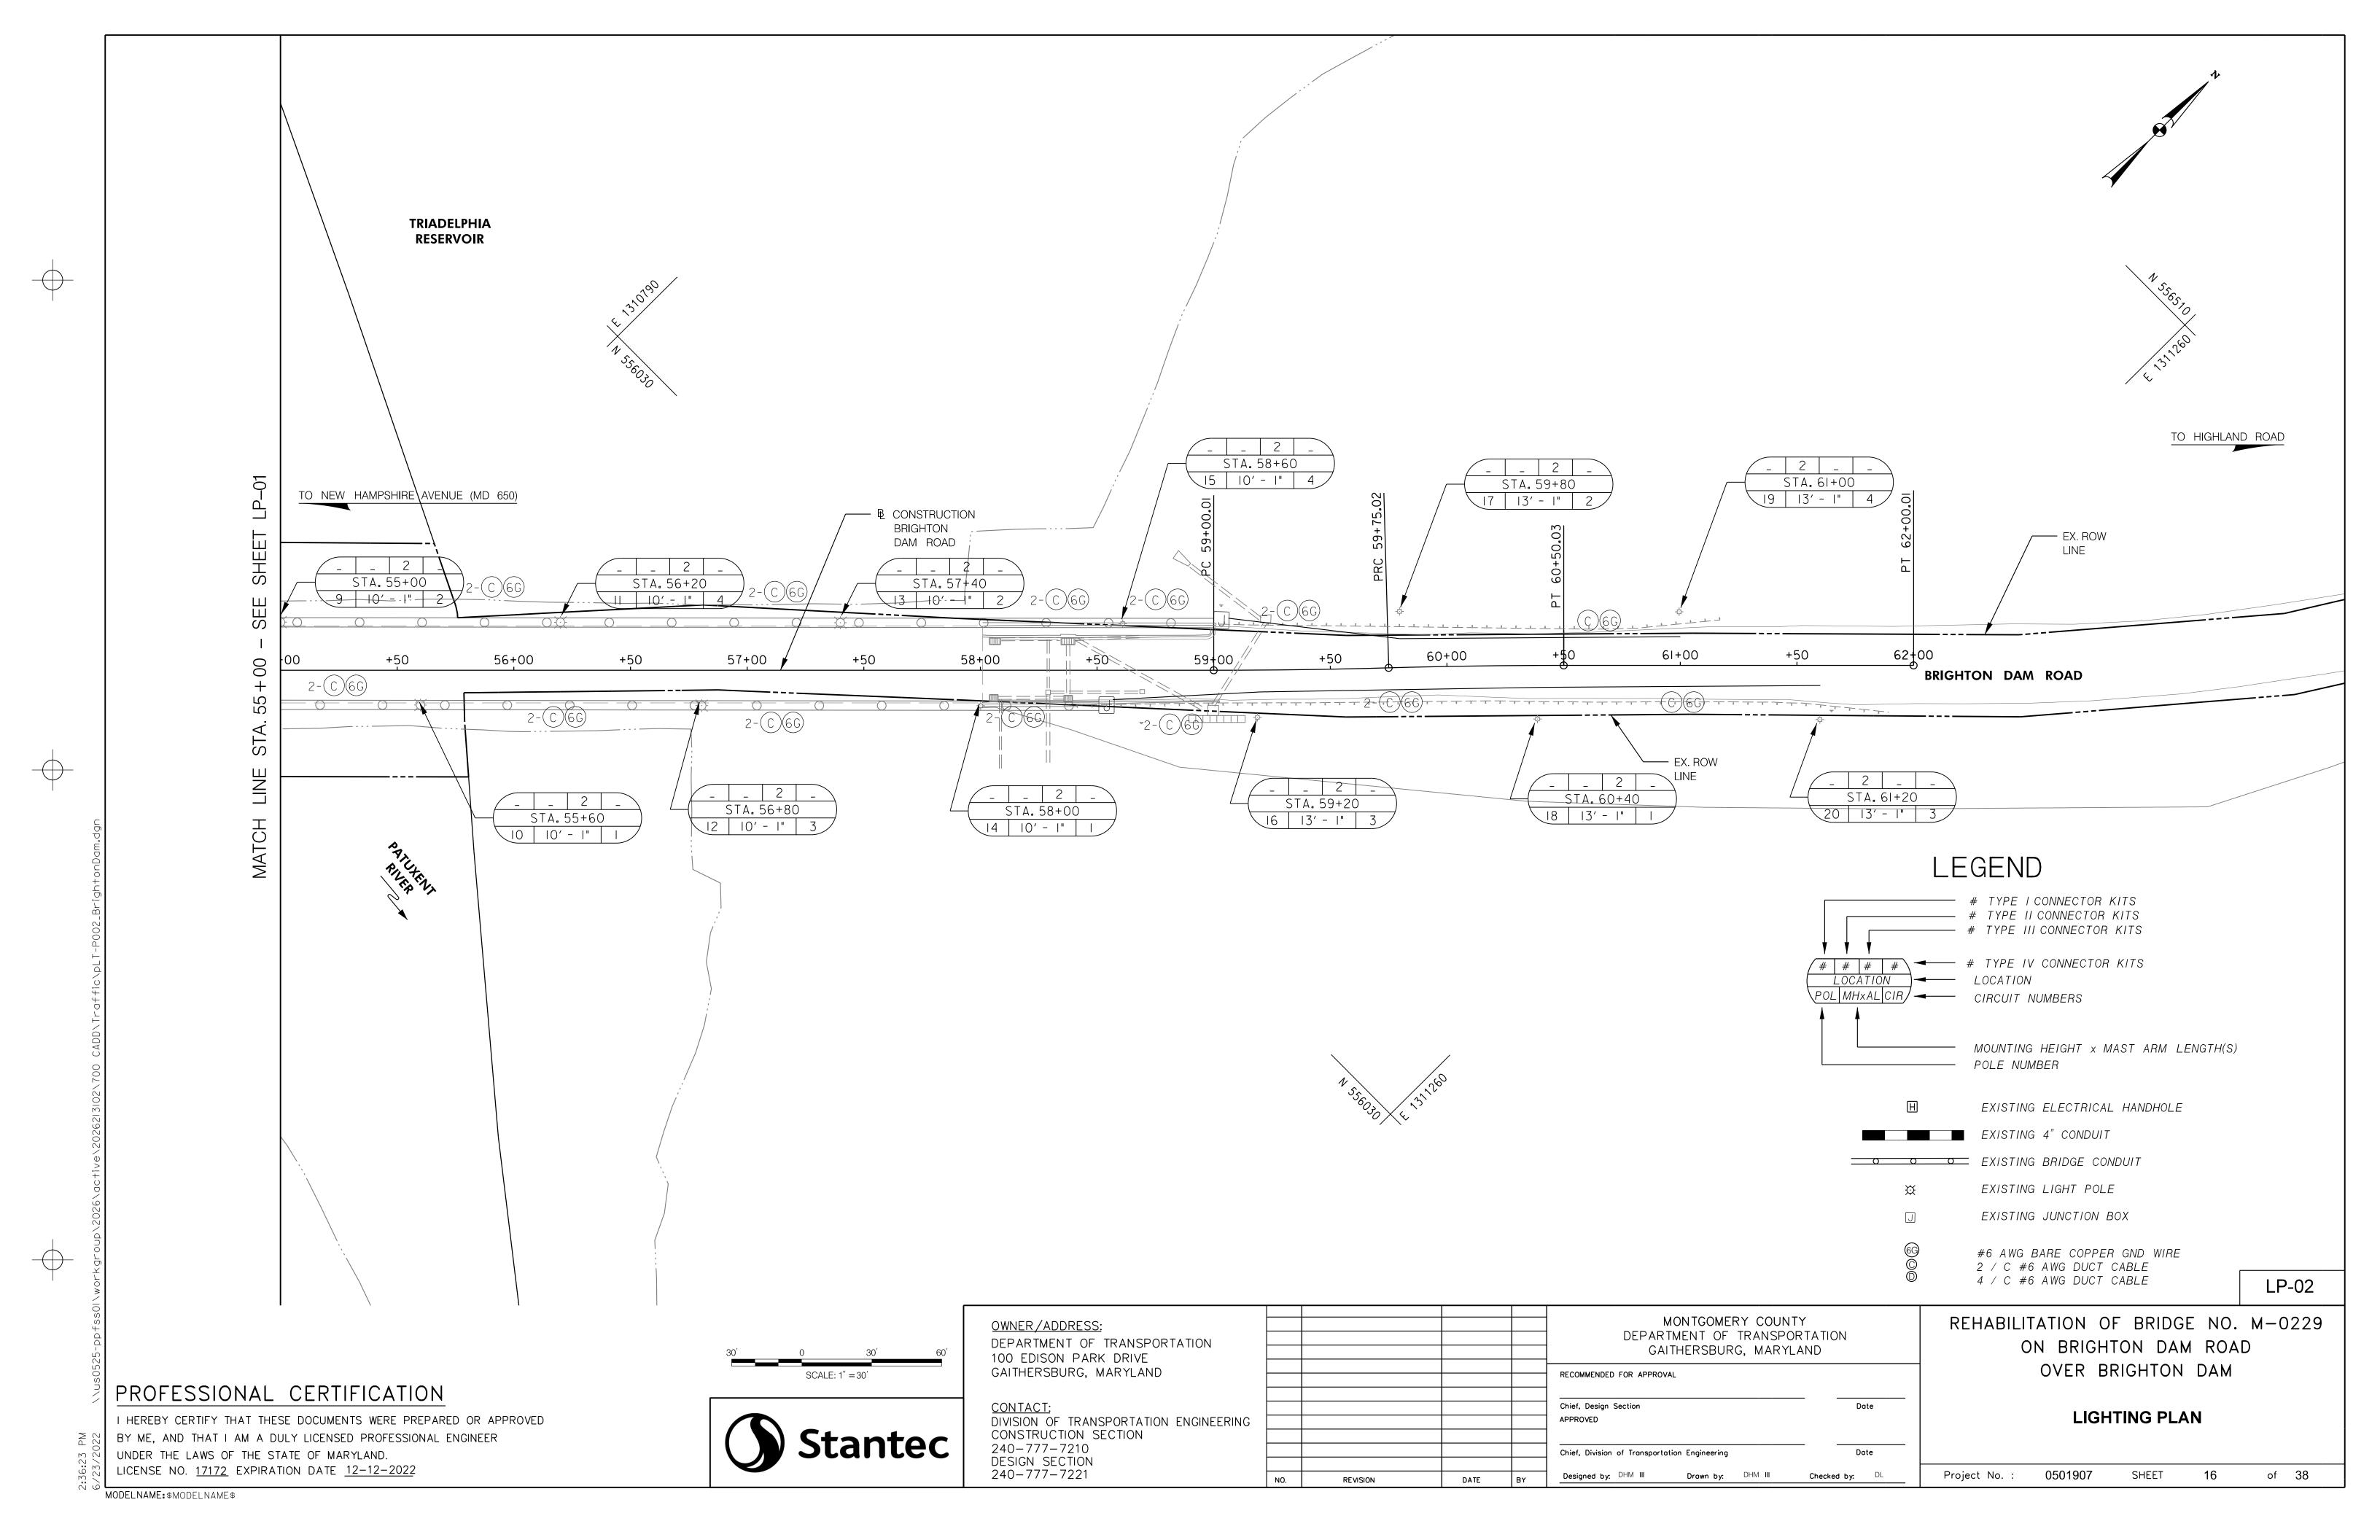

- 2. ALL CONNECTORS BETWEEN GROUND RODS AND GROUND CABLE SHALL BE BY EXOTHERMIC WELD.
- 3. CONDUCTORS SHALL NOT BE SPLICED EXCEPT IN STRUCTURES, MANHOLES AND PULL OR JUNCTION BOXES. ALL MANHOLES, CONDUITS UNDER PAVEMENTS, LIGHTING STRUCTURES, ETC, SHALL BE STAKED OUT AND EVERY LOCATION APPROVED BY THE ENGINEER BEFORE ANY WORK IS DONE.
- 4. ALL DRIVEN CONDUIT SHALL BE PLACED UNDER PAVEMENT BY DIRECTIONAL BORING OR JACKING.
- 5. ALL TRENCHING MUST BE BACKFILLED AND RESTORED TO ITS ORIGINAL CONDITION ON THE SAME WORKING DAY ON WHICH IT WAS OPENED. AREAS WHICH ARE NOT REDRESSED, MULCHED OR SODDED MUST BE COVERED TO PREVENT EROSION. ALL SOIL NOT USED FOR BACKFILL MUST BE REMOVED ON THE SAME WORKING DAY.
- 6. ALL SOIL REMOVED FOR HANDBOXES, FOUNDATIONS, ETC, MUST BE COVERED TO PREVENT EROSION. SOIL NOT USED FOR BACKFILL MUST BE DISPOSED OF TO THE ENGINEER'S SATISFACTION ON THE SAME WORKING DAY THE BACKFILL IS COMPLETED.
- 7. THE CONTRACTOR SHALL VERIFY ALL UNDERGROUND UTILITIES PRIOR TO INSTALLING PROPOSED LIGHTING EQUIPMENT. IF ANY UTILITY CONFLICTS SHOULD ARISE THE CONTRACTOR SHALL CONTACT THE PROJECT ENGINEER.
- 8. THE CONTRACTOR SHALL VERIFY ALL OPERATING VOLTAGES PRIOR TO ORDERING EQUIPMENT AND SHALL NOTIFY THE PROJECT ENGINEER IF A CONFLICT ARISES.
- 9. INSTALL PHOTOCELL ON LUMINAIRE.
- 10. THE OPERATING VOLTAGE OF PROPOSED LUMINAIRES SHALL BE 240V.
- 11. THE CONTRACTOR SHALL CONTACT THE UTILITY COMPANY TO ARRANGE FOR ELECTRICAL SERVICE CONNECTION.
- 12. CONTRACTOR MUST OBTAIN A LANE CLOSURE PERMIT FOM STATE HIGHWAY ADMINISTRATION, DISTRICT 1 TRAFFIC, A MINIMUM OF THREE (3) WORKING DAYS PRIOR TO PERFORMING ANY WORK ON A STATE OWNED ROADWAY.
- 13. THE CONTRACTOR SHALL REFER TO MDSHA STANDARD NO. 104.02-01 FOR WORK ASSOCIATED WITH LIGHT POLE INSTALLATION.
- 14. AS-BUILT LIGHTING INVENTORY DATA SHALL BE PROVIDED TO THE ADMINISTRATION IN ACCORDANCE WITH THE CONTRACT DOCUMENTS AT THE COMPLETION OF THE BURN TEST. LIGHTING SYSTEMS WILL NOT BE ACCEPTED FOR MAINTENANCE UNTIL AS-BUILT LIGHTING INVENTORY DATA HAS BEEN RECEIVED BY THE ADMINISTRATION.

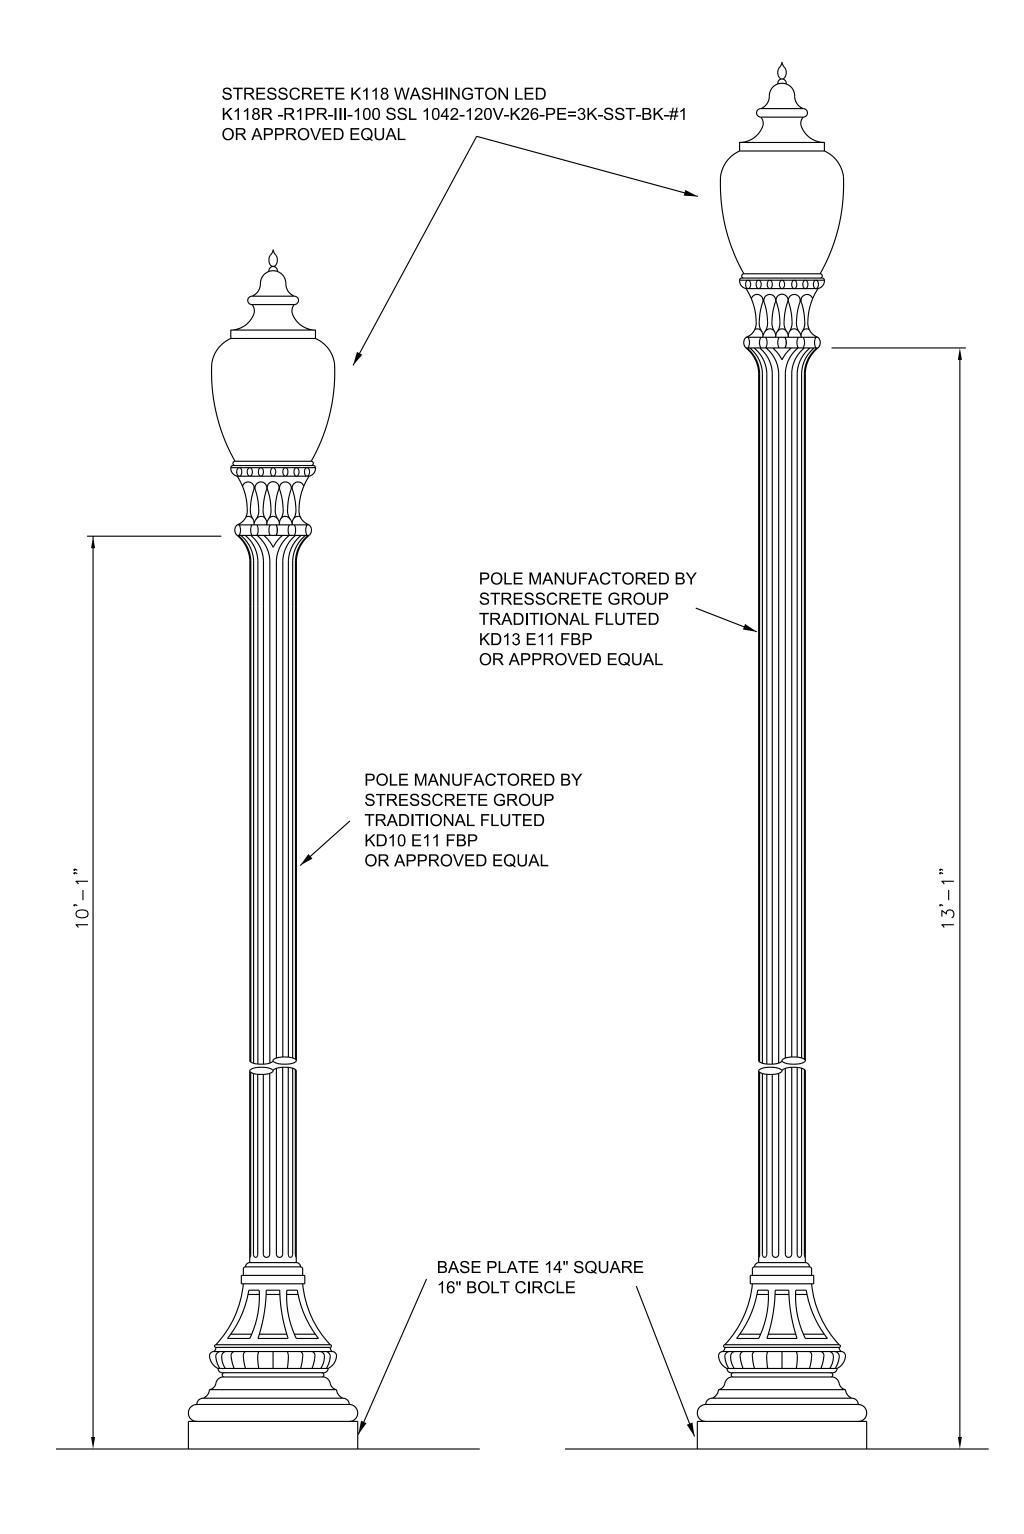

I D 00

PROFESSIONAL CERTIFICATION

I HEREBY CERTIFY THAT THESE DOCUMENTS WERE PREPARED OR APPROVED BY ME, AND THAT I AM A DULY LICENSED PROFESSIONAL ENGINEER UNDER THE LAWS OF THE STATE OF MARYLAND. LICENSE NO. 17172 EXPIRATION DATE 12-12-2022



OWNER/ADDRESS:
DEPARTMENT OF TRANSPORTATION
100 EDISON PARK DRIVE
GAITHERSBURG, MARYLAND

CONTACT:	
DIVISION OF TRANSPORTATION	ENGINEERING
CONSTRUCTION SECTION	
240-777-7210	
DESIGN SECTION	
240-777-7221	

REVISION

MONTGOMERY COUNTY
DEPARTMENT OF TRANSPORTATION GAITHERSBURG, MARYLAND

RECOMMENDED FOR APPROVAL

Chief, Design Section Date

APPROVED

Chief, Division of Transportation Engineering Date

Designed by: DHM III Drawn by: DHM III Checked by: DL

REHABILITATION OF BRIDGE NO. M-0229
ON BRIGHTON DAM ROAD
OVER BRIGHTON DAM

LIGHTING PLAN NOTES

Project No. : 0501907 SHEET 17 of 38

MODELNAME: \$MODELNAME\$

LP-03

2. THE CONTRACTOR MUST HAVE A CERTIFIED TRAFFIC CONTROL MANAGER ON SITE DURING ALL PHASES OF INSPECTION AND CONSTRUCTION AT ALL TIMES.

3. EACH PHASE OF INSPECTION AND CONSTRUCTION, INCLUDING THE FOLLOW UP RESTORATION OPERATIONS, SHALL BE PROVIDED WITH APPROPRIATE WORK ZONE TRAFFIC CONTROLS.

4. ANY WORK SHALL BE RESTRICTED TO THE HOURS LISTED IN THE SPECIFICATIONS, MONDAY THROUGH FRIDAY. WORK ON HOLIDAYS AND WEEKENDS SHALL NOT OCCUR UNLESS AN EXEMPTION IS GRANTED IN WRITING BY THE COUNTY'S INSPECTOR.

5. CONSTRUCTION ACTIVITY, LOADING OR UNLOADING OF EQUIPMENT SHALL NOT BLOCK ANY TRAFFIC LANE OTHER THAN THOSE DELINEATED WITHIN THE WORK ZONE.

6. EXCLUSIVE OF EMERGENCY WORK, THE CONTRACTOR SHALL CONTACT OCCUPANTS OF ALL ADJOINING PROPERTIES AND INFORM THEM OF THE SCOPE AND THE TIMING OF CONSTRUCTION A MINIMUM OF 24 HOURS NOTIFICATION SHALL BE REQUIRED PRIOR TO THE COMMENCEMENT OF ANY ACTIVITY ON THE SITE.

7. ACCESS SHALL BE MAINTAINED TO ALL DRIVEWAYS UNLESS PERMISSION FOR CLOSURE IS GRANTED BY THE PROPERTY OWNERMANAGER. HOWEVER, ACCESSIBILITY FOR EMERGENCY VEHICLES SHALL BE MAINTAINED AT ALL TIMES.

8. ALL TEMPORARY TRAFFIC CONTROL DEVICES SHALL CONFORM TO THE MOST RECENT EDITION OF THE 2011 MDMUTCD. ALL SIGNS, TRAFFIC DRUMS AND CONES SHALL BE FULLY REFLECTORIZED WITH HIGH INTENSITY, REFLECTIVE SHEETING AS PER THE MUTCD. TEMPORARY SIGNS SHALL BE FLUORESCENT ORANGE.

9. ALL WARNING SIGNS, UNLESS OTHERWISE SPECIFIED, SHALL BE A MINIMUM OF 48" X 48", BLACK SYMBOL OR LEGEND ON FLUORESCENT ORANGE BACKGROUND AND DIAMOND SHAPED. ALL WARNING SIGNS NOT APPLICABLE TO THE ACTUAL SITUATION SHALL BE REMOVED OR COVERED DURING NON-APPLICABLE PERIODS. ALL PORTABLE SIGNS SHALL BE MOUNTED A MINIMUM OF ONE (1) FOOT ABOVE THE LEVEL OF THE ROADWAY, WITH HIGHER MOUNTING HEIGHTS DESIRABLE.

10. THE CONTRACTOR SHALL MAINTAIN ALL EXISTING SIGNS IN GOOD CONDITION FOR THE DURATION OF THE PROJECT. ANY SIGNS THAT ARE DAMAGED BY THE CONTRACTOR'S CONSTRUCTION ACTIVITIES SHALL BE REPLACED AT THE CONTRACTOR'S EXPENSE.

11. THE CONTRACTOR SHALL COVER ANY ADVANCE WARNING SIGNS THAT ARE NOT APPLICABLE DURING NON-WORKING HOURS AND UNCOVER WHEN APPLICABLE.

12. THE CONTRACTOR WILL NOT BE ALLOWED TO REMOVE OR DAMAGE ANY EXISTING LANDSCAPING UNLESS NOTED IN THE PLANS, ANY DAMAGED LANDSCAPING NOT AUTHORIZED SHALL BE REPLACED AT THE CONTRACTOR'S EXPENSE.

13. IF ANY TEMPORARY TRAFFIC CONTROL SIGNS ARE TO BE PLACED ALONG A MDOT SHA ROADWAY OR WITHIN THE LIMITS OF AN INCORPORATED AREA, THE CONTRACTOR SHALL NOTIFY THE APPROPRIATE AGENCY OF SIGNAGE TO BE INSTALLED.

14. DURING NON-WORK HOURS, THE CONTRACTOR SHALL ENSURE THAT THE BRIDGE IS INACCESSIBLE TO VEHICULAR, PEDESTRIAN AND CYCLIST TRAFFIC.

15. THE CONTRACTOR SHALL OBTAIN A TEMPORARY NOISE WAIVER FROM THE MONTGOMERY COUNTY DEPARTMENT OF ENVIRONMENTAL PROTECTION FOR ALL NIGHTTIME CONSTRUCTION ACTIVITIES.

16. NO CONSTRUCTION VEHICLES SHAL BE ALLOWED IN RESIDENTIAL STREETS.

17. ALL STAKEHOLDERS SHALL BE NOTIFIED PRIOR TO ROAD CLOSURE/CONSTRCTION, ACCESS TO THE DRIVEWAY WEST OF THE BRIDGE SHALL BE MAINTAINED AT ALL TIMES DURING CONSTRUCTION. TEMPORARY CLOSURE OF DRIVEWAY SHALL BE COORDINATED WITH THE PROJECT ENGINEER.

18. FINAL VARIABLE MESSGE SIGN(S) MESSAGES ARE TO BE DETERMINED BY THE PROJECT ENGINEER.

19. PVMS SHALL REMAIN IN STRATEGIC LOCATIONS DURING ROAD CLOSURE/CONSTRUCTION WITH ADVANCE WARNING. MESSAGE TO MOTORISTS.

20. FIXED BARRICADES SHALL EXTEND THE FULL WIDTH OF THE ROADWAY CLOSURE POINTS AND SHALL HAVE FLASHING WARNING LIGHTS.

21. TRAFFIC CONTROL DEVICES MUST BE IN COMPLIANCE WITH THE LATEST EDITION OF THE MD MUTCD AND THE MD SHA BOOK OF STANDARDS.

22. ALL WARNING SIGNS NOT IN USE SHALL BE FULLY COVERED WITH OPAQUE MATERIAL.

INSPECTOR AUTHORITY

1. THE COUNTY'S DEPARTMENT OF PERMITTING SERVICES (DPS) INSPECTOR HAS THE AUTHORITY TO MODIFY THE TTCP AS DEEMED NECESSARY. THE INSPECTOR HAS THE AUTHORITY TO ORDER THE CONTRACTOR TO STOP WORK AND VACATE THE PUBLIC RIGHT-OF-WAY IF THE TTCP IS NOT COMPLIED WITH.

2. THE IMPLEMENTATION DATE AND CONTINUANCE OF WORK ACTIVITIES MAY BE ALTERED AT THE DISCRETION OF THE COUNTY'S INSPECTOR IN THE EVENT OF CONFLICTS WITH PREVIOUSLY APPROVED OR EMERGENCY ACTIVITIES.

MISCELLANEOUS

1. HAZARDOUS MATERIALS SHALL NOT BE STORED WITHIN PUBLIC RIGHT-OF-WAY. NO MATERIALS OR EQUIPMENT SHALL BE STORED ON THE ROADWAY SURFACE OR SIDEWALK DURING NON-WORK PERIODS. ALL STORED MATERIALS AND EQUIPMENT SHALL BE SET BACK AT LEAST SIX (6) FEET BEHIND THE CURB ALONG A CLOSED SECTION ROADWAY AND AT LEAST TWELVE (12) FEET FROM THE EDGE OF AN OPEN SECTION ROADWAY.

2. AT THE COMPLETION OF WORK ACTIVITIES, CONDITIONS WITHIN THE PUBLIC SPACE SHALL BE FULLY RESTORED TO THOSE THAT EXISTED PRIOR TO THE WORK ACTIVITY.

CONTACT INFORMATION

1. THE PROJECT MANAGER AND CONTRACTOR SHALL COORDINATE WITH HOWARD COUNTY DPW - PUBLIC INFORMATION OFFICE AT 410-313-3440 AT LEAST THREE WEEKS PRIOR TO PROJECT START TO ADVISE OF PROPOSED DETOUR.

2. THE CONTRACTOR SHALL ARRANGE AND HOST A PRE-PHASE TRAFFIC SWITCH MEETING AT LEAST TWO WEEKS PRIOR TO SWITCHING TRAFFIC. THE FOLLOWING OFFICES SHALL BE NOTIFIED OF THIS MEETING AND OF THE IMPENDING TRAFFIC SWITCH:

* MONTGOMERY COUNTY DIVISION OF TRAFFIC ENGINEERING AND OPERATIONS AT 240-777-6000

* MONTGOMERY COUNTY TRANSPORTATION SYSTEMS ENGINEEERING TEAM AT 240-777-2100

* MONTGOMERY COUNTY FIRE AND RESCUE, LOCAL FIRE DEPARTMENT CAPTAIN

* MONTGOMERY COUNTY POLICE, LOCAL TRAFFIC SERGEANT * MONTGOMERY COUNTY DEPARTMENT OF PERMITTING SERVICES, PERMIT INSPECTION SECTION AT 240-777-6300

* HOWARD COUNTY TRAFFIC ENGINEERING DIVISION AT 410-313-2430

* HOWARD COUNTY PUBLIC SCHOOLS, LOCAL DEPOT MANAGER * HOWARD COUNTY POLICE, LOCAL SERGEANT

* HOWARD COUNTY FIRE AND RESCUE, LOCAL FIRE DEPARTMENT CAPTAIN

3. PRIOR TO ROAD CLOSURES, THE CONTRACTOR SHALL NOTIFY THE FOLLOWING OFFICES A MINIMUM OF SEVENTY-TWO (72) HOURS IN ADVANCE:

* MONTGOMERY COUNTY DIVISION OF TRAFFIC ENGINEERING AND OPERATIONS AT 240-777-6000

* MONTGOMERY COUNTY EMERGENCY OPERATIONS CENTER AT 240-777-0751

* MONTGOMERY COUNTY POLICE, LOCAL TRAFFIC SERGEANT

* MONTGOMERY COUNTY TRANSPORTATION MANAGEMENT CENTER AT 240-777-2100

* MONTGOMERY COUNTY FIRE AND RESCUE, LOCAL FIRE DEPARTMENT CAPTAIN

* HOWARD COUNTY TRAFFIC ENGINEERING DIVISION AT 410-313-2430 * HOWARD COUNTY EMERGENCY SERVICE BUREAU AT 410-313-6000

* HOWARD COUNTY PUBLIC SCHOOLS, LOCAL DEPOT MANAGER

* HOWARD COUNTY POLICE, LOCAL SERGEANT

* HOWARD COUNTY FIRE AND RESCUE, LOCAL FIRE DEPARTMENT CAPTAIN

4. FIELD ASSISTANCE BY THE MCDOT. DIVISION OF TRAFFIC ENGINEERING AND OPERATIONS IS AVAILABLE UPON REQUEST. CONTACT TRAFFIC ENGINEERING & OPERATIONS SECTION AT 240-777-6000.

SEQUENCE OF CONSTRUCTION FOR MAINTENANCE OF TRAFFIC

1. INSTALL MAINTENANCE OF TRAFFIC CONTROL DEVICES FOR FLAGGING OPERATIONS FOR CONSTRUCTION OF PERMANENT TURNAROUND ON EAST END OF THE DAM.

2. CONSTRUCT PERMANENT TURNAROUND ON EAST END OF THE DAM.

3. INSTALL PORTABLE VARIABLE MESSAGE SIGN (PVMS) 2 WEEKS BEFORE ROAD CLOSURE IN ACCORDANCE WITH MD STD 104.01-22.

4. INSTALL MAINTENANCE OF TRAFFIC CONTROL DEVICES FOR DETOUR AND CLOSE BRIGHTON DAM ROAD. ADJUST ALL PVMS TO LOCATION AS DETERMINED BY THE ENGINEER.

5. CONSTRUCT IMPROVEMENTS FOR ROADWAY AND BRIDGE.

6. AFTER COMPLETING THE CONSTRUCTION OF THE ROADWAY AND BRIDGE, REMOVE MAINTENANCE OF TRAFFIC CONTROL DEVICES AND OPEN BRIGHTON DAM ROAD.

MT-01

PROFESSIONAL CERTIFICATION

I HEREBY CERTIFY THAT THESE DOCUMENTS WERE PREPARED OR APPROVED BY ME, AND THAT I AM A DULY LICENSED PROFESSIONAL ENGINEER UNDER THE LAWS OF THE STATE OF MARYLAND. LICENSE NO. <u>17172</u> EXPIRATION DATE <u>12-12-2022</u>



240-777-7221


OWNER/ADDRESS: DEPARTMENT OF TRANSPORTATION 100 EDISON PARK DRIVE GAITHERSBURG, MARYLAND			MONTGOMERY COUNTY DEPARTMENT OF TRANSPORTA GAITHERSBURG, MARYLAND
			RECOMMENDED FOR APPROVAL
<u>CONTACT:</u> DIVISION OF TRANSPORTATION ENGINEERING CONSTRUCTION SECTION			Chief, Design Section APPROVED
240-777-7210 DESIGN SECTION			Chief, Division of Transportation Engineering

TATION Date Checked by: RM

REHABILITATION OF BRIDGE NO. M-0229 ON BRIGHTON DAM ROAD OVER BRIGHTON DAM

> MAINTENANCE OF TRAFFIC NOTES

of 38 0501907 Project No. :

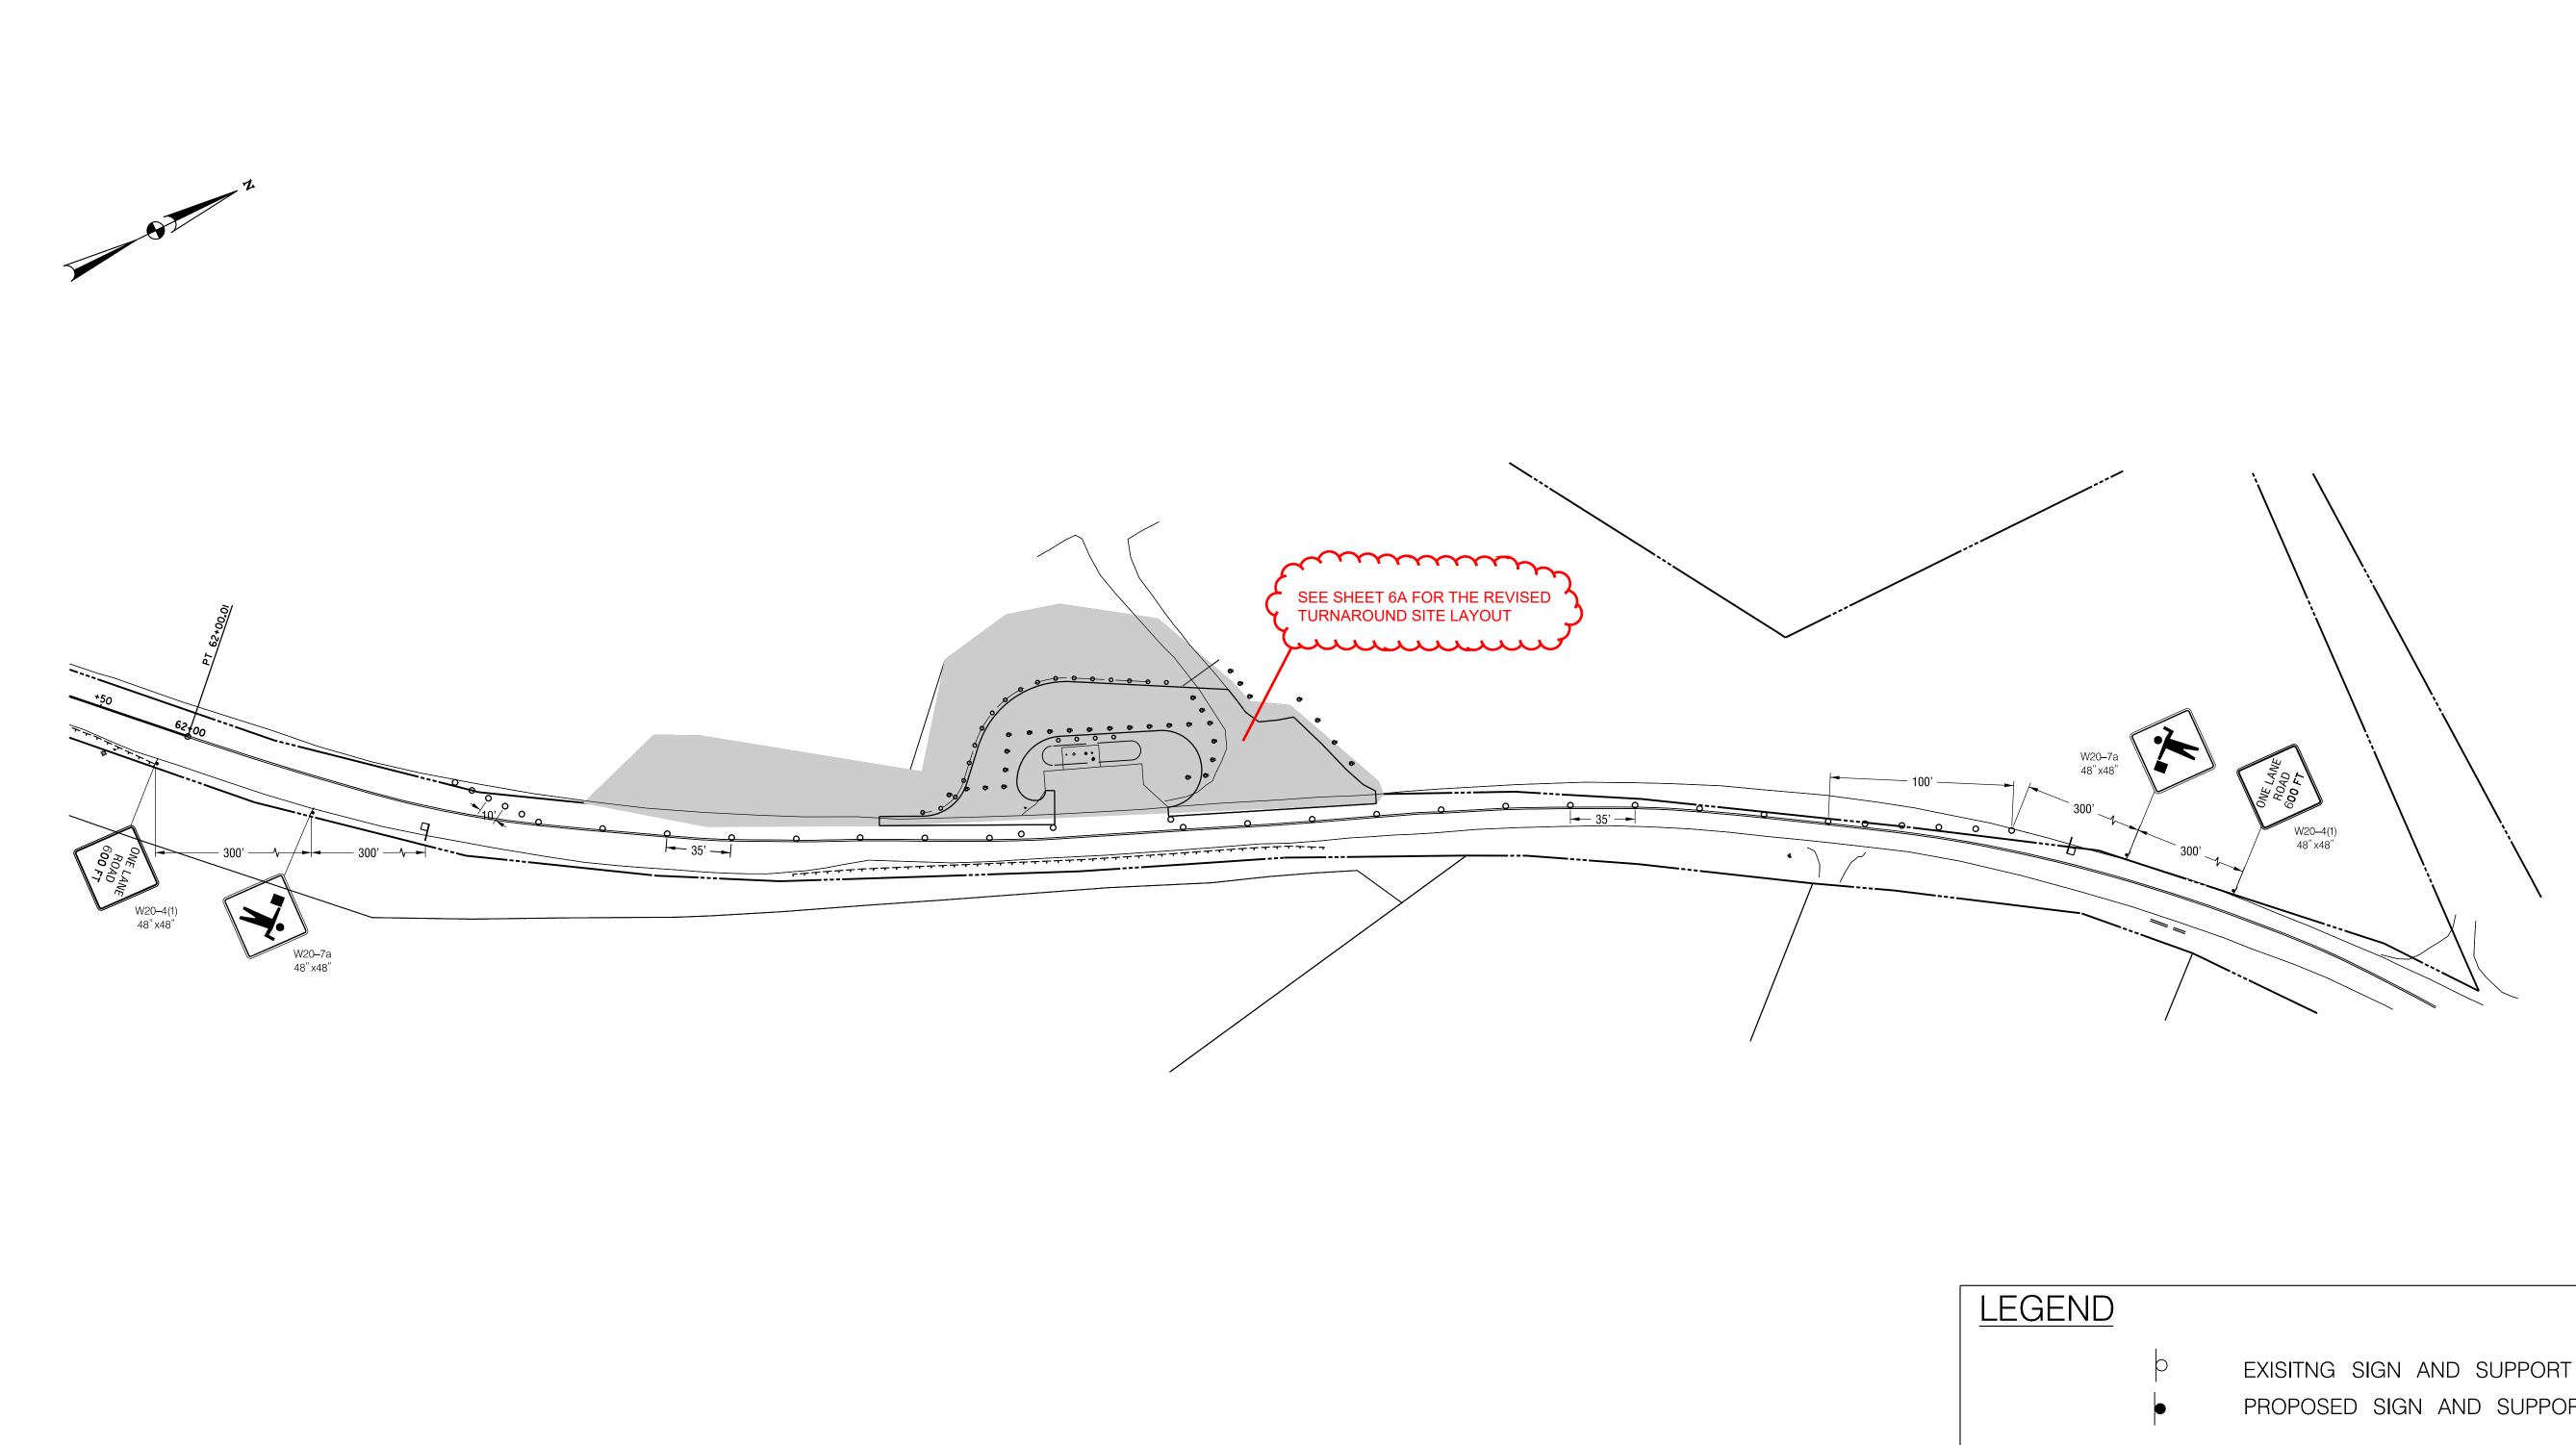


EXISITNG SIGN AND SUPPORT PROPOSED SIGN AND SUPPORT EX. RIGHT OF WAY DRUMS FLAGGER

MT-02

PROFESSIONAL CERTIFICATION

I HEREBY CERTIFY THAT THESE DOCUMENTS WERE PREPARED OR APPROVED BY ME, AND THAT I AM A DULY LICENSED PROFESSIONAL ENGINEER UNDER THE LAWS OF THE STATE OF MARYLAND. LICENSE NO. 17172 EXPIRATION DATE 12-12-2022

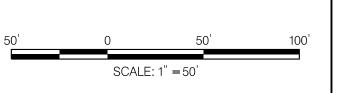

Stantec

OWNER/ADDRESS:	
DEPARTMENT OF TRANSPORTATION	
100 EDISON PARK DRIVE	
GAITHERSBURG, MARYLAND	

CONTACT:
DIVISION OF TRANSPORTATION ENGINEERING
CONSTRUCTION SECTION
240-777-7210
DESIGN SECTION
240-777-7221

	MONTGOMERY COUNTY
	DEPARTMENT OF TRANSPORTATION
	GAITHERSBURG, MARYLAND
	RECOMMENDED FOR APPROVAL

DATE


REVISION

RECOMMENDED	FOR APPROV	/AL	
Chief, Design S	Section		Date
	- f T	ation Engineering	

REHABILITATION OF BRIDGE NO. M-0229
ON BRIGHTON DAM ROAD
OVER BRIGHTON DAM

MAINTENANCE OF TRAFFIC NOTES

Project No. : 0501907 SHEET 19 of 38

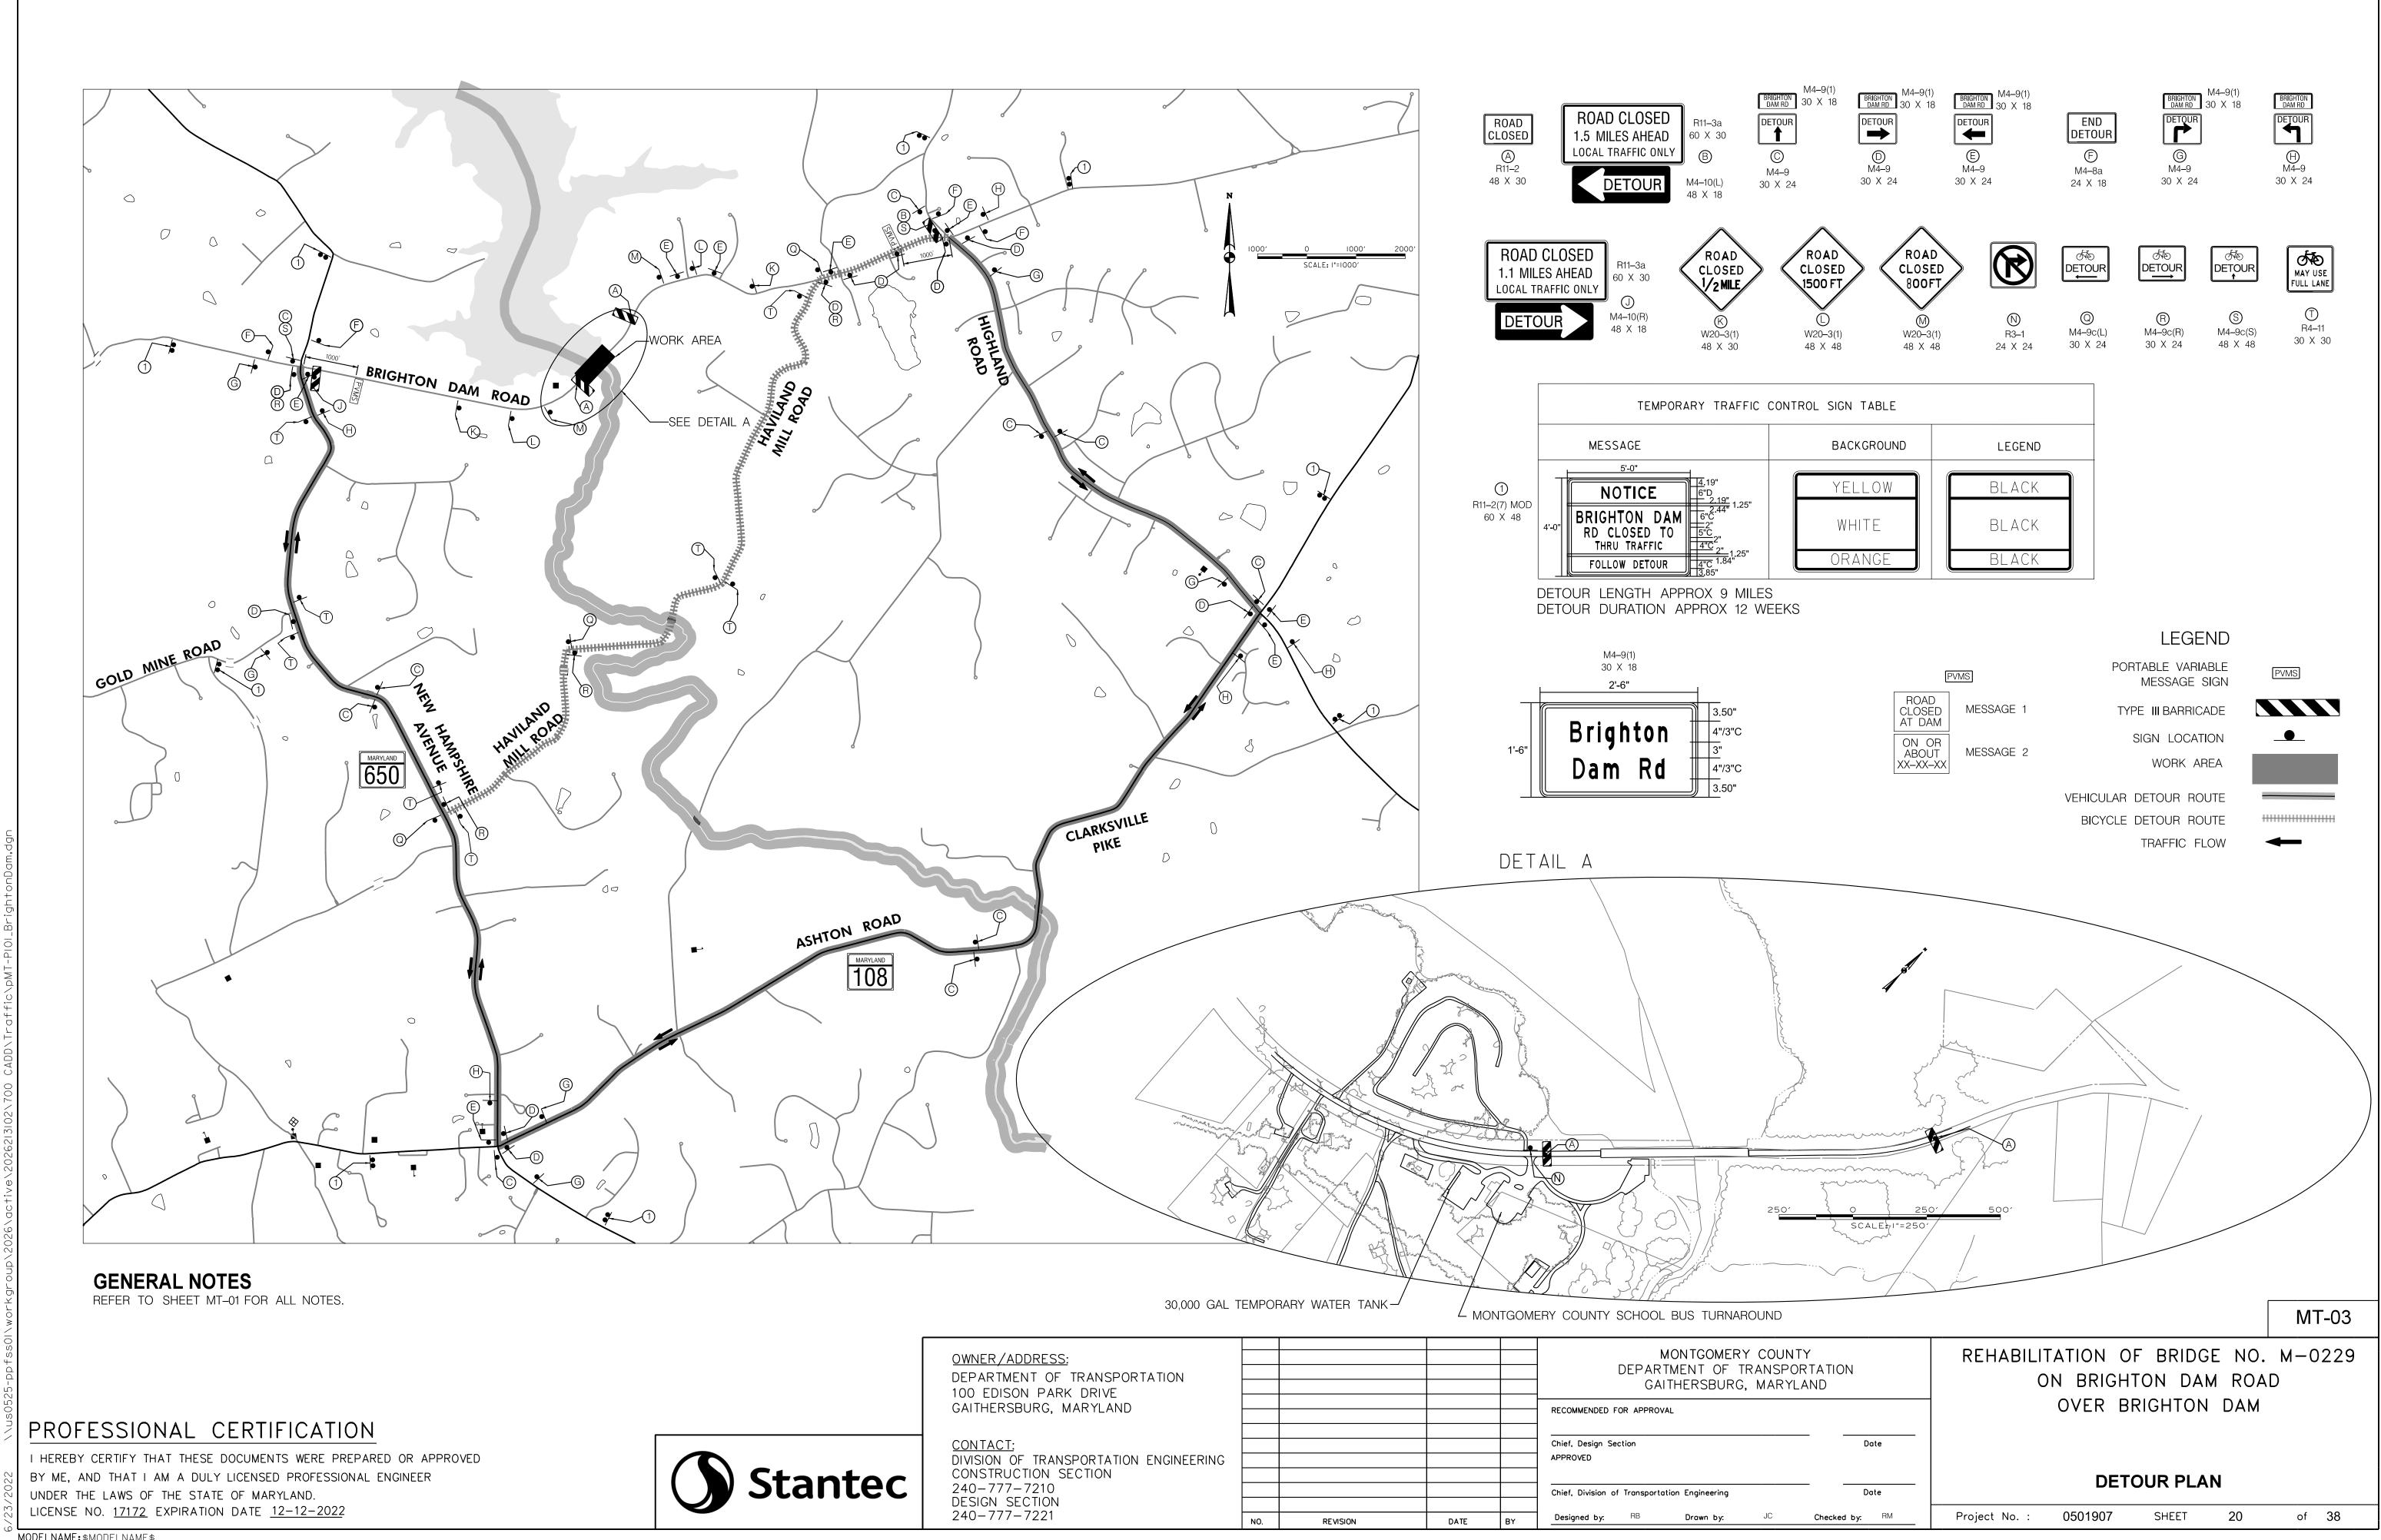

STANDARDS AND SPECIFICATIONS:

MARYLAND DEPARTMENT OF TRANSPORTATION STATE HIGHWAY ADMINISTRATION'S "STANDARD SPECIFICATIONS FOR CONSTRUCTION AND MATERIALS", DATED 2021 AND ALL REVISIONS THEREOF AND

ADDITIONS THERETO.

THE LATEST "MARYLAND MANUAL ON UNIFORM TRAFFIC CONTROL DEVICES" (MD MUTCD) FROM MDOT STATE HIGHWAY ADMINISTRATION.

AASHTO LRFD BRIDGE DESIGN SPECIFICATIONS 9TH EDITION, 2020

PERFORM WELDING IN ACCORDANCE WITH AASHTO/AWS/DI.5:2010 BRIDGE WELDING CODE, 6TH EDITION, WITH 2020 SHA STANDARD

SPECIFICATIONS

MATERIAL:

REINFORCING STEEL SHALL CONFORM TO ASTM A615 GRADE 60. ONLY GRADE 60 CAN BE USED ON THE PROJECT. ALL

REINFORCING STEEL SHALL BE EPOXY COATED.

FOR REPAIRING SPALLS AND CRACKS, SEE SPECIAL PROVISION 400.01 & 400.02. ALL MATERIALS AND SOURCE OF SUPPLY SHALL BE SUBMITTED TO THE ENGINEER FOR APPROVAL PRIOR TO

COMMENCING WORK.

EXISTING UTILITIES:

WHERE WORK AFFECTS OR IS AFFECTED BY EXISTING UTILITIES, THE WORK SHALL BE CORRDINATED WITH THAT UTILITY COMPANY. IT WILL BE THE CONTRACTOR'S RESPONSIBILITY TO CONTACT ALL UTILITY COMPANIES THAT MAY HAVE INSTALLATIONS IN THE WORK AREA PRIOR TO BEGINNING WORK. THE CONTRACTOR SHALL SCOUT AND NOTIFY THE ENGINEER 90 DAYS IN ADVANCE OF ANY WORK REQUIRING THE TEMPORARY RELOCATION OF THIRD PARTY UTILITY.

REPAIRS

APPROXIMATE LOCATIONS ARE SHOWN IN THE REPAIR WORK SCHEDULE TABLES. THESE LOCATIONS ARE FOR INFORMATIONAL PURPOSES ONLY AND MAY NOT BE EXACT. IF ADDITIONAL REPAIR LOCATIONS ARE FOUND, THEY SHOULD BE INCLUDED IN THIS CONTRACT WITH THE APPROVAL OF THE ENGINEER.

THE CONTRACTOR SHALL VERIFY ALL DIMENSIONS, QUANTITIES AND REPAIR LOCATIONS IN THE FIELD PRIOR TO ORDERING MATERIALS, AND NOTIFY THE ENGINEER OF ANY DISCREPANCIES OR CONFLICTS WITH THE DETAILS.

DAMAGE TO EXISTING FACILITIES AND STRUCTURES AS A RESULT OF THE CONTRACTOR'S WORK OR METHOD OF OPERATIONS SHALL BE REPAIRED BY CONTRACTOR AT NO ADDITIONAL COST TO THE COUNTY.

CLEAN EXPOSED MILD STEEL REINFORCEMENT IN ACCORDANCE WITH SHA STANDARD SPECIFICATION SECTION 423.03.04. COAT EXISTING REINFORCING STEEL WITH APPROVED EPOXY. PROTECT CONCRETE WITH TAPE, PLASTIC, ETC. PRIOR TO APPLYING COATING AS NEEDED. ANY EPOXY MATERIAL ON ADJACENT CONCRETE SHALL BE REMOVED TO THE SATISFACTION OF THE ENGINEER.

ALL CONSTRUCTION SHALL BE ACCOMPLISHED WITHIN EXISTING RIGHT OF WAY OR EASEMENTS OBTAINED BY COUNTY OR THE

CONTRACTOR.

SALVAGE DEBRIS:

SALVAGED STEEL AND OTHER DEBRIS SHALL BECOME THE PROPERTY OF THE CONTRACTOR. THE CONTRACTOR SHALL BE RESPONSIBLE FOR DISPOSING OF ALL DEBRIS IN CONFORMANCE WITH ALL APPLICABLE REQUIREMENTS AND REGULATIONS. THE COST FOR DISPOSING OF SALVAGED STEEL AND OTHER DEBRIS WILL BE INCIDENTAL TO THE CONTRACT.

AS-BUILT INFORMATION: A MAJORITY OF THE INFORMATION FOR THE EXISTING STRUCTURES IN THE FOLLOWING PLANS IS FROM THE 2000 AS-BUILT PLANS. THE DETAILS SHOWN IN THESE PLANS MAY NOT BE TO SCALE. THIS INFORMATION SHALL BE FIELD VERIFIED BY THE

CONTRACTIOR.

REPAIR WORK SCHEDULE DESCRIPTION LOCATION TYPE ODD NUMBERED DRAINAGE TROUGH BUTTRESSES ABOVE INSTALLATION DAM GATES AND STAIRS CONCRETE CRACK BEAMS, PARAPETS, AND REPAIR ABUTMENT BACKWALLS CONCRETE SPALL BEAMS. PARAPETS. DECK. REPAIR AND ABUTMENT BACKWALLS APPLY CONCRETE ALL DECK, CURB, AND CRACK SEALER SIDEWALK AREAS PARAPETS WITHOUT TYPE I PARAPET REPAIR SPALLING ON PILASTERS TYPE 2 PARAPET PARAPETS WITH 6 REPAIR SPALLING ON PILASTERS TYPE 3 PARAPET PILASTERS WITH REPAIR LIGHT POLE TYPE 4 PARAPET PILASTERS WITH LIGHT REPAIR POLE AND FENCE JOINT SEAL ODD NUMBERED REPLACEMENT BUTTRESSES BUTTRESS NO. II DOWNSPOUT INSTALLATION

PROFESSIONAL CERTIFICATION

I HEREBY CERTIFY THAT THESE DOCUMENTS WERE PREPARED OR APPROVED BY ME, AND THAT I AM A DULY LICENSED PROFESSIONAL ENGINEER UNDER THE LAWS OF THE STATE OF MARYLAND. LICENSE NO. <u>38931</u> EXPIRATION DATE <u>12-22-2023</u>



OWNER/ADDRESS: DEPARTMENT OF TRANSPORTATION 100 EDISON PARK DRIVE GAITHERSBURG, MARYLAND

CONTACT: DIVISION OF TRANSPORTATION ENGINEERING CONSTRUCTION SECTION 240-777-7210 DESIGN SECTION 240-777-7221

				MONTGOMERY COUNTY DEPARTMENT OF TRANSPORTATION GAITHERSBURG, MARYLAND	RE
				RECOMMENDED FOR APPROVAL	
				Chief, Design Section Date	
				APPROVED	
				Chief, Division of Transportation Engineering Date	
NO	PEVISION	DATE	RY	Designed by: TK Drawn by: ZK Checked by: MWM	Proje

S-01

REHABILITATION OF BRIDGE NO. M-0229 ON BRIGHTON DAM ROAD OVER


GENERAL NOTES

of 38

BRIGHTON DAM

0501907 SHEET 21 oject No. :

SCALE: I" = 30'-0"

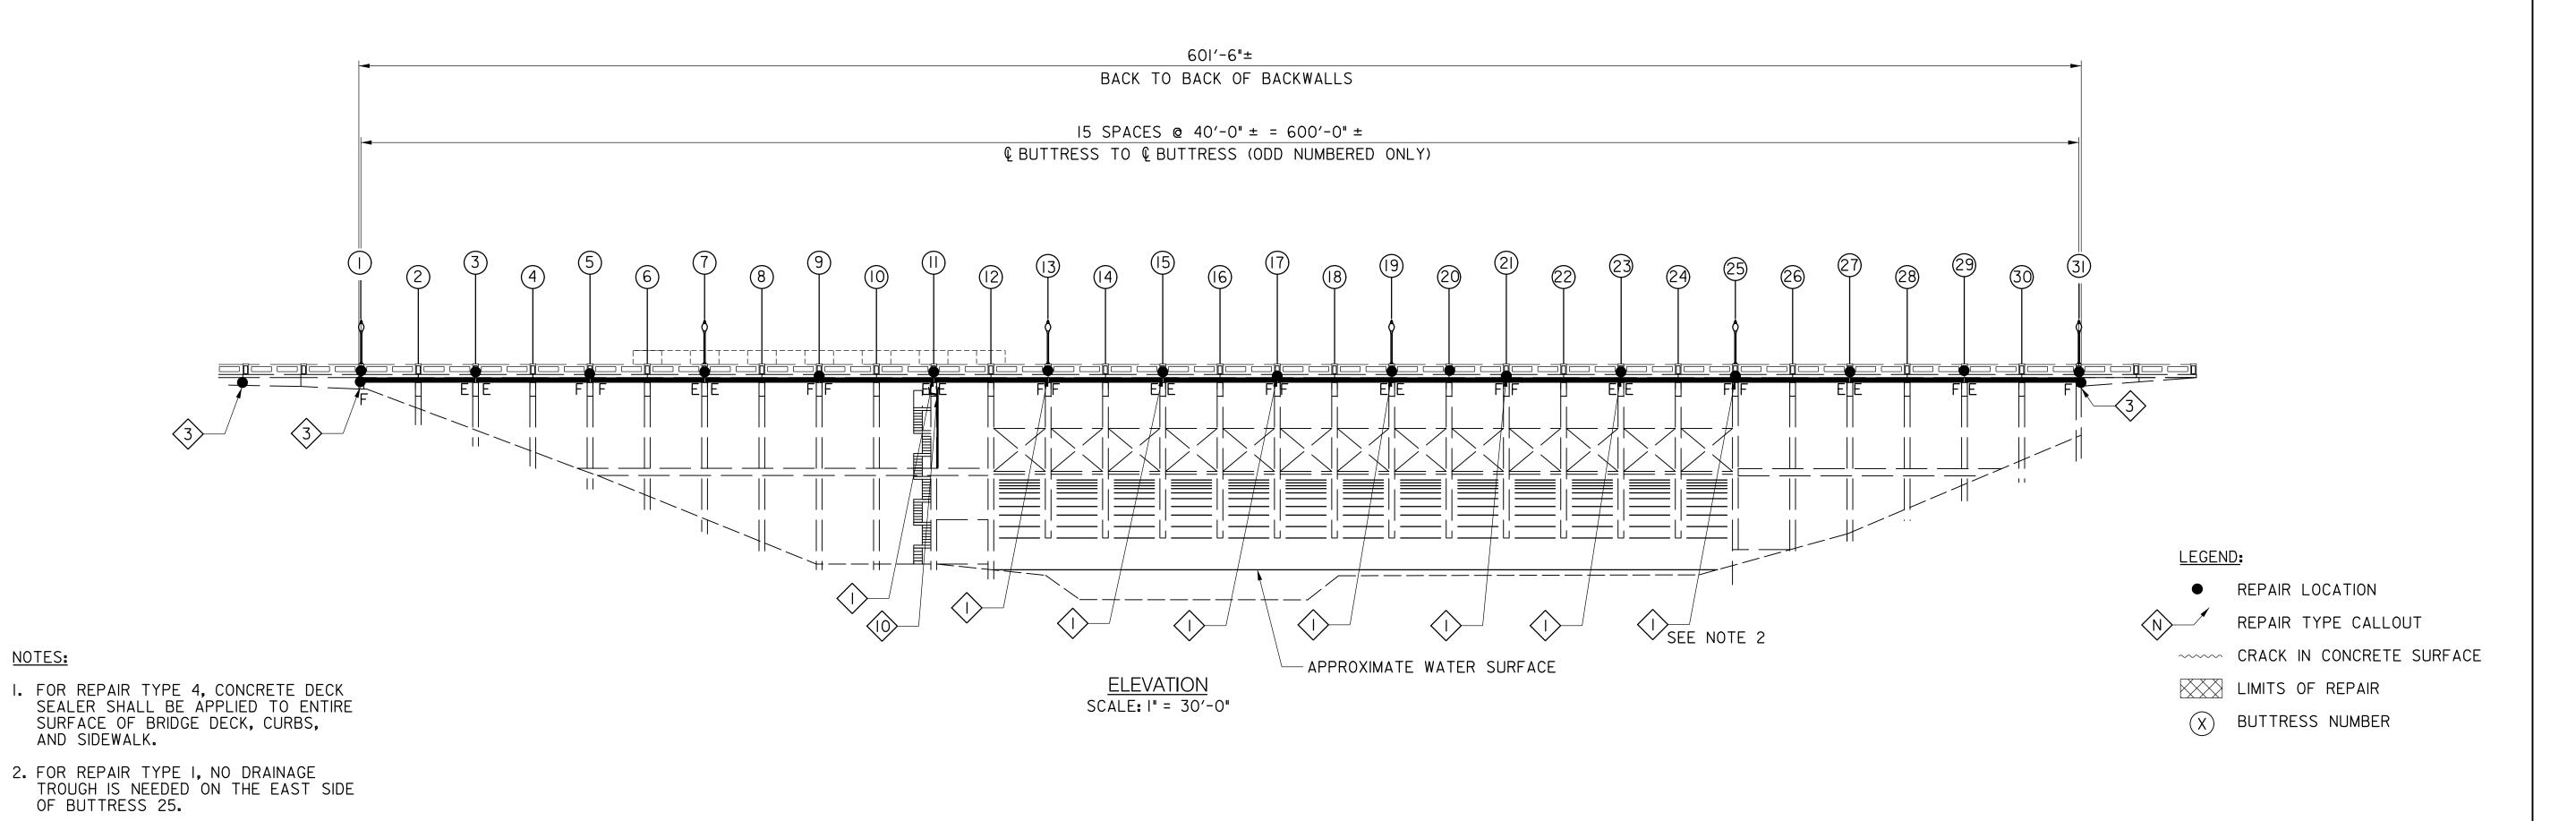

PROFESSIONAL CERTIFICATION

I HEREBY CERTIFY THAT THESE DOCUMENTS WERE PREPARED OR APPROVED BY ME, AND THAT I AM A DULY LICENSED PROFESSIONAL ENGINEER UNDER THE LAWS OF THE STATE OF MARYLAND. LICENSE NO. <u>38931</u> EXPIRATION DATE <u>12-22-2023</u>



OWNER/ADDRESS: DEPARTMENT OF TRANSPORTATION 100 EDISON PARK DRIVE GAITHERSBURG, MARYLAND

CONTACT: DIVISION OF TRANSPORTATION ENGINEERING CONSTRUCTION SECTION
240-777-7210
DESIGN SECTION 240-777-7221


				MONTGOMERY COUNTY DEPARTMENT OF TRANSPOR GAITHERSBURG, MARYLA	TATION	RE
				RECOMMENDED FOR APPROVAL		
				Chief, Design Section APPROVED	Date	
				Chief, Division of Transportation Engineering	Date	
NO.	REVISION	DATE	BY	Designed by: TK Drawn by: ZK	Checked by: MWM	Proje

REHABILITATION OF BRIDGE NO. M-0229ON BRIGHTON DAM ROAD OVER BRIGHTON DAM


S-02


GENERAL PLAN AND ELEVATION


SHEET 22 roject No. : 0501907 of 38

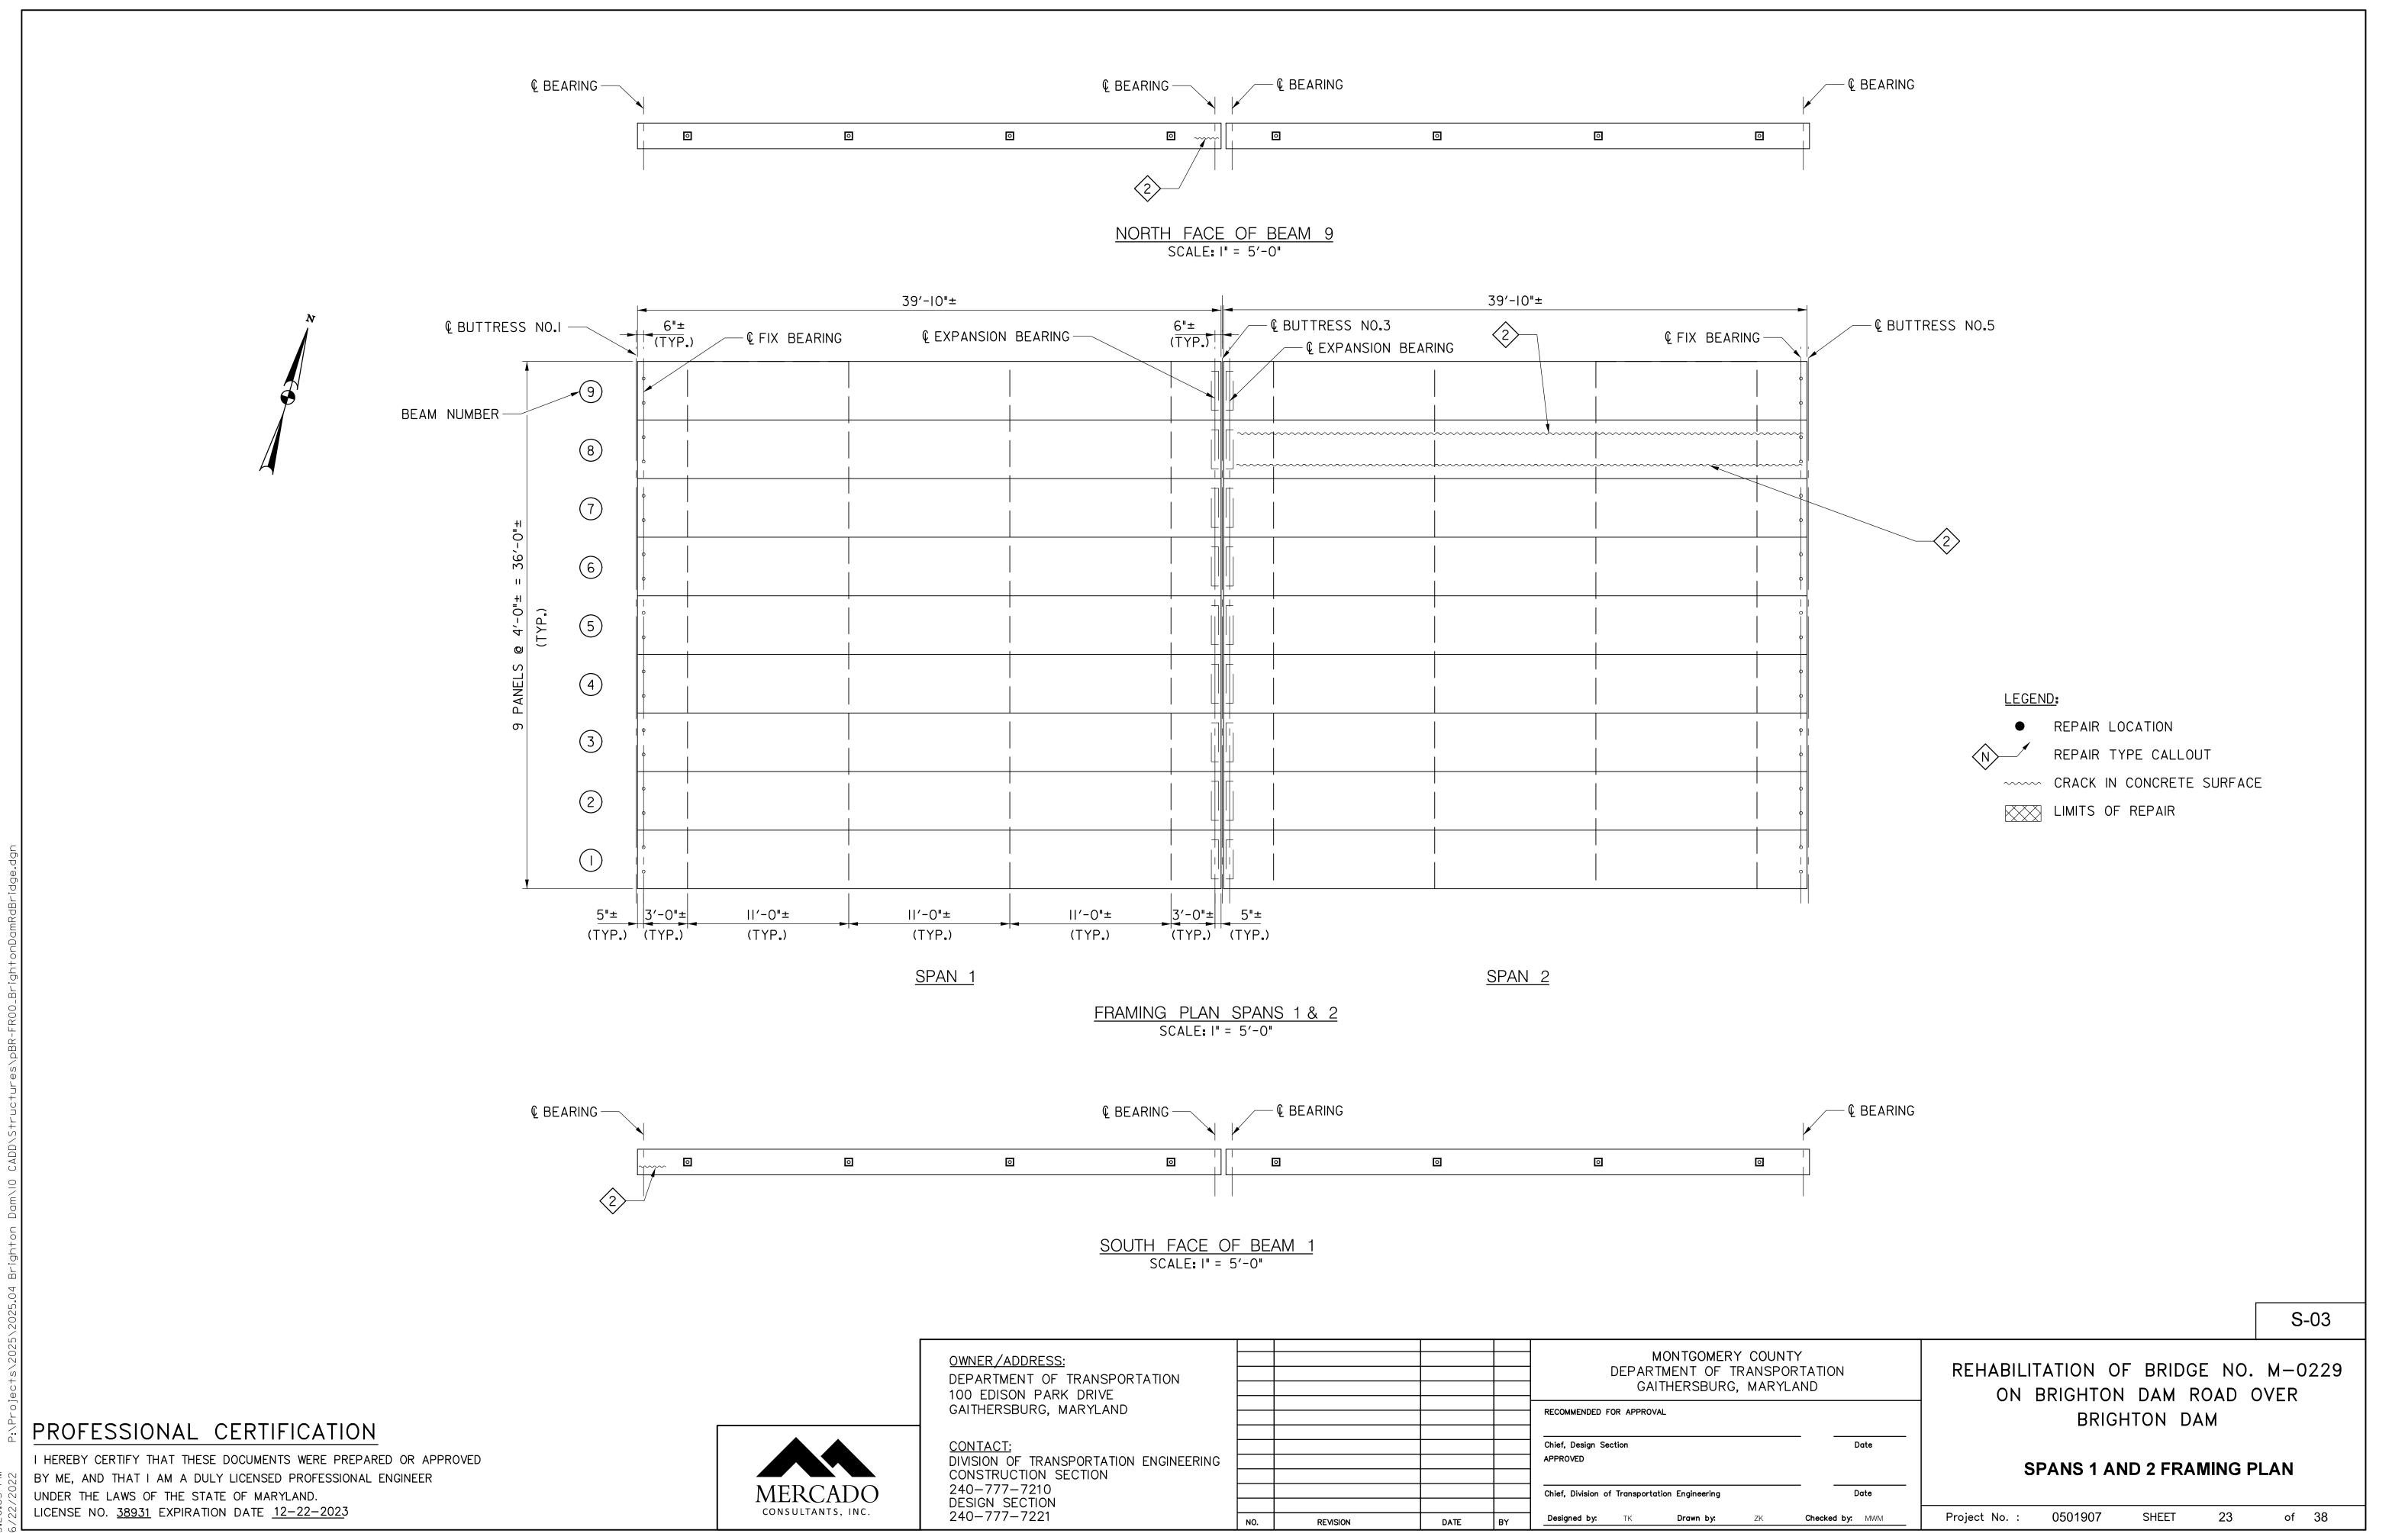

3,20.05 PM

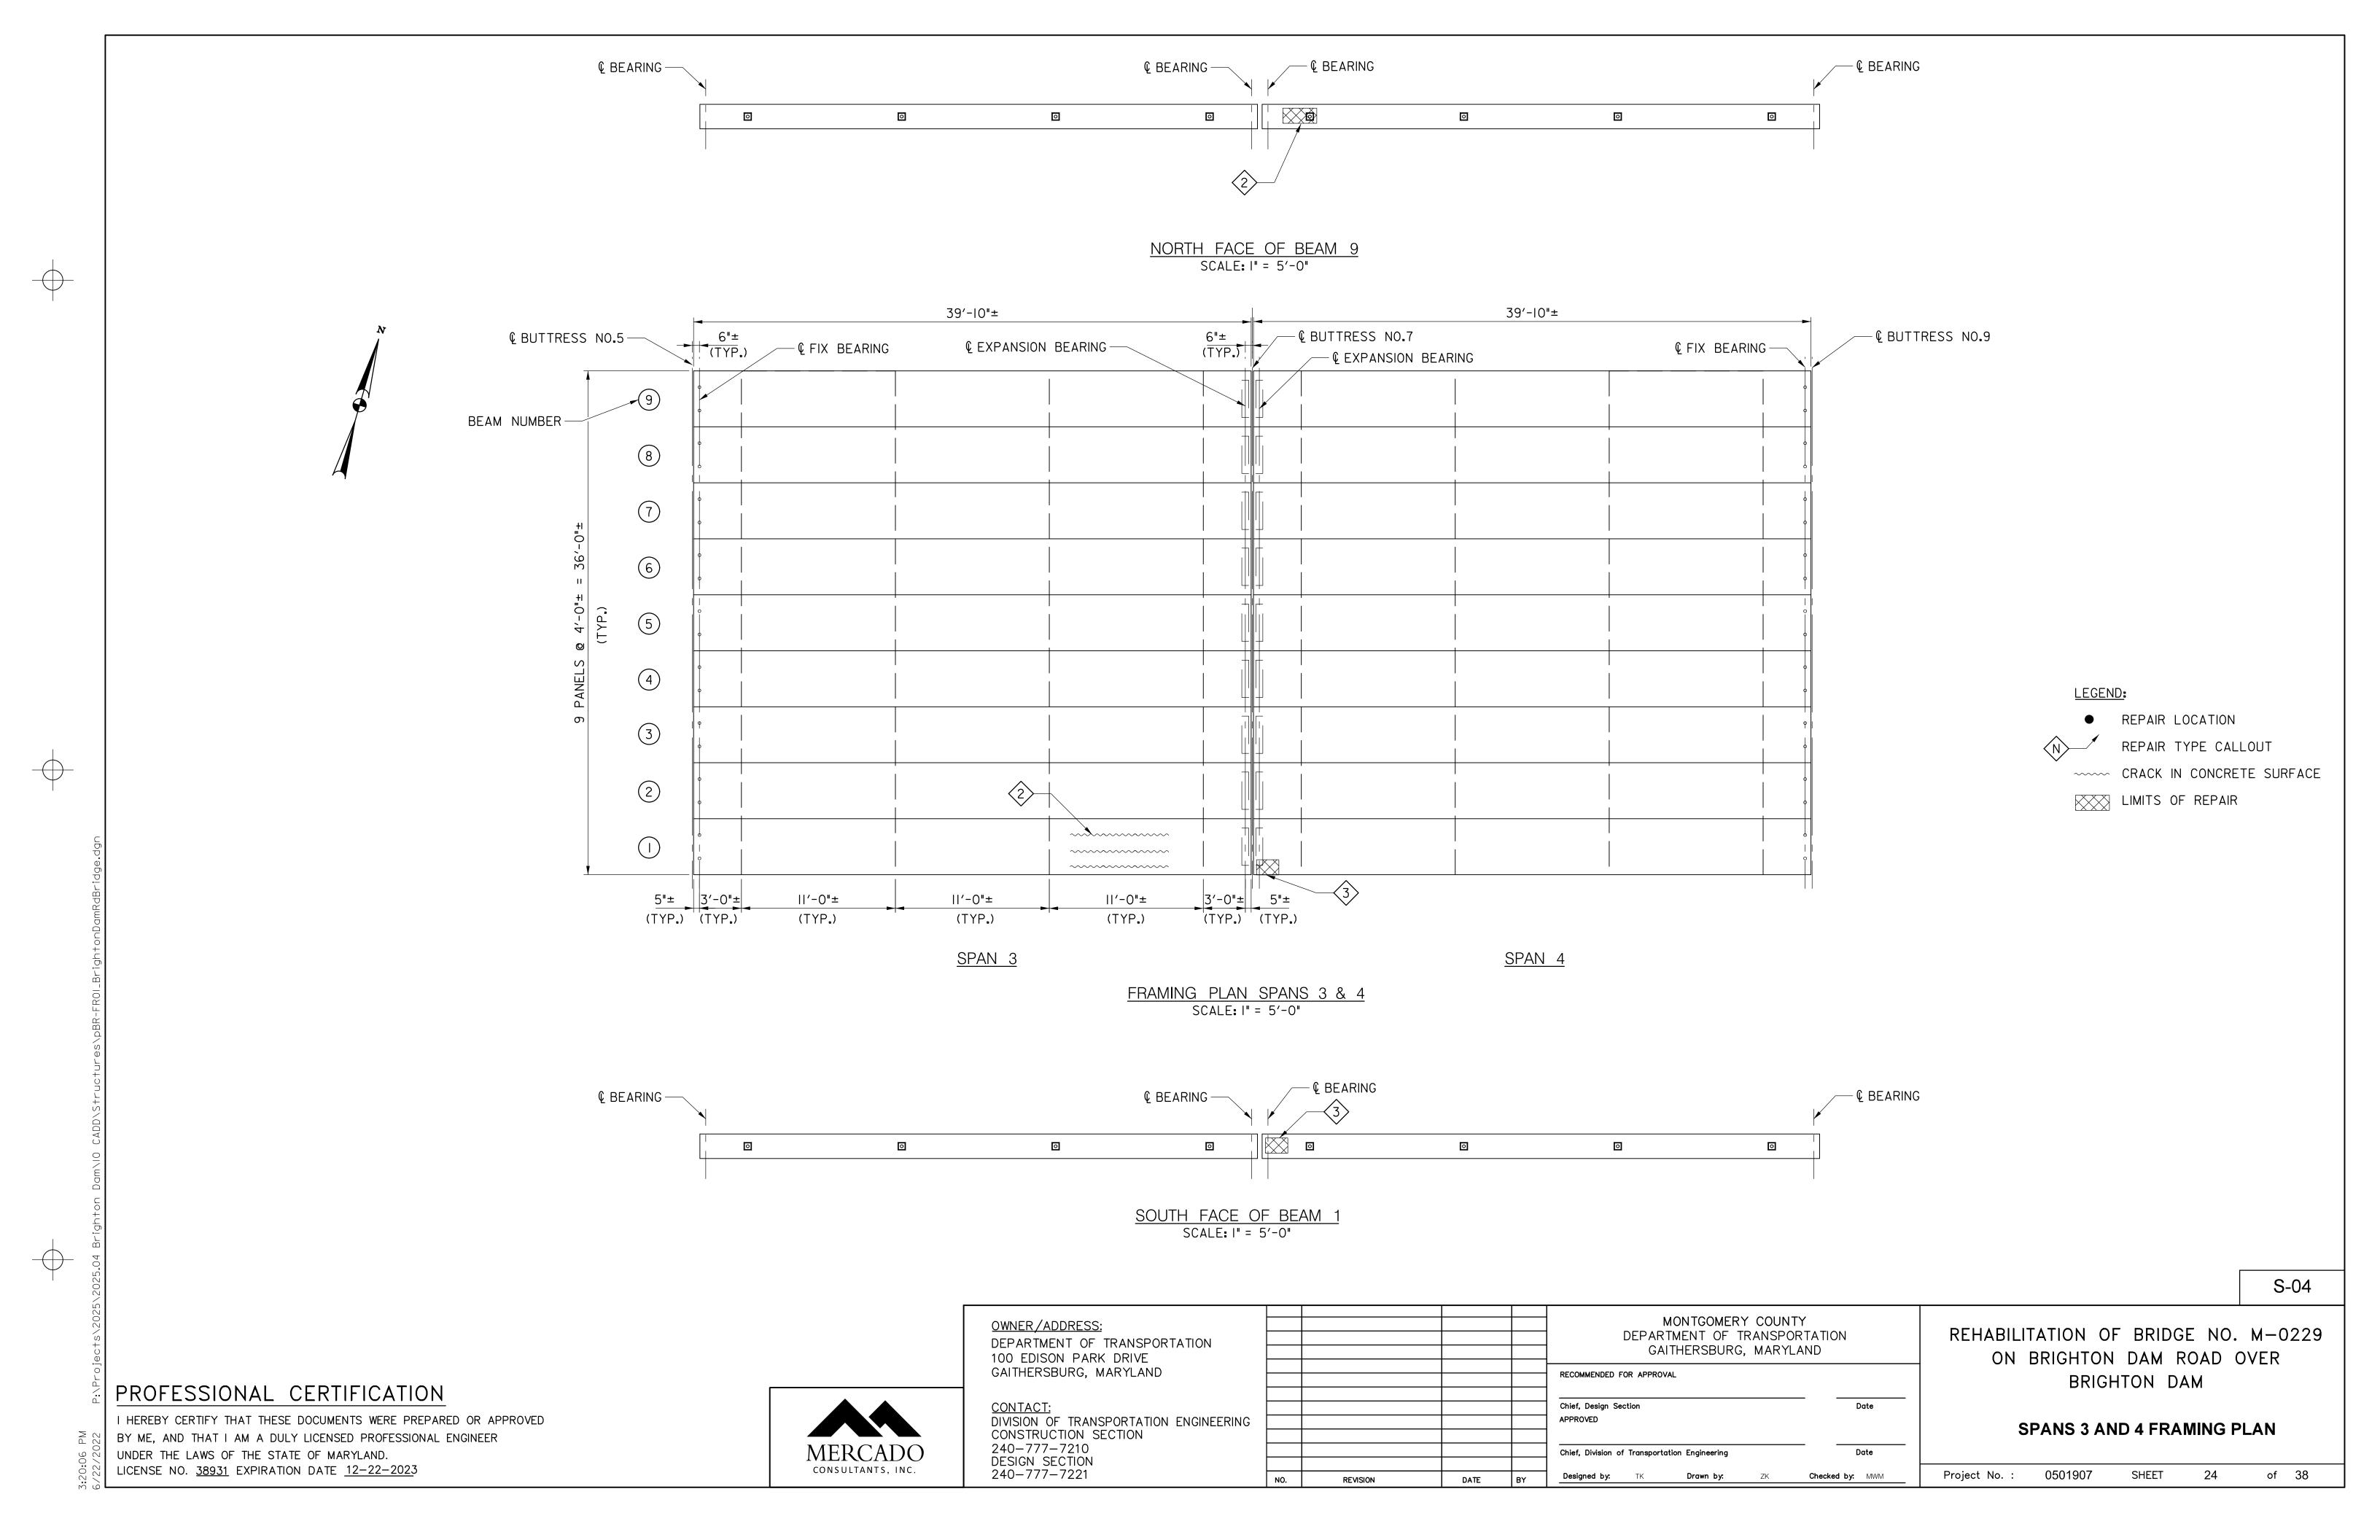

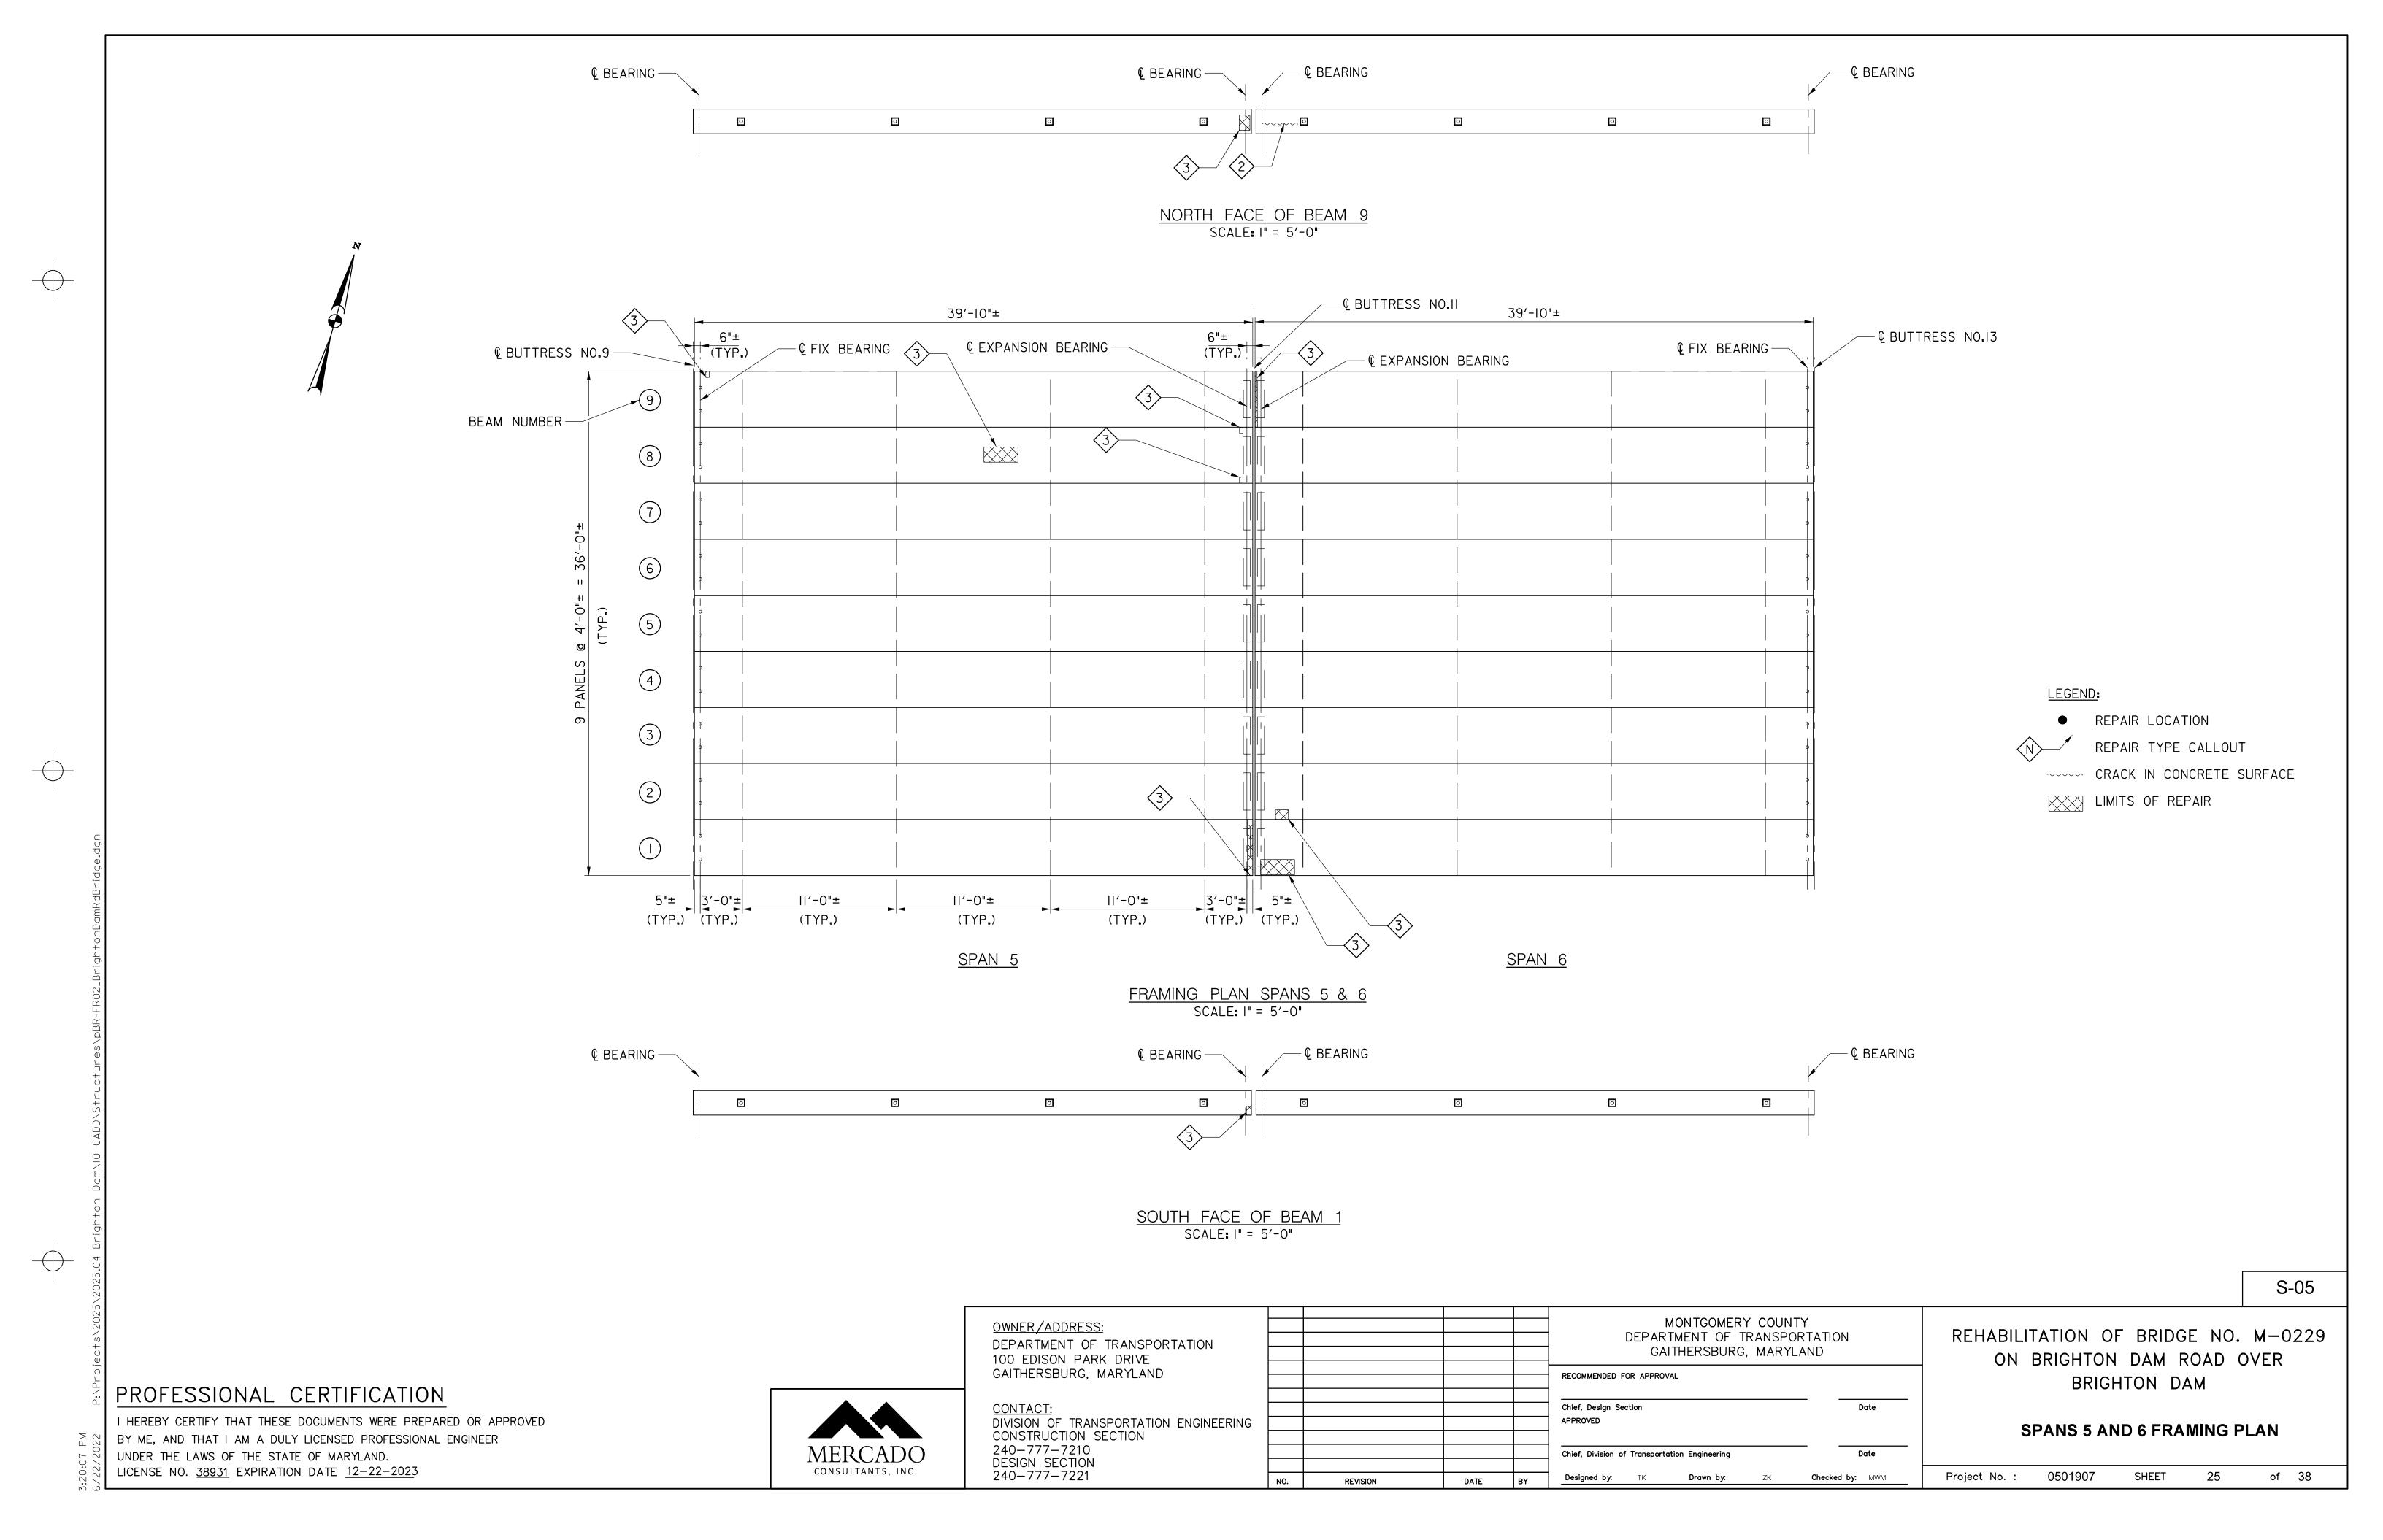

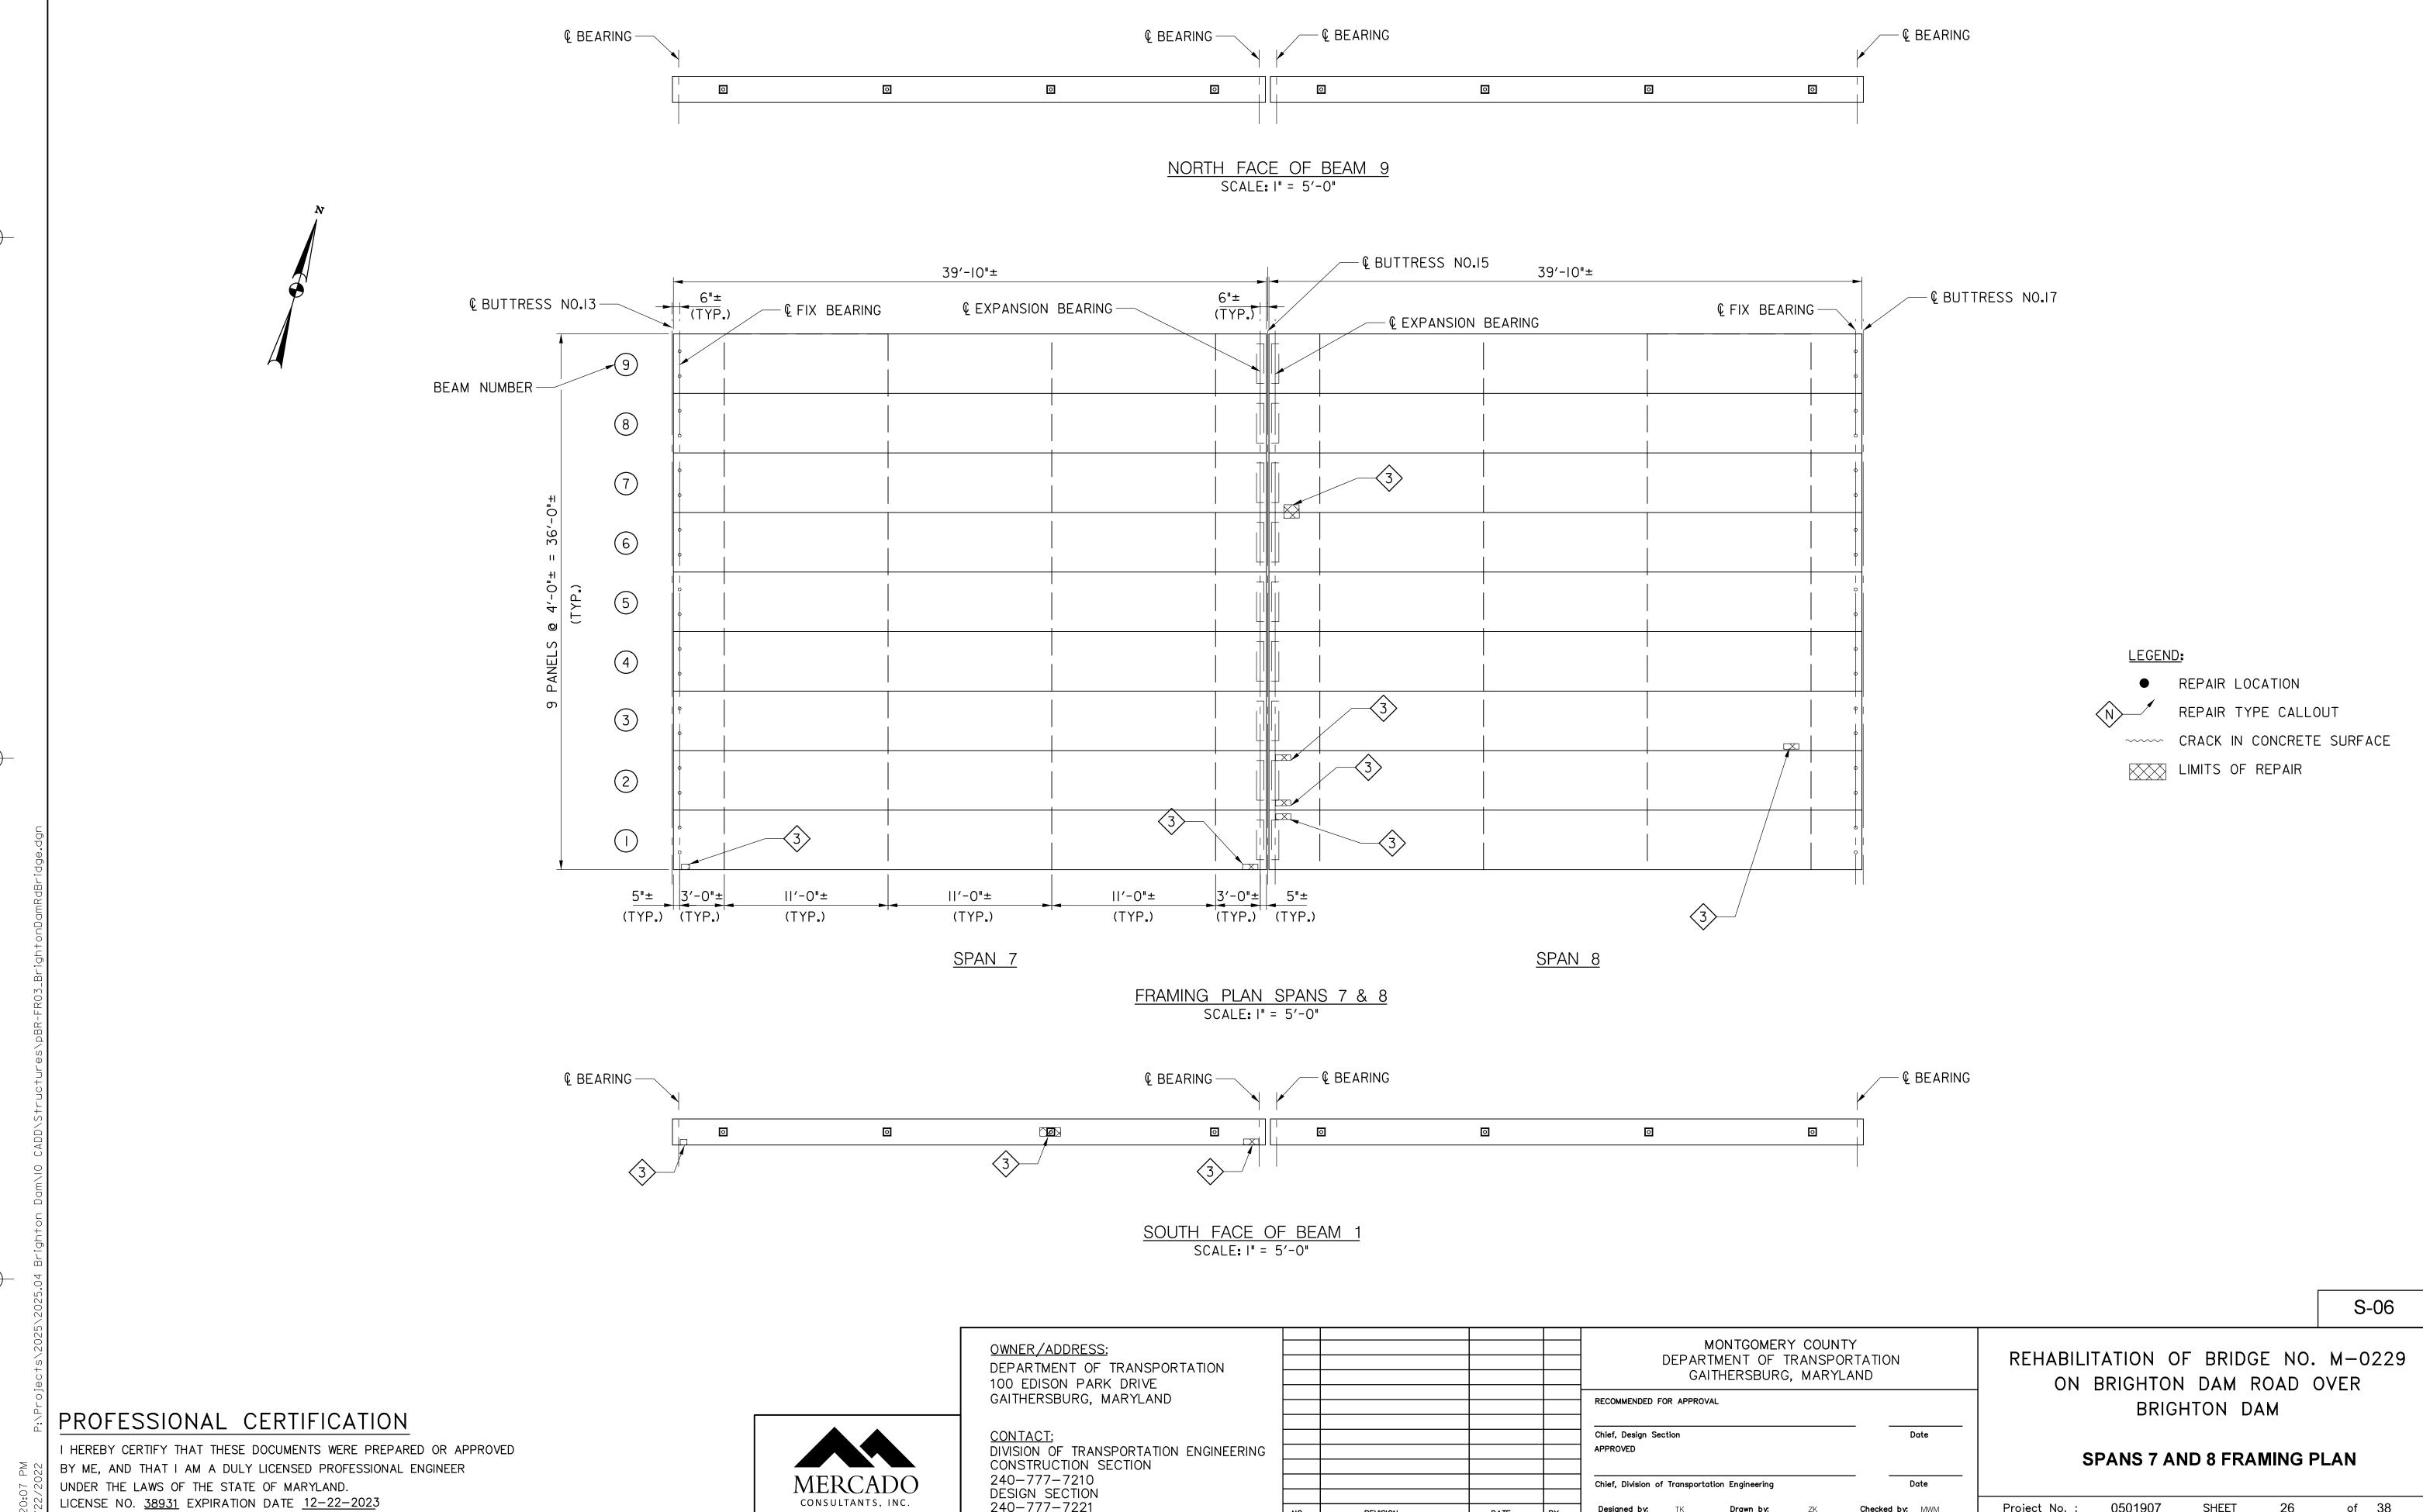

Project No. :

Checked by: MWM

Drawn by:

DATE

REVISION


0501907

26

SHEET

of 38

240-777-7221

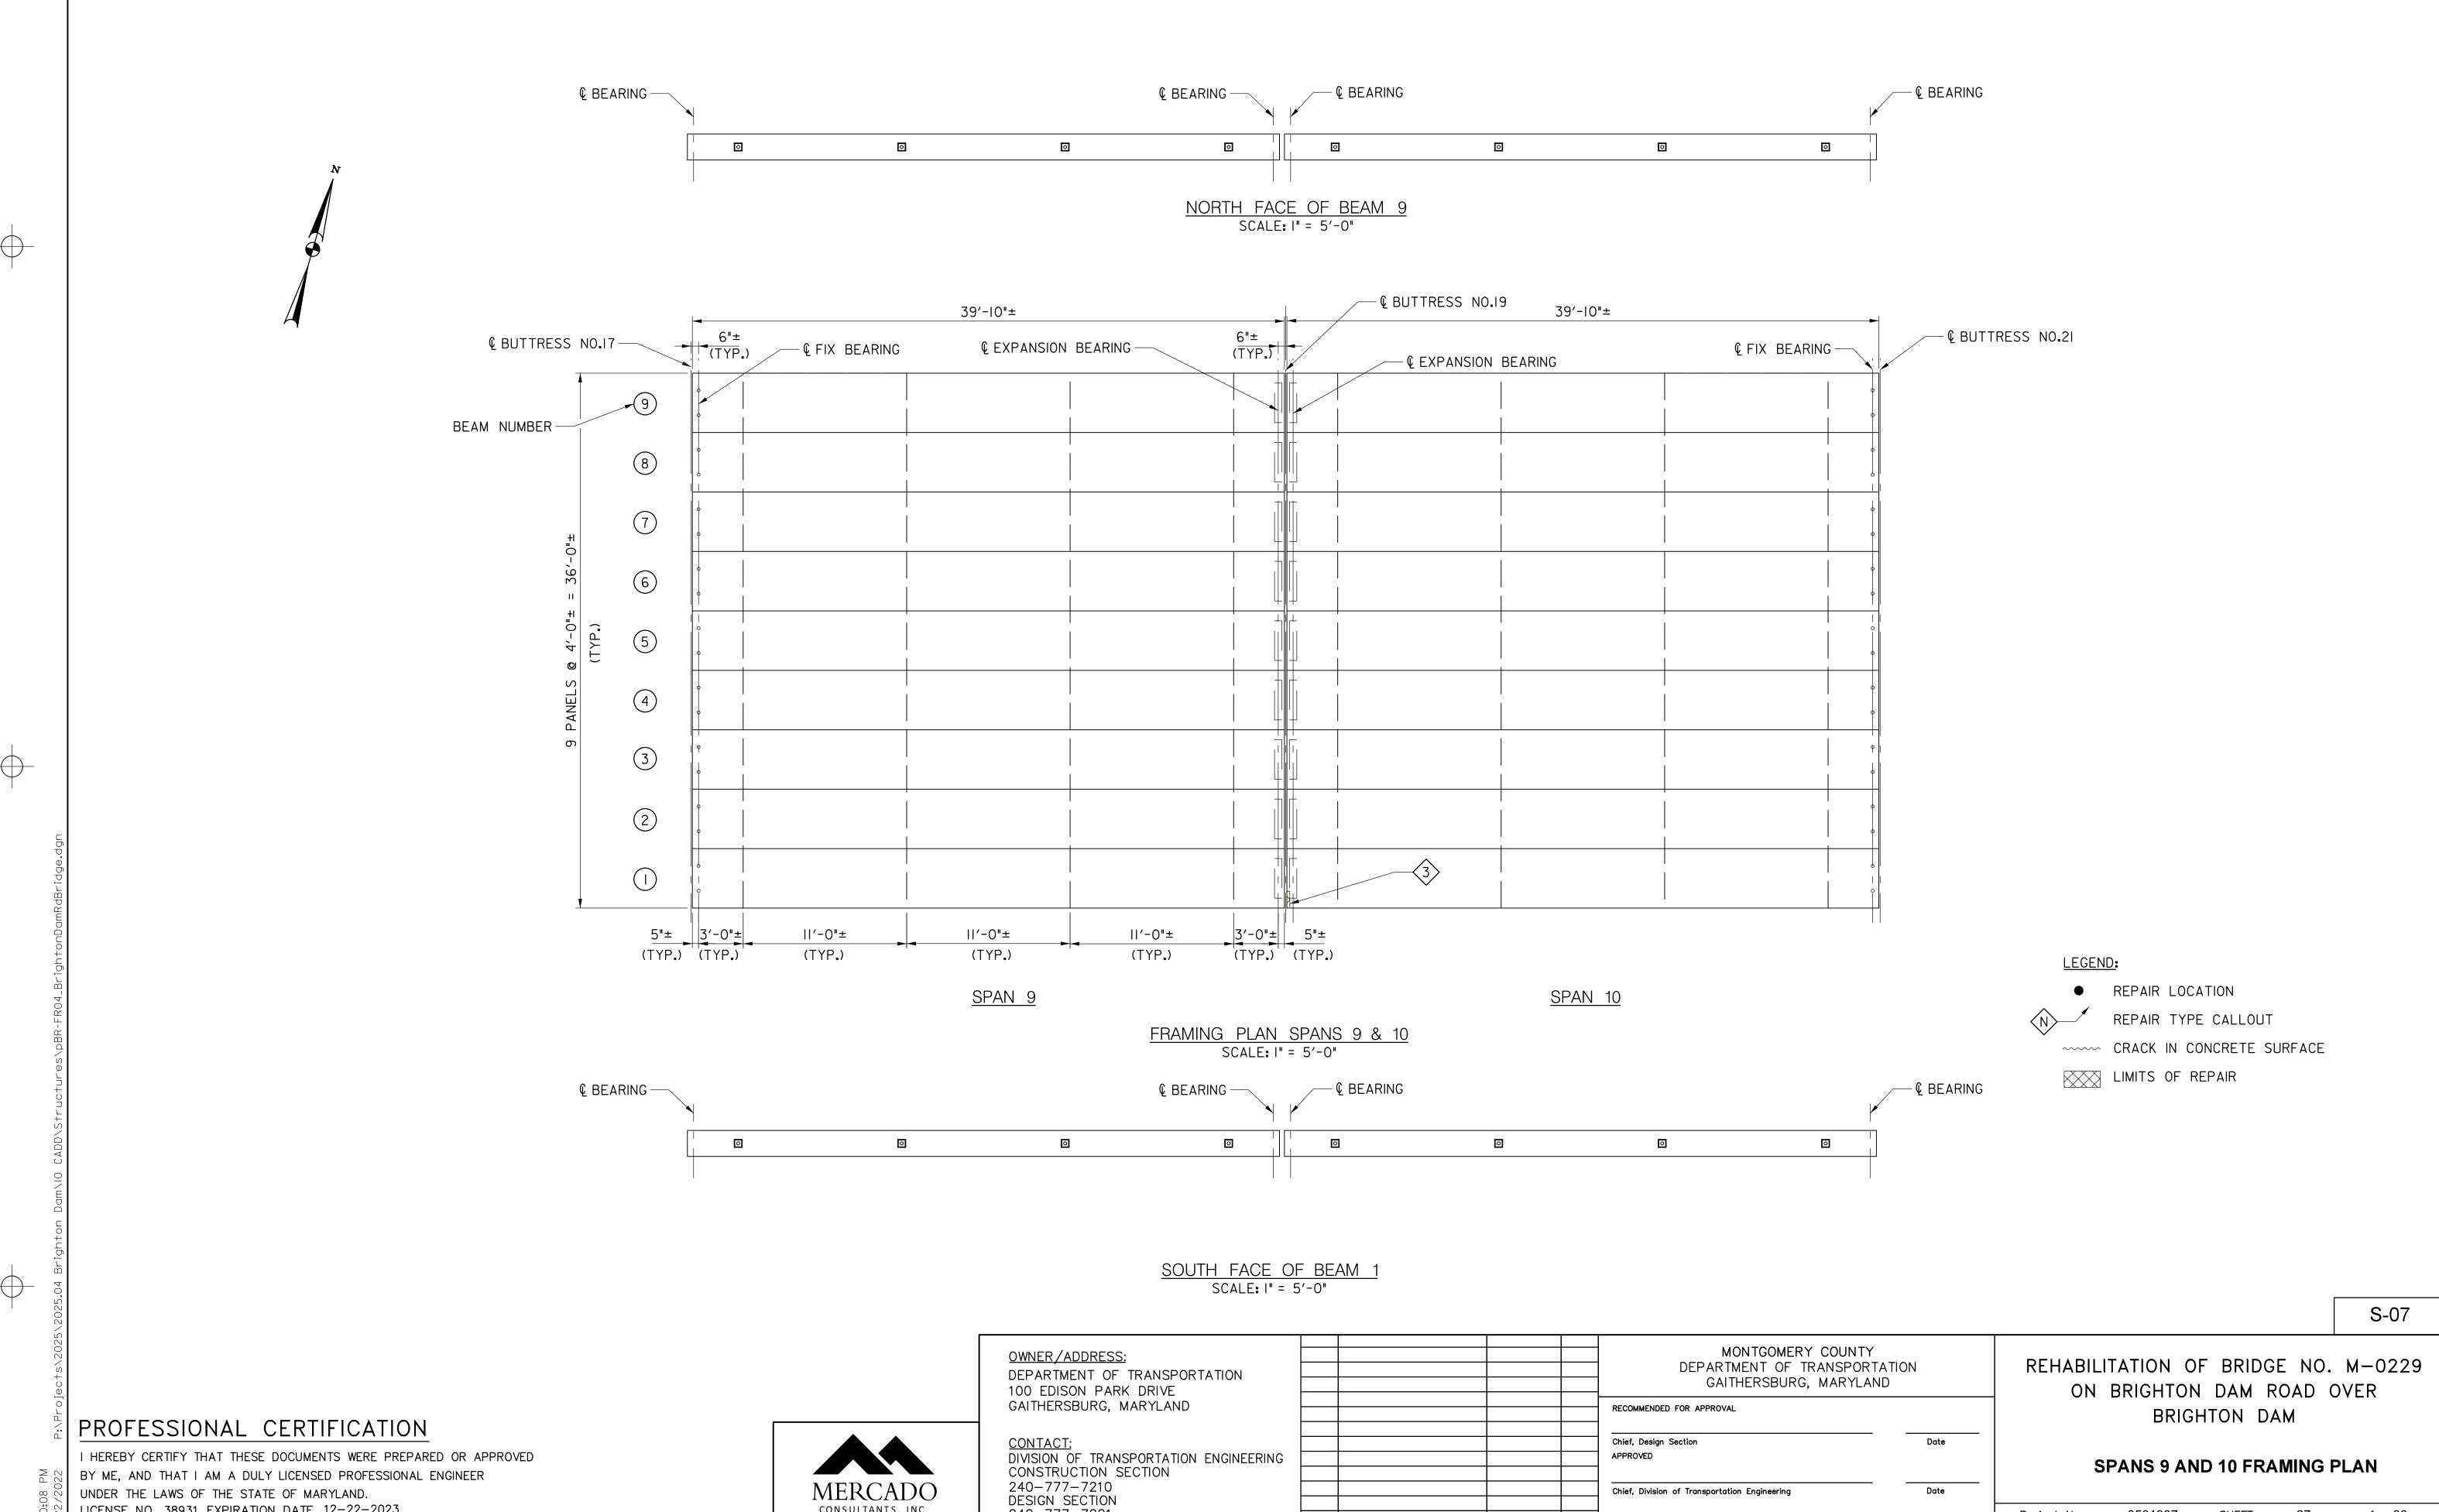

SHEET 27

of 38

0501907

Project No. :

Checked by: MWM

Designed by: TK Drawn by: ZK


DATE


REVISION


CONSULTANTS, INC.


240-777-7221

LICENSE NO. <u>38931</u> EXPIRATION DATE <u>12-22-2023</u>

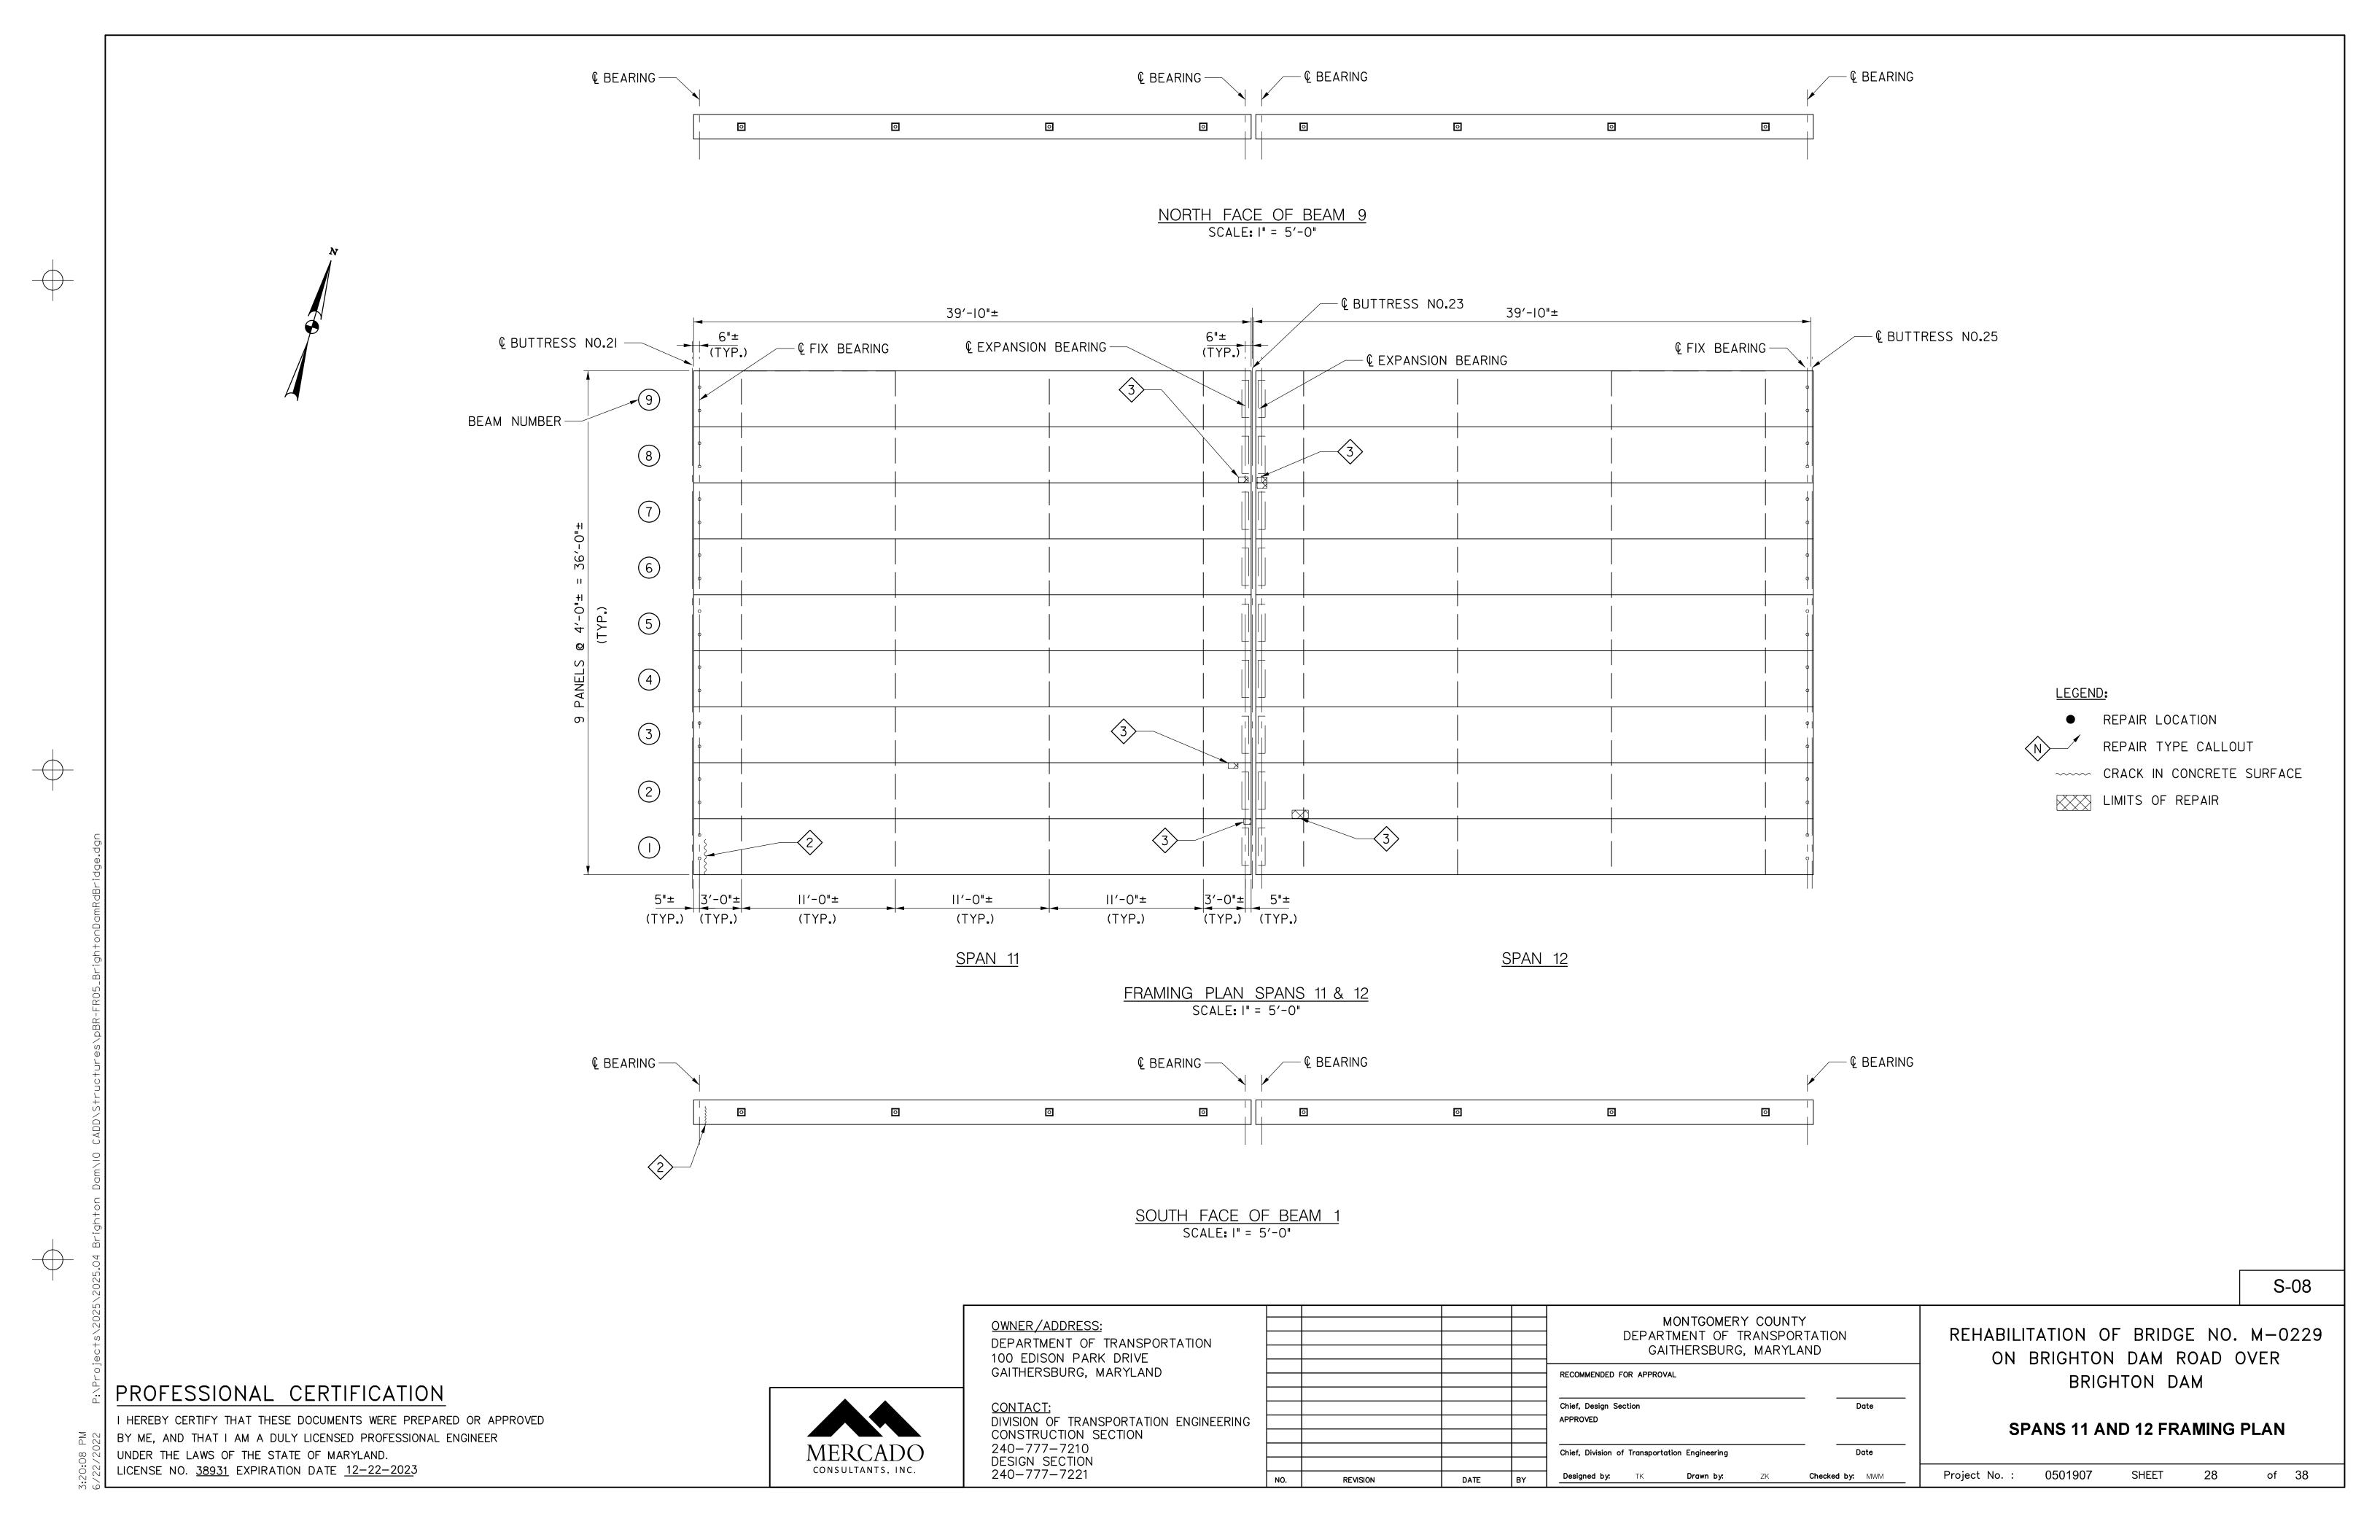

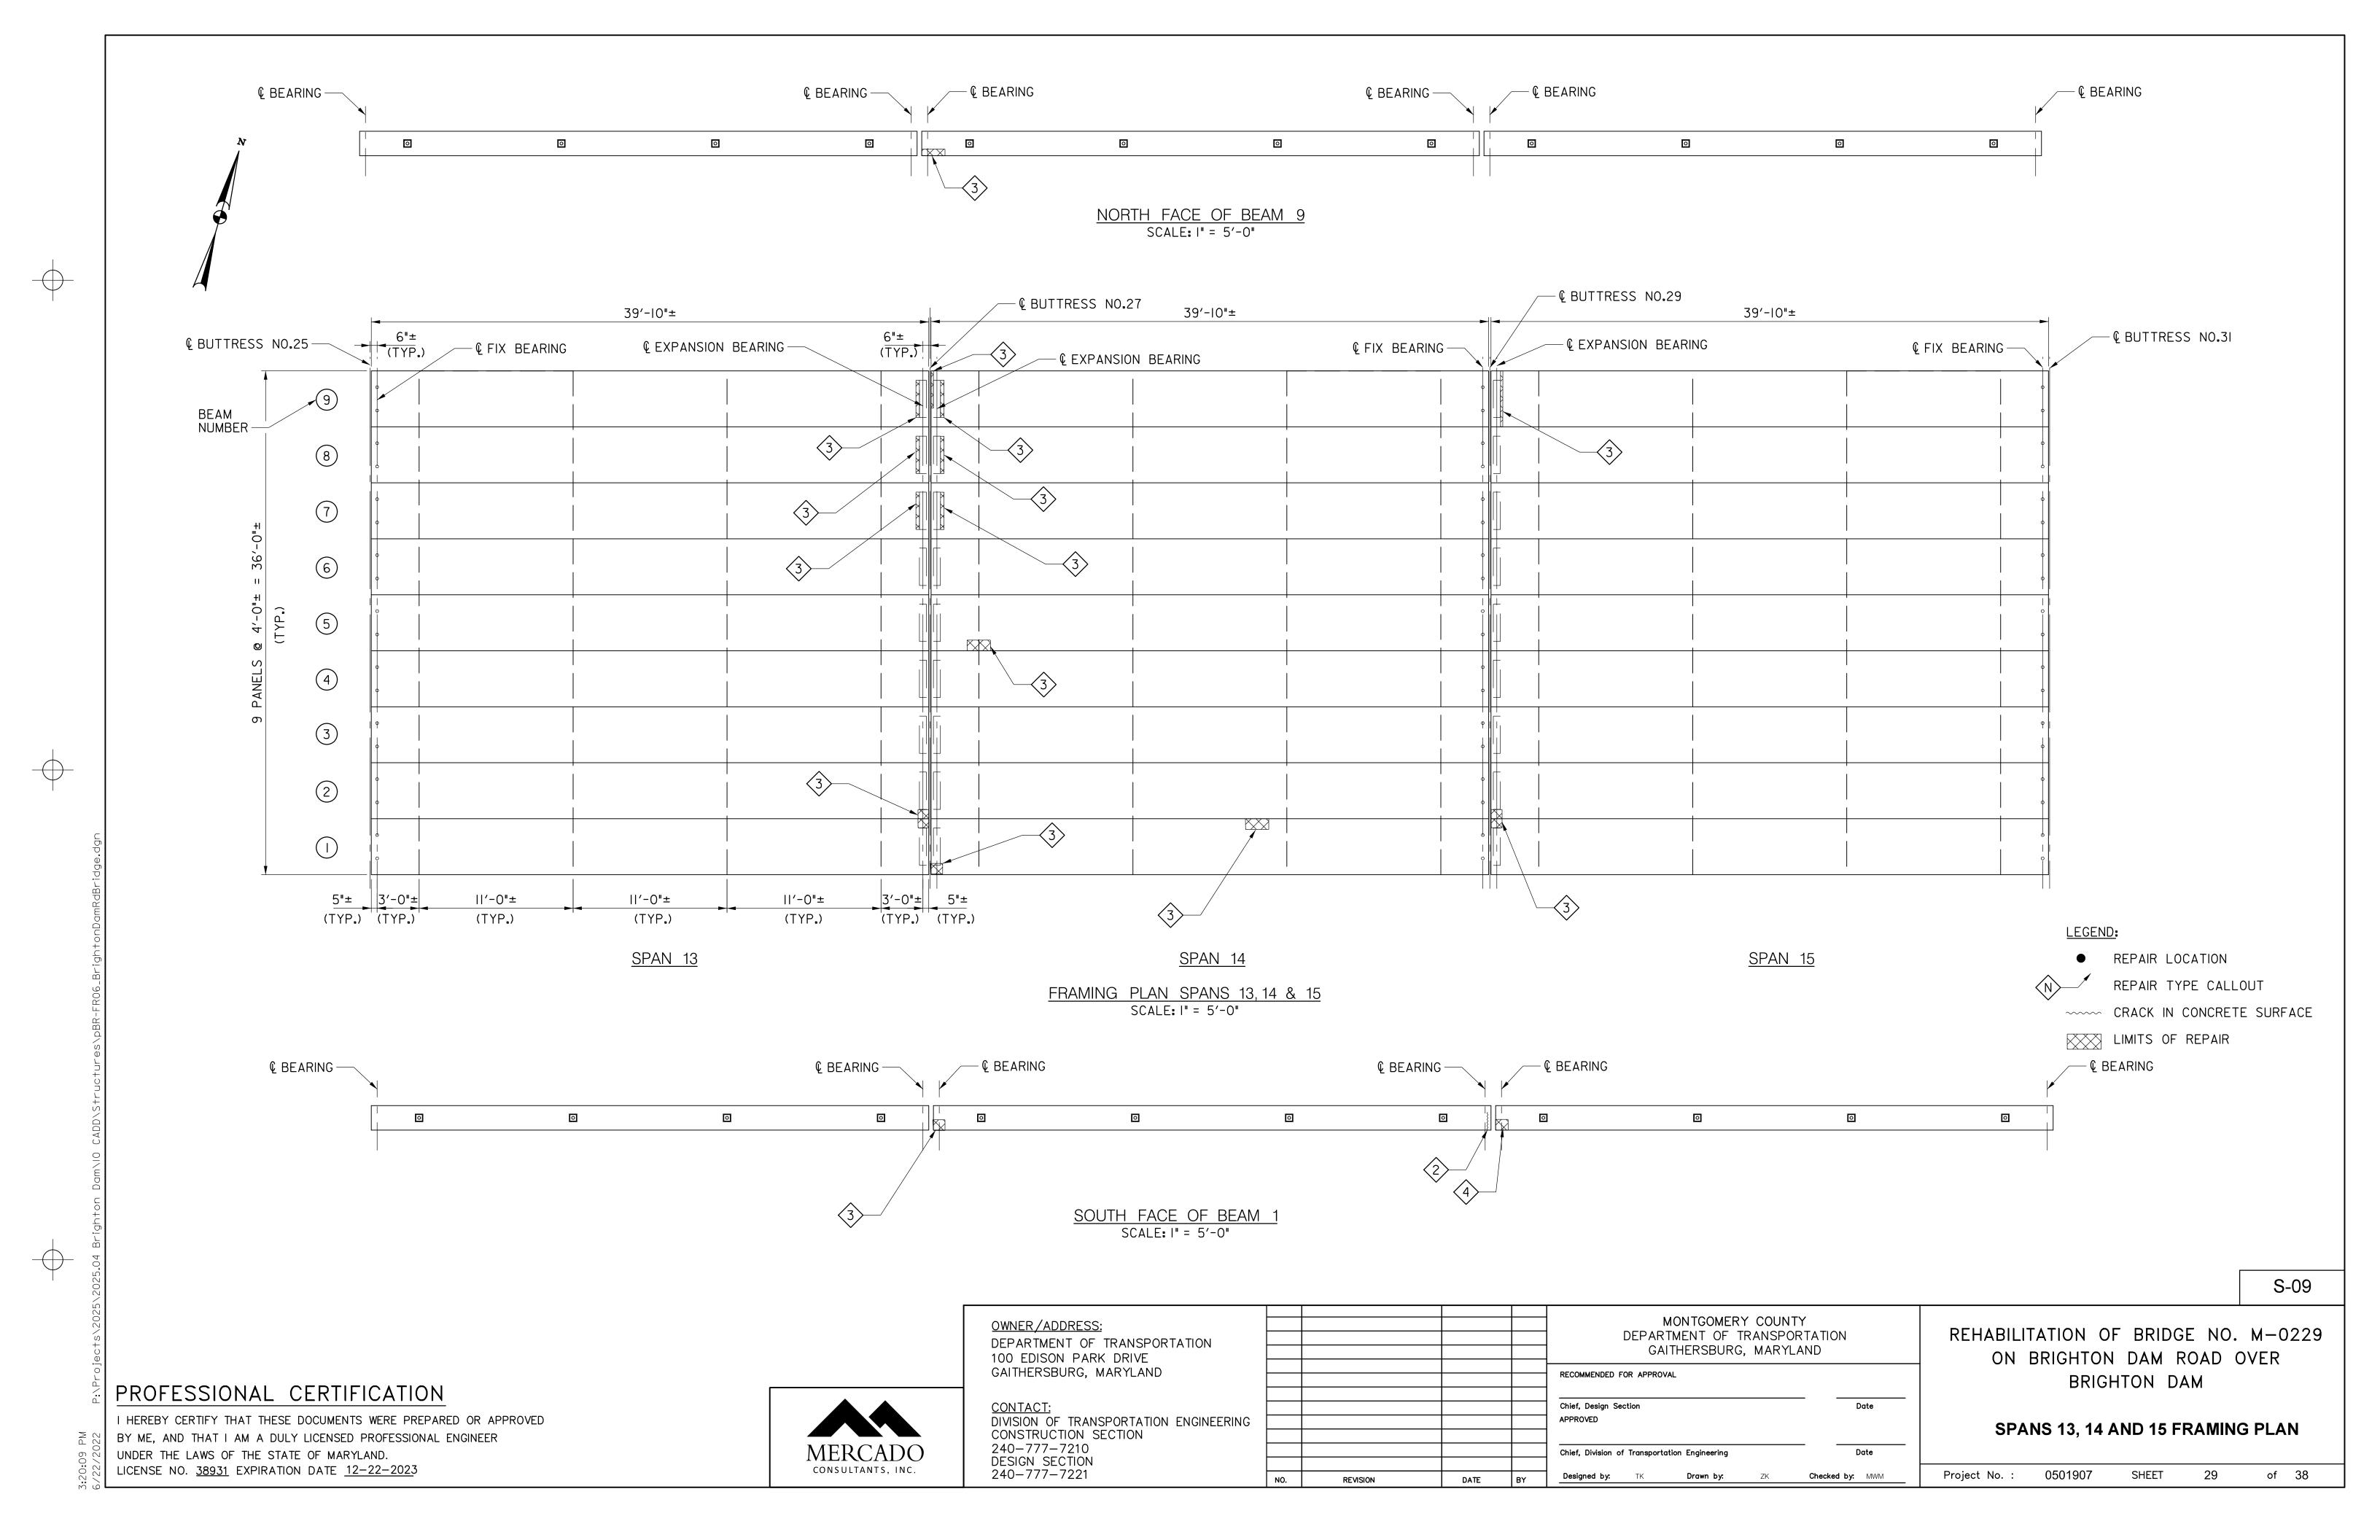

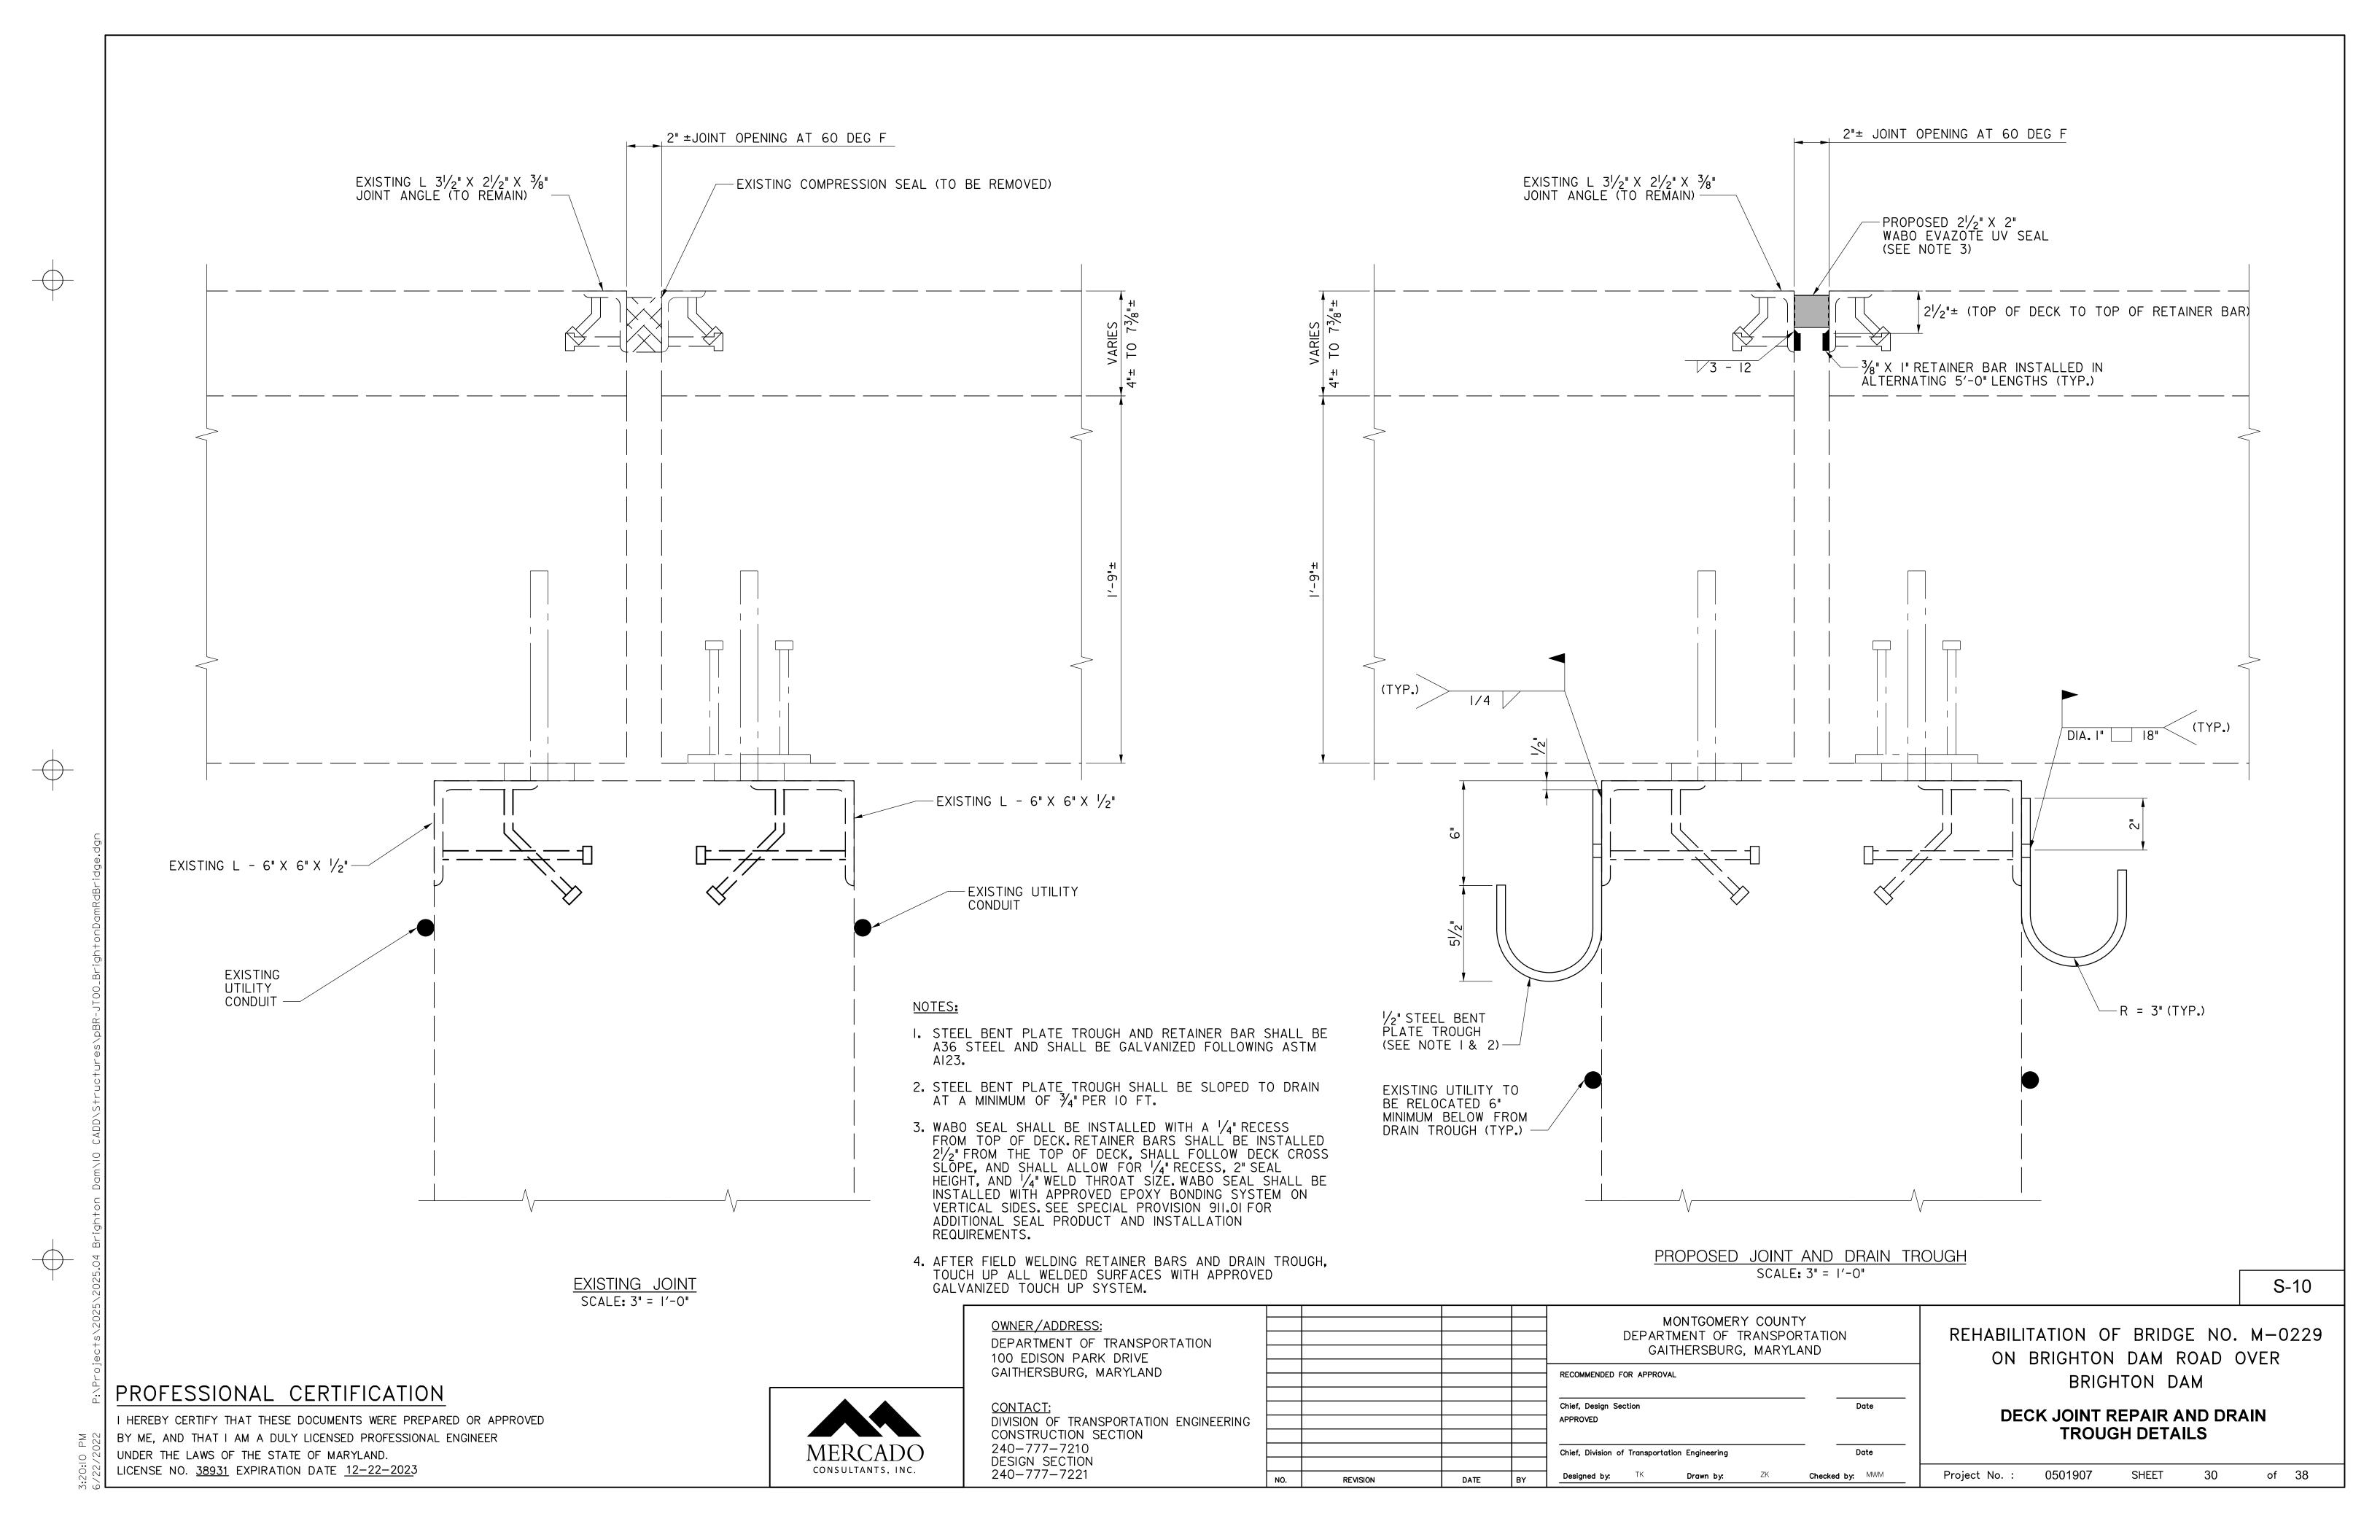

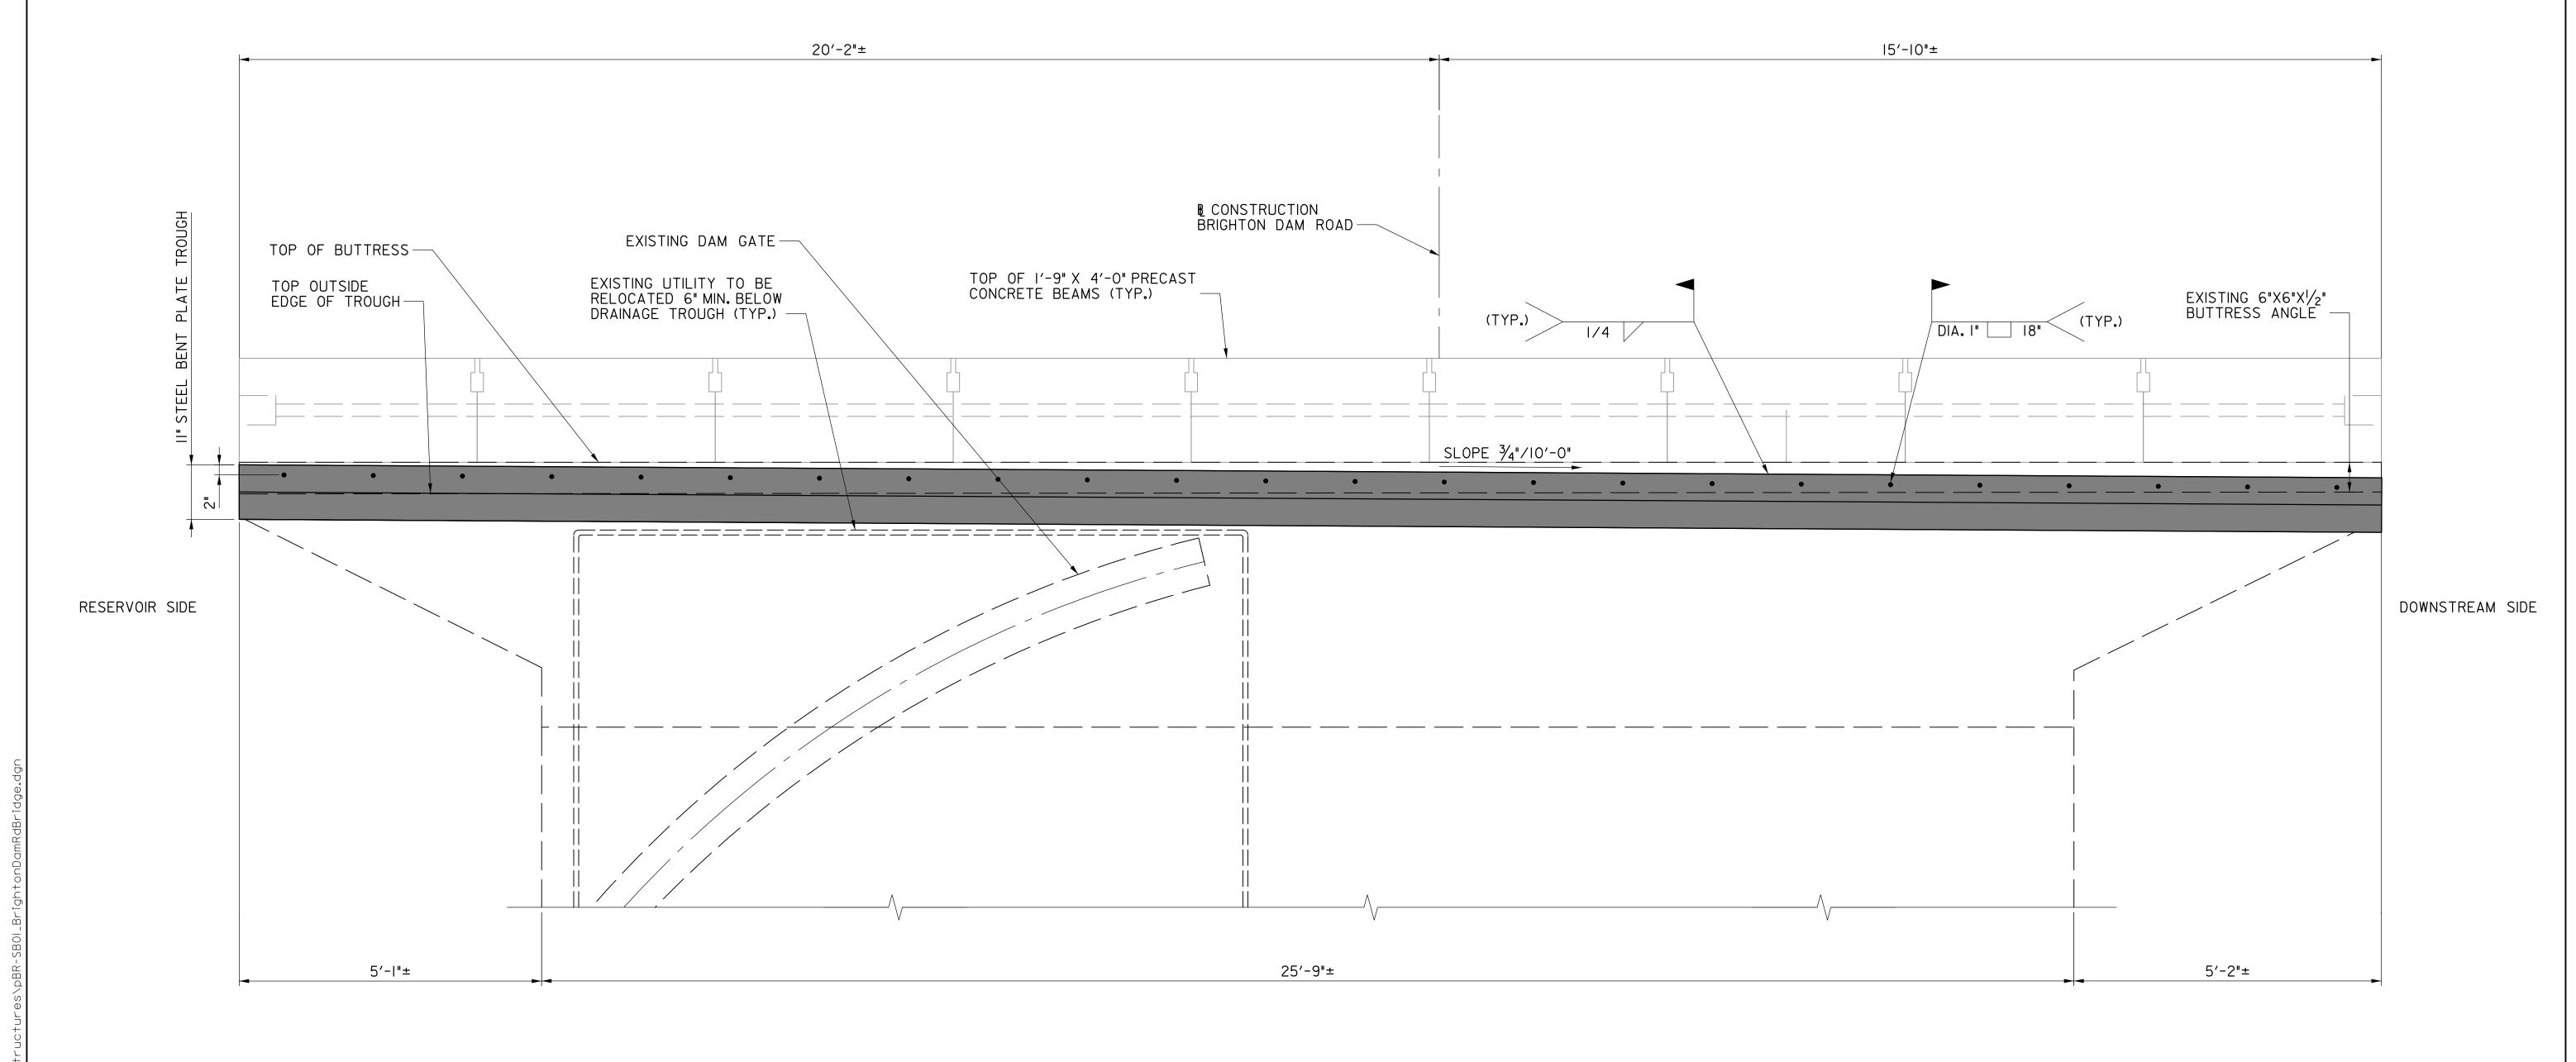

TYPICAL BUTTRESS ELEVATION

SCALE: 3/4" = 1'-0"

NOTES:

- I. DRAINAGE TROUGH SHALL BE PROVIDED WITH SLOPE SHOWN FOR BUTTRESSES 13, 15, 17, 19, 21, 23, AND 25 (WEST SIDE ONLY). NO DRAINAGE TROUGH SHALL BE PROVIDED ON EAST SIDE OF BUTTRESS 25.
- 2. FOR DETAILS ON DRAINAGE TROUGH AT BUTTRESS II, SEE DWG. NO. S-I2.

PROFESSIONAL CERTIFICATION

I HEREBY CERTIFY THAT THESE DOCUMENTS WERE PREPARED OR APPROVED BY ME, AND THAT I AM A DULY LICENSED PROFESSIONAL ENGINEER UNDER THE LAWS OF THE STATE OF MARYLAND.

LICENSE NO. 38931 EXPIRATION DATE 12-22-2023



OWNER/ADDRESS:
DEPARTMENT OF TRANSPORTATION
100 EDISON PARK DRIVE
GAITHERSBURG, MARYLAND

CONTACT:
DIVISION OF TRANSPORTATION ENGINEERING CONSTRUCTION SECTION
240-777-7210
DESIGN SECTION
240-777-7221

				MONTGOMERY COUNT DEPARTMENT OF TRANSPOR GAITHERSBURG, MARYLA		TATION	RE
					RECOMMENDED FOR APPROVAL		
G					Chief, Design Section APPROVED	Date	
					Chief, Division of Transportation Engineering	Date	
	NO.	REVISION	DATE	BY	Designed by: KW Drawn by: KW	Checked by: MWM	Projec


REHABILITATION OF BRIDGE NO. M-0229 ON BRIGHTON DAM ROAD OVER BRIGHTON DAM


S-11

DRAINAGE TROUGH AT BUTTRESS ELEVATION

Project No. : 0501907 SHEET 31 of 38

3:20:10 PM

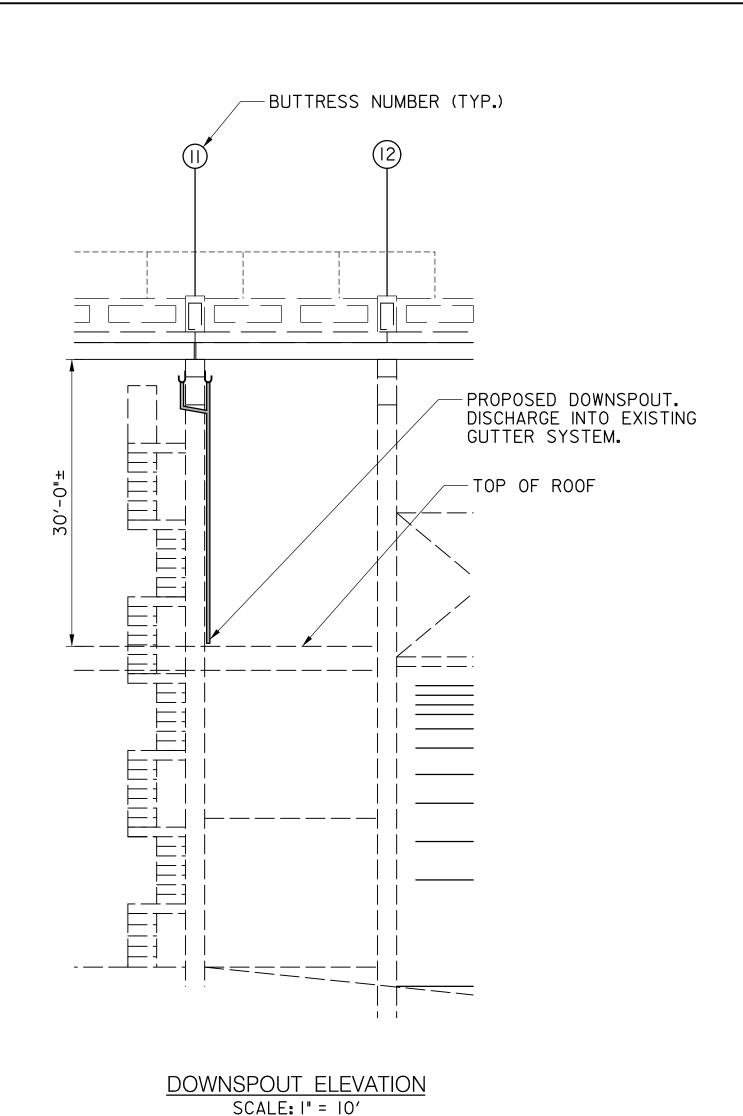


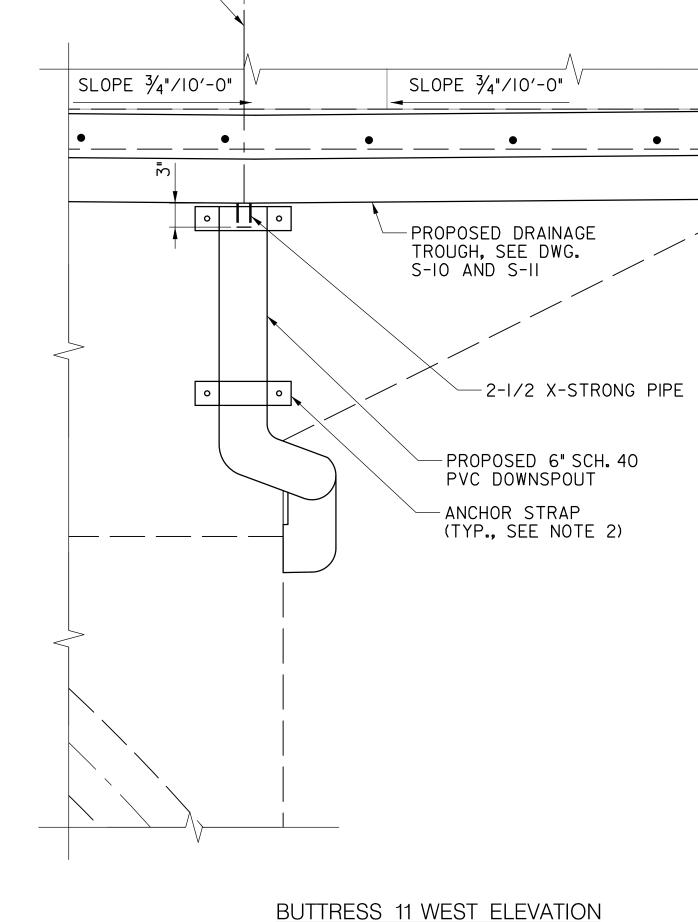


5′-8"

LOW POINT OF DRAINAGE TROUGH

AT BUTTRESS II

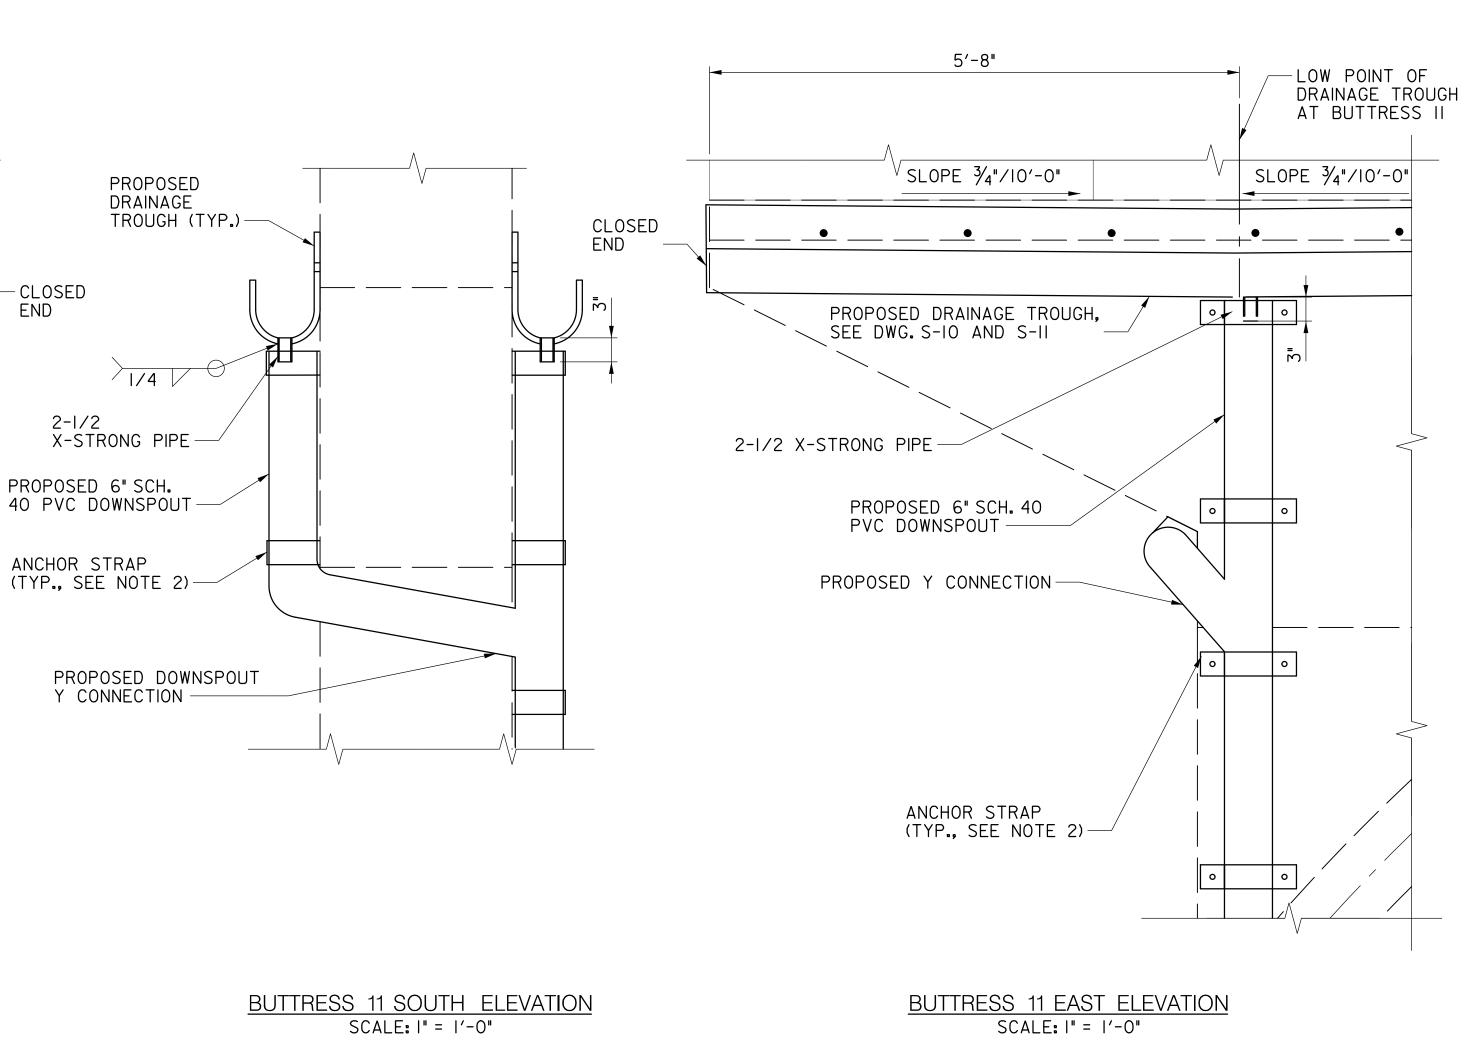


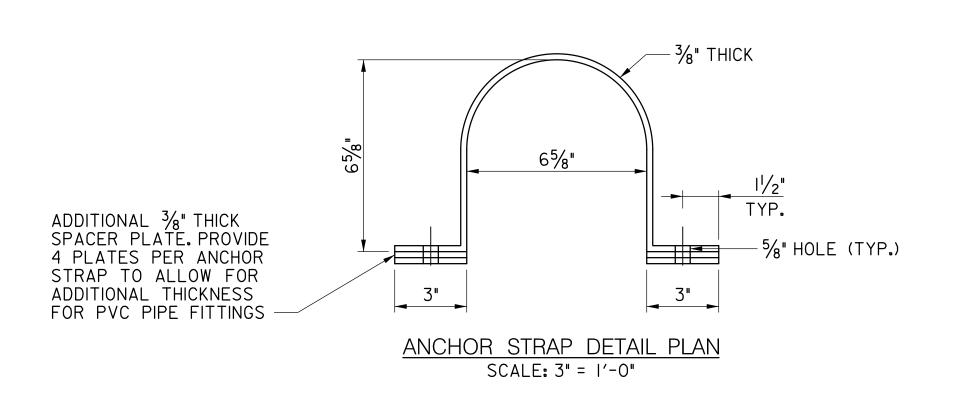

MERCADO

CONSULTANTS, INC.

SCALE: |" = |'-0"

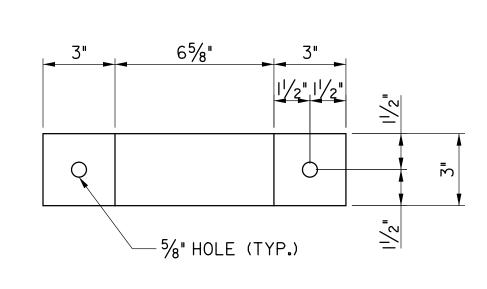

ANCHOR STRAP DETAIL ELEVATION

SCALE: 3" = 1'-0"

NOTES:

- I. ALL DOWNSPOUTS SHALL BE SCHEDULE 40 PVC.
- 2. INSTALL DOWNSPOUT ANCHOR STRAPS WITH \(\frac{1}{2} \) DIA. HILTIKWIK BOLT TZ2 SS304 WEDGE ANCHOR (STAINLESS STEEL). LENGTH OF ANCHOR SHALL PROVIDE FOR A MINIMUM OF 3" EMBEDMENT INTO THE BUTTRESS. CONTRACTOR SHALL FIELD DRILL 3" DEEP, \(\frac{1}{2} \) DIAMETER HOLES AT ANCHOR STRAP LOCATIONS INTO CONCRETE BUTTRESS. ANCHOR STRAPS SHALL BE PROVIDED AT A MINIMUM OF 10'-0" SPACING EXCEPT AS SHOWN AT THE TOP OF THE BUTTRESS. IT IS ESTIMATED THAT 9 ANCHOR STRAPS WILL BE NEEDED.
- 3. APPLY EPOXY ADHESIVE BETWEEN INSIDE OF ANCHOR STRAP AND OUTSIDE OF PVC DOWNSPOUT WHEN INSTALLED.
- 4. ANCHOR STRAPS, SPACERS, AND X-STRONG PIPE SHALL BE A36 STEEL AND SHALL BE GALVANIZED FOLLOWING ASTM A123.
- 5. MEASUREMENT AND PAYMENT FOR DOWNSPOUT AT BUTTRESS II SHALL INCLUDE ALL MATERIALS, LABOR, AND INCIDENTALS NEEDED TO INSTALL DOWNSPOUT.

PROPOSED DOWNSPOUT LOCATION NOT TO SCALE

PROFESSIONAL CERTIFICATION

I HEREBY CERTIFY THAT THESE DOCUMENTS WERE PREPARED OR APPROVED BY ME, AND THAT I AM A DULY LICENSED PROFESSIONAL ENGINEER UNDER THE LAWS OF THE STATE OF MARYLAND. LICENSE NO. 38931 EXPIRATION DATE 12-22-2023

OWNER/ADDRESS:

DEPARTMENT OF TRANSPORTATION

100 EDISON PARK DRIVE

GAITHERSBURG, MARYLAND

CONTACT:
DIVISION OF TRANSPORTATION ENGINEERING CONSTRUCTION SECTION 240-777-7210
DESIGN SECTION 240-777-7221

				RECOM
				Chief,
				APPRO'
				Chief,
				Offici,
NO.	REVISION	DATE	BY	Design
ı 170.	INE VISION	"	יטן	

MONTGOMERY COUNTY DEPARTMENT OF TRANSPORTATION GAITHERSBURG, MARYLAND						
MMENDED FOR APPROVAL						
Design Section OVED	Date					
Division of Transportation Engineering	Date					
gned by: KW Drawn by: KW	Checked by: MWM					

REHABILITATION OF BRIDGE NO. M-0229 ON BRIGHTON DAM ROAD OVER BRIGHTON DAM


S-12

DOWNSPOUT DETAILS

Project No. : 0501907 SHEET 32 of 38

3:20:11 PM

2025,04 Brighton Dam\IO CADD\Struc

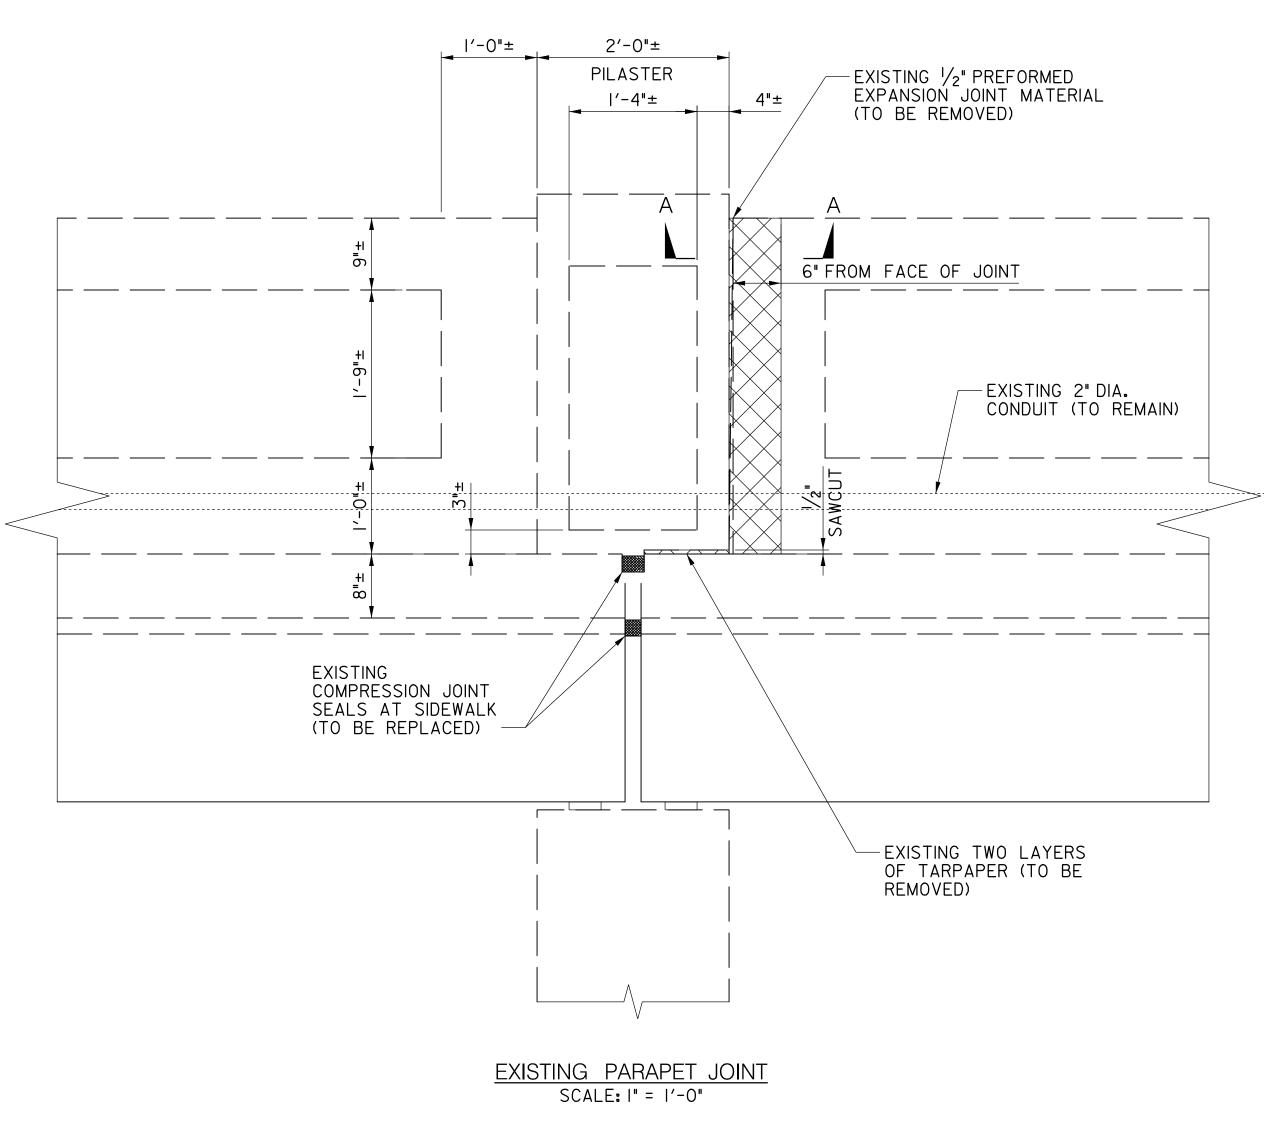

EXISTING 1/2" PREFORMED EXPANSION JOINT MATERIAL (TO BE REMOVED) #5 @ I'-0" (TYP., TO REMAIN) — #5 L@ I'-O" (TYP., TO REMAIN)-#5 @ I'-0" (TYP., TO REMAIN) -EXISTING 2" DIA. CONDUIT (TO REMAIN) -

SECTION A-A EXISTING EXPANSION JOINT SCALE: |" = |'-0"

LEGEND:

PROPOSED MIX NO.6 CONCRETE

PROPOSED WABO EVAZOTE UV SEAL

MERCADO

CONSULTANTS, INC.

LIMITS OF REMOVAL

NOTES:

PROPOSED PARAPET JOINT

SCALE: |" = |'-0"

2'-0"±

PILASTER

|'-4"±

I. REMOVAL LIMITS SHOWN ARE MINIMUM REQUIRED TO INSTALL NEW JOINT AT PARAPET/PILASTER. ADDITIONAL REMOVAL AND REPAIRS MAY BE NEEDED FOR ADJACENT CONCRETE SPALLING OR CRACK REPAIRS. SEE DWG. NO. S-18 FOR DETAILS ON ADDITIONAL REMOVAL AND REPAIRS FOR ADJACENT CONCRETE SPALLING OR CRACK REPAIRS.

-PROPOSED 21/2" X 2" WABO EVAZOTE UV SEAL

-PROPOSED MIX NO.6 CONCRETE

- PROPOSED 1/2" PREFORMED EXPANSION JOINT MATERIAL INSERTED WITH EPOXY

ADHESIVE

-EXISTING 2" DIA. CONDUIT

- 2. MEASUREMENT AND PAYMENT FOR LIMITS OF REMOVAL AND RECONSTRUCTION SHOWN ON THIS SHEET SHALL BE PAID UNDER REPAIR OF CONCRETE PARAPET AT BRIDGE JOINTS PAY ITEM. ADDITIONAL CONCRETE SPALL AND CONCRETE CRACKING REPAIRS BEYOND THE LIMITS SHOWN ON THIS SHEET SHALL NOT BE PAID UNDER THE REPAIR OF CONCRETE PARAPET AT BRIDGE JOINTS PAY ITEMS AND SHALL BE PAID USING THE CONCRETE SPALL REPAIR OR CONCRETE CRACKING REPAIR PAY ITEMS.
- 3. EXISTING HORIZONTAL UTILITY CONDUITS ARE PRESENT IN THE PARAPETS. CARE SHALL BE TAKEN NOT DAMAGE THESE EXISTING CONDUITS. ANY DAMAGE TO THE EXISTING CONDUITS SHALL BE REPAIRED BY THE CONTRACTOR AT NO COST TO THE COUNTY.
- 4. DETAILS ON THIS SHEET ARE FOR NORTH PARAPET. SOUTH PARAPET DETAILS ARE MIRRORED.

S-13

PROFESSIONAL CERTIFICATION

I HEREBY CERTIFY THAT THESE DOCUMENTS WERE PREPARED OR APPROVED BY ME, AND THAT I AM A DULY LICENSED PROFESSIONAL ENGINEER UNDER THE LAWS OF THE STATE OF MARYLAND. LICENSE NO. <u>38931</u> EXPIRATION DATE <u>12-22-2023</u>


TYPICAL TYPE 1 DEFECT PHOTO

PIER 1, NORTH PARAPET

NOT TO SCALE

OWNER/ADDRESS: DEPARTMENT OF TRANSPORTATION 100 EDISON PARK DRIVE GAITHERSBURG, MARYLAND


> CONTACT: DIVISION OF TRANSPORTATION ENGINEERING CONSTRUCTION SECTION 240-777-7210 DESIGN SECTION 240-777-7221

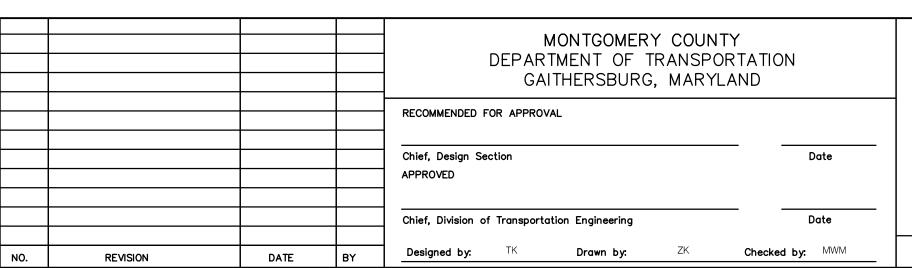

REHABILITATION OF BRIDGE NO. M-0229 ON BRIGHTON DAM ROAD OVER BRIGHTON DAM

TYPE 1 PARAPET JOINT REPAIR


0501907 SHEET 33 of 38 Project No. :

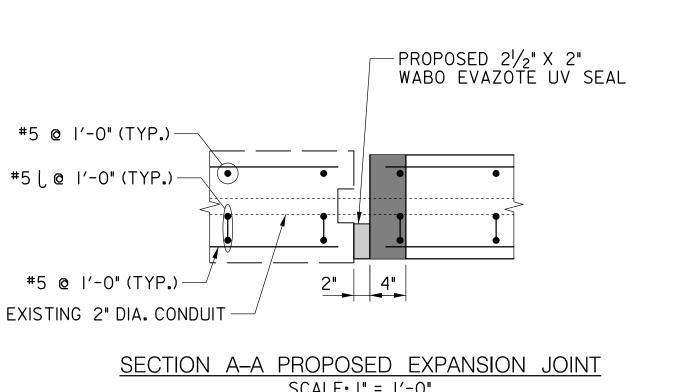

PROPOSED 31/16" X 23/4" WABO EVAZOTE UV

SEAL AT SIDEWALK, REFER TO DWG. NO. S-17-

SCALE: |" = |'-0"

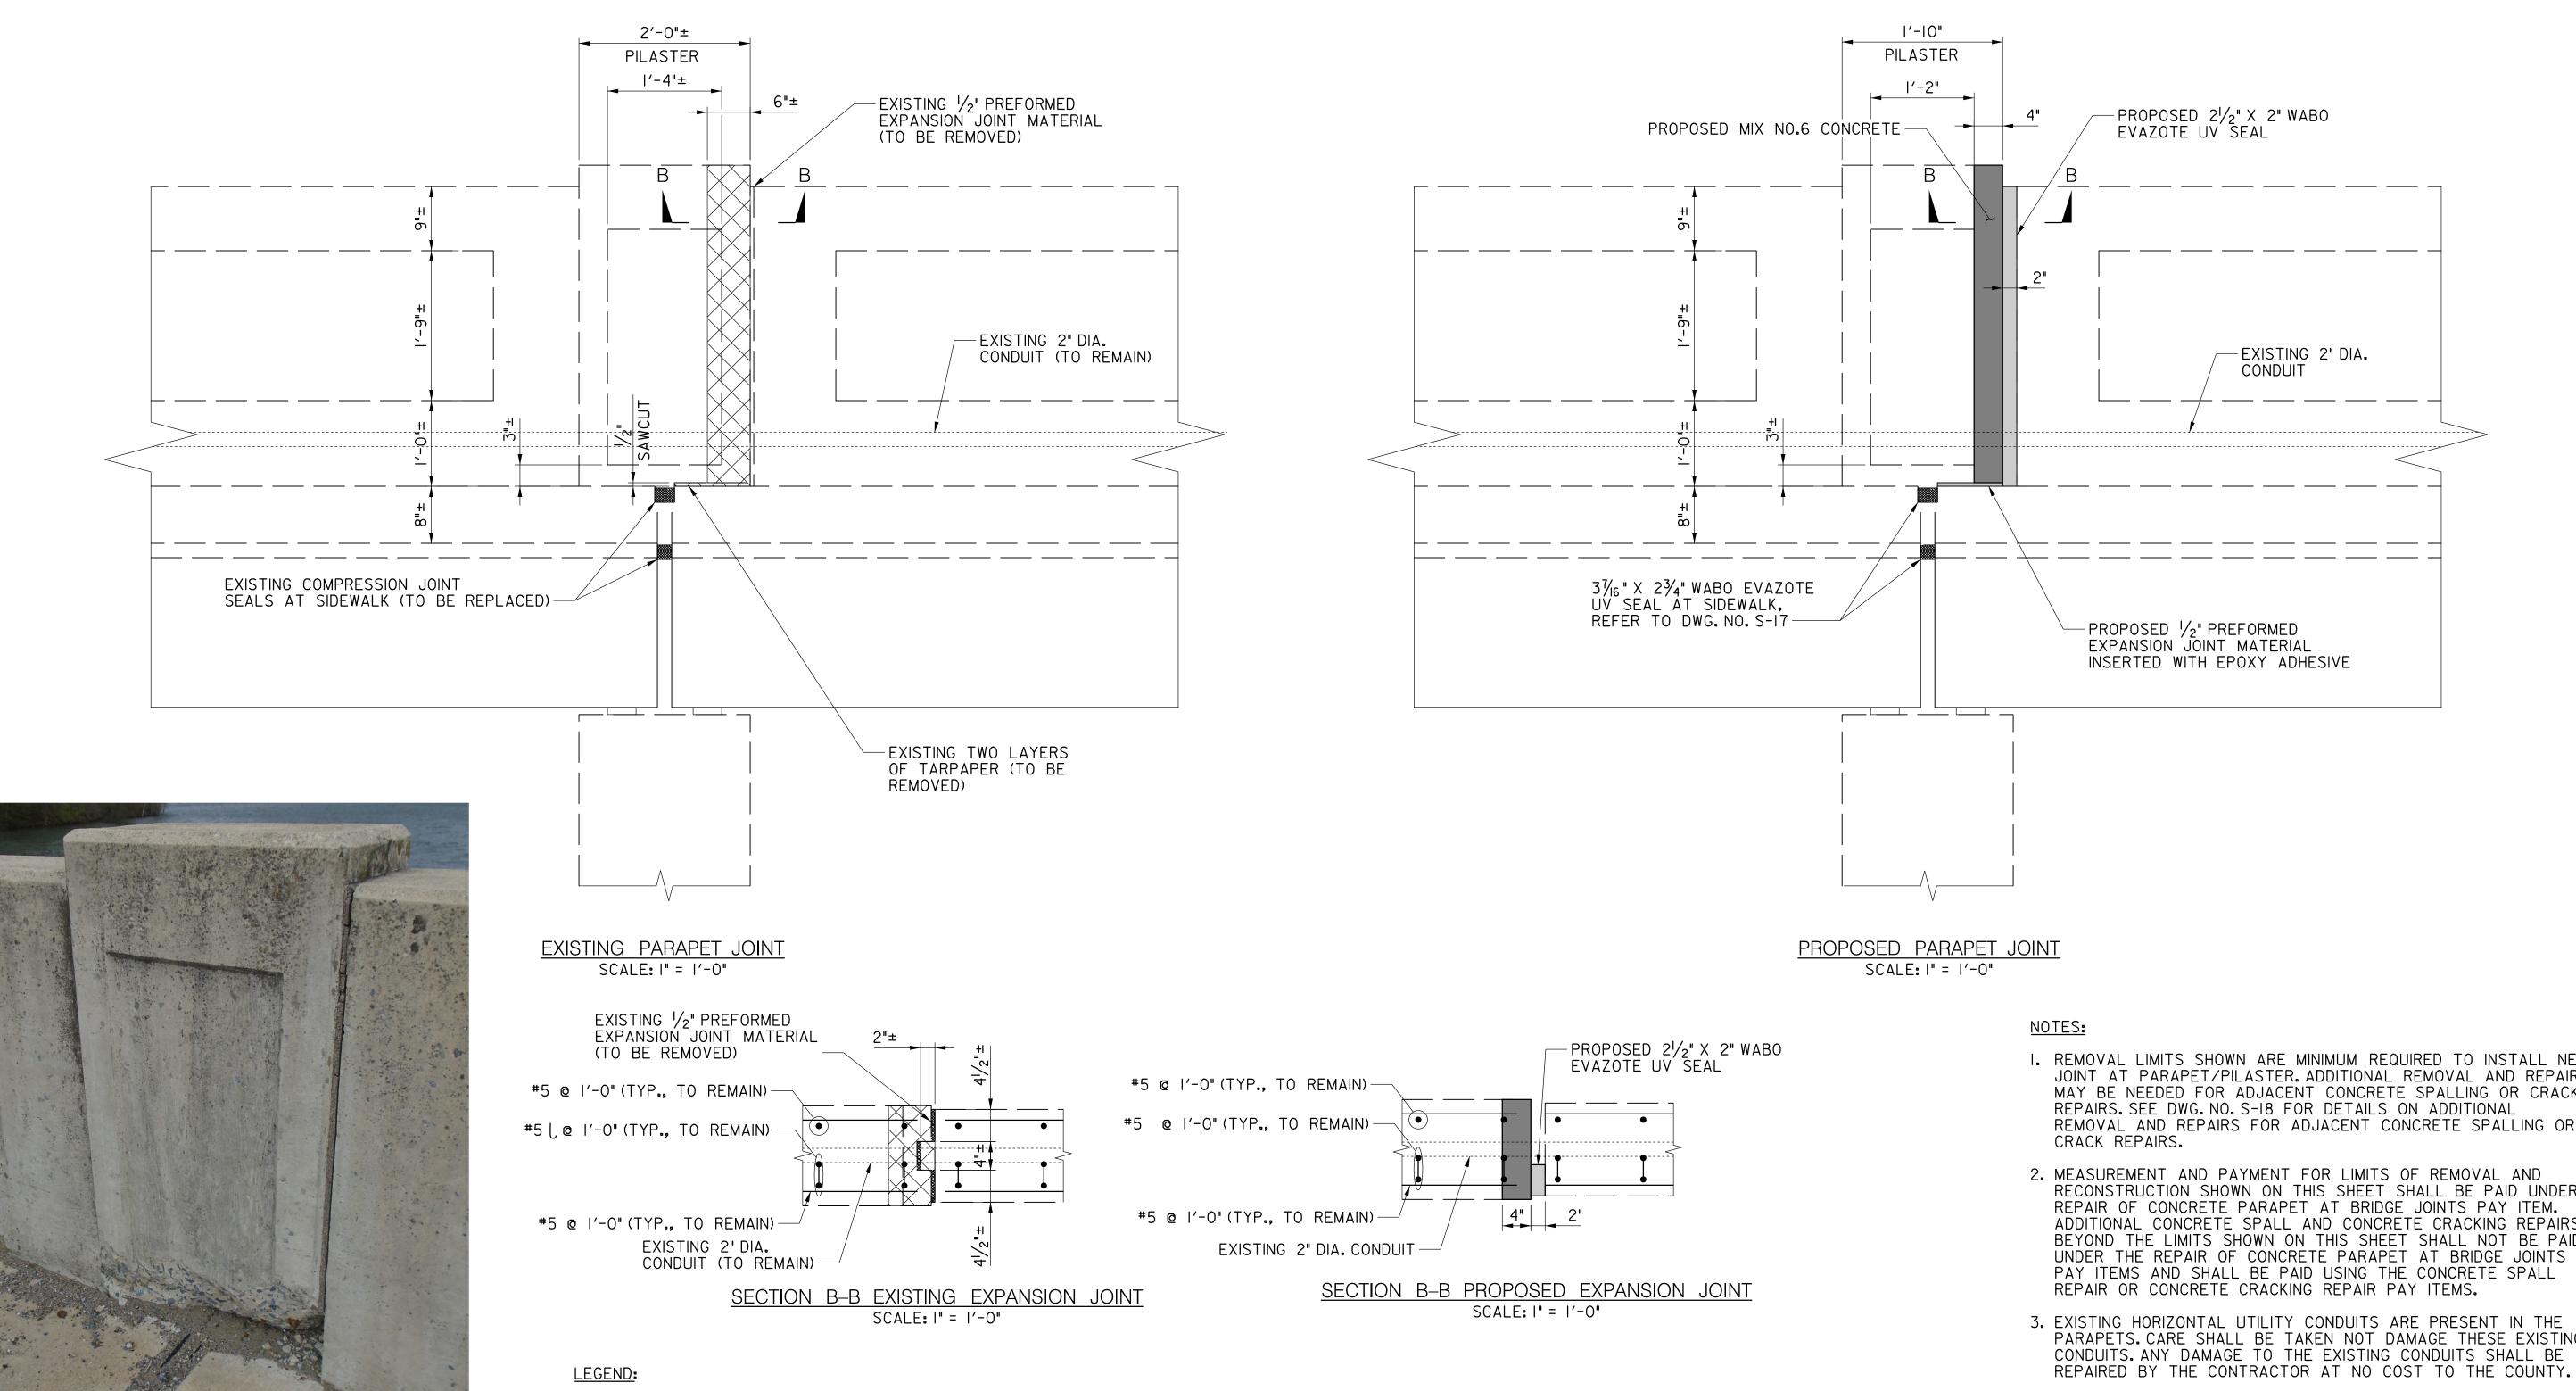

PIER 3, NORTH PARAPET NOT TO SCALE

I HEREBY CERTIFY THAT THESE DOCUMENTS WERE PREPARED OR APPROVED BY ME, AND THAT I AM A DULY LICENSED PROFESSIONAL ENGINEER UNDER THE LAWS OF THE STATE OF MARYLAND. LICENSE NO. <u>38931</u> EXPIRATION DATE <u>12-22-2023</u>

OWNER/ADDRESS: DEPARTMENT OF TRANSPORTATION 100 EDISON PARK DRIVE GAITHERSBURG, MARYLAND

CONTACT: DIVISION OF TRANSPORTATION ENGINEERING CONSTRUCTION SECTION 240-777-7210 DESIGN SECTION 240-777-7221

REVISION

DATE

MONTGOMERY COUNTY DEPARTMENT OF TRANSPORTATION GAITHERSBURG, MARYLAND RECOMMENDED FOR APPROVAL Chief, Design Section Date APPROVED Chief, Division of Transportation Engineering Date

REHABILITATION OF BRIDGE NO. M-0229 ON BRIGHTON DAM ROAD OVER BRIGHTON DAM

TYPE 2 PARAPET JOINT REPAIR

0501907 SHEET 34 of 38 Project No. :

PROFESSIONAL CERTIFICATION

TYPICAL TYPE 2 DEFECT PHOTO

MERCADO CONSULTANTS, INC.

PROPOSED MIX NO.6 CONCRETE


LIMITS OF REMOVAL

PROPOSED WABO EVAZOTE UV SEAL


- I. REMOVAL LIMITS SHOWN ARE MINIMUM REQUIRED TO INSTALL NEW JOINT AT PARAPET/PILASTER. ADDITIONAL REMOVAL AND REPAIRS MAY BE NEEDED FOR ADJACENT CONCRETE SPALLING OR CRACK REPAIRS. SEE DWG. NO. S-18 FOR DETAILS ON ADDITIONAL REMOVAL AND REPAIRS FOR ADJACENT CONCRETE SPALLING OR
- 2. MEASUREMENT AND PAYMENT FOR LIMITS OF REMOVAL AND RECONSTRUCTION SHOWN ON THIS SHEET SHALL BE PAID UNDER REPAIR OF CONCRETE PARAPET AT BRIDGE JOINTS PAY ITEM. ADDITIONAL CONCRETE SPALL AND CONCRETE CRACKING REPAIRS BEYOND THE LIMITS SHOWN ON THIS SHEET SHALL NOT BE PAID UNDER THE REPAIR OF CONCRETE PARAPET AT BRIDGE JOINTS PAY ITEMS AND SHALL BE PAID USING THE CONCRETE SPALL
- 3. EXISTING HORIZONTAL UTILITY CONDUITS ARE PRESENT IN THE PARAPETS. CARE SHALL BE TAKEN NOT DAMAGE THESE EXISTING CONDUITS. ANY DAMAGE TO THE EXISTING CONDUITS SHALL BE
- 4. DETAILS ON THIS SHEET ARE FOR NORTH PARAPET. SOUTH PARAPET DETAILS ARE MIRRORED.

Checked by: MWM

S-14

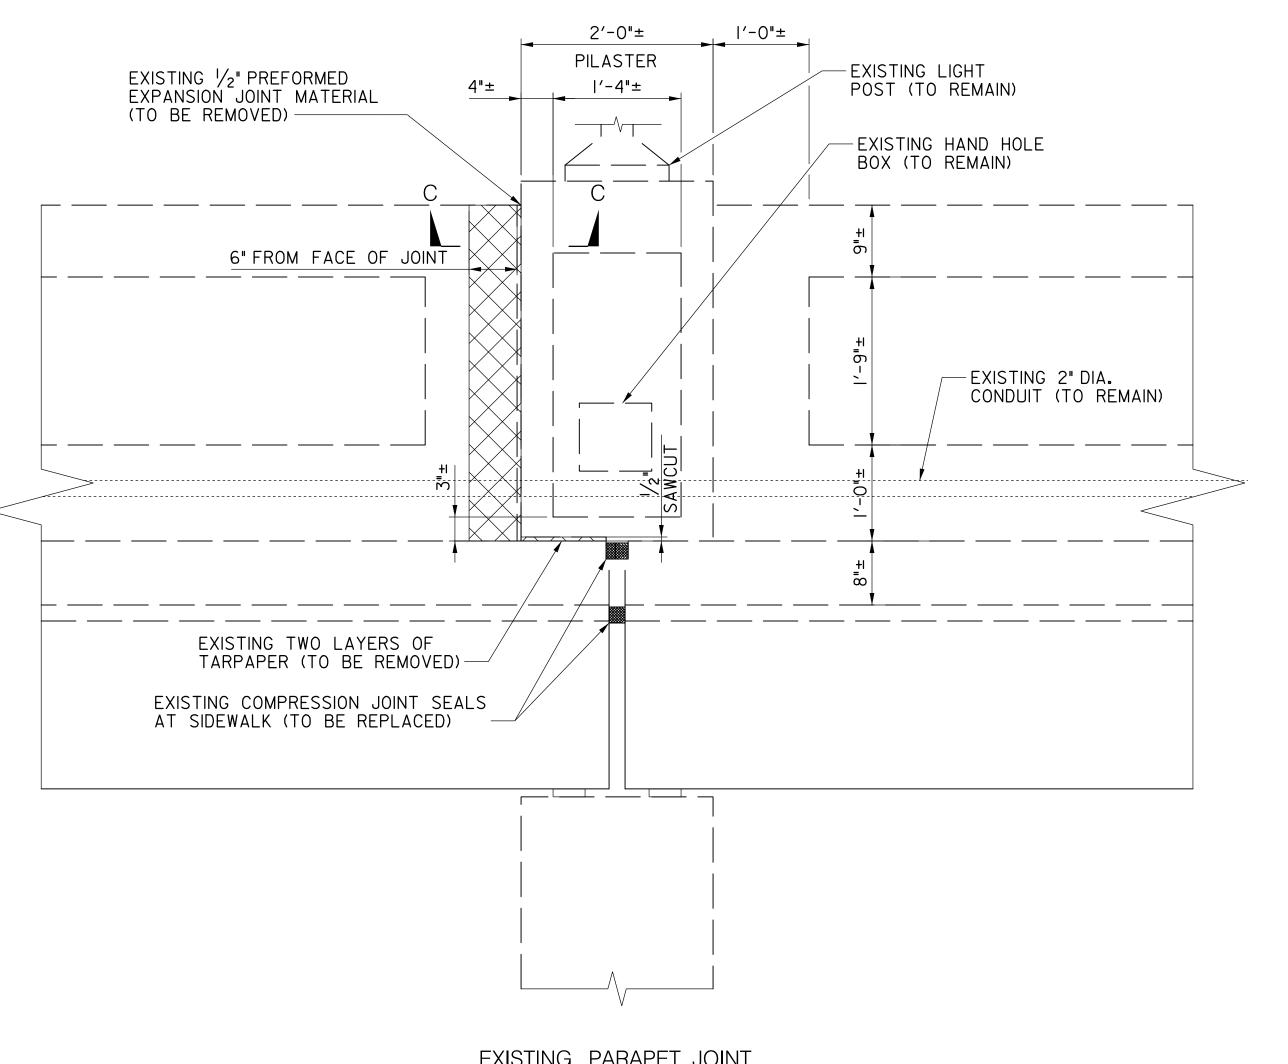

EXISTING PARAPET JOINT

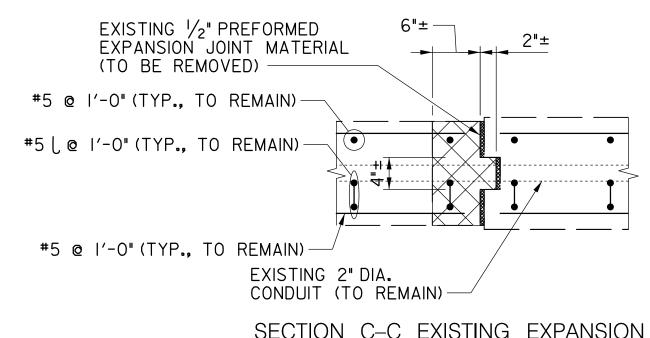

SECTION C-C EXISTING EXPANSION JOINT

LEGEND:

PROPOSED MIX NO.6 CONCRETE

MERCADO

CONSULTANTS, INC.

PROPOSED WABO EVAZOTE UV SEAL


LIMITS OF REMOVAL



TYPICAL TYPE 3 DEFECT PHOTO PIER 25, SOUTH PARAPET NOT TO SCALE

PROFESSIONAL CERTIFICATION

I HEREBY CERTIFY THAT THESE DOCUMENTS WERE PREPARED OR APPROVED BY ME, AND THAT I AM A DULY LICENSED PROFESSIONAL ENGINEER UNDER THE LAWS OF THE STATE OF MARYLAND. LICENSE NO. <u>38931</u> EXPIRATION DATE <u>12-22-2023</u>

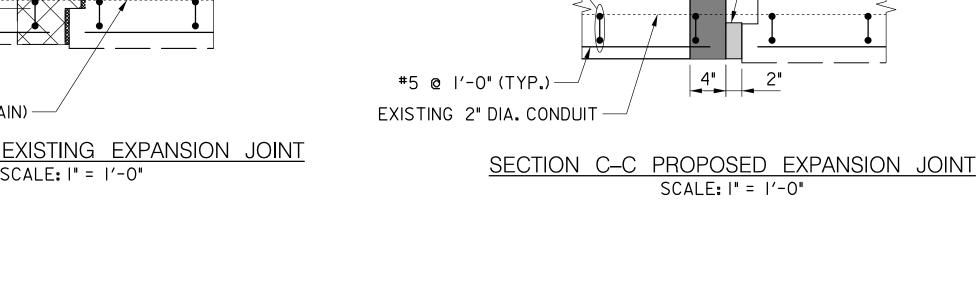

#5 @ I'-O"(TYP.)—

#5 | @ I'-0" (TYP.)-

NOTES:

PROPOSED PARAPET JOINT

SCALE: |" = |'-0"

-PROPOSED 21/2" X 2"
WABO EVAZOTE UV SEAL

NO. S-17

2'-0"±

PILASTER

|'-4"±

PROPOSED 21/2" X 2" WABO EVAZOTE UV SEAL

PROPOSED MIX NO.6 CONCRETE

PROPOSED 1/2" PREFORMED EXPANSION JOINT MATERIAL

INSERTED WITH EPOXY ADHESIVE -

EXISTING 2" DIA.

CONDUIT

EXISTING LIGHT POST (TO REMAIN)

> -EXISTING HAND HOLE BOX (TO REMAIN)

-PROPOSED 3⅓6"X 2¾"WABO EVAZOTE UV SEAL AT SIDEWALK, REFER TO DWG.

- I. REMOVAL LIMITS SHOWN ARE MINIMUM REQUIRED TO INSTALL NEW JOINT AT PARAPET/PILASTER. ADDITIONAL REMOVAL AND REPAIRS MAY BE NEEDED FOR ADJACENT CONCRETE SPALLING OR CRACK REPAIRS. SEE DWG. NO. S-18 FOR DETAILS ON ADDITIONAL REMOVAL AND REPAIRS FOR ADJACENT CONCRETE SPALLING OR CRACK REPAIRS.
- 2. MEASUREMENT AND PAYMENT FOR LIMITS OF REMOVAL AND RECONSTRUCTION SHOWN ON THIS SHEET SHALL BE PAID UNDER REPAIR OF CONCRETE PARAPET AT BRIDGE JOINTS PAY ITEM. ADDITIONAL CONCRETE SPALL AND CONCRETE CRACKING REPAIRS BEYOND THE LIMITS SHOWN ON THIS SHEET SHALL NOT BE PAID UNDER THE REPAIR OF CONCRETE PARAPET AT BRIDGE JOINTS PAY ITEMS AND SHALL BE PAID USING THE CONCRETE SPALL REPAIR OR CONCRETE CRACKING REPAIR PAY ITEMS.
- 3. EXISTING HORIZONTAL UTILITY CONDUITS ARE PRESENT IN THE PARAPETS. CARE SHALL BE TAKEN NOT DAMAGE THESE EXISTING CONDUITS. ANY DAMAGE TO THE EXISTING CONDUITS SHALL BE REPAIRED BY THE CONTRACTOR AT NO COST TO THE COUNTY.

OWNER/ADDRESS: DEPARTMENT OF TRANSPORTATION 100 EDISON PARK DRIVE

GAITHERSBURG, MARYLAND CONTACT: DIVISION OF TRANSPORTATION ENGINEERING CONSTRUCTION SECTION 240-777-7210 DESIGN SECTION 240-777-7221

MONTGOMERY COUNTY DEPARTMENT OF TRANSPORTATION GAITHERSBURG, MARYLAND RECOMMENDED FOR APPROVAL Chief, Design Section Date APPROVED Date Chief, Division of Transportation Engineering Checked by: MWM Drawn by: REVISION DATE

REHABILITATION OF BRIDGE NO. M-0229 ON BRIGHTON DAM ROAD OVER BRIGHTON DAM

S-15


0501907 SHEET 35 of 38 Project No. :



SCALE: |" = |'-0"


SCALE: |" = |'-0"

TYPE 3 PARAPET JOINT REPAIR

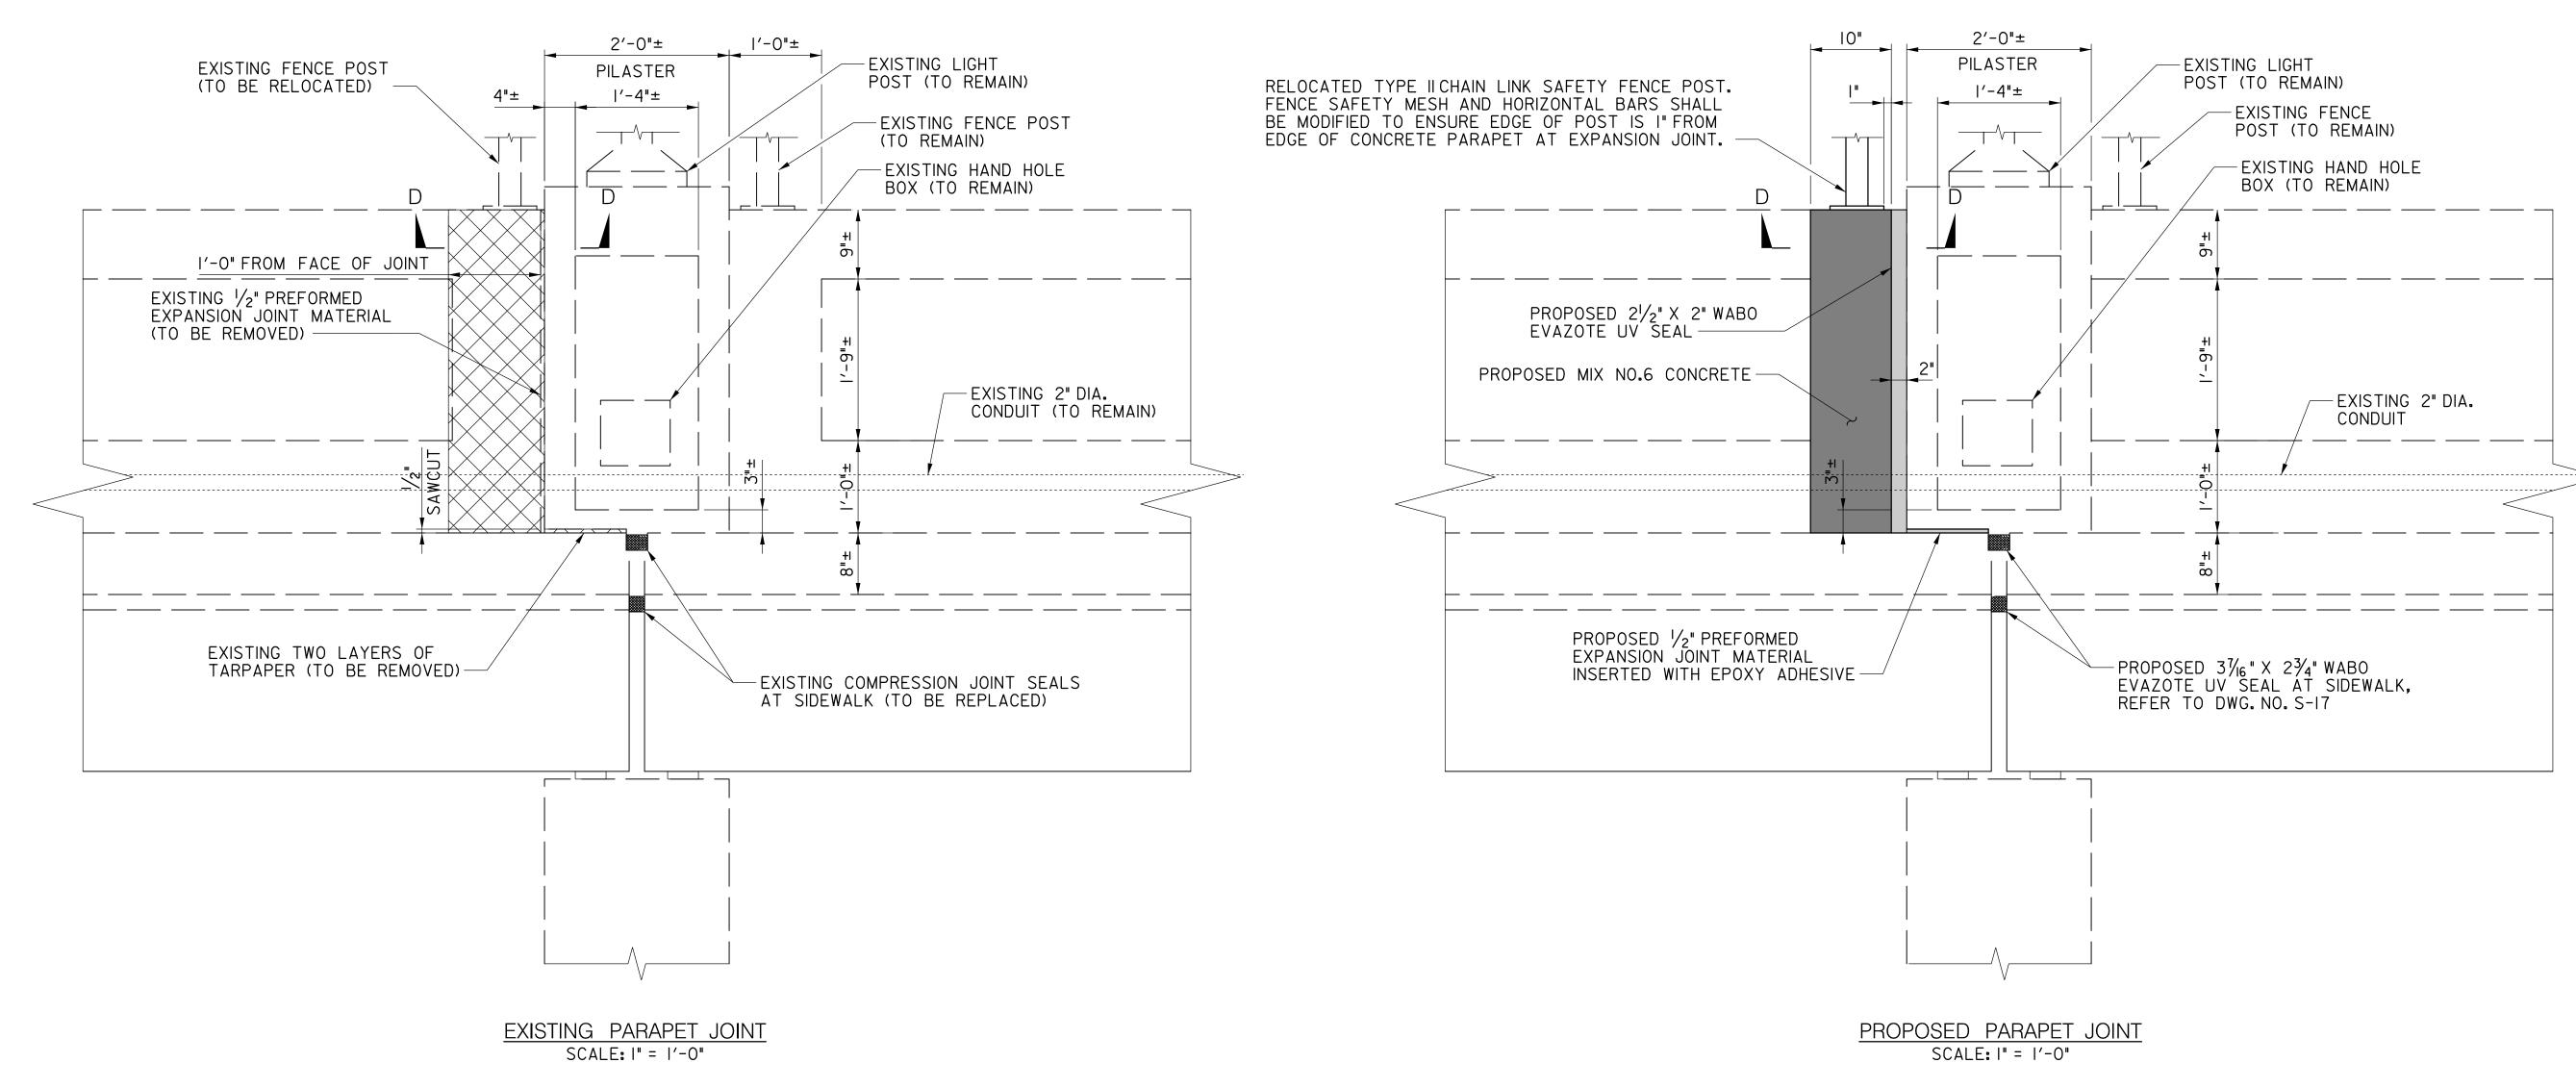



TYPICAL TYPE 4 DEFECT PHOTO PIER 7, SOUTH PARAPET NOT TO SCALE

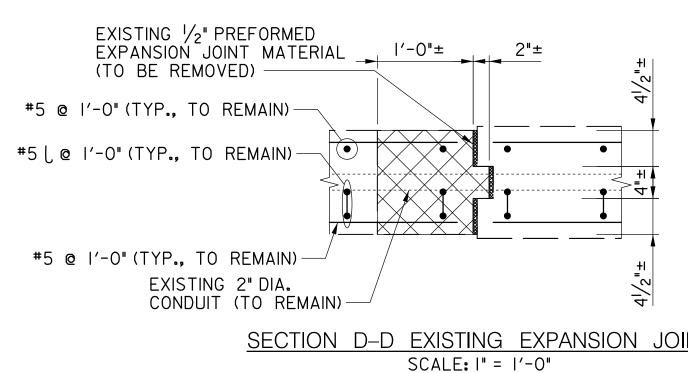

SECTION D-D EXISTING EXPANSION JOINT SCALE: |" = |'-0"

LEGEND:

PROPOSED MIX NO.6 CONCRETE

PROPOSED WABO EVAZOTE UV SEAL

LIMITS OF REMOVAL

-PROPOSED 21/2" X 2" WABO EVAZOTE UV SEAL -EXISTING 2" DIA. CONDUIT #5 @ I'-O"(TYP.)— #5 [, @ I'-0" (TYP.)-10" #5 @ I'-0"(TYP.)-

SECTION D-D PROPOSED EXPANSION JOINT

NOTES:

- I. REMOVAL LIMITS SHOWN ARE MINIMUM REQUIRED TO INSTALL NEW JOINT AT PARAPET/PILASTER. ADDITIONAL REMOVAL AND REPAIRS MAY BE NEEDED FOR ADJACENT CONCRETE SPALLING OR CRACK REPAIRS. SEE DWG. NO. S-18 FOR DETAILS ON ADDITIONAL REMOVAL AND REPAIRS FOR ADJACENT CONCRETE SPALLING OR CRACK REPAIRS.
- 2. MEASUREMENT AND PAYMENT FOR LIMITS OF REMOVAL AND RECONSTRUCTION SHOWN ON THIS SHEET SHALL BE PAID UNDER REPAIR OF CONCRETE PARAPET AT BRIDGE JOINTS PAY ITEM. ADDITIONAL CONCRETE SPALL AND CONCRETE CRACKING REPAIRS BEYOND THE LIMITS SHOWN ON THIS SHEET SHALL NOT BE PAID UNDER THE REPAIR OF CONCRETE PARAPET AT BRIDGE JOINTS PAY ITEMS AND SHALL BE PAID USING THE CONCRETE SPALL REPAIR OR CONCRETE CRACKING REPAIR PAY ITEMS.
- 3. EXISTING HORIZONTAL UTILITY CONDUITS ARE PRESENT IN THE PARAPETS. CARE SHALL BE TAKEN NOT DAMAGE THESE EXISTING CONDUITS. ANY DAMAGE TO THE EXISTING CONDUITS SHALL BE REPAIRED BY THE CONTRACTOR AT NO COST TO THE COUNTY.

S-16

PROFESSIONAL CERTIFICATION

I HEREBY CERTIFY THAT THESE DOCUMENTS WERE PREPARED OR APPROVED BY ME, AND THAT I AM A DULY LICENSED PROFESSIONAL ENGINEER UNDER THE LAWS OF THE STATE OF MARYLAND. LICENSE NO. <u>38931</u> EXPIRATION DATE <u>12-22-2023</u>

OWNER/ADDRESS: DEPARTMENT OF TRANSPORTATION 100 EDISON PARK DRIVE GAITHERSBURG, MARYLAND

MERCADO CONSULTANTS, INC.


CONTACT:	
DIVISION OF TRANSPORTATION	ENGINEERING
CONSTRUCTION SECTION	
240-777-7210	
DESIGN SECTION	
240-777-7221	

		T			
				MONTGOMERY COUNTY DEPARTMENT OF TRANSPORTATION GAITHERSBURG, MARYLAND	
				RECOMMENDED FOR APPROVAL	
				Chief, Design Section Date APPROVED	
				Chief, Division of Transportation Engineering Date	
NO.	REVISION	DATE	BY	Designed by: TK Drawn by: ZK Checked by: MWM	F

REHABILITATION OF BRIDGE NO. M-0229ON BRIGHTON DAM ROAD OVER BRIGHTON DAM

TYPE 4 PARAPET JOINT REPAIR

0501907 SHEET 36 of 38 Project No. :

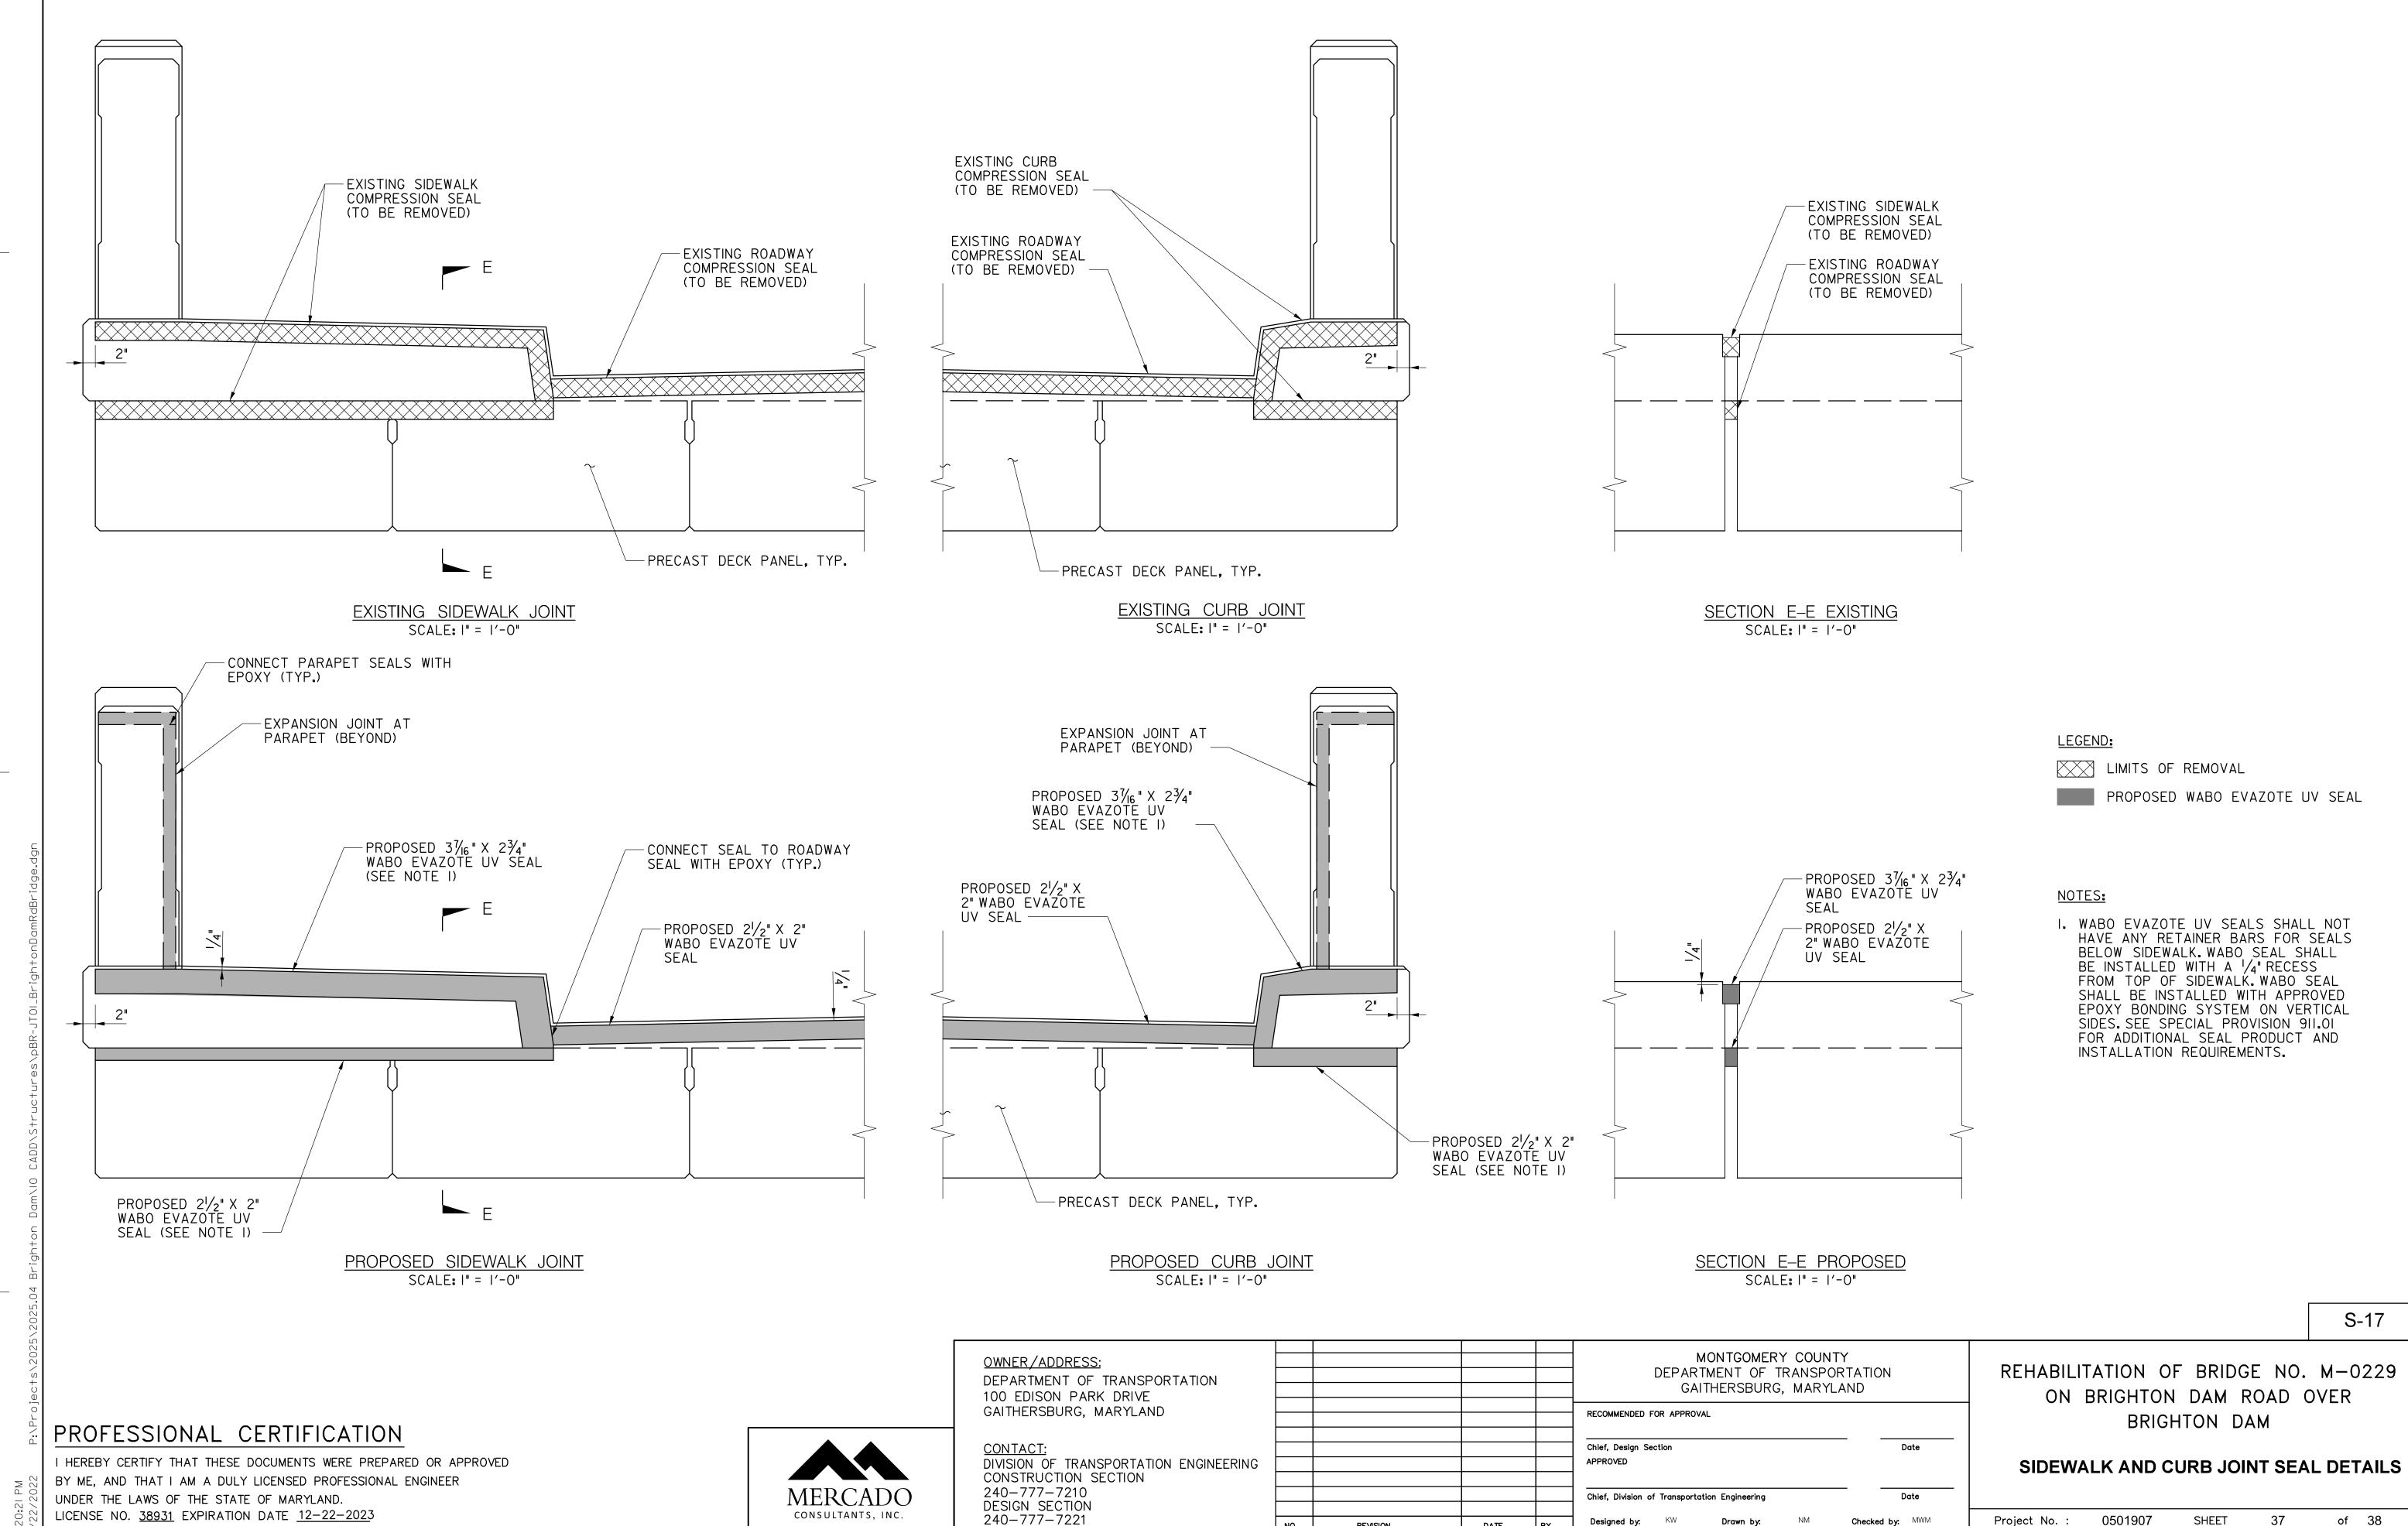

0501907

Project No. :

Checked by: MWM


Designed by: KW

DATE

REVISION

SHEET 37

of 38

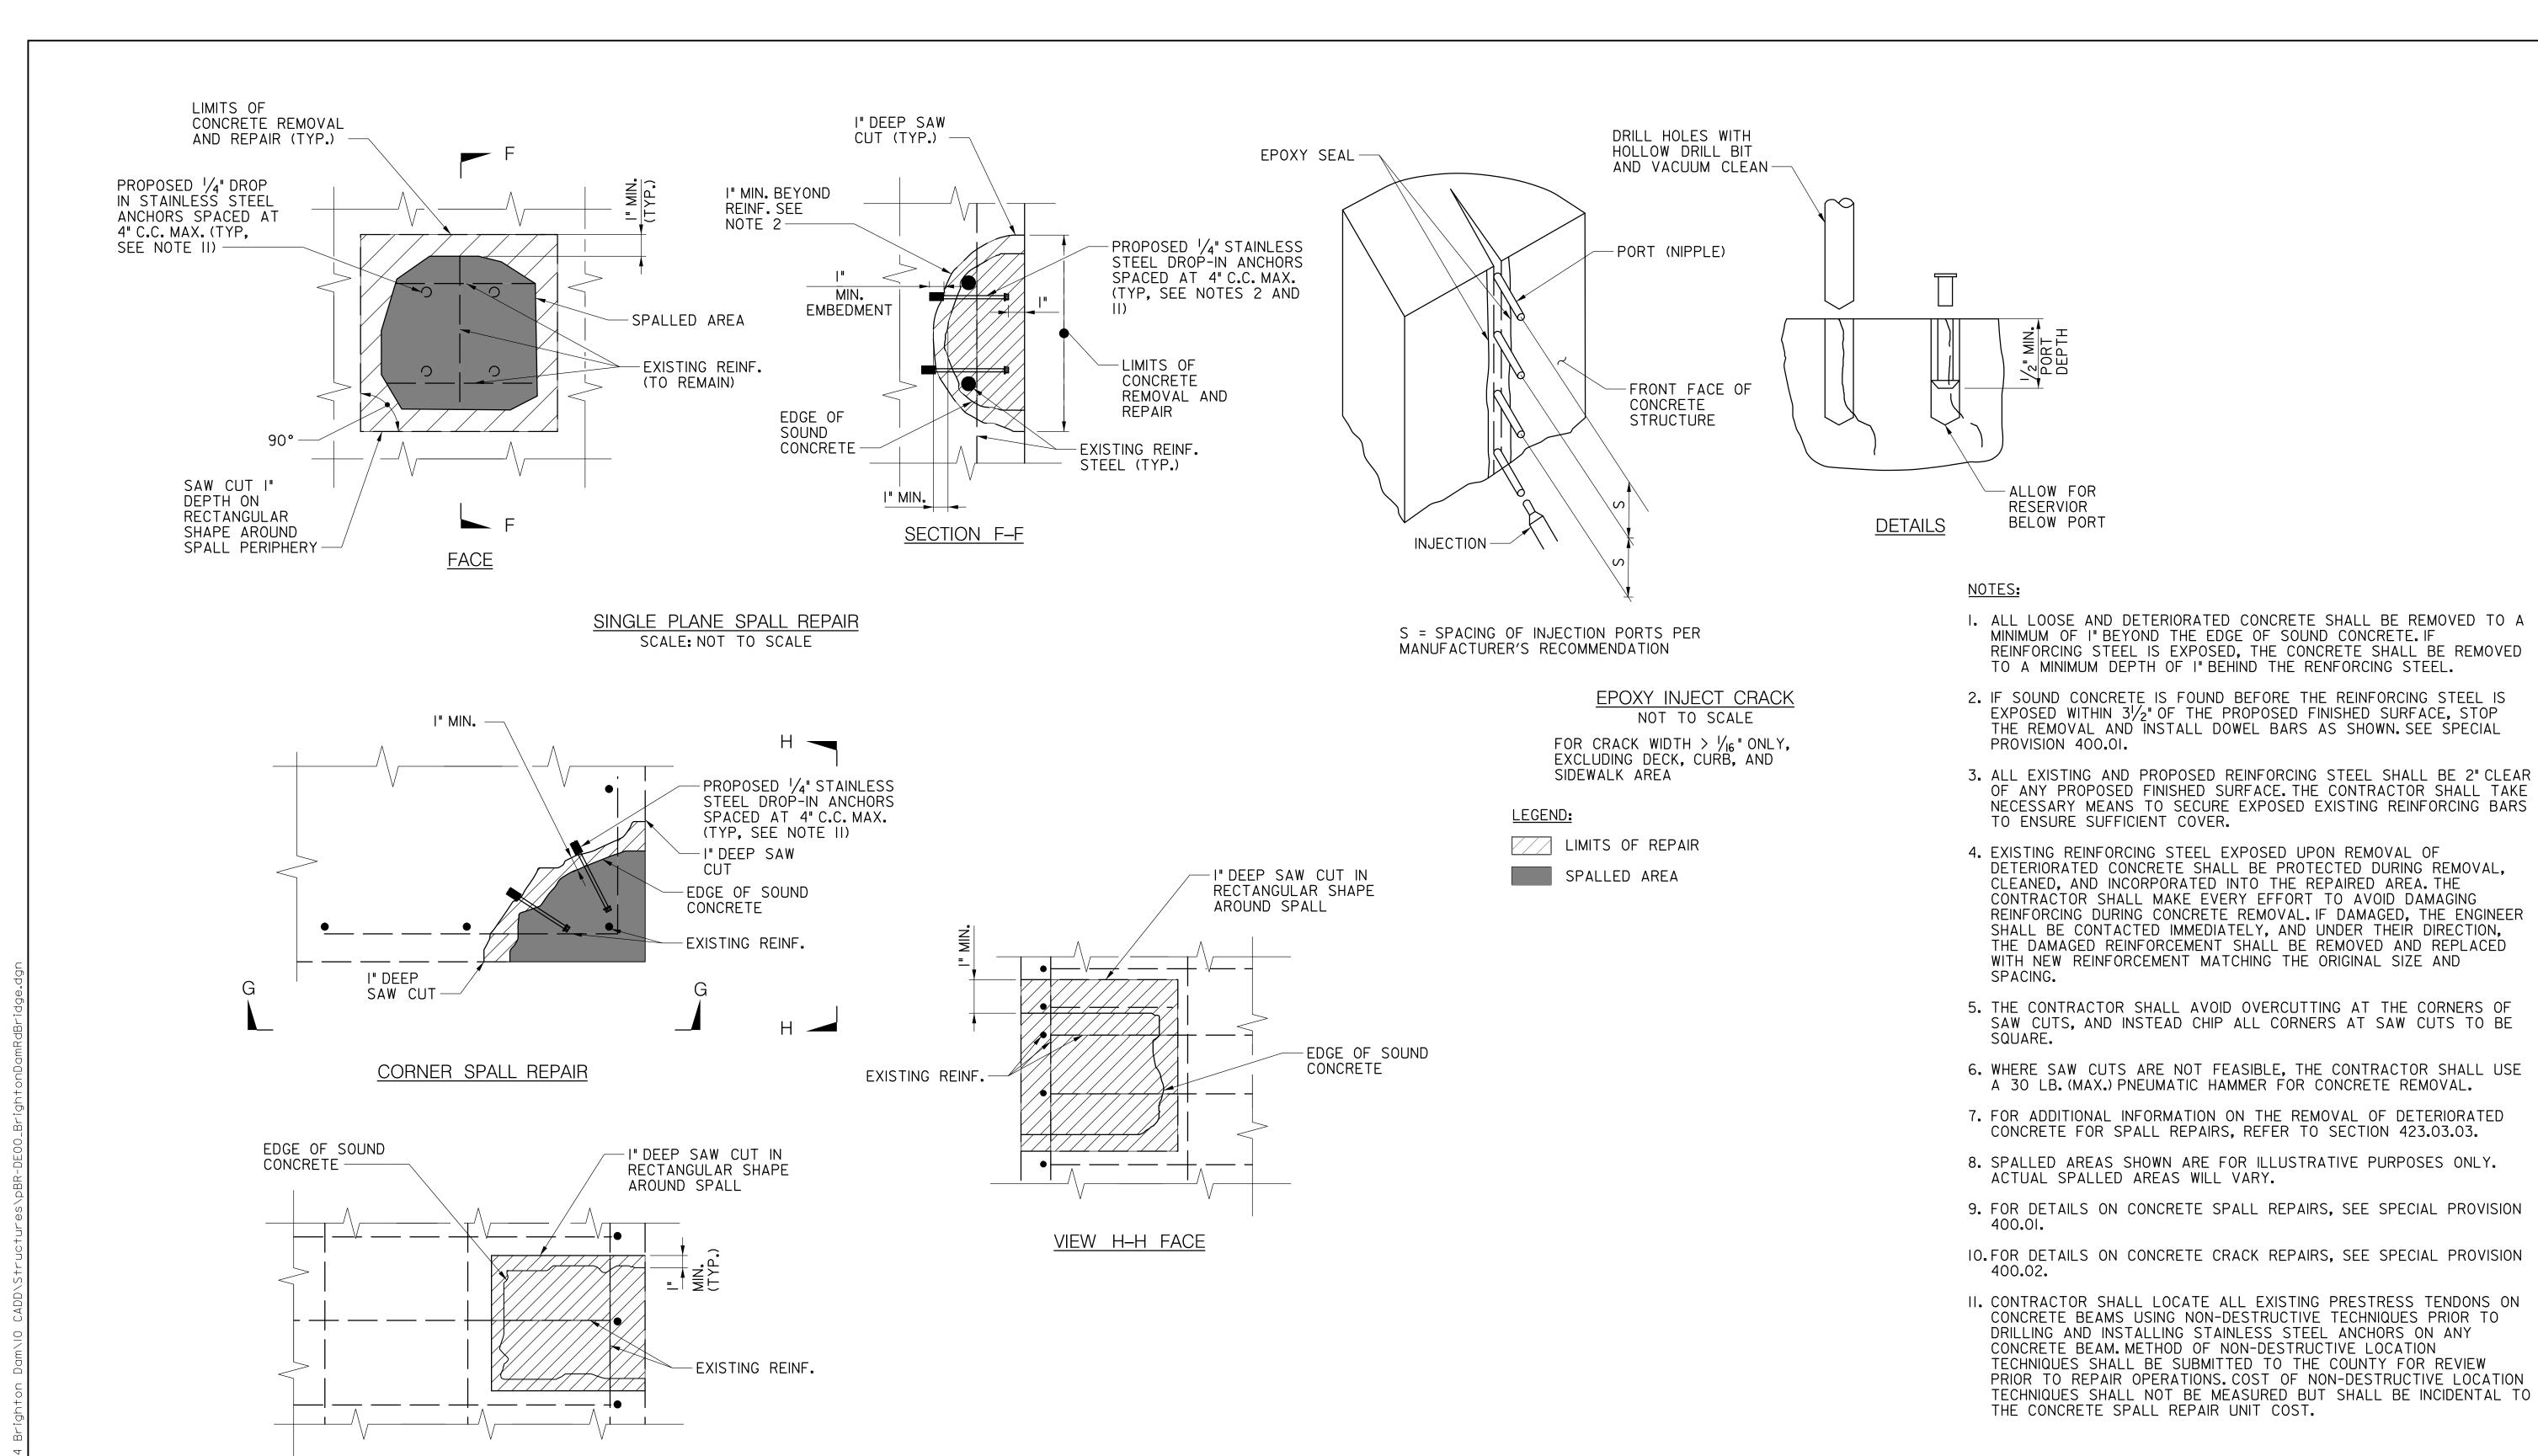

S-18

PROFESSIONAL CERTIFICATION

I HEREBY CERTIFY THAT THESE DOCUMENTS WERE PREPARED OR APPROVED BY ME, AND THAT I AM A DULY LICENSED PROFESSIONAL ENGINEER UNDER THE LAWS OF THE STATE OF MARYLAND. LICENSE NO. <u>38931</u> EXPIRATION DATE <u>12-22-2023</u>

VIEW G-G FACE



CORNER SPALL REPAIR SCALE: NOT TO SCALE

> OWNER/ADDRESS: DEPARTMENT OF TRANSPORTATION 100 EDISON PARK DRIVE GAITHERSBURG, MARYLAND

CONTACT: DIVISION OF TRANSPORTATION ENGINEERING CONSTRUCTION SECTION 240-777-7210 DESIGN SECTION 240-777-7221

MONTGOMERY COUNTY DEPARTMENT OF TRANSPORTATION GAITHERSBURG, MARYLAND RECOMMENDED FOR APPROVAL Chief, Design Section Date APPROVED Chief, Division of Transportation Engineering Date Checked by: MWM REVISION DATE

REHABILITATION OF BRIDGE NO. M-0229 ON BRIGHTON DAM ROAD OVER BRIGHTON DAM

CONCRETE SPALL REPAIR DETAILS

0501907 of 38 Project No. : SHEET 38