THE FOLLOWING MARYLAND STANDARD (CONSTRUCTION AND TEMPORARY TRAFFIC CONTROL) DETAILS ARE REQUIRED FOR THE PROJECT:

MD 104.03-02 - SHOULDER WORK/MULTILANE UNDIV. EQUAL/LESS THAN 40 MPH MD 104.05-15 - STANDARD RAMP

MD 381.01 - STANDARD YARD INLET

MD 580.03 - NEW COMBINATION CURB AND GUTTER PLACEMENT ALONG EXISTING

MD 620.02-01 - STANDARD TYPES C AND D CONCRETE CURB AND COMBINATION CONCRETE CURB & GUTTER

MD 630.02 -STANDARD ENTRANCE CONSTRUCTION RESIDENTIAL AND COMMERCIAL, METHOD NO. 2

MD 655.40 - DETECTABLE WARNING SURFACES

FOR ALL STANDARDS REFERRED TO ON THE PLANS, THE CONTRACTOR MUST GO TO THE BOOK OF STANDARDS WHICH WILL HAVE THE MOST CURRENT VERSION. THE BOOK OF STANDARDS CAN BE ACCESSED AT: https://apps.roads.maryland.gov/BusinessWithSHA/ bizStdsSpecs/desManualStdPub/publicationsonline/ohd/bookstd/index.asp. ALL ITEMS ARE TO BE CONSTRUCTED IN ACCORDANCE WITH THE CURRENT VERSION OF THE REFERENCED STANDARD AT THE TIME OF CONSTRUCTION.

		INDEX OF SHEETS
SHEET NO.	DRAWING NO.	SHEET NAME
	TI-OI	TITLE SHEET
2	GN-01	GENERAL NOTES, STANDARD SYMBOLS, & ABBREVIATIONS
2 3	GS-01	GEOMETRIC LAYOUT
4	TS-01	TYPICAL SECTION & PAVING DETAILS
5 6 7	PS-0I	ROADWAY PLAN
6	PR-01	ROADWAY PROFILE
	GR-01	GRADING PLAN
8	LN-OI	LANDSCAPING PLAN
9	LN-02	LANDSCAPING NOTES & DETAILS
10	LT-OI	LIGHTING PLAN
II	LT-02	LIGHTING NOTES & DETAILS
12	MT-OI	MAINTENANCE OF TRAFFIC GENERAL NOTES
13	MT-02	MAINTENANCE OF TRAFFIC PLAN
14	MT-03	MAINTENANCE OF TRAFFIC PLAN
15	MT-04	MAINTENANCE OF TRAFFIC PLAN
16	MT-05	MAINTENANCE OF TRAFFIC PLAN
17	MT-06	MAINTENANCE OF TRAFFIC PLAN
18	MT-07	MAINTENANCE OF TRAFFIC PLAN
19	MT-08	MAINTENANCE OF TRAFFIC PLAN
20	SN-00	SIGNING & PAVEMENT MARKING NOTES
21	SN-01	SIGNING & PAVEMENT MARKING PLAN
22	SN-02	SIGNING & PAVEMENT QUANTITIES
23	XS-01	ROADWAY CROSS SECTIONS
24	XS-02	ROADWAY CROSS SECTIONS
25	XS-03	ROADWAY CROSS SECTIONS
26	XS-04	ROADWAY CROSS SECTIONS
27	XS-05	ROADWAY CROSS SECTIONS
28	XS-06	ROADWAY CROSS SECTIONS

OWNER'S CERTIFICATION

I HEREBY CERTIFY THAT ALL CLEARING, GRADING, CONSTRUCTION AND/OR DEVELOPMENT WILL BE DONE PURSUANT TO THIS PLAN AND THAT ANY RESPONSIBLE PERSONNEL INVOLVED IN THE CONSTRUCTION PROJECT WILL HAVE A CERTIFICATE OF ATTENDANCE AT A DEPARTMENT OF NATURAL RESOURCES APPROVED TRAINING PROGRAM FOR THE CONTROL OF SEDIMENT AND EROSION BEFORE BEGINNING THE PROJECT.

DATE

TIMOTHY H. CUPPLES, P.E. CHIEF, DIVISION OF TRANSPORTATION ENGINEERING

DESIGN CERTIFICATION

I HEREBY CERTIFY THAT THIS PLAN HAS BEEN PREPARED IN ACCORDANCE WITH THE "2011 MARYLAND STANDARDS AND SPECIFICATIONS FOR SOIL EROSION AND SEDIMENT CONTROL", MONTGOMERY COUNTY DEPARTMENT OF PERMITTING SERVICES EXECUTIVE REGULATIONS 5-90, 7-02AM AND 36-90, AND MONTGOMERY COUNTY DEPARTMENT OF TRANSPORTATION "STORM DRAIN DESIGN CRITERIA" DATED AUGUST 1988.

I FURTHER CERTIFY THAT THE ESTIMATED TOTAL AMOUNTS OF EXCAVATION AND FILL AS SHOWN ON THESE PLANS HAS BEEN COMPUTED TO BE 342 CUBIC YARDS OF EXCAVATION AND 200 CUBIC YARDS OF FILL AND THAT THE TOTAL AREA TO BE DISTURBED AS SHOWN ON THESE PLANS HAS BEEN DETERMINED TO BE 17,947 SQUARE FEET.


2021-09-22

DATE


LORI R. ADGATE, P.E. MD. REGISTRATION NO.28255

MONTGOMERY COUNTY, MARYLAND DEPARTMENT OF TRANSPORTATION WHITE FLINT METRO STATION ACCESS IMPROVEMENTS

PHASE 1 – SIDEWALK RECONSTRUCTION C. I. P. PROJECT NO. 502106 SHA TRACKING NO. 21-AP-MO-003-21

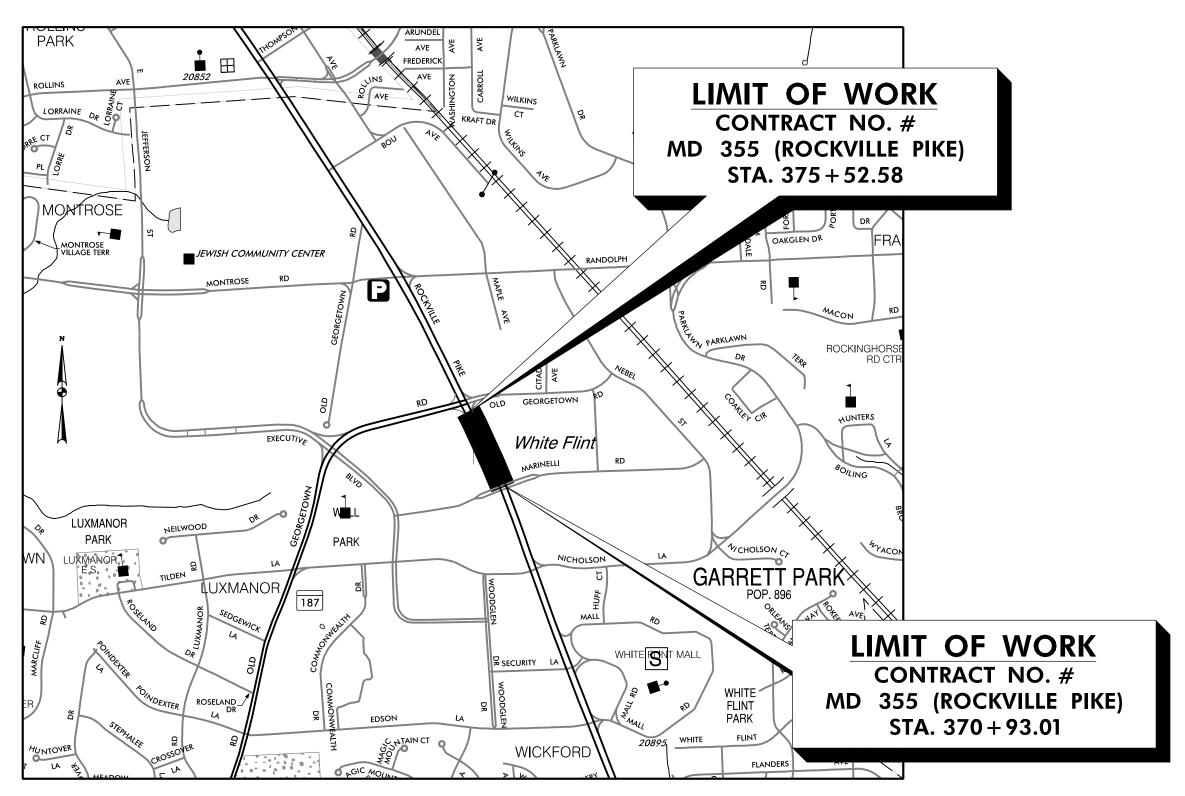

VICINITY MAP SCALE: 1'' = 1000'

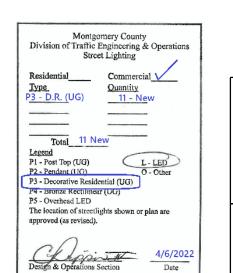

ALL AREAS OF SHA PROPERTY AND PROPERTY TO BE DEDICATED TO SHA SHALL BE RESTORED IN CONFORMANCE WITH SHA STANDARD SPECIFICATIONS, EXCEPT AS NECESSARY FOR WORK FOR WHICH THERE ARE NO SHA STANDARD SPECIFICATIONS.

PRIOR TO VEGETATIVE STABILIZATION, ALL DISTURBED AREAS MUST BE TOPSOILED PER THE MONTGOMERY COUNTY "STANDARDS AND SPECIFICATIONS FOR TOPSOIL"

PROFESSIONAL CERTIFICATION: I HEREBY CERTIFY THAT THESE DOCUMENTS WERE PREPARED OR APPROVED BY ME, AND THAT I AM A DULY LICENSED PROFESSIONAL ENGINEER UNDER THE LAWS OF THE STATE OF MARYLAND. LICENSE NO: 28255 EXPIRATION DATE: 6-30-2022

PROJECT MANAGER REBECCA PARK 100 Edison Park Drive, 4th Floor Gaithersburg, MD 20878 240-777-7263 rebecca.park@montgomerycountymd.gov

SE OF MAAL RECOMME ORI R. ADGY Y. REVISION DATE Chief. APPROVE 28255 Chief.

APPROVED

Mar 18 2022

District 3

Access Management

IT IS THE RESPONSIBILTY OF PERMITTEE/OWNER OF THIS SITE TO OBTAIN ALL REQUIRED PERMITS PRIOR TO ISSUANCE OF THE APPROVED SEDIMENT CONTROL PERMIT XPRIATION WORK
DATE RESTRICTION DATES PERMIT # Floodplain District WATERWAYS/WETLAND(S): Corps of Engineers MDE MDE Dam Safety *DPS Roadside Trees N.P.D.E.S. NOTICE OF INTENT FEMA LOMR (Required Post Construction OTHERS: DPS Erosion XXXXXX X XXXXX * A copy of the Roadside Trees Protection Plan must be delivered to the sediment control inspector at the preconstruction meeting. OWNER/PERMIT APPLICANT INFORMATION

RELATED REQUIRED PERMITS

MONTGOMERY COUNTY DEPARTMENT OF TRANSPORTATION 100 EDISON PARK DRIVE, GAITHERSBURG, MD 20878 <u>(240)</u> 777-7209 PHONE NUMBER:

CONTACT PERSON: TIMOTHY H. CUPPLES, P.E.

PS&E SUBMITTAL SEPT 2021

PPROVALS:		
RAFFIC CONTROL PLANS	SIGNATURE	DATE
LIGHTING PLANS	Cedric Ward SIGNATURE	3/15/2022 DATE
SIGNING & PAVEMENT MARKING PLANS	Cedric Ward SIGNATURE	3/15/2022 DATE
TRAFFIC SIGNAL PLANS	SIGNATURE	DATE

MONTGOMERY COUNTY DEPARTMENT OF TRANSPORTATION DIVISION OF TRANSPORTATION ENGINEERING GAITHERSBURG, MARYLAND	WHITE FLINT METRO STATION ACCESS IMPROVEMENTS
RECOMMENDED FOR APPROVAL	TITLE SHEET
Chief, Design Section Date APPROVED	
Chief, Division of Transportation Engineering Date	SCALE: N.T.S. DATE: SEPT 2021
Designed by :	Project No. : 502106 SHEET 01 of 28

GENERAL NOTES

- I. THE SPECIFICATIONS FOR THIS CONTRACT WILL BE THOSE OF THE MARYLAND STATE HIGHWAY ADMINISTRATION DATED JULY 2020, ALL ERATA AND ADDENDA THERETO. THE MARYLAND STATE HIGHWAY ADMINISTRATION BOOK OF STANDARDS FOR HIGHWAY AND INCIDENTAL STRUCTURES, AND SOIL CONSERVATION SERVICE POND CONSTRUCTION SPECIFICATIONS FOR MARYLAND.
- 2. FOR CONSTRUCTION, HORIZONTAL SHALL BE BASED ON NAD 83/91DATUM AND VERTICAL SHALL BE BASED ON NAVD 1988 DATUM.
- 3. INFORMATION CONCERNING UNDERGROUND UTILITIES WAS OBTAINED FROM AVAILABLE RECORDS, BUT THE CONTRACTOR MUST DETERMINE THE EXACT LOCATIONS AND ELEVATIONS OF THE LINES BY DIGGING TEST PITS BY HAND AT ALL UTILITY CROSSINGS, WELL IN ADVANCE OF TRENCHING. IF CLEARANCES ARE LESS THAN SHOWN OR SIX (6) INCHES, WHICHEVER IS LESS, CONTACT MONTGOMERY COUNTY DEPARTMENT OF TRANSPORTATION'S PROJECT INSPECTOR AND THE APPROPRIATE UTILITY OWNER BEFORE PROCEEDING WITH CONSTRUCTION.
- 4. REPAIRS TO UTILITIES OR PROPERTY DAMAGE AS A RESULT OF THE CONTRACTOR'S NEGLIGENCE OR METHOD OF OPERATION MUST BE MADE AT THE CONTRACTOR'S EXPENSE BEFORE PROCEEDING WITH CONSTRUCTION.
- 5. CALL "MISS UTILITY" AT I-800-257-7777 FORTY-EIGHT (48) HOURS PRIOR TO BEGINNING EXCAVATION TO DETERMINE THE EXACT LOCATION OF EXISTING UTILITIES.
- 6. CLEARING IS TO BE LIMITED TO THE "LIMIT OF DISTURBANCE" AS SHOWN ON THE PLANS.
- 7. ALL GRADING SHALL BE DONE IN SUCH A MANNER AS TO PROVIDE POSITIVE DRAINAGE.
- 8. THE CONTRACTOR SHALL OBTAIN A ROADSIDE TREE PERMIT FOR ANY MAINTENANCE, TREATMENT, PLANTING, REMOVAL, OR ROOT CUTTING ON TREES WITHIN THE PUBLIC RIGHT OF WAY. PERMIT REQUIREMENTS MAY BE OBTAINED FROM THE DEPARTMENT OF NATURAL RESOURCES, MARYLAND FOREST, PARK AND WILDLIFE SERVICE, TELEPHONE 301-854-6060.
- 9. THE LOCATION OF RIGHT-OF-WAY AND EASEMENT LINES SHOWN ON THE PLANS ARE FOR INFORMATION AND GUIDANCE ONLY. NO GUARANTEE IS MADE AS TO THE ACCURACY OF SAID LOCATIONS. PLEASE REFER TO THE APPROPRATE RIGHT-OF-WAY PLATS.
- IO. THE CONTRACTOR SHALL INSTALL PEDESTRIAN DETECTABLE WARNING SURFACES AT ALL SIDEWALK & PEDESTRIAN CROSSINGS. LOCATIONS AS DIRECTED BY THE ENGINEER. THE WARNING SURFACES SHALL BE IN CONFORMANCE WITH ADA REQUIREMENTS AND THE PROJECT SPECIAL PROVISION.
- II. THE DESIGN FOR THIS PROJECT HAS INCORPORATED FACILITIES FOR THE ELDERLY AND HANDICAPPED IN COMPLIANCE WITH STATE AND FEDERAL LEGISLATION.

ABBREVIATIONS

A.A.S.H.T.O American Association of State	EEast	L.L. Liquid Limit	PROPProposed	STDStandard
Highway Transportation Officials	EElectric	LODLimit of Disturbance	PRCPoint of Reverse Curve	STAStation
ABANAbandoned	e External Distance	LONGLongitudinal	PTPoint	STIFF Stiffener
ABUTAbutment	EA Each	L.P. Light Pole	PTPoint of Tangency	SOSingle Opening
ADTAverage Daily Traffic	E.BEastbound	LTLeft	PVCPoint of Vertical Curve	S.YSquare Yards
AHD Ahead	E.J Expansion Joint	MAC Macadam	P.V.C Polyvinyl Chloride	SWMStormwater Management
APPROX Approximate	EL. or ELEV Elevation	MAX Maximum	PVIPoint of Vertical Intersection	TTangent
₽ or B/LBaseline	E.R.C.C.PElliptical Reinforced Cement	MB Micro Bio	PVRC Point of Vertical Reverse Curve	TTelephone
BKBack /Book	Concrete Pipe	MC Moisture Content	PVTPoint of Vertical Tangency	T.CTop of Cover
BITBituminous	ESEnd Section	MDD Maximum Dry Content	R Radius	TEMP Temporary
B.CBituminous Concrete	EX. or EXIST Existing	MOD Modified	REINF Reinforcement	T.GTop of Grate
B.MBench Mark	FTFeet	MIN Minimum	REQ'DRequired	T.B.R To Be Removed
B.O.F. Bottom of Footing	F or FL Flowline	MN Managed Roadway	R.F Rock Fragments	T or TLTraverse Line
BOTBottom	F.B.D Flat Bottom Ditch	M.S.E Mechanically Stablilized Earth	RT Right	T.MTop of Manhole
BRGBearing	F.HFire Hydrant	N North	RW or R/W Right of Way	T.O.FTop of Footing
C.C Center of Curve	F.OFiber Optic	NB Northbound	R.C.P Reinforced Cement Pipe	TRAV Traverse
CATV Cable Television	F.SFull Super Elevation	NE Northeast	R.C.C.P Reinforced Cement Concrete Pipe	TSTemporary Swale
C.B.RCalifornia Bearing Ratio	FWD Forward	NO Number	R.Q.DRock Quality Desgnation	T.STop of Slab
C.JContraction Joint	GGas	NP Non-Plastic	R.MRootmat	T.STopsoil
C _I or C/L Centerline	GLGutterline	N.T.SNot To Scale	SSouth	TYPTypical
CĒClass or Clear	GPGeneral Purpose Roadway	O.COn Center	SANSanitary Sewer	U.DUnder Drain
CLFChainlink Fence	G.VGas Valve	OHOverhead	SB or S/B Southbound	U.GUnderground
CMP Corrugated Metal Pipe	H.BHandbox	OMCOptimum Moisture	S.DStorm Drain	U.O.N Unless Otherwise Noted
C.OCleanout	H.D.PHigh Density Polyetheylene	PAV'TPavement	S.D.DSurface Drain Ditch	U.PUtility Pole
COMBCombination	HDWLHeadwall	PC Point of Curvature	SESuper Elevation	USC Unified Soil Classification
CONC Concrete	H.E.R.C.P Horizontal Elliptical Reinforced	PCC Point of Compound Curvature	SFSilt Fence	USDAUnited States Department of Agriculture
CONSTRConstruction	Concrete Pipe	P/CPoint of Crown	S.FSquare Feet	VCLVertical Clearance
CORCorner	H.PHigh Point	P/GE Profile Grade Elevation	SHLDR Shoulder	V.C.LVertical Curve Length
CORRCorrection	H.S.D Headlight Sight Distance	P.G.L. Profile Grade Line	SHAState Highway Administration	WWater
C.YCubic Yard	INInch	P/GL Profile Ground Line	SHA MBState Highway Administration Micro Bio	WWest
DC Degree of Curve	I.S.TInlet Sediment Trap	PPlate	SHTSheet	W.BWestbound
D.H.V Design Hourly Volume	INVInvert	P/RPoint of Rotation	S.P.PStructural Plate Pipe	WBWetland Buffer
D.I Drop Inlet	J.BJunction Box	P.IPlasticity Index	S.P.TStandard Penetration Testing	W.M Water Meter
DIA Diameter	KK Inlet	P.IPoint of Intersection	S.SStainless Steel	W.SWrapped Steel
D.O Double Opening	LLength	POCPoint On Curve	SSDStopping Sight Distance	
D.SDesign Speed	L.F. Linear Feet	POTPoint On Tangent	SSFSuper Silt Fence	

EXISTING CONTOUR (MAJOR) __

SYMBOLS

XISTING RIGHT OF WAY LINE ROPOSED RIGHT OF WAY LINE		LIMIT OF DISTURBANCESILT FENCE	
ROPOSED TRAFFIC BARRIER	······	SUPER SILT FENCE	
XISTING TRAFFIC BARRIER		DIVERSION FENCE	• • • • • • • • • • • • • • • • • • • •
XISTING WOOD FENCE LINE	·····	STONE CHECK DAM	•
XISTING CHAIN LINK FENCE LINE	X		204
ASE OR SURVEY LINE	31 +50 32	TEMPORARY STONE OUTLET STRUCTURE	1303
XISTING FIRE HYDRANT		TEMPORARY GABION OUTLET STRUCTURE	4089 CW 1003
ROPOSED STORM DRAIN	Li Li	AT-GRADE INLET PROTECTION	
ROPOSED STORM DRAIN INLET		CURB INLET PROTECTION	
ROPOSED STORM DRAIN MANHOLE		MEDIAN INLET PROTECTION	1 1VIIT
XISTING STORM DRAIN		STANDARD INLET PROTECTION	1 1317
XISTING INLET		COMBINATION INLET PROTECTION	COIP
XISTING UTILITY POLE		STABILIZED CONSTRUCTION ENTRANCE	S SCE
XISTING TREE	·	PROPOSED UTILITY POLE	
XISTING TREE LINE		PROPOSED UTILITY CONDUIT	
UT SLOPE		PROPOSED UTILITY VAULT	
ILL SLOPE		EXISTING GAS	
TREET LIGHT	*	EXISTING WATER	•
TREET LIGHT HANDBOX		EXISTING SEWER	
TREET LIGHT CONDUIT		EXISTING FIBER OPTIC	
XISTING CONTOUR (MINOR)	— — — —	EXISTING FIDER OF HO	F0 —

SHA TRACKING NO. 21-AP-MO-003-21

••••]				MONTGOMERY COUNTY DEPARTMENT OF T DIVISION OF TRANSPORTATION ENG GAITHERSBURG, MARYLAND	INEERING	WHITE FLINT M ACCESS IMP	
AAL YELL	NO.	REVISION	DATE	BY	RECOMMENDED FOR APPROVAL SEE TITLE SHEET FOR SIGNATURES Chief, Design Section APPROVED	Date	GENERAL SYMBOLS AND	•
NON					SEE TITLE SHEET FOR SIGNATURES Chief, Division of Transportation Engineering	Date	SCALE: NO-SCANE	DATE : SEPT 2021
= 14					Designed by : Drawn by :	Checked by :	Project No. : 502106	SHEET 02 of 28





I HEREBY CERTIFY THAT THESE DOCUMENTS WERE PREPARED OR APPROVED BY ME, AND THAT I AM A DULY LICENSED PROFESSIONAL ENGINEER UNDER THE LAWS OF THE STATE



PROFESSIONAL CERTIFICATION: OF MARYLAND. LICENSE NO: 28255 EXPIRATION DATE: 6-30-2022

DWG. Drawing

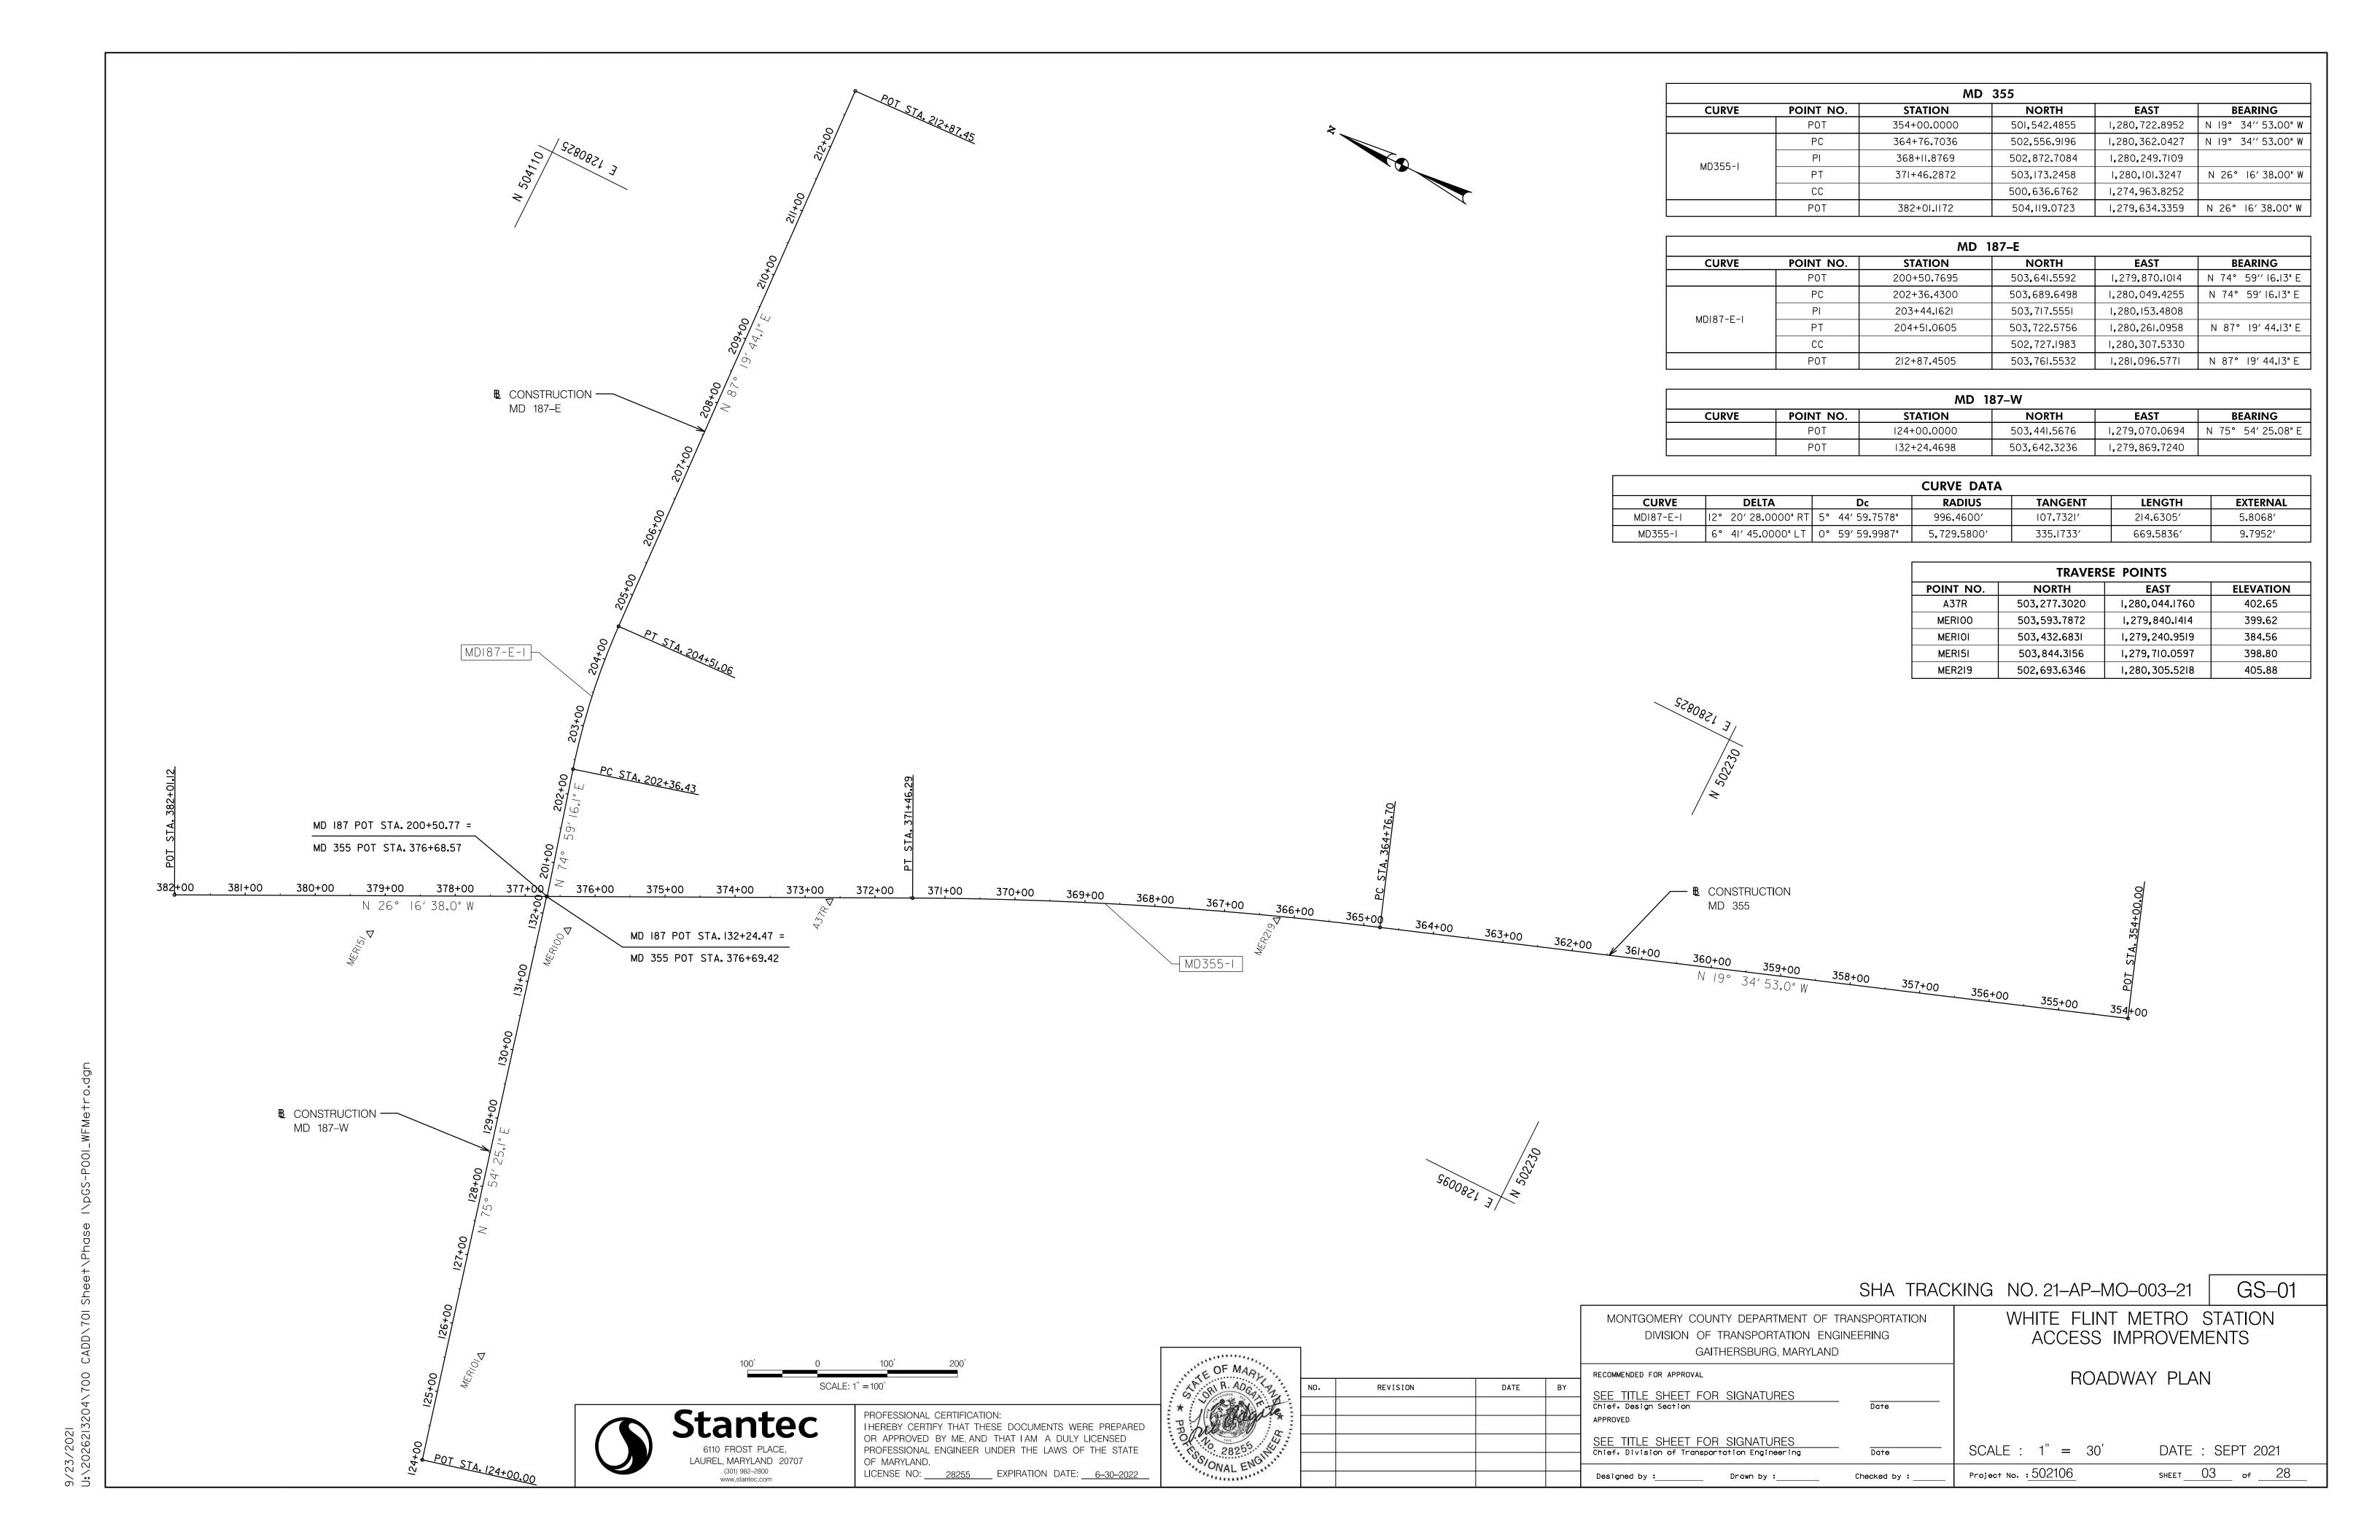

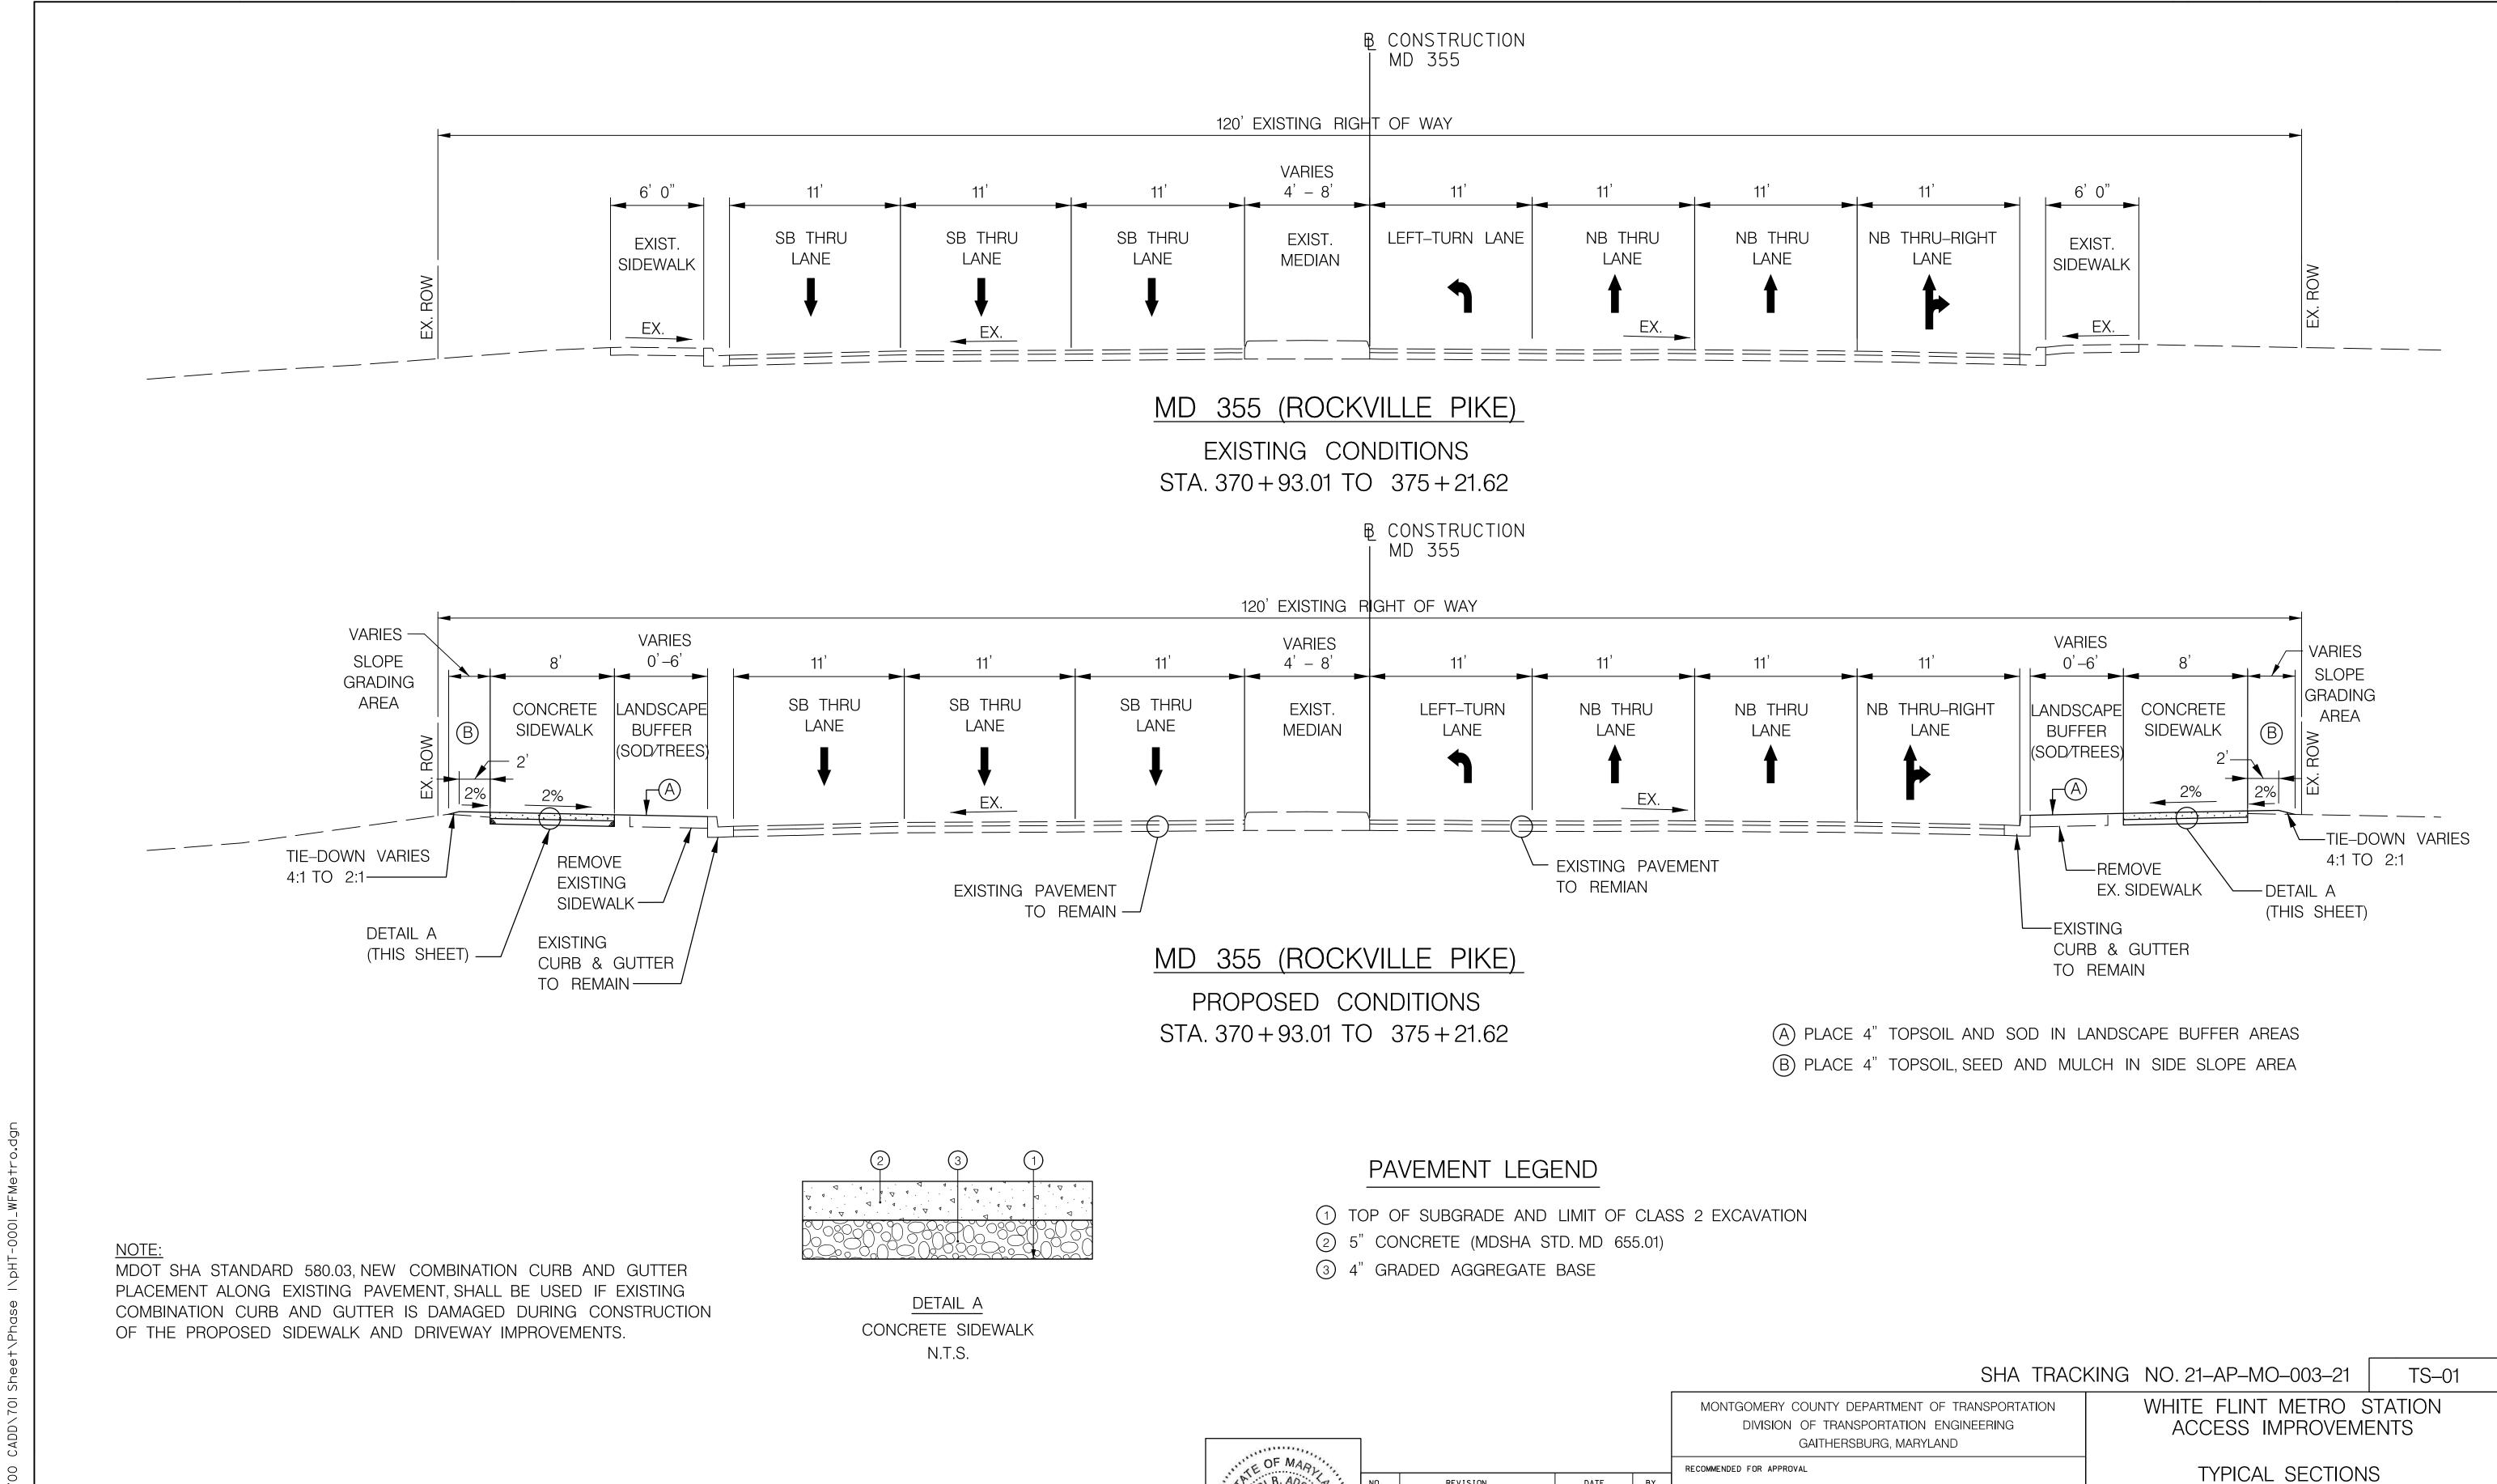

Stantec

LAUREL, MARYLAND 20707

SCALE: 1'' = 5'

PROFESSIONAL CERTIFICATION:
I HEREBY CERTIFY THAT THESE DOCUMENTS WERE PREPARED
OR APPROVED BY ME, AND THAT I AM A DULY LICENSED

PROFESSIONAL ENGINEER UNDER THE LAWS OF THE STATE

LICENSE NO: 28255 EXPIRATION DATE: 6-30-2022

SEE TITLE SHEET FOR SIGNATURES Chief, Design Section

SEE TITLE SHEET FOR SIGNATURES
Chief, Division of Transportation Engineering

Drawn by:_


Checked by :

SCALE : 1" = 5"

Project No. : 502106

DATE: SEPT 2021

SHEET 04 of 28

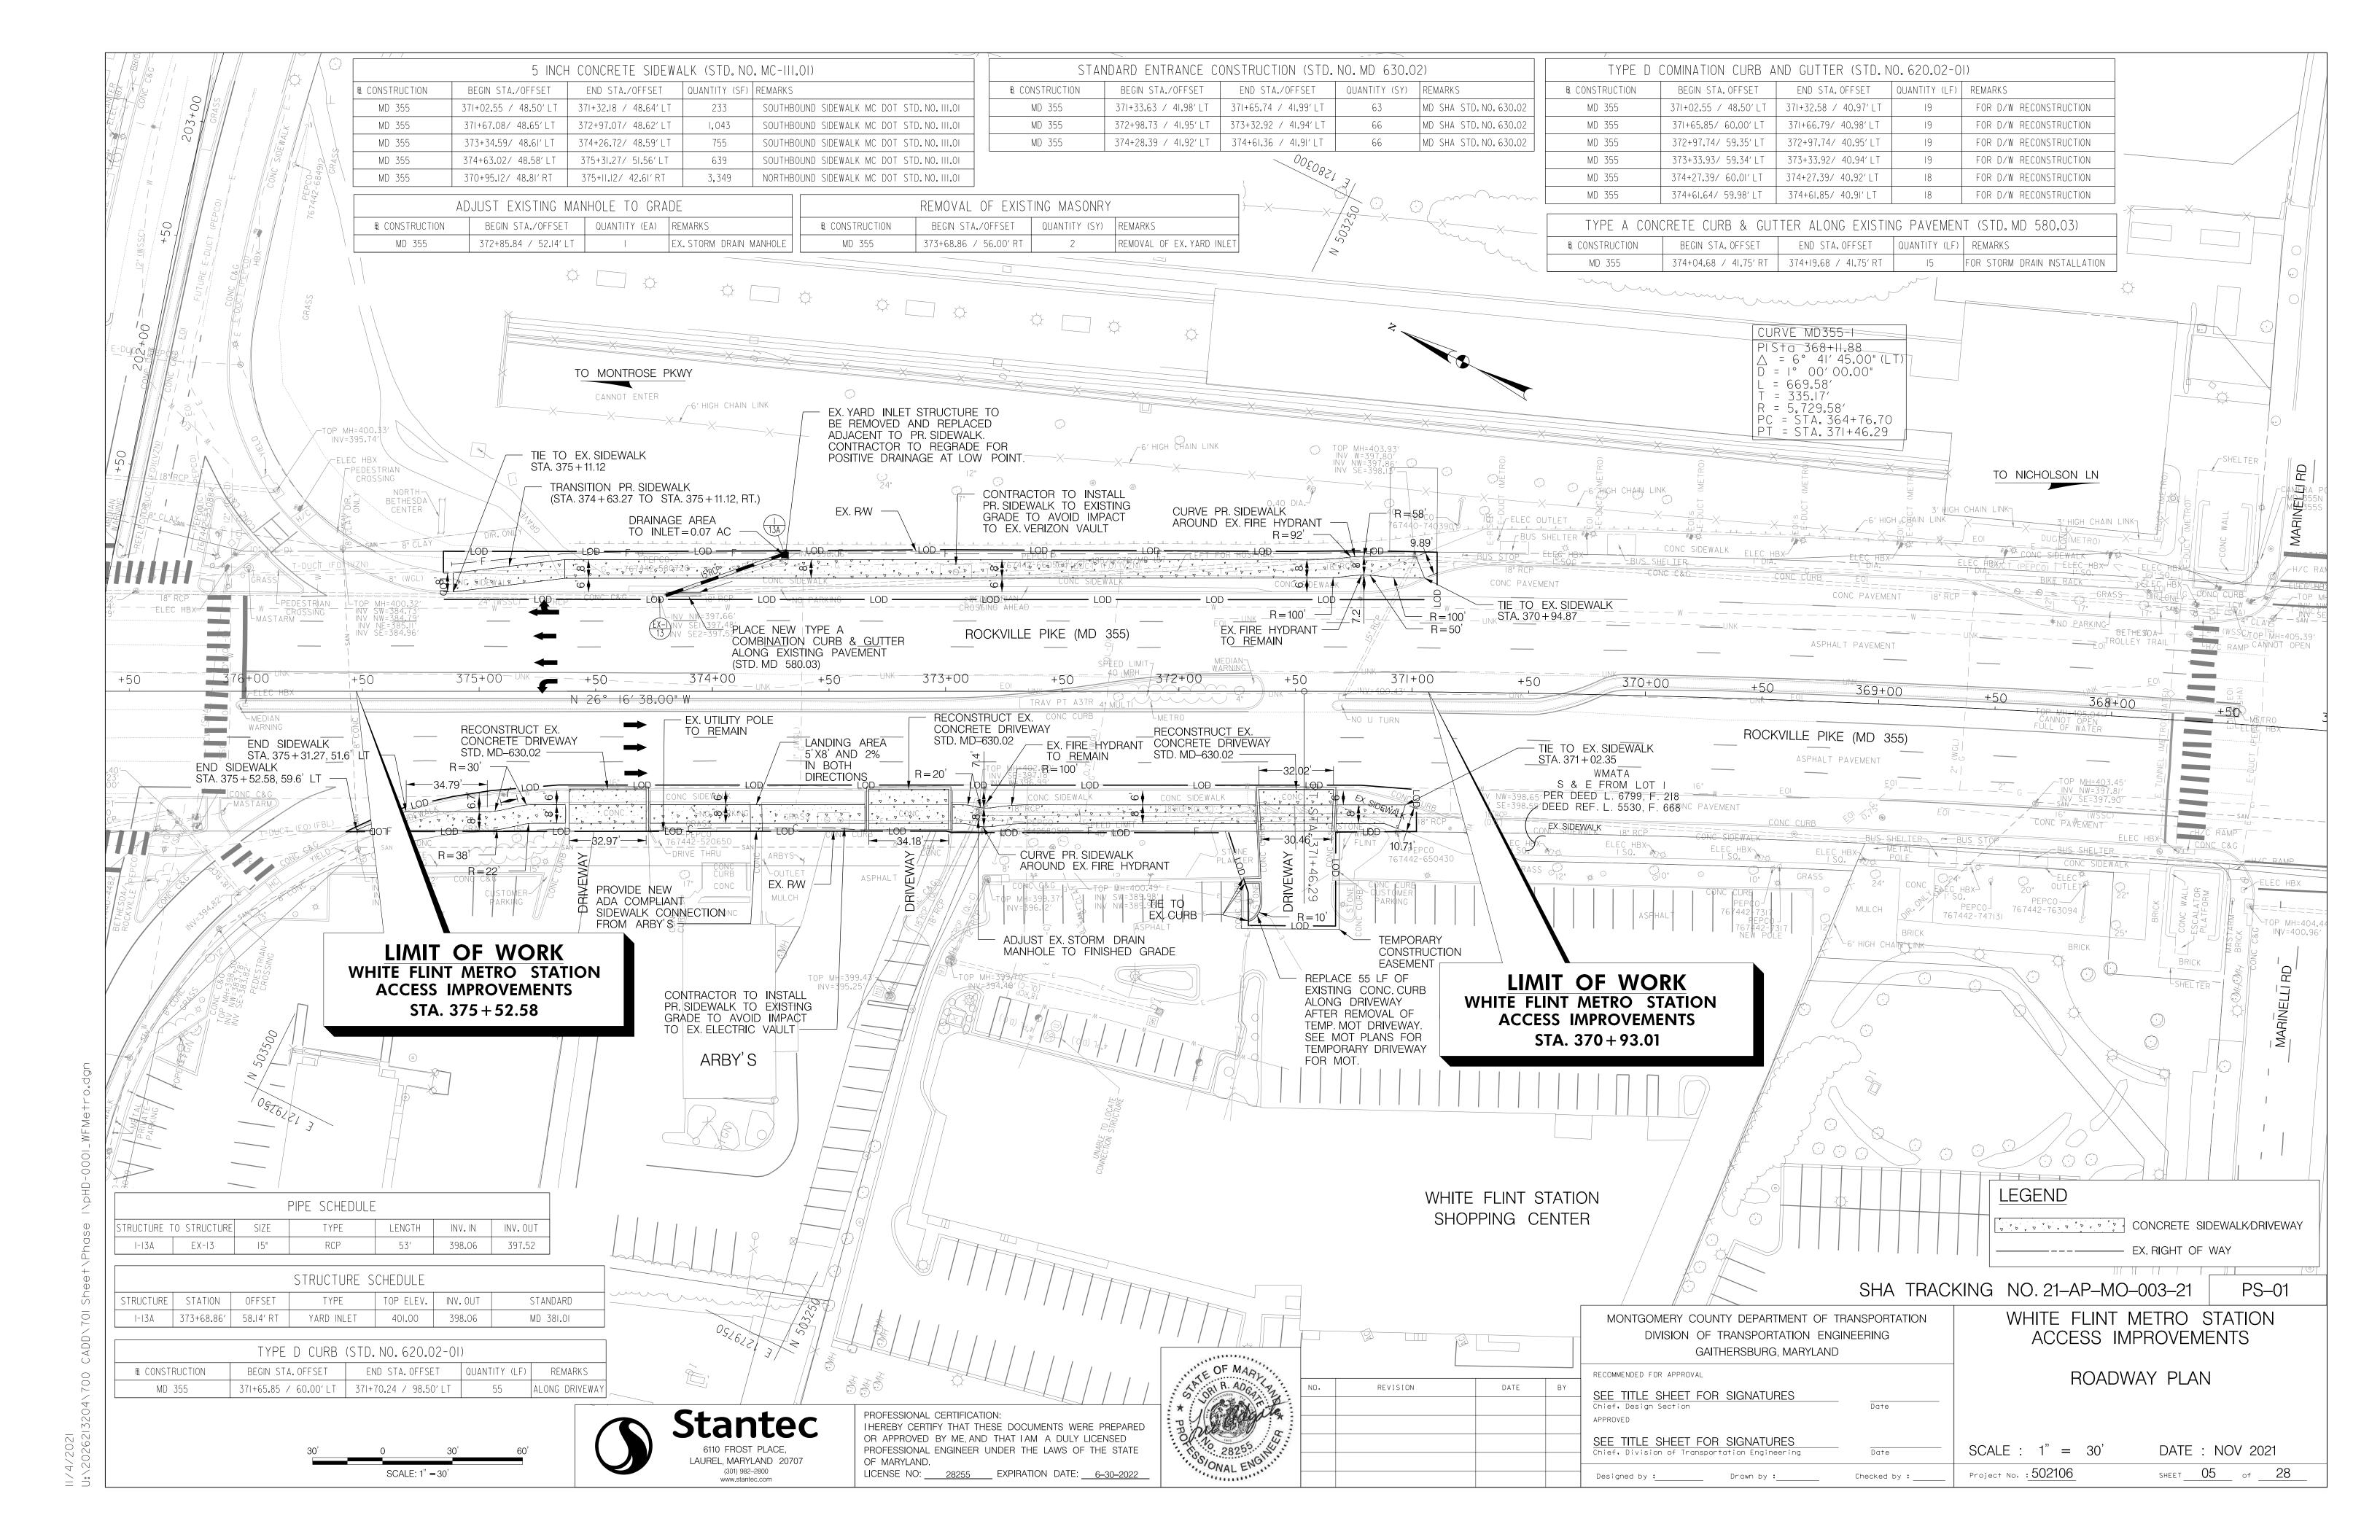



VERTICAL SCALE: 1" = 6' HORIZONTAL SCALE: 1" = 30'



PROFESSIONAL CERTIFICATION:
I HEREBY CERTIFY THAT THESE DOCUMENTS WERE PREPARED
OR APPROVED BY ME, AND THAT I AM A DULY LICENSED PROFESSIONAL ENGINEER UNDER THE LAWS OF THE STATE OF MARYLAND. LICENSE NO: 28255 EXPIRATION DATE: 6-30-2022

REVISION

DATE BY APPROVED

RECOMMENDED FOR APPROVAL SEE TITLE SHEET FOR SIGNATURES
Chief, Design Section Checked by : _

ROADWAY CENTERLINE PROFILE

ACCESS IMPROVEMENTS

MONTGOMERY COUNTY DEPARTMENT OF TRANSPORTATION DIVISION OF TRANSPORTATION ENGINEERING GAITHERSBURG, MARYLAND

SHA TRACKING NO. 21-AP-MO-003-21


PR-01 WHITE FLINT METRO STATION


LIMIT OF WORK
WHITE FLINT METRO STATION
ACCESS IMPROVEMENTS STA. 370 + 93.01 LIMIT OF WORK
WHITE FLINT METRO STATION ACCESS IMPROVEMENTS STA. 375 + 21.62 NORTHBOUND LEFT-TURN INGRESS EXISTING GRADE ROCKVILLE PIKE (MD 355) EX. 8" SAN. SEWER 370 ---- EXISTING GRADE ELEVATION 370+00 371+00 372+00 373+00 ROCKVILLE PIKE (MD 355)

SEE TITLE SHEET FOR SIGNATURES
Chief, Division of Transportation Engineering Designed by :___ Drawn by :___

Project No. : 502106

SCALE : H 1" = 30'; V 1" = 6' DATE : SEPT 2021 SHEET 06 of 28

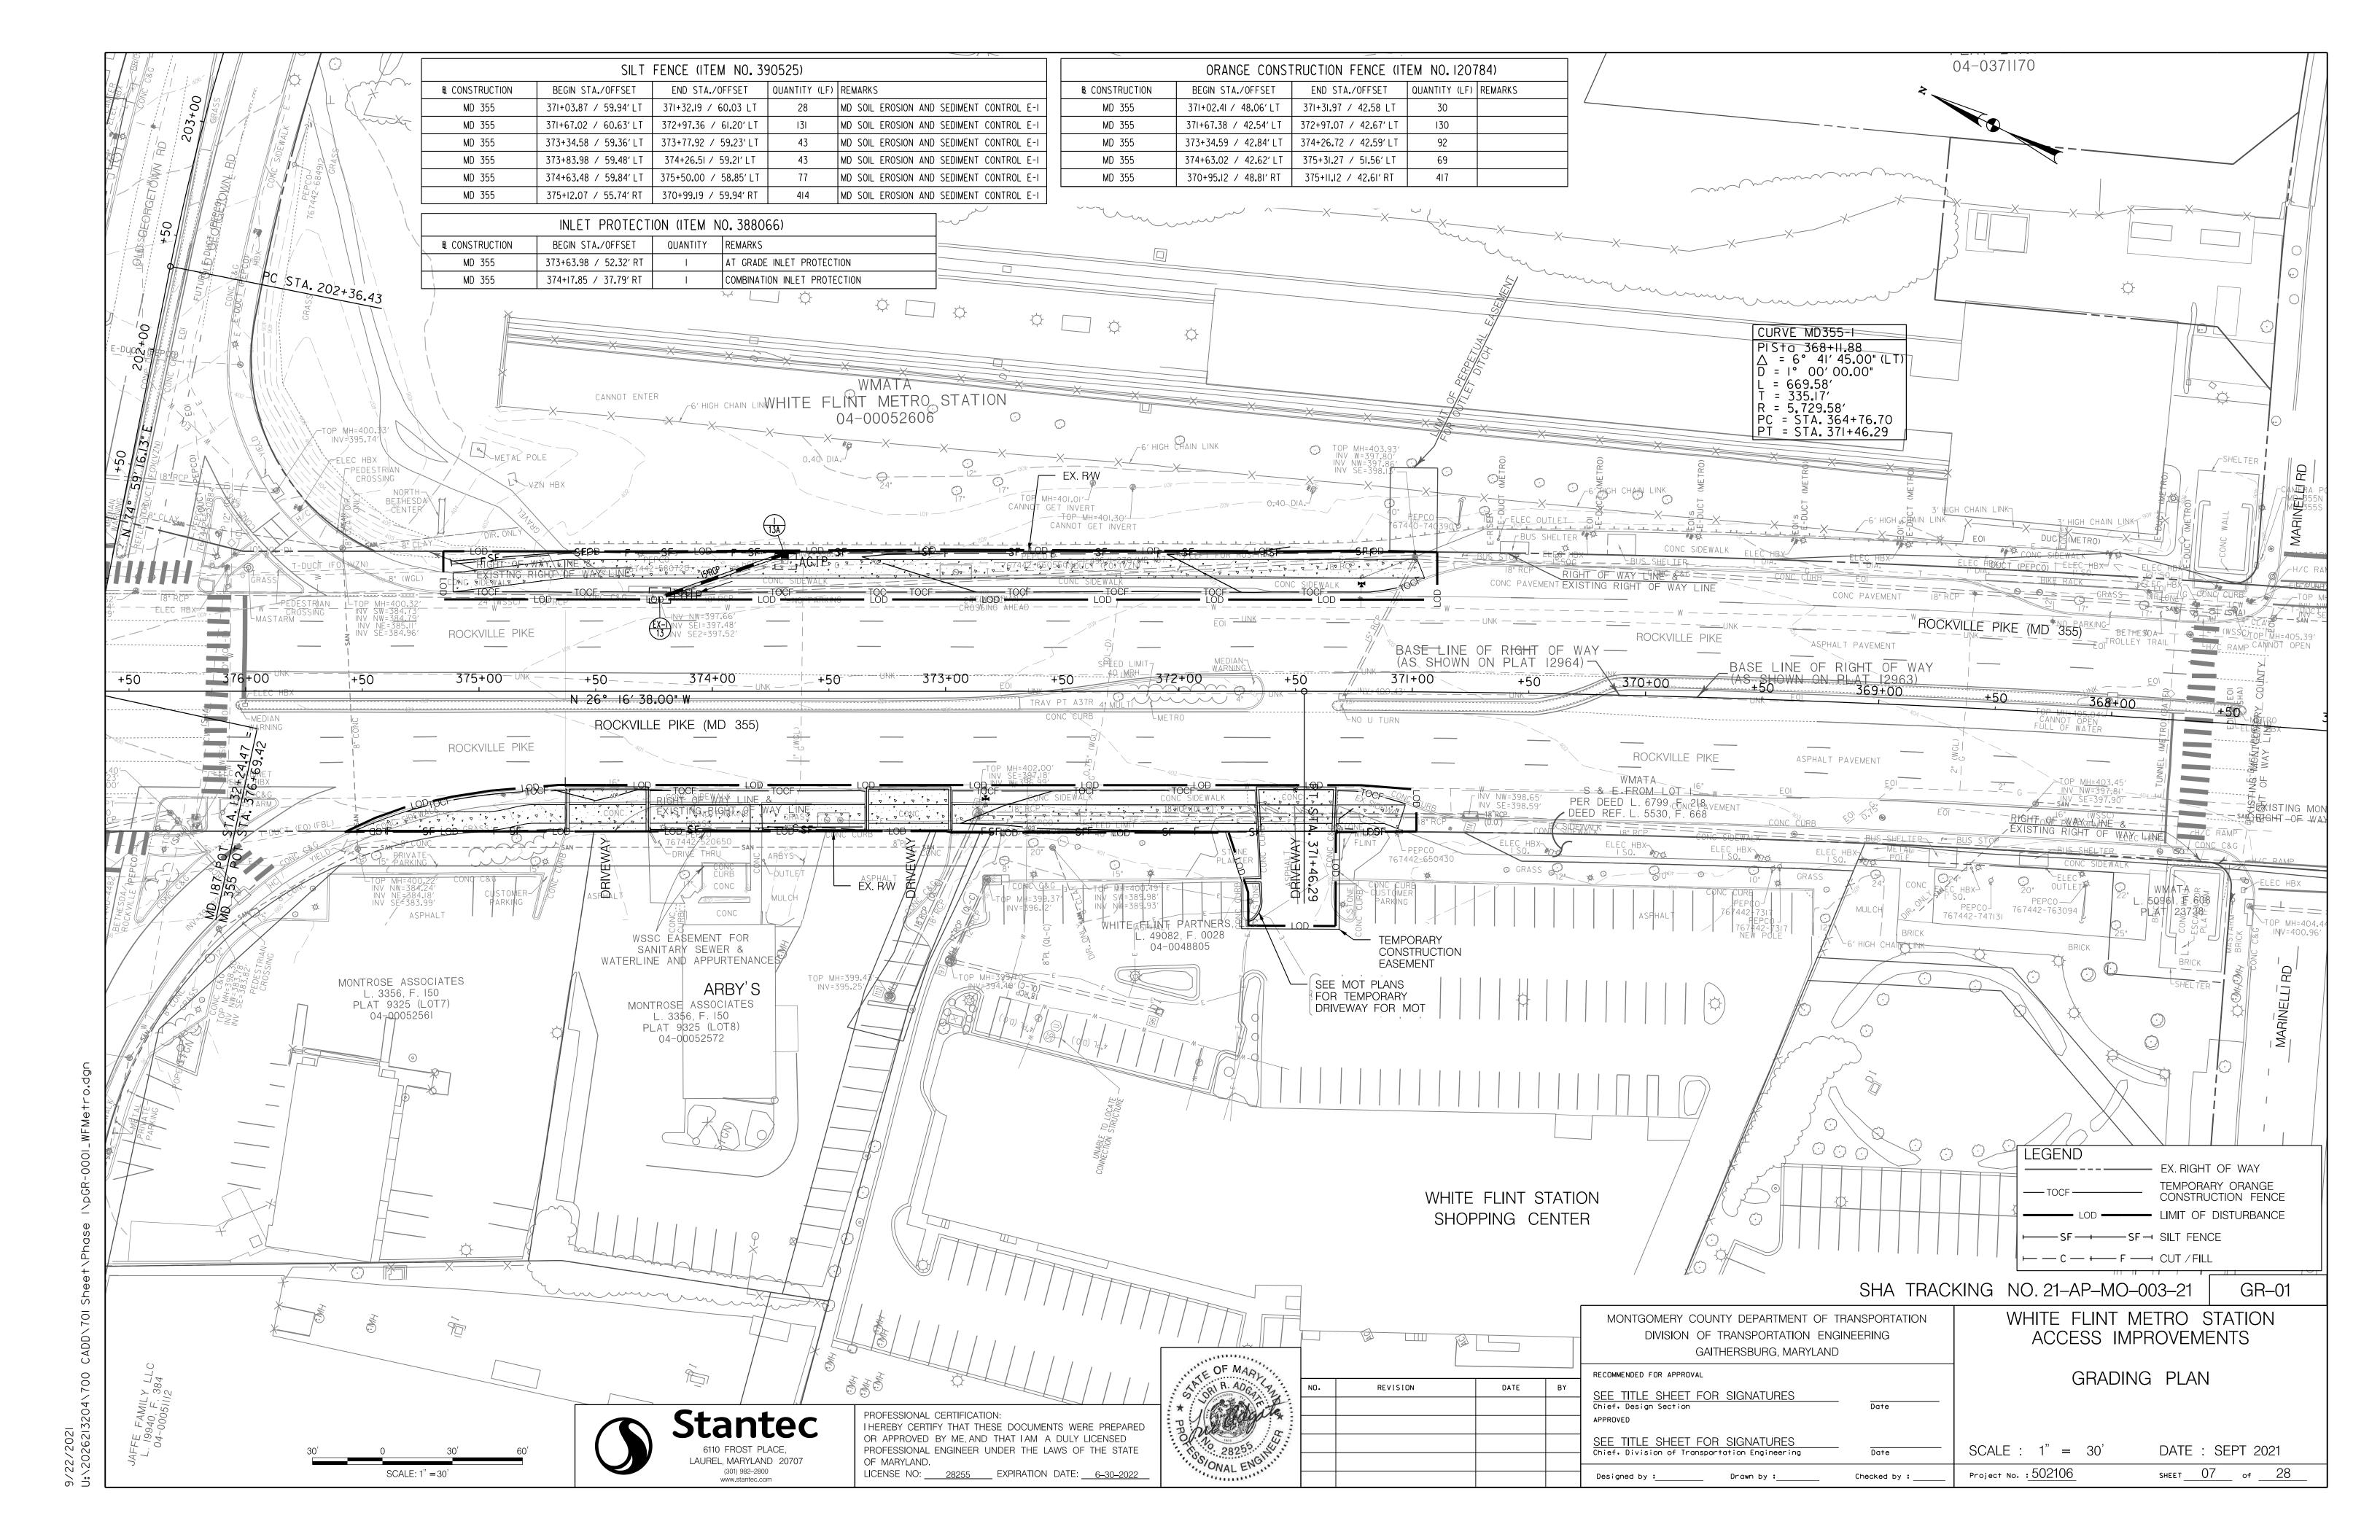

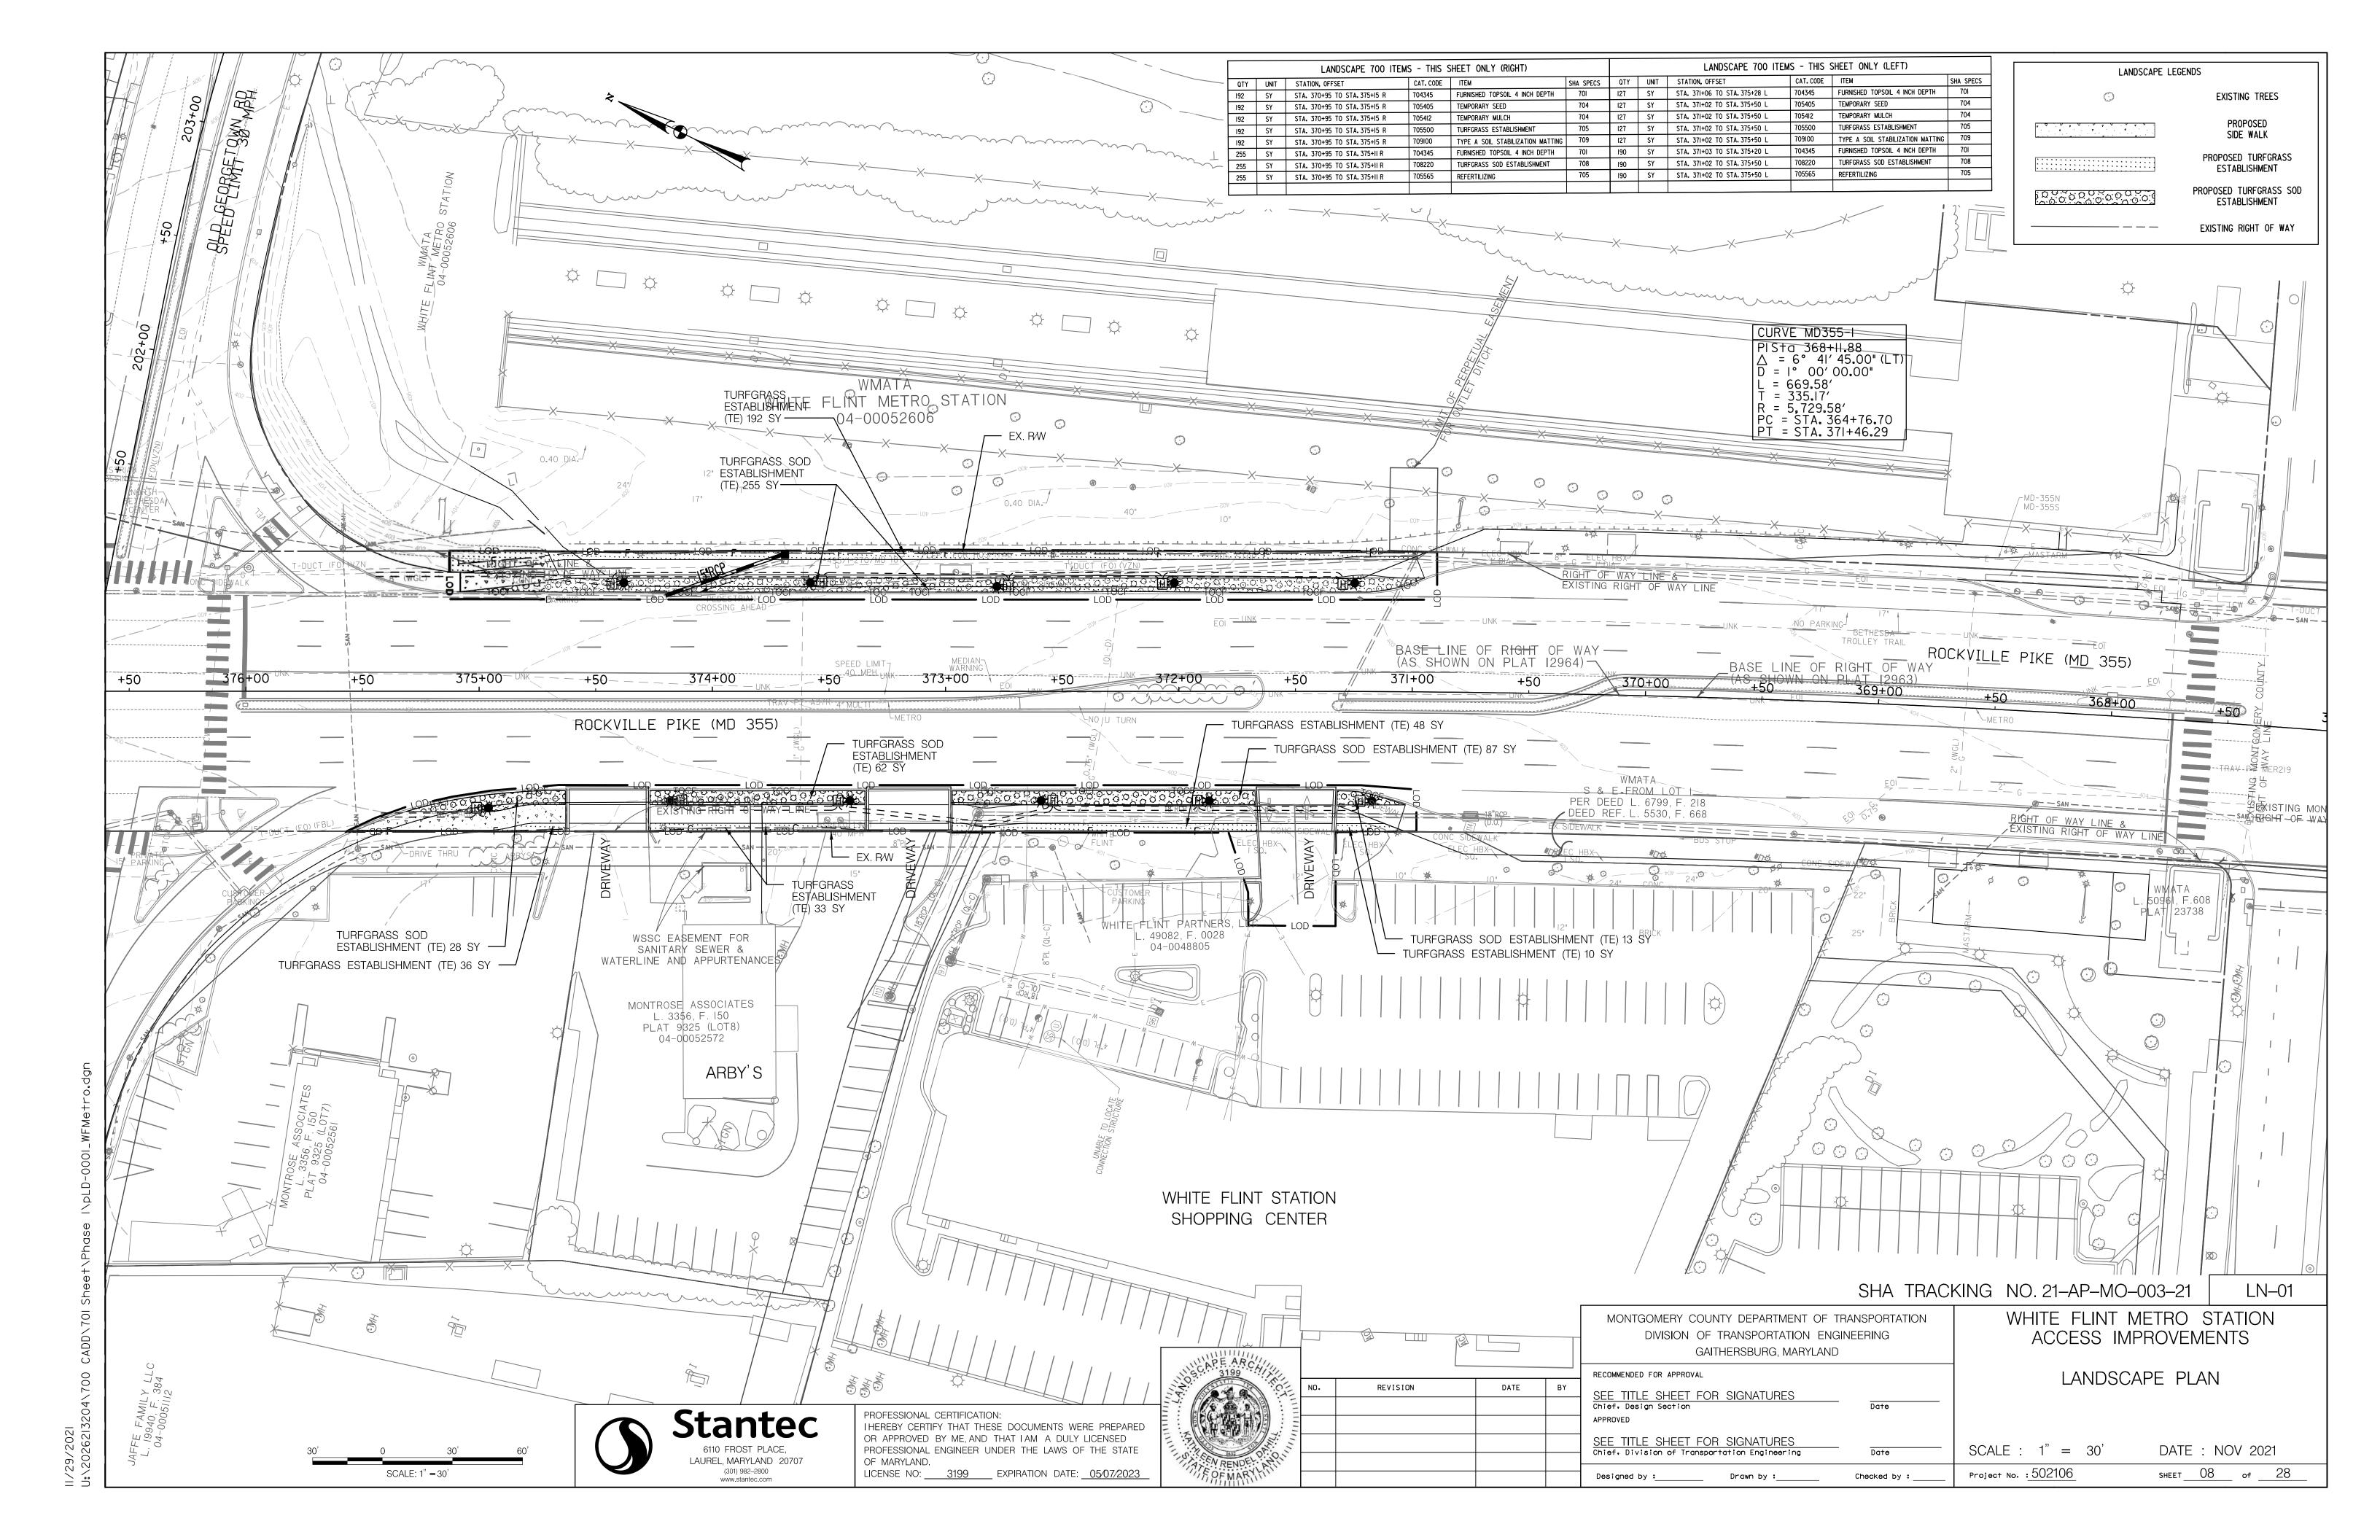

7.2 SHA STANDARD SPECIFICATIONS. LANDSCAPE CONSTRUCTION SHALL CONFORM TO SECTIONS 701 THROUGH 716, AND LANDSCAPE MATERIALS SHALL CONFORM TO SECTION 920 OF THE MOST RECENT REVISION OF SHA STANDARD SPECIFICATIONS FOR CONSTRUCTION AND MATERIALS, INCLUDING ALL REVISIONS AND SUPPLEMENTS, AND AS SPECIFIED IN THESE NOTES. THESE REQUIREMENTS SHALL SUPERSEDE ALL OTHER SPECIFICATIONS FOR WORK ON SHA PROPERTY. ALL SHA SPECIFICATIONS FOR LANDSCAPING AND LANDSCAPE MATERIALS PUBLISHED IN 2008 HAVE BEEN REPLACED. CURRENT SPECIFICATIONS ARE A HTTP://WWW.ROADS.MARYLAND.GOV/INDEX.ASPX?PAGEID=44

7.3 EROSION AND SEDIMENT CONTROL MANAGER (ESCM). SOIL DISTURBANCE SUCH AS GRADING, EXCAVATION, SOIL PLACEMENT OR OTHER ACTIVITIES THAT INVOLVE SOIL DISTURBANCE SHALL BE SUPERVISED BY AN ESCM MANAGER WITH A VALID "SHA YELLOW CARD" IN CONFORMANCE WITH SHA STANDARD SPECIFICATIONS AND ANY APPLICABLE EROSION AND SEDIMENT CONTROL PERMIT.

SHA STANDARD DETAILS FOR TREES, SHRUBS AND PLANTING BEDS. THE INSTALLATION OF TREES, SHRUBS, PLANTING BEDS AND OTHER LANDSCAPE CONSTRUCTION RELATED TO SECTION 710 OF THE SHA STANDARD SPECIFICATIONS SHALL CONFORM TO THE "SHA BOOK OF STANDARDS FOR HIGHWAY & INCIDENTAL STRUCTURES CATEGORY 7" AT

HTTP://APPS.ROADS.MARYLAND.GOV/BUSINESSWITHSHA/BIZSTDSSPECS/DESMANUALSTDPUB /PUBLICATIONSONLINE/OHD/BOOKSTD/TOCCAT7.ASP

7.5 TEMPORARY STABILIZATION SHALL BE INSTALLED IN CONFORMANCE WITH SECTION 704 TO ENSURE THAT AREAS OF SOIL DISTURBANCE ARE PROTECTED FROM WIND, RAINFALL AND FLOWING WATER UNTIL PERMANENT STABILIZATION IS INSTALLED.

7.6 ROADWAY PAVEMENT REMOVAL. AREAS OF ROADWAY REMOVAL SHALL BE EXCAVATED TO REMOVED PAVEMENTS, AGGREGATE BASE, AND COMPACTED SOIL TO A MINIMUM DEPTH OF 10 INCHES BELOW THE PAVEMENT SURFACE OR AS NECESSARY TO REMOVE ALL MATERIAL UNSUITABLE FOR LANDSCAPING. THE EXCAVATION AREAS SHALL BE RESTORED WITH SUBSOIL AND TOPSOIL AS PART OF SOIL RESTORATION.

TEMPORARY MULCH, EITHER AS TEMPORARY STRAW MULCH OR TEMPORARY MATTING MULCH, SHALL BE INSTALLED AT THE END OF EACH WORKING DAY TO PROVIDE "SAME DAY STABILIZATION" UNLESS OTHER APPROVED STABILIZATION IS INSTALLED.

TEMPORARY STRAW MULCH SHALL BE INSTALLED ON AREAS AND SLOPES FLATTER THAN 4:1 TEMPORARY MATTING MULCH SHALL BE APPLIED ON SLOPES 4:1 AND STEEPER, AND TO AREAS WITIN CHANNELS. TEMPORARY SEED SHALL BE INSTALLED IN LIEU OF TEMPORARY MULCH WHEN SOIL REDISTURBANCE IS EXPECTED MORE THAN 30 DAYS AFTER SOIL DISTURBANCE. THE REQUIRED APPLICATION RATE SHALL BE 100 LBS PER ACRE OF 37-0-0 (SCU) FERTILIZER.

7.7 EXCAVATION AND DEBRIS REMOVAL. DEBRIS RELATED TO THE DEMOLITION OF SIDEWALKS, DRIVEWAYS CURBS, TREES, STUMPS, ROOTS, FENCING, PIPES, AND OTHER MATERIALS THAT MAY INTERFERE WITH LANDSCAPE INSTALLATION OR FUTURE MAINTENANCE SHALL BE EXCAVATED AS NECESSARY FOR THEIR COMPLETE REMOVAL AND DISPOSAL.

7.8 SOIL RESTORATION. AREAS OF PAVEMENT REMOVAL, EXCAVATION OR DRILLING IN LANDSCAPED AREAS SHALL REMOVE EXCAVATED DEBRIS AND RESTORE THE SUBGRADE WITH APPROVED SUBSOIL AND TOPSOIL PLACED IN CONFORMANCE WITH SECTION 701 OF THE SHA STANDARD SPECIFICATIONS.

1. A LAYER OF APPROVED TOPSOIL AT LEAST 4 INCH DEPTH SHALL BE PLACED ON ALL DISTURBED AREAS FLATTER THAN 2:1 AND IN ALL CHANNELS PRIOR TO SEEDING, SODDING OR OTHER LANDSCAPING, UNLESS OTHERWISE SPECIFIED.

2. A LAYER OF APPROVED TOPSOIL AT LEAST 2 INCH DEPTH SHALL BE PLACED ON ALL DISTURBED AREAS 2:1 AND STEEPER PRIOR TO SEEDING, SODDING OR OTHER LANDSCAPING, UNLESS OTHERWISE SPECIFIED. 3. BIORETENTION SOIL MIX (BSM) AND OTHER MATERIALS INSTALLED IN CONJUNCTION WITH SPI 316 STORMWATER FILTRATION FACILITIES AND SHA STORMWATER DETAILS SHALL BE INSTALLED IN CONFORMANCE WITH THE SHA LANDSCAPE NOTES AND LANDSCAPE PLANS. PLANT MATERIALS AND MULCH SHALL BE INSTALLED IN BSM IN CONFORMANCE WITH STORMWATER DETAILS, SECTION 710 OR OTHER SHA SPECIFICATIONS.

7.9 TURFGRASS SOD ESTABLISHMENT SHALL BE PERFORMED IN ALL DISTURBED AREAS, OR WITHIN THE AREAS INDICATED IN THE PLANS, IN CONFORMANCE WITH SECTION 708 OF THE SHA STANDARD SPECIFICATIONS. THE REQUIRED APPLICATION RATE OF 20-16-12 FERTILIZER SHALL BE 200 LBS PER ACRE, AND NO FERTILIZER SHALL BE APPLIED FROM NOVEMBER 15 TO MARCH 1.

7.10 TURFGRASS ESTABLISHMENT SHALL BE PERFORMED IN ALL DISTURED AREAS, OR WITHIN THE AREAS INDICATED IN THE PLANS, IN CONFORMANCE WITH SECTION 705 OF THE SHA STANDARD SPECIFICATIONS. THE REQUIRED APPLICATION RATE OF 20-16-12 FERTILIZER SHALL BE 200 LBS PER ACRE, AND NO FERTILIZER SHALL BE APPLIED FROM NOVEMBER 15 TO MARCH 1.

7.11 SOIL STABILIZATION MATTING SHALL BE INSTALLED IN CONFORMANCE WITH SECTION 709 OF THE SHA STANDARD SPECIFICATIONS, IN CONJUCTION WITH TRUFGRASS ESTABLISHMENT PER SECTION 705 OR MEADOW ESTABLISHMENT PER SECTION 707 AS FOLLOWS:

1. AREAS FLATTER THAN 6:1. TYPE A OR TYPE E MATTING MAY BE INSTALLED IN LIEU OF STRAW MULCH AND HYDROMULCH BINDER IN CONJUCTION WITH TURFGRASS ESTABLISHMENT. 2. AREAS STEEEPER THAN 6:1 AND FLATTER THAN 4:1. TYPE A OR TYPE E MATTING SHALL BE INSTALLED IN LIEU OF STRAW MULCH AND HYDORMULCH BINDER IN CONJUCTION WITH TURFGRASS ESTABLISHMENT, UNLESS

DELINEATED AND NOTED OTHERWISE. 3. CHANNELS, STORMWATER MANAGEMENT FACILITIES, AND SLOPES 4:1 AND STEEPER TYPE A SOIL STABILIZATION MATTING SHALL BE INSTALLED IN LIEU OF STRAW MULCH AND HYDROMULCH BINDR IN CONJUCTION WITH TURFGRASS ESTABLISHMENT, UNLESS DELINEATED AND NOTED OTHERWISE.

7.14 ROADSIDE TREE PERMIT. TREE REMOVAL, TREE INSTALLATION, TREE ROOT AND BRANCH PRUNING, AND OTHER REGULATED IMPACTS TO TREES IN THE SHA RIGHT OF WAY SHALL CONFORM TO THE REQUIREMENTS OF THE ROADSIDE TREE PERMIT (RTP) OF THE MARYLAND DEPARTMENT OF NATURAL RESOURCES, OR THE APPROVED FOREST CONSERVATION ACT PLAN OF THE LOCAL AUTHORITY.

1. A COPY OF THE RTP OR FCP SHALL BE SUBMITTED TO THE SHA OFFICE OF ENVIRONMENTAL DESIGN BEFORE WORK IS PERFORMED, AND A COPY OF THE RTP OR FCP SHALL BE REPRODUCED IN THE PLANS OR BE IN POSSESSION OF THE APPLICANT AT THE PROJECT SITE WHEN THE PERMITTED WORK IS PERFORMED.

2. A MARYLAND LICENSED TREE EXPERT SHALL PERFORM THE SPECIFIED TREE OPERATIONS IN CONFORMANCE WITH THE SHA STANDARD SPECIFICATIONS AND ANSI A300 STANDARDS FOR TREE CARE OPERATIONS.

7.15 TREES AND OTHER PLANT MATERIAL INSTALLATION. TREES, SHRUBS, PERENNIALS, ANNUALS, BULBS. LANDSCAPE BEDS, BARK MULCH AND SIMILAR MATERIALS SHALL BE INSTALLED IN CONFORMANCE WITH SECTION 710 AND 711 OF THE SHA STANDARD SPECIFICATIONS. TREE AND SHRUBS SHALL BE PRUNED AT THE TIME OF INSTALLATION TO ENSURE SIDEWALK CLEARANCE FOR PEDESTRIANS IS MAINTAINED TO A HEIGHT OF 8 FEET. NO TREE OR SHRUB SHALL BE INSTALLED WITHIN 3 FEET OF CURBS, SIDEWALKS, OR PAVEMENT EDGES.

	MAS	TER LAI	NDSCAPE 7	00 ITEMS	
1	QTY	UNIT	CAT. CODE	ITEM	SHA SPECS
1	764	SY	704345	FURNISHED TOPSOIL 4 INCH DEPTH	701
1	319	SY	705405	TEMPORARY SEED	704
1	319	SY	705500	TURFGRASS ESTABLISHMENT	705
1	319	SY	709100	TYPE A SOIL STABILIZATION MATTING	709
1	445	SY	708220	TURFGRASS SOD ESTABLISHMENT	708
1	319	SY	705412	TEMPORARY MULCH	704
1	445	SY	705565	REFERTILIZING	705
1					
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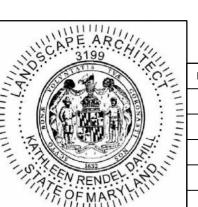
SHA TRACKING NO. 21-AP-MO-003-21

Project No. : 502106

SHEET 09 of 28

LN-02

PROFESSIONAL CERTIFICATION: Stantec I HEREBY CERTIFY THAT THESE DOCUMENTS WERE PREPARED OR APPROVED BY ME, AND THAT I AM A DULY LICENSED 6110 FROST PLACE, LAUREL, MARYLAND 20707 OF MARYLAND. (301) 982-2800 LICENSE NO: 3199 EXPIRATION DATE: 05/07/2023



,					RECOMMENDED FOR APPROVAL
1	NO.	REVISION	DATE	BY	SEE TITLE SHEET FOR SIGNATURES
==					Chief, Design Section
Ξ					APPROVED
111/1/					SEE TITLE SHEET FOR SIGNATURES
-					Chief, Division of Transportation Engineering
					Designed by : Drawn by :


WHITE FLINT METRO STATION MONTGOMERY COUNTY DEPARTMENT OF TRANSPORTATION ACCESS IMPROVEMENTS DIVISION OF TRANSPORTATION ENGINEERING GAITHERSBURG, MARYLAND

Checked by :

OMMENDED FOR APPROVAL LANDSCAPE NOTES & DETAILS TITLE SHEET FOR SIGNATURES ef, Design Section

> SCALE : 1" = 30"DATE: NOV 2021

PROFESSIONAL ENGINEER UNDER THE LAWS OF THE STATE

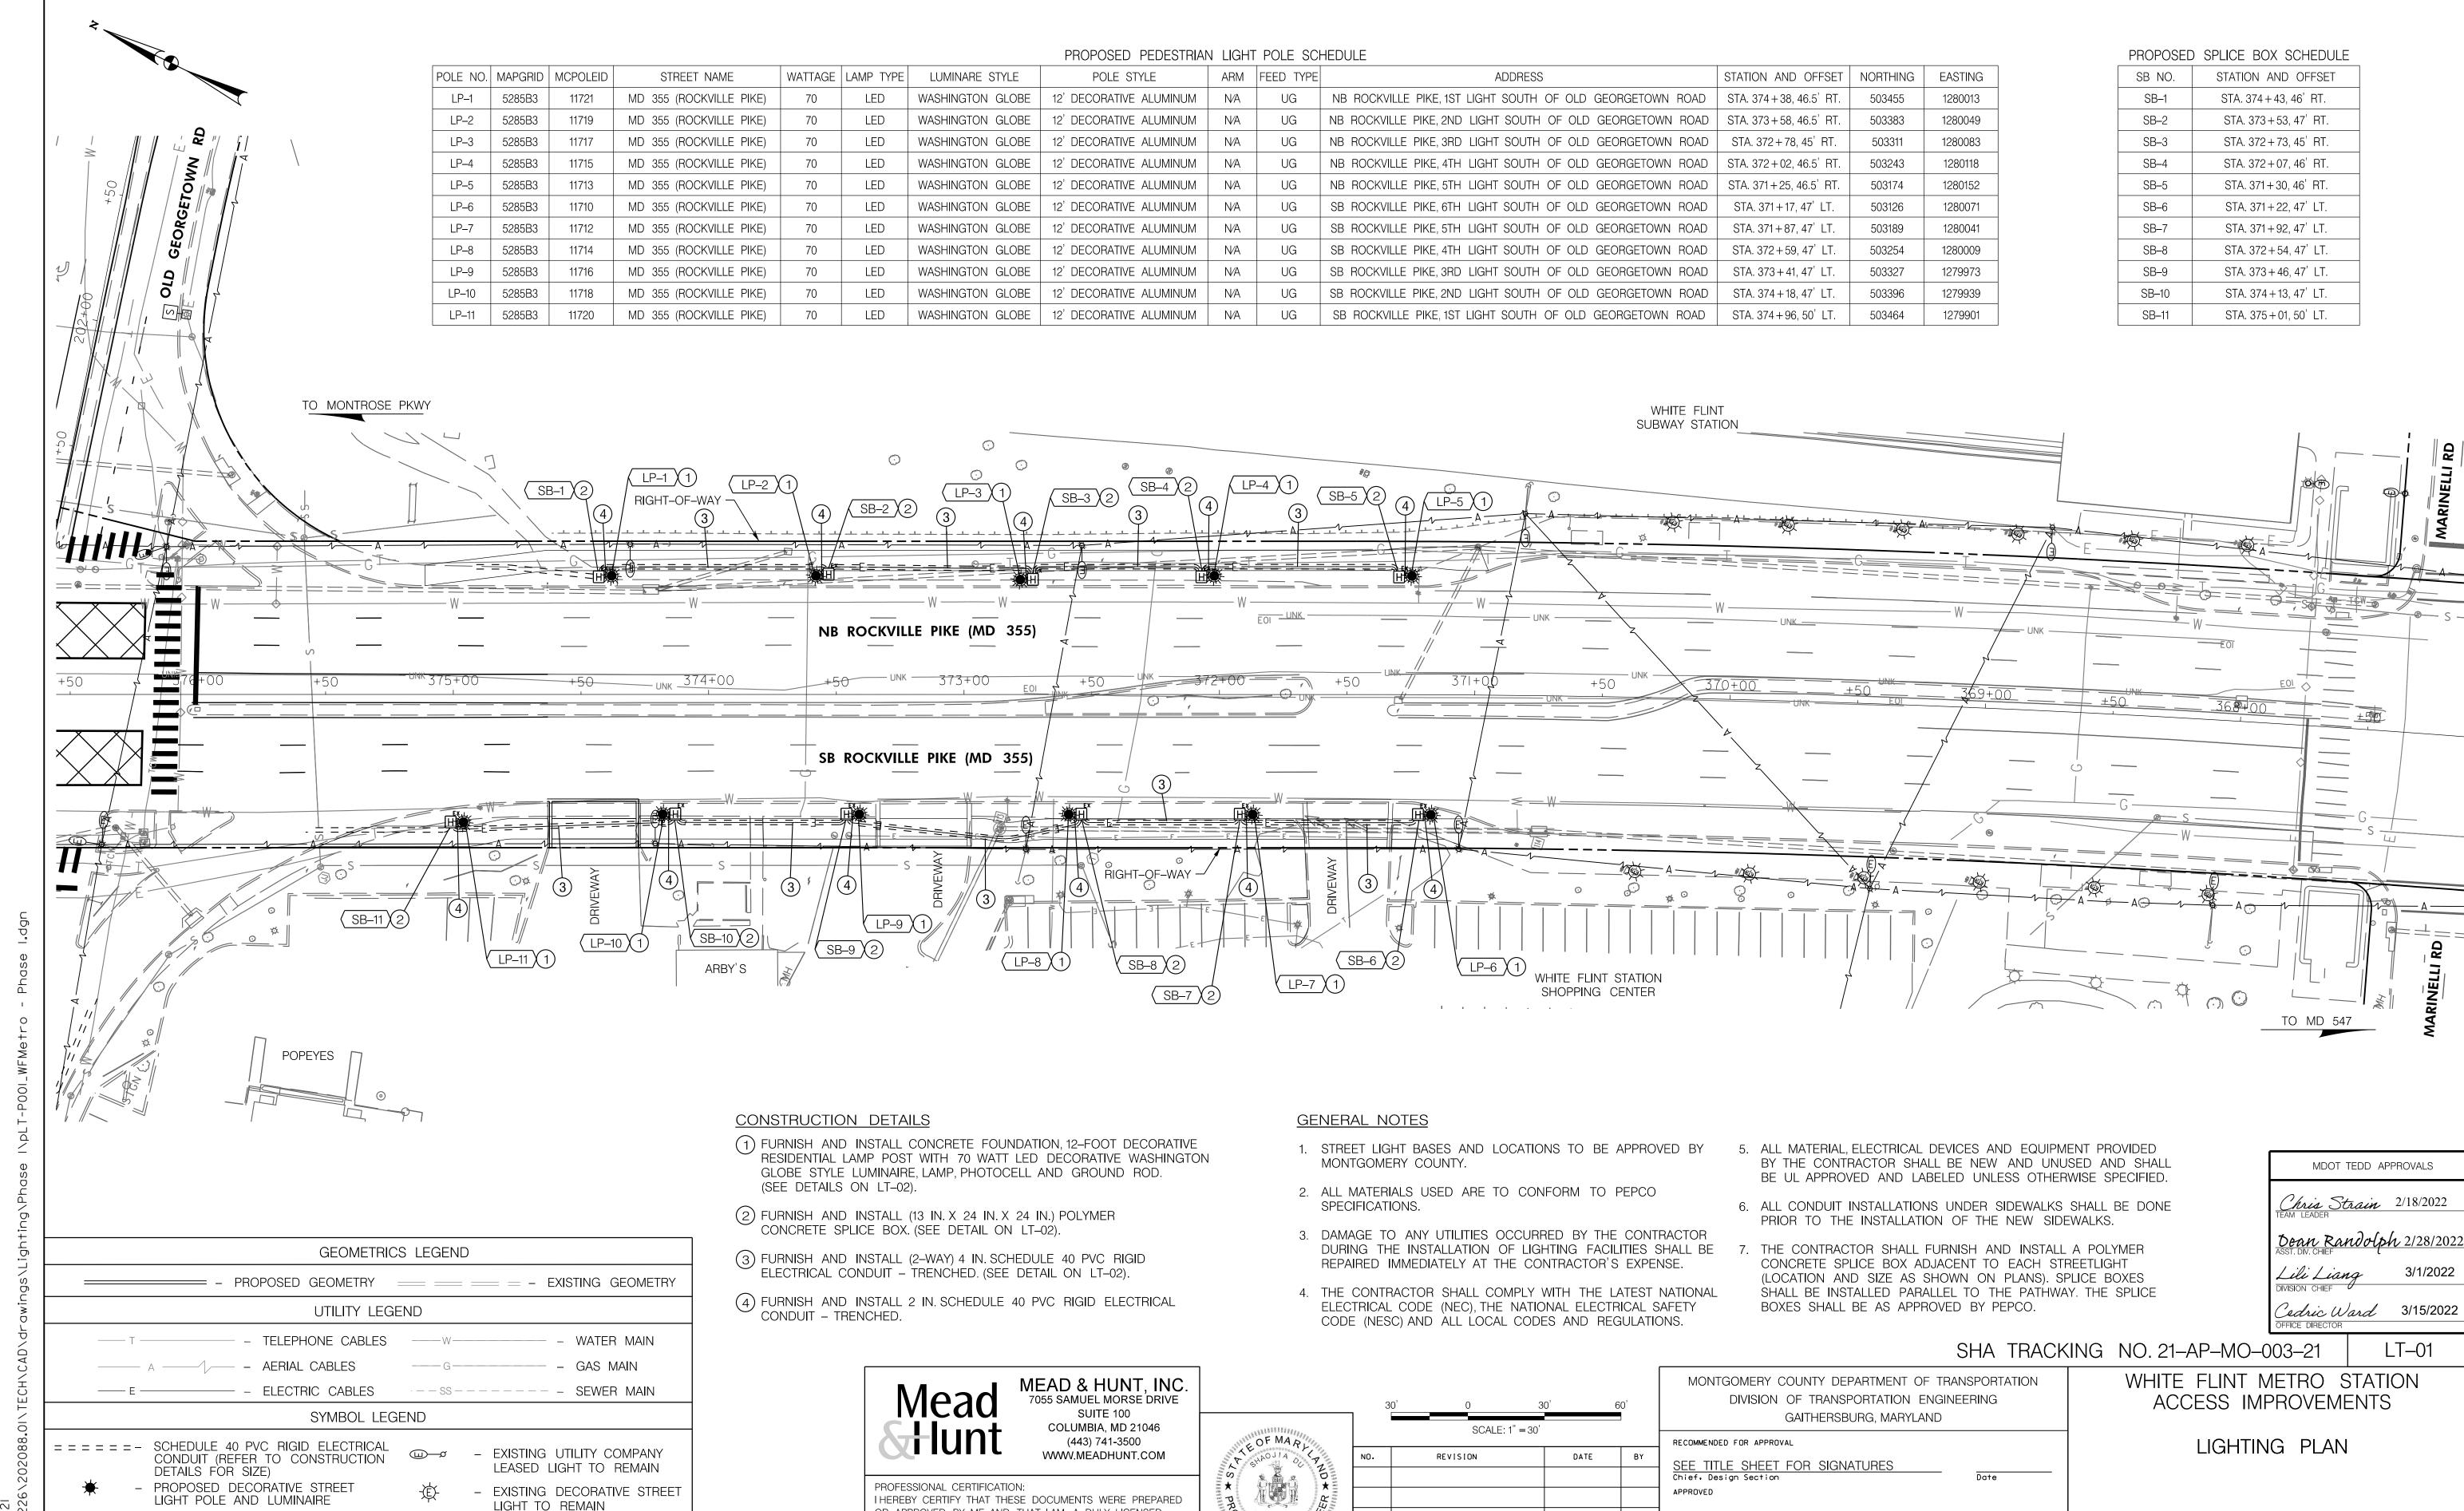

SONAL EN

Date: 2021:09:24 18:44:49-04'00' Digitally signed by Shaojia Du

SEE TITLE SHEET FOR SIGNATURES

Designed by :____

Chief, Division of Transportation Engineering

Drawn by :__

SCALE : 1" = 30"

Project No. : 502106

Checked by :

DATE: SEPT 2021

SHEET 10 of 28

OR APPROVED BY ME, AND THAT I AM A DULY LICENSED

OF MARYLAND.

PROFESSIONAL ENGINEER UNDER THE LAWS OF THE STATE

LICENSE NO: 27451 EXPIRATION DATE: 1/23/2022

PROPOSED SPLICE BOX

REMAIN

EXISTING STREET LIGHT TO

- PROP. SPLICE BOX ID NO.


- PROP. LIGHT POLE ID NO.


SB-#


LP-# >


STREETLIGHT CONDUIT INSTALLATION CHECKLIST


- 1. 2-WAY FOUR INCH (4"), SCHEDULE 40, PVC CONDUIT TO BE INSTALLED BY THE CONTRACTOR CONNECTING EACH SPLICEBOX IN A CONTINUOUS RUN.
- 2. TWO INCH (2"), SCHEDULE 40, PVC CONDUIT TO BE INSTALLED BY THE CONTRACTOR CONNECTING THE SPLICEBOX TO THE STREET LIGHT FOOTING.
- 3. CONTRACTOR TO PROVIDE AND INSTALL PHOTOCELLS FOR EACH STREET LIGHT LUMINAIRE.
- 4. STREETLIGHT AND POST ERECTED BY THE CONTRACTOR ARE TO BE WIRED WITH #10 AWG (MIN.) COPPER WITH A THREE FOOT MINIMUM LOOP OF SLACK IN THE SPLICEBOX FOR ATTACHMENT BY PEPCO.
- 5. STREETLIGHT POSTS ARE TO HAVE A GROUNDING LUG ATTACHED TO THE BASE OF THE POST WITH A MINIMUM THREE FOOT LOOP OF SLACK IN THE SPLICEBOX OF #6 AWG BARE COPPER WIRE ATTACHED.
- 6. ALL SWEEPBENDS TO BE MINIMUM OF 24 INCHES RADIUS.
- 7. 1/4" NYLON PULL-LINES IS TO BE INSTALLED IN EACH CONDUIT DUCT.
- 8. CONTRACTOR TO INSTALL MARKING TAPE ONE FOOT (1") ABOVE EACH CONDUIT
- 9. NO MORE THAN 180 DEGREES OF BENDS IN A CONDUIT RUN.
- 10. CONDUIT IS TO HAVE THREE (3) FEET (MINIMUM) OF COVER OVER IT.
- 11. INSTALLATION OF ALL UNDERGROUND LIGHTING FACILITIES ARE ALSO SUBJECT TO PEPCO INSPECTION AND WRITTEN APPROVAL BEFORE CONCEALMENT. FAILURE TO OBTAIN SUCH INSPECTION WILL RESULT IN THE UNCOVERING OF FACILITIES AT THE CONTRACTOR'S EXPENSE. CALL (202) 388-2137 7:00 TO 9:00 AM OR 3:00 TO 4:00 PM TWO WORKING DAYS IN ADVANCE TO ARRANGE INSPECTION.
- 12. ALL STREETLIGHT EQUIPMENT AND MATERIALS SHALL BE SUBMITTED TO MONTGOMERY COUNTY FOR APPROVAL PRIOR TO BEING INSTALLED ON THE PROJECT. SEE SPECIAL PROVISIONS FOR STREETLIGHT SPECIFICATIONS.
- 13. ALL STREETLIGHTS SHALL BE INSTALLED 2'-6" BEHIND THE FACE OF THE CURB (EXCEPT AS NOTED ON PLANS).
- 14. CONTRACTOR SHALL SUBMIT SHOP DRAWINGS / CATALOG CUTS FOR ALL LIGHTING EQUIPMENT TO MONTGOMERY COUNTY TRAFFIC OPERATIONS DIVISION FOR APPROVAL PRIOR TO INSTALLATION.

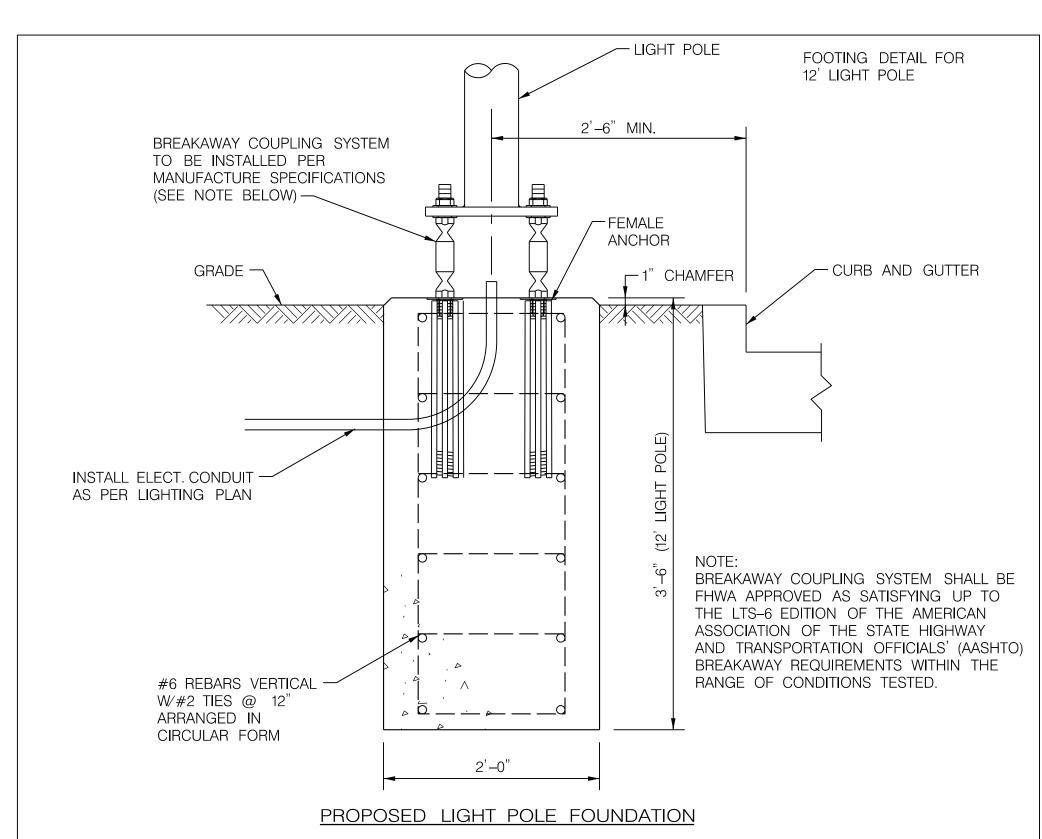

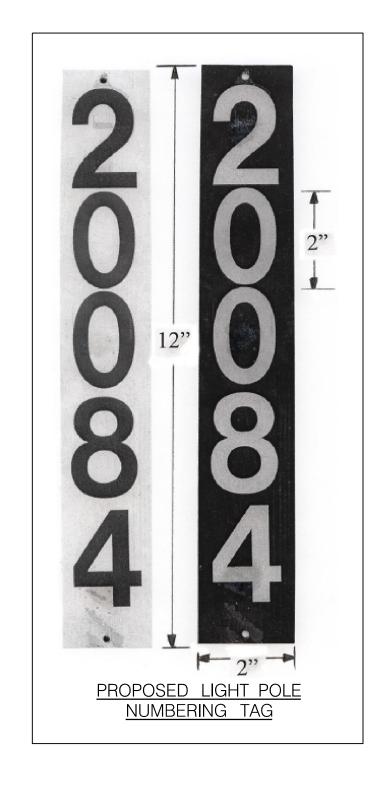

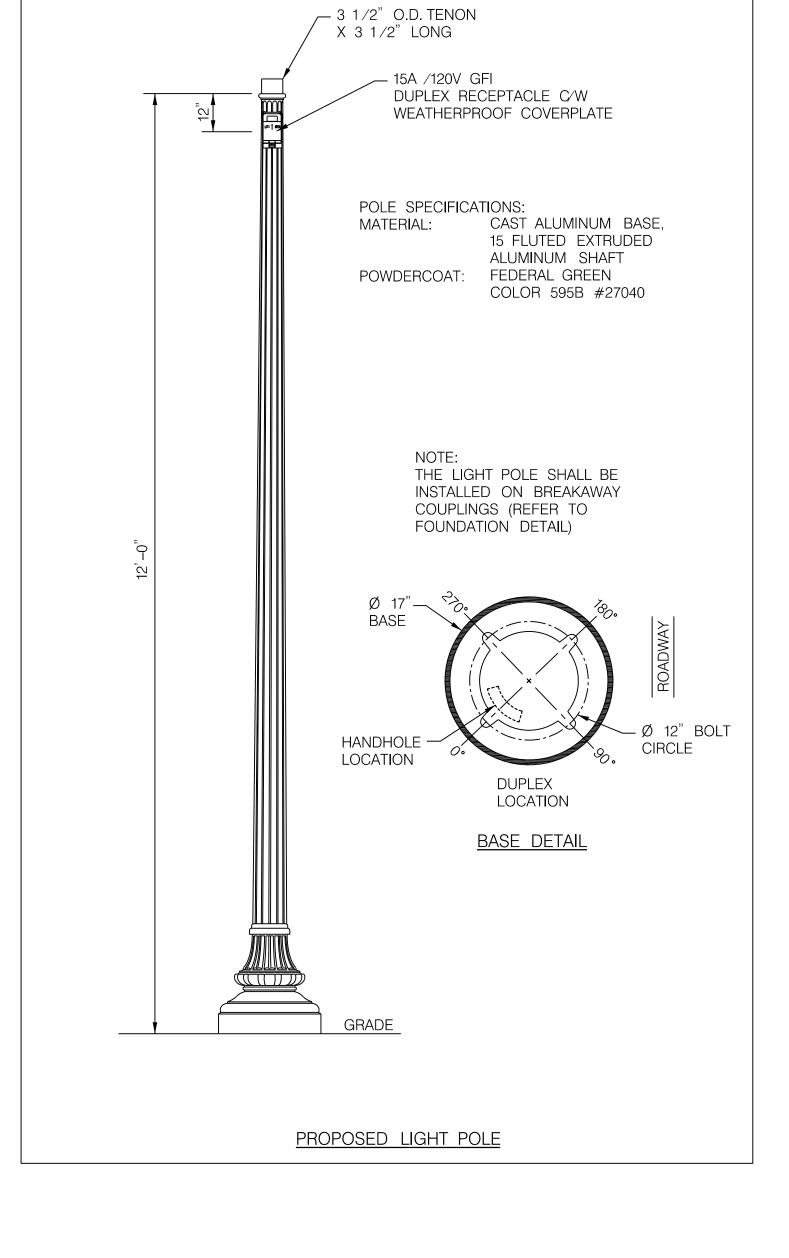

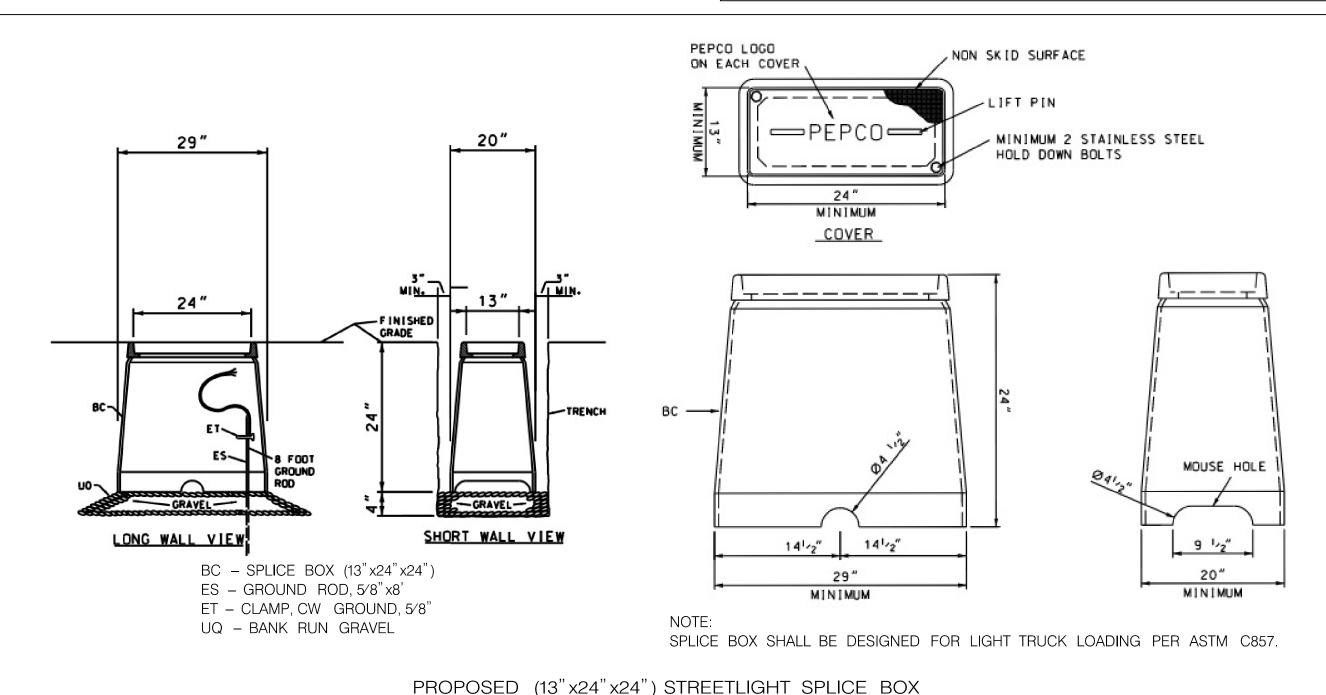

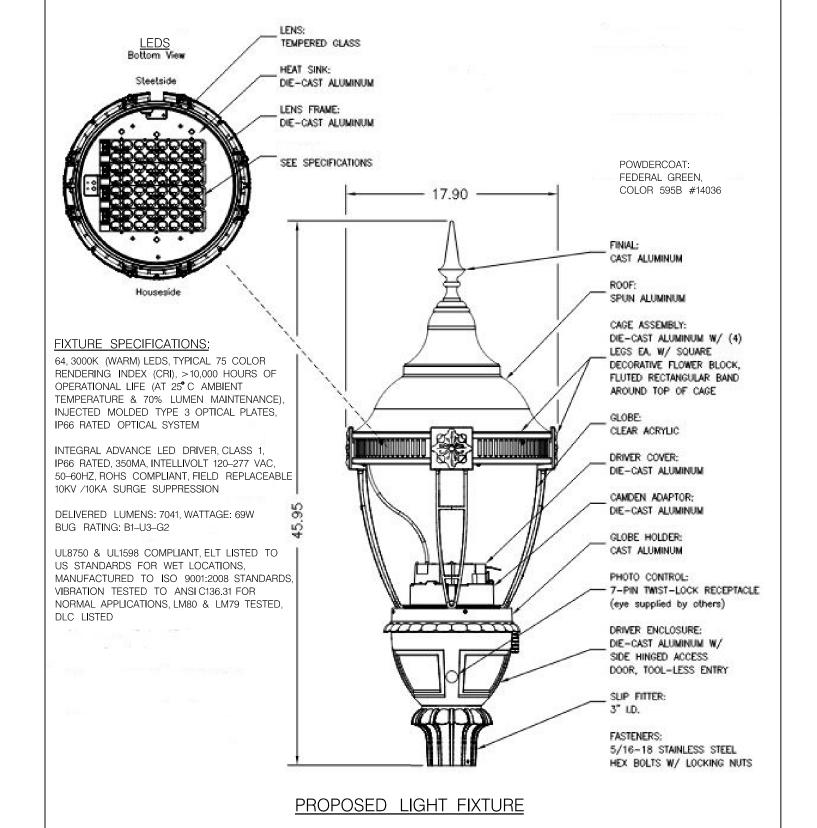

MDOT TEDD APPROVALS hris Strain 2/18/2022 Dean Randolph 2/28/2022 3/18/22 <u>Cedric Ward</u> DFFICE DIRECTOR

SHA TRACKING NO. 21-AP-MO-003-21

LT-02 WHITE FLINT METRO STATION

- 4" CONDUITS

1. THE CONTRACTOR SHALL TERMINATE THE CONDUITS WITH COUPLINGS AND PLUGS.

2. ONLY STANDARD WEIGHT READY MIX CONCRETE WILL BE APPROVED FOR ENCASEMENT.

3. NO METALLIC MATERIALS (REBARS, HOLD DOWN WIRES, ETC.) SHALL BE PERMITTED IN SPACES BETWEEN LOW VOLTAGE DUCTS.

4. PEPCO CONDUIT INSPECTOR SHOULD BE CONTACTED 48 HOURS (2 WORK DAYS) PRIOR TO ENCASEMENT OF CONDUIT FOR SCHEDULING TRANSMISSION AND DISTRIBUTION CONSTRUCTION INSPECTION AND APPROVAL.

CONCRETE ENCASED CONDUIT DUCT LINE CONFIGURATION



MEAD & HUNT, INC 7055 SAMUEL MORSE DRIVE SUITE 100 COLUMBIA, MD 21046 (443) 741-3500 WWW.MEADHUNT.COM

PROFESSIONAL CERTIFICATION: I HEREBY CERTIFY THAT THESE DOCUMENTS WERE PREPARED OR APPROVED BY ME, AND THAT I AM A DULY LICENSED PROFESSIONAL ENGINEER UNDER THE LAWS OF THE STATE LICENSE NO: 27451 EXPIRATION DATE: 1/23/2022

OF MARL P SHAOJIA OC P
Date: 2021:09 24 18:44:49-04:00' Digitally signed by Shaojia Du

MONTGOMERY COUNTY DEPARTMENT OF TRANSPORTATION ACCESS IMPROVEMENTS DIVISION OF TRANSPORTATION ENGINEERING GAITHERSBURG, MARYLAND RECOMMENDED FOR APPROVAL

Checked by :

SEE TITLE SHEET FOR SIGNATURES

SEE TITLE SHEET FOR SIGNATURES

Chief, Division of Transportation Engineering

Drawn by :__

Chief, Design Section

Designed by :_____

APPROVED

LIGHTING NOTES AND DETAILS

DATE: SEPT 2021 SCALE: NONE

2W(V)

Project No. : 502106

SHEET 11 of 28

2. THE PERMITTEE MUST HAVE A CERTIFIED TRAFFIC CONTROL MANAGER ON SITE DURING ALL PHASES OF INSPECTION AND CONSTRUCTION AT ALL TIMES.

3. EACH PHASE OF INSPECTION AND CONSTRUCTION, INCLUDING THE FOLLOW UP RESTORATION OPERATIONS, SHALL BE PROVIDED WITH APPROPRIATE WORK ZONE TRAFFIC CONTROLS.

4. ANY WORK WITHIN THE TRAVELED PORTION OF ROADWAYS SHALL BE RESTRICTED TO THE HOURS LISTED IN THE SPECIFICATIONS, MONDAY THROUGH FRIDAY. WORK ON HOLIDAYS AND WEEKENDS SHALL NOT OCCUR UNLESS AN EXEMPTION IS GRANTED IN WRITING BY THE COUNTY'S INSPECTOR.

5. CONSTRUCTION ACTIVITY. LOADING OR UNLOADING OF EQUIPMENT SHALL NOT BLOCK ANY TRAFFIC LANE OTHER THAN THOSE DELINEATED WITHIN THE WORK ZONE.

6. EXCLUSIVE OF EMERGENCY WORK, THE PERMITTEE SHALL CONTACT OCCUPANTS OF ALL ADJOINING PROPERTIES AND INFORM THEM OF THE SCOPE AND THE TIMING OF CONSTRUCTION. A MINIMUM OF 24 HOURS NOTIFICATION SHALL BE REQUIRED PRIOR TO THE COMMENCEMENT OF ANY ACTIVITY ON THE SITE.

7. ACCESS SHALL BE MAINTAINED TO ALL DRIVEWAYS UNLESS PERMISSION FOR CLOSURE IS GRANTED BY THE PROPERTY OWNER/MANAGER. HOWEVER, ACCESSIBILITY FOR EMERGENCY VEHICLES SHALL BE MAINTAINED AT ALL TIMES.

8. ALL TEMPORARY TRAFFIC CONTROL DEVICES SHALL CONFORM TO THE MOST RECENT EDITION OF THE 2011 MDMUTCD. ALL SIGNS, TRAFFIC DRUMS AND CONES SHALL BE FULLY REFLECTORIZED WITH HIGH INTENSITY, REFLECTIVE SHEETING AS PER THE MUTCD. TEMPORARY SIGNS SHALL BE FLUORESCENT ORANGE.

9. ALL WARNING SIGNS, UNLESS OTHERWISE SPECIFIED, SHALL BE A MINIMUM OF 48" X 48", BLACK SYMBOL OR LEGEND ON FLUORESCENT ORANGE BACKGROUND AND DIAMOND SHAPED.ALL WARNING SIGNS NOT APPLICABLE TO THE ACTUAL SITUATION SHALL BE REMOVED OR COVERED DURING NON-APPLICABLE PERIODS. ALL PORTABLE SIGNS SHALL BE MOUNTED A MINIMUM OF ONE (1) FOOT ABOVE THE LEVEL OF THE ROADWAY, WITH HIGHER MOUNTING HEIGHTS DESIRABLE.

IO.IF ANY TEMPORARY TRAFFIC CONTROL SIGNS ARE TO BE PLACED ALONG A MDOT SHA ROADWAY OR WITHIN THE LIMITS OF AN INCORPORATED AREA, THE PERMITTEE SHALL NOTIFY THE APPROPRIATE AGENCY OF SIGNAGE TO BE INSTALLED.

II.DURING NIGHTTIME OPERATIONS REFLECTORIZED TRAFFIC DRUMS SHALL BE USED.HOWEVER, FOR EMERGENCY WORK ACTIVITIES WHERE TRAFFIC DRUMS ARE NOT AVAILABLE, REFLECTORIZED TRAFFIC CONES THAT ARE A MINIMUM OF TWENTY EIGHT (28) INCHES IN HEIGHT AND HAVING SIX (6) INCH AND FOUR (4) INCH REFLECTIVE COLLARS WITHIN THE TOP SIXTEEN (16) INCHES OF THE CONE MAY BE USED. ALL WORK AREAS LEFT UNATTENDED AT NIGHT SHALL BE DELINEATED WITH REFLECTORIZED TRAFFIC DRUMS.

12. THE PERMITEE SHALL OBTAIN A TEMPORARY NOISE WAIVER FROM THE MONTGOMERY COUNTY DEPARTMENT OF ENVIRONMENTAL PROTECTION FOR ALL NIGHTTIME CONSTRUCTION ACTIVITIES.

SEQUENCE OF CONSTRUCTION FOR MAINTENANCE OF TRAFFIC

PHASE I

- I. INSTALL MAINTENANCE OF TRAFFIC CONTROL DEVICES FOR PHASE I, (SB MD 355).
- 2. CONSTRUCT TEMPORARY DRIVEWAY FOR WHITE FLINT STATION SHOPPING CENTER.
- 3. SHIFT TRAFFIC TO TEMPORARY DRIVEWAY.
- 4. CONSTRUCT SB MD 355 FROM STA 371+54 TO 370+93.
- 5. SHIFT TRAFFIC TO NEW DRIVEWAY.
- 6. CONSTRUCT SOUTHBOUND MD 355 FROM 375+52 TO 371+54.

PHASE 2

- I. INSTALL MAINTENANCE OF TRAFFIC CONTROL DEVICES FOR PHASE 2.
- 2. CONSTRUCT NORTHBOUND MD 355.

INSPECTOR AUTHORITY

I. THE COUNTY'S DEPARTMENT OF PERMITTING SERVICES (DPS) INSPECTOR HAS THE AUTHORITY TO MODIFY THE TTCP AS DEEMED NECESSARY. THE INSPECTOR HAS THE AUTHORITY TO ORDER THE PERMITTEE TO STOP WORK AND VACATE THE PUBLIC RIGHT-OF-WAY IF THE TTCP IS NOT COMPLIED WITH.

2. THE IMPLEMENTATION DATE AND CONTINUANCE OF WORK ACTIVITIES MAY BE ALTERED AT THE DISCRETION OF THE COUNTY'S INSPECTOR IN THE EVENT OF CONFLICTS WITH PREVIOUSLY APPROVED OR EMERGENCY ACTIVITIES.

<u>MISCELLANEOUS</u>

I. THE PERMITTEE WILL BE SOLELY RESPONSIBLE FOR ALL ACCIDENTS AND/OR DAMAGE TO PERSONS AND/OR PROPERTY DAMAGE RESULTING FROM HIS OPERATIONS.

2. HAZARDOUS MATERIALS SHALL NOT BE STORED WITHIN PUBLIC RIGHT-OF-WAY. NO MATERIALS OR EQUIPMENT SHALL BE STORED ON THE ROADWAY SURFACE OR SIDEWALK DURING NON-WORK PERIODS. ALL STORED MATERIALS AND EQUIPMENT SHALL BE SET BACK AT LEAST SIX (6) FEET BEHIND THE CURB ALONG A CLOSED SECTION ROADWAY AND AT LEAST TWELVE (12) FEET FROM THE EDGE OF AN OPEN SECTION ROADWAY.

3. ALL TEMPORARY TRAFFIC CONTROL (TTC) DEVICES SHALL BE REMOVED AS SOON AS PRACTICAL WHEN THEY ARE NO LONGER NEEDED. WHEN WORK IS SUSPENDED FOR SHORT PERIODS OF TIME, TTC DEVICES THAT ARE NO LONGER APPROPRIATE SHALL BE REMOVED OR COVERED.

4. AT THE COMPLETION OF WORK ACTIVITIES, CONDITIONS WITHIN THE PUBLIC SPACE SHALL BE FULLY RESTORED TO THOSE THAT EXISTED PRIOR TO THE WORK ACTIVITY.

CONTACT INFORMATION

I.THE CONTRACTOR SHALL ARRANGE AND HOST A PRE-PHASE TRAFFIC SWITCH MEETING AT LEAST TWO WEEKS PRIOR TO SWITCHING TRAFFIC. THE FOLLOWING OFFICES SHALL BE NOTIFIED OF THIS MEETING AND OF THE IMPENDING TRAFFIC SWITCH:

- * MONTGOMERY COUNTY DIVISION OF TRAFFIC ENGINEERING AND OPERATIONS AT 240-777-6000
- * MONTGOMERY COUNTY TRANSPORTATION SYSTEMS ENGINEEERING TEAM AT 240-777-2100
- * MONTGOMERY COUNTY TRANSIT AT 240-777-5800
- * MONTGOMERY COUNTY PUBLIC SCHOOLS, LOCAL DEPOT MANAGER
- * MONTGOMERY COUNTY FIRE AND RESCUE, LOCAL FIRE DEPARTMENT CAPTAIN
- * MONTGOMERY COUNTY POLICE, LOCAL TRAFFIC SERGEANT
- * MONTGOMERY COUNTY DEPARTMENT OF PERMITTING SERVICES, PERMIT INSPECTION SECTION AT 240-777-6300

2. PRIOR TO ROAD CLOSURES, THE CONTRACTOR SHALL NOTIFY THE FOLLOWING OFFICES A MINIMUM OF SEVENTY-TWO (72) HOURS IN ADVANCE:

- * MONTGOMERY COUNTY DIVISION OF TRAFFIC ENGINEERING AND OPERATIONS AT 240-777-6000
- * MONTGOMERY COUNTY EMERGENCY OPERATIONS CENTER AT 240-777-0751
- * MONTGOMERY COUNTY POLICE, LOCAL TRAFFIC SERGEANT
- * MONTGOMERY COUNTY TRANSPORTATION MANAGEMENT CENTER AT 240-777-2100
- * MONTGOMERY COUNTY FIRE AND RESCUE, LOCAL FIRE DEPARTMENT CAPTAIN
- * MONTGOMERY COUNTY PUBLIC SCHOOLS, LOCAL DEPOT MANAGER

3. FIELD ASSISTANCE BY THE MCDOT, DIVISION OF TRAFFIC ENGINEERING AND OPERATIONS IS AVAILABLE UPON REQUEST. CONTACT TRAFFIC ENGINEERING & OPERATIONS SECTION AT 240-777-6000.

SHA TRACKING NO. 21-AP-MO-003-21

MT - 01

WHITE FLINT METRO STATION MONTGOMERY COUNTY DEPARTMENT OF TRANSPORTATION DIVISION OF TRANSPORTATION ENGINEERING ACCESS IMPROVEMENTS GAITHERSBURG, MARYLAND RECOMMENDED FOR APPROVAL MAINTENANCE OF TRAFFIC PLAN REVISION DATE SEE TITLE SHEET FOR SIGNATURES Chief, Design Section GENERAL NOTES APPROVED

SEE TITLE SHEET FOR SIGNATURES
Chief, Division of Transportation Engineering

SCALE : 1" = 30"DATE: SEPT 2021



PROFESSIONAL CERTIFICATION: THEREBY CERTIFY THAT THESE DOCUMENTS WERE PREPARED OR APPROVED BY ME, AND THAT I AM A DULY LICENSED PROFESSIONAL ENGINEER UNDER THE LAWS OF THE STATE OF MARYLAND,


Designed by : RJM

Drawn by: WH

Checked by :

Project No. : 502106

SHEET 12 of 28

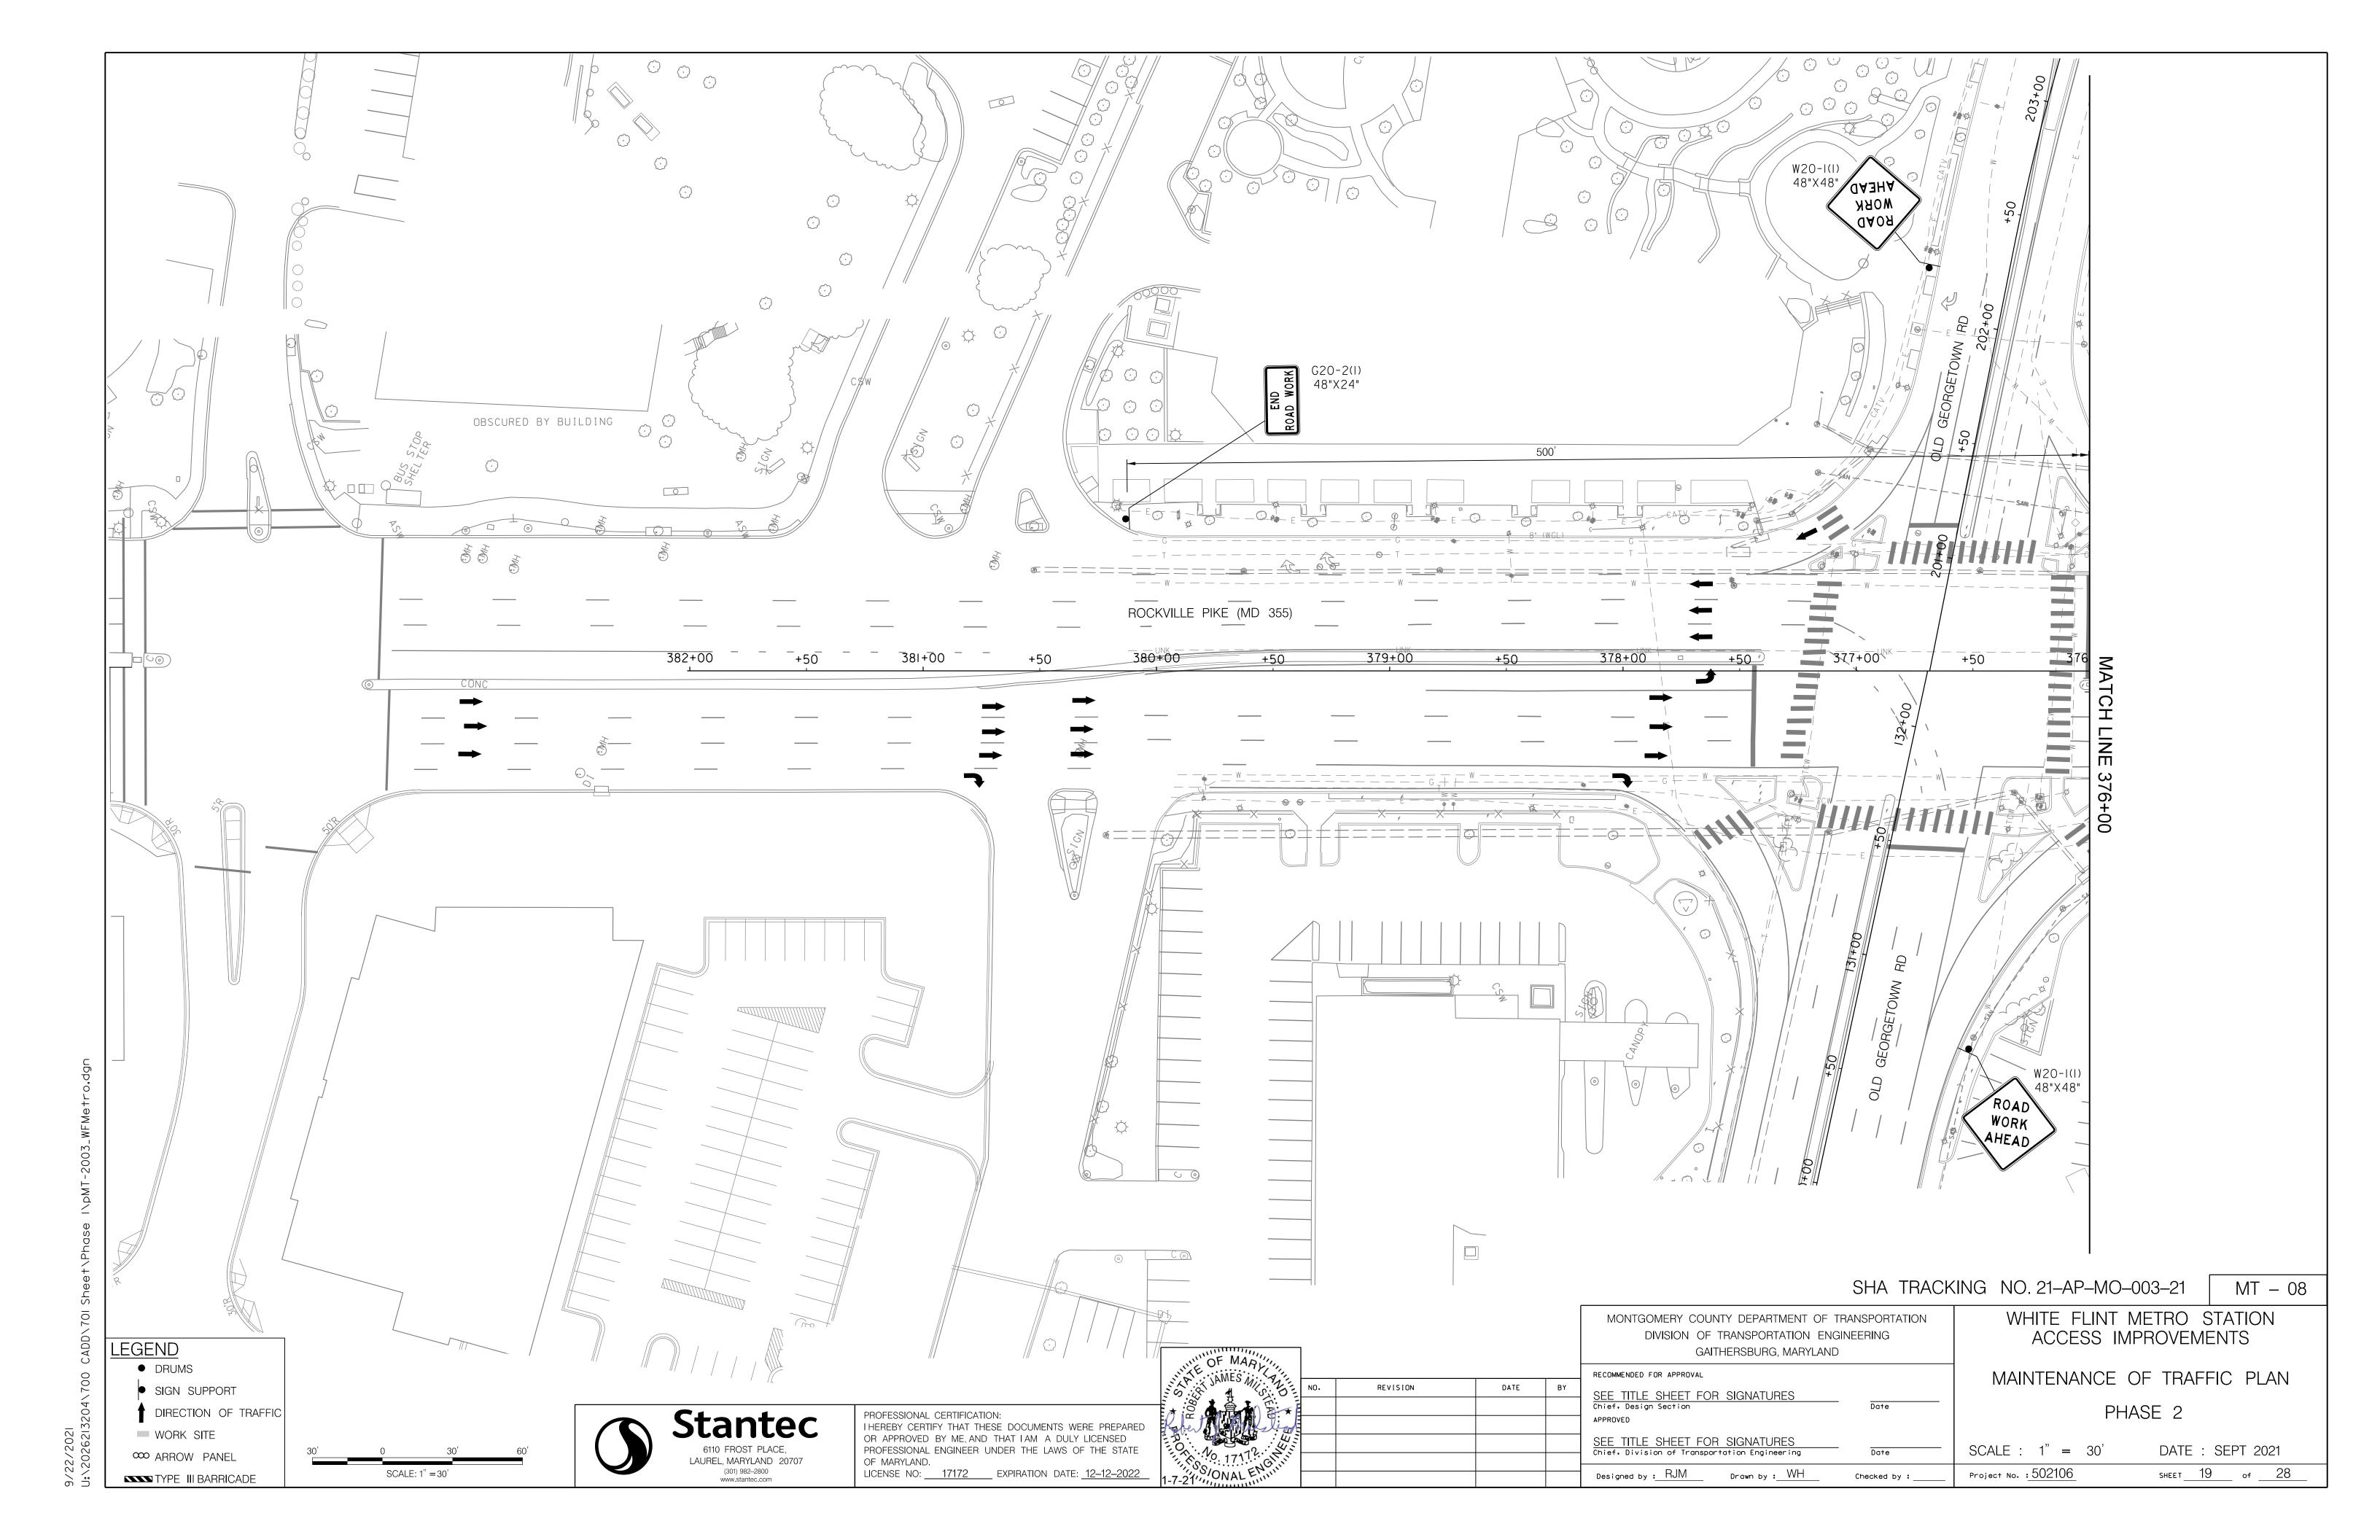

CRITERIA

THE CONTRACTOR SHALL BE GOVERNED BY THE STANDARDS AND REQUIREMENTS OF THE FOLLOWING PUBLICATIONS, EXCEPT AS MODIFIED BY THE SPECIAL PROVISIONS OF THIS CONTRACT:

<u>DESIGN</u>

MDOT SHA - "MARYLAND MANUAL ON UNIFORM TRAFFIC CONTROL DEVICES", 2011 EDITION AND SUBSEQUENT REVISIONS. (MDMUTCD)

A A S H T O - "HIGHWAY SAFETY DESIGN AND OPERATIONS GUIDE" -1997

A A S H T O - "STANDARD SPECIFICATIONS FOR STRUCTURAL SUPPORTS FOR HIGHWAY SIGNS LUMINAIRES AND TRAFFIC SIGNALS", 2001 EDITION (CATEGORY II FOR ALL OVERHEAD AND CANTILEVER SIGN STRUCTURES).

MATERIALS AND CONSTRUCTION

MDOT SHA - "STANDARD SPECIFICATIONS FOR CONSTRUCTION & MATERIALS", MOST CURRENT EDITION AND SUBSEQUENT REVISIONS AND SUPPLEMENTS.

ALL DISTRICTS

MDOT SHA - "BOOK OF STANDARDS FOR HIGHWAY AND INCIDENTAL STRUCTURES", MOST CURRENT EDITION AND SUBSEQUENT REVISIONS AND SUPPLEMENTS.

DESIGN WIND

100 MPH - WOOD SUPPORTS IO YEAR RECURRENCE INTERVAL

100 MPH - GROUND MOUNT SIGN STEEL SUPPORTS IO YEAR RECURRENCE INTERVAL

100 MPH - OVERHEAD AND CANTILEVER STRUCTURES 50 YEAR RECURRENCE INTERVAL

DESIGN STRESS

SOIL BEARING PRESSURE - S = 3,000 P.S.F. (ASSUMED) SEE MATERIAL & CONSTRUCTION ABOVE AND SPECIAL PROVISIONS FOR DESIGN STRESSES FOR STRUCTURAL STEEL, ALUMINUM, REINFORCING STEEL AND CONCRETE.

CHAMFER

ALL EXPOSED EDGES OF CONCRETE SHALL HAVE A 3/4" X 3/4" CHAMFER.

CLASSIFICATION OF SIGNS

SIGNS ARE DIVIDED INTO TWO (2) GENERAL CATEGORIES. B) PANELS

I. GUIDE SIGNS

A) STRUCTURAL TYPES

OH - OVERHEAD C - CANTILEVER

GM - GROUND MOUNT, BREAKAWAY

OR NON-BREAKWAY

BM - BRIDGE MOUNTED

B) PANELS

2. STANDARD SIGNS (REGULATORY, WARNING, ETC.) A) STRUCTURAL TYPES

WOOD SUPPORTS

MATERIAL - SHEET ALUMINUM COPY - DIRECT APPLIED

MATERIAL - EXTRUDED ALUMINUM

I) HIGH INTENSITY (NEW SIGNS AND

REVISIONS TO EXISTING SIGNS)

COPY - DIRECT APPLIED

IDENTIFICATION OF SIGNS AND PANELS

SQUARE TUBE

EACH GUIDE SIGN IS IDENTIFIED BY A SIGN NUMBER ON THE PLANS AND IN THE TABULATIONS. (GM-I, GM-2, GM-3, etc)

SIGNS ON STRUCTURES ARE IDENTIFIED WITH A NUMBER AND WHERE VARIATIONS OCCUR. A LOWER CASE LETTER. (OH-Ia, OH-Ib, OH-Ic)

STANDARD SIGNS

STANDARD SIGNS ARE IDENTIFIED BY PANEL NUMBERS AND ARE CLASSIFIED AS FOLLOWS

- R REGULATORY W - WARNING
- M ROUTE MARKERS AND ACCESSORIES
- D DESTINATION AND MILEAGE PANELS
- S SCHOOL

PANELS SHALL BE DESIGNATED TO AGREE WITH MARYLAND STANDARD SIGN BOOK. EACH STANDARD SIGN IS IDENTIFIED FIRST BY THE SHEET NUMBER, THEN BY THE NUMERICAL ORDER OF THE SIGN AS IT APPEARS ON THE PLAN. FOR EXAMPLE SHEET SN 2.1-101,102,103, ETC. SHEET SN 2.2-201,202,203,ETC.

PANEL LAYOUT AND ALPHABETS

Stantec

6110 FROST PLACE,


LAUREL, MARYLAND 20707

I. GUIDE SIGN PANEL LAYOUTS ARE BASED ON THE A.A.S.H.T.O. MANUALS NOTED ABOVE. 2. STANDARD SIGN PANEL LAYOUTS ARE BASED ON THE MDMUTCD WITH SPECIFICATIONS DETAILED IN THE MARYLAND STATE HIGHWAY ADMINISTRATION PUBLICATION, "STANDARD SIGN BOOK", AVAILABLE ONLINE AT http://apps.roads.maryland.gov/businesswithsha/ bizstdsspecs/desmanualstdpub/publicationsonline/oots/internet_signbook.asp


HEREBY CERTIFY THAT THESE DOCUMENTS WERE PREPARED OR APPROVED BY ME, AND THAT I AM A DULY LICENSED PROFESSIONAL ENGINEER

UNDER THE LAWS OF THE STATE OF MARYLAND.

17172 MD LICENSE NUMBER 12-12-2022 **EXPIRATION DATE**

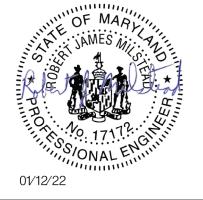

ORIENTATION OF SIGN FACES

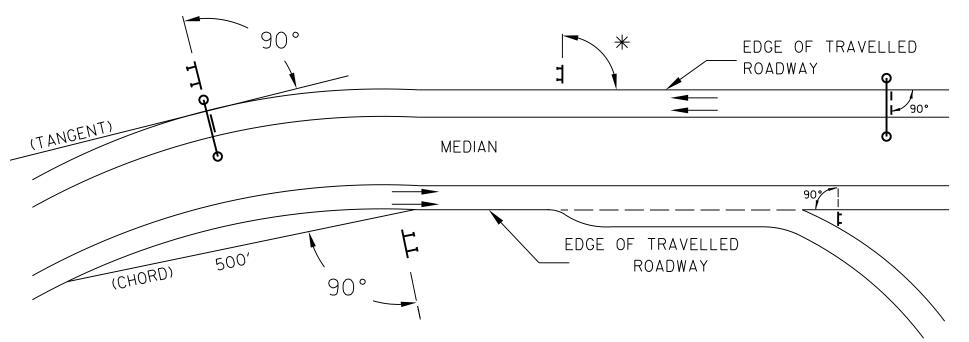

* UNDER 30 FEET FROM TRAVELLED ROADWAY TO NEAR EDGE OF SIGN - 93° AWAY FROM THE ROAD TO AVOID SPECULAR REFLECTION AS INDICATED IN 813.03 OF THE MARYLAND STANDARD SPECIFICATIONS FOR CONSTRUCTION AND MATERIALS.

OVER 30 FEET FROM TRAVELLED ROADWAY TO NEAR EDGE OF SIGN - 90°

REFLECTORIZATION

BACKGROUNDS, BORDERS, TEXTS AND ALL OTHER ELEMENTS OF SIGN PANELS SHALL BE REFLECTORIZED EXCEPT WHERE NOTED. REFER TO PROJECT REQUIREMENTS FOR MORE DETAIL.

SIGN LOCATIONS

I. GUIDE SIGNS ARE LOCATED ON THE PLANS BY DIMENSION TO SURVEY STATIONS, OR WHEN NECESSARY, TO IDENTIFIABLE PHYSICAL FEATURES.

2. ALL CHANGES IN THE LOCATIONS OF SIGNS AS SHOWN ON THE PLAN SHALL HAVE THE PRIOR APPROVAL OF THE ENGINEER.

EXISTING UTILITIES

THE ENGINEER DOES NOT WARRANT OR GUARANTEE THE ACCURACY OR COMPLETENESS OF UTILITY INFORMATION SHOWN ON THE PLAN. IT SHALL BE THE RESPONSIBILITY OF THE CONTRACTOR TO LOCATE AND PROTECT ALL EXISTING FACILITIES WHICH MIGHT BE AFFECTED BY THIS WORK OR HIS OPERATION.

ROADSIDE SIGNS

I. VERTICAL ALIGNMENT

POSITION PANEL SO FACE IS PLUMB.

2. HORIZONTAL ALIGNMENT (SEE DIAGRAM ABOVE) A) ON STRAIGHT ROADWAY SECTIONS, ANGLE OF SIGN FACE TO ROADWAY VARIES WITH DISTANCE FROM TRAVELLED ROADWAY TO NEAR EDGE OF SIGN - SEE DIAGRAM.

B) ON THE INSIDE OF HORIZONTAL CURVES, POSITION SIGN SO FACE OF PANEL MAKES AN ANGLE OF 90° WITH A CHORD BETWEEN A POINT ON NEAR EDGE OF PAVEMENT AT SIGN LOCATION AND A POINT ON EDGE OF PAVEMENT 500' IN ADVANCE OF SIGN. C) ON THE OUTSIDE OF HORIZONTAL CURVES, POSITION SIGN SO FACE OF PANEL IS

AT RIGHT ANGLES TO THE TANGENT OF THE CURVE AT THE SIGN LOCATION. D) POSITIONING OF SIGNS AT GORES AND RAMP SEPARATIONS IS REFERRED TO THE NORMAL EDGE OF THE MAINLINE ROADWAY.

OVERHEAD SIGNS

I. VERTICAL ALIGNMENT

POSITION PANELS FOR ALL OVERHEAD STRUCTURES SO THAT PANEL FACE IS PLUMB.

2. OVERHEAD SIGN STRUCTURES SHALL NOT BE ERECTED WITHOUT ATTACHING LUMINAIRES, SUPPORTS. AND/OR SIGNS.

3. HORIZONTAL ALIGNMENT

A) POSITION ALL OVERHEAD SIGNS SO THAT THE FACE OF THE PANEL IS AT RIGHT ANGLES TO THE NORMAL EDGE OF ROADWAY. IF ON A STRAIGHT ROADWAY SECTION.

B) POSITION ALL OVERHEAD SIGNS SO THAT THE FACE OF THE PANEL IS AT RIGHT ANGLES TO THE TANGENT OF THE CURVE AT SIGN LOCATION. IF ON A HORIZONTAL CURVE.

C) POSITIONING OF SIGNS AT GORES AND RAMP SEPARATIONS IS REFERRED TO THE NORMAL EDGE OF THE MAINLINE ROADWAY.

4. VERTICAL CLEARANCE

A) OVERHEAD SIGNS SHALL HAVE A MINIMUM VERTICAL CLEARANCE OF 17'-9" FROM ROADWAY TO THE BOTTOM OF LIGHT FIXTURES. ALL LIGHT FIXTURES ARE TO BE AT THE SAME ELEVATION. B) IF THE CONTRACTOR CANNOT OBTAIN 17'-9" (SEE 3A) CLEARANCE, HE IS TO CEASE WORK AND CONTACT THE PROJECT ENGINEER FOR FURTHER INSTRUCTIONS. THE PROJECT ENGINEER

MAY CONTACT THE TRAFFIC ENGINEERING DESIGN DIVISION FOR ASSISTANCE. C) ON ALL OVERHEAD SIGNS, THE MINIMUM CLEARANCE TO BOTTOM OF DESIGN SIGN: 20'-9".

PROJECT REQUIREMENTS

ALL NEW SIGNS ON THIS PROJECT SHALL BE FABRICATED FROM SHEETING WHICH MEETS ALL OF THE FOLLOWING REQUIREMENTS, UNLESS OTHERWISE SPECIFIED IN THE CONTRACT DOCUMENTS, OR AS DIRECTED BY THE ENGINEER:

I. SHEETING SHALL MEET THE REQUIREMENTS OF SECTIONS 813 AND 950.03 OF MDOT SHA'S STANDARD SPECIFICATIONS FOR CONSTRUCTION AND MATERIALS 2017 EDITION AND SUBSEQUENT REVISIONS AND SUPPLEMENTS.

2. LISTED ON MDOT SHA OFFICE OF TRAFFIC AND SAFETY'S QUALIFIED PRODUCTS LIST (QPL).

PROJECT REQUIREMENTS CONT'D

3. THE FOLLOWING TYPES OF SHEETING SHALL BE USED FOR THE SPECIFIED SIGN CLASSIFICATIONS:

GENERAL NOTE: ALL COLORS SHALL BE RETROREFLECTIVE EXCEPT BLACK BLACK TEXT. BORDERS. SYMBOLS OR ANY BLACK ELEMENTS OF ANY SIGN SHALL BE NON-REFLECTIVE. THIS APPLIES TO ALL MDOT SHA SIGNS AS SHOWN BELOW.

A) GUIDE, EXIT GORE, GENERAL INFORMATION, AND SERVICE SIGNS - FALL INTO TWO SUB CATEGORIES:

(I). GROUND MOUNTED:

ALL RETROREFLECTIVE SHEETING ELEMENTS OF THESE SIGNS SHALL MEET OR EXCEED THE REQUIREMENTS FOR ASTM TYPE IX (9).

(II). OVERHEAD STRUCTURE SIGNS AND OVERHEAD CANTILEVER SIGNS:

ALL RETROREFLECTIVE SHEETING ELEMENTS OF ALL OVERHEAD SIGNS SHALL MEET OR EXCEED THE REQUIREMENTS FOR ASTM TYPE XI(II). (THIS SECTION DOES NOT APPLY TO OVERHEAD SIGNALIZED INTERSECTION SIGNING; MAST ARM OR SPAN WIRE. FOLLOW THE REQUIREMENTS FOR THE RESPECTIVE SIGN CLASSIFICATION FOR SIGNAL SIGNING.)

B) WARNING SIGNS - RETROREFLECTIVE SHEETING FOR WARNING SIGNS (FLUORESCENT YELLOW AND FLUORESCENT ORANGE) SHALL MEET OR EXCEED THE REQUIREMENTS FOR ASTM TYPE IX (9). REGULATORY MESSAGES WITHIN WARNING SIGNS SHALL FOLLOW THE REQUIREMENTS FOR REGULATORY SIGNS.

C) SCHOOL SIGNS - RETROREFLECTIVE SHEETING FOR SCHOOL SIGNS (FLUORESCENT YELLOW AND FLUORESCENT YELLOW-GREEN) SHALL MEET OR EXCEED THE REQUIREMENTS FOR ASTM TYPE IX (9). REGULATORY MESSAGES WITHIN SCHOOL SIGNS SHALL FOLLOW THE REQUIREMENTS FOR REGULATORY SIGNS.

D) REGULATORY SIGNS - FALL INTO THREE SUBCATEGORIES:

(I). "RED" REGULATORY SIGNS; (SPECIFICALLY - STOP, YIELD, DO NOT ENTER AND WRONG WAY). ALL RETROREFLECTIVE SHEETING ELEMENTS OF THESE SIGNS SHALL MEET OR EXCEED THE REQUIREMENTS FOR ASTM TYPE IX (9).

(II). ALL R7 AND R8 SERIES PARKING RELATED SIGNS AND THEIR SUPPLEMENTAL PANELS, NO TRESPASSING SIGNS, AND SIGNS DIRECTED AT PEDESTRIANS AND BICYCLISTS ONLY. ALL RETROREFLECTIVE SHEETING ELEMENTS OF THESE SIGNS SHALL MEET THE REQUIREMENTS FOR ASTM TYPE IV (4).

(III). ALL OTHER REGULATORY SIGNS - ALL RETROREFLECTIVE SHEETING ELEMENTS OF THESE SIGNS SHALL MEET ASTM TYPE IV (4) INCLUDING RED ELEMENTS. WARNING MESSAGES WITHIN REGULATORY SIGNS SHALL FOLLOW THE REQUIREMENTS FOR WARNING SIGNS.

E) ROUTE MARKERS (INDEPENDENT USE AND GUIDE SIGN USE)

INDEPENDENT USE: ALL RETROREFLECTIVE SHEETING ELEMENTS OF THESE SIGNS SHALL MEET BUT NOT TO EXCEED THE REQUIREMENTS FOR ASTM TYPE IV (4).

GUIDE SIGN USE: WHEN INCORPORATED IN THE BODY OF A GUIDE SIGN, ALL RETROREFLECTIVE SHEETING ELEMENTS OF THESE SIGNS SHALL MEET THE SHEETING REQUIREMENTS OF THE GUIDE SIGNS FOR WHICH THEY ARE TO BE APPLIED; GROUND MOUNT ASTM TYPE IX (9) OR OVERHEAD ASTM TYPE XI(II).

F) LOGOS AND / OR GRAPHICS - WITHIN SIGNS SHALL FOLLOW THE REQUIREMENTS FOR THE RESPECTIVE SIGN CLASSIFICATION UNLESS OTHERWISE SPECIFIED IN THE CONTRACT DOCUMENTS. OR AS DIRECTED BY THE ENGINEER.

G) SPECIFIC SERVICE (LOGO) SIGNING - ALL COPY, DIVIDER BORDERS, LOGOS AND ARROWS SHALL BE DEMOUNTABLE ALUMINUM OVERLAYS, .032 MINIMUM TO .063 MAXIMUM. ALL RETROREFLECTIVE SHEETING ELEMENTS OF THESE SIGNS SHALL MEET OR EXCEED THE REQUIREMENTS FOR ASTM TYPE IX (9). DISTANCES ON DIRECTIONAL ARROWS WHEN SPECIFIED SHALL BE BLACK. THE OVERLAYS ARE TO BE APPLIED WITH .125 ALUMINUM POP RIVETS TO THE BODY OF THE MAIN SIGN.

H) CIVIL DEFENSE SIGNS AND OTHER SIGNS - NOT SPECIFICALLY FALLING INTO ONE OF THE CATEGORIES ABOVE. SHALL FOLLOW THE GUIDELINES FOR THE SIGN CLASSIFICATION THAT MOST CLOSELY MATCHES THE COLOR(S) OF THE PROPOSED SIGN.

4. THE FOLLOWING MINIMUM THICKNESS SHALL BE USED FOR THE APPROPRIATE WIDTH OF SHEET ALUMINUM BLANKS:

LONGECT DIMENSION

LONGEST DIMENSION	MINIMUM THICKNESS
UP TO 12"	0.040"
GREATER THAN 12" TO 24"	0.063"
GREATER THAN 24" TO 36"	0.080"
GREATER THAN 36" TO 48"	0.100"
OVER 48"	0.125"


MARYLAND DEPARTMENT OF TRANSPORTATION STATE HIGHWAY **ADMINISTRATION**

OFFICE OF TRAFFIC & SAFETY TRAFFIC ENGINEERING DESIGN DIVISION

SN - 0

WHITE FLINT METRO STATION ACCESS IMPROVEMENTS MD 355 (ROCKVILLE PIKE) SHA TRACKING NO. 21-AP-MO-003-21

APPROVALS	REVISIONS	GEN	ERAL NOT	TES AND	PROPOSALS
Aris Strain 2/18/2022		SCALE <u>N.T.S.</u>	_ ADVERTISED DAT	Ē(CONTRACT NO. < CONTRACT NO>
Dean Randolph 2/28/2022 SST. DIV. CHIEF					MONTGOMERY 15035506.356
Lili Liang 3/1/2022 VISION CHIEF			NA	_	
Pedric Ward 3/15/2022		DRAWING NO.	SN-1	1 OF 1	SHEET NO. 20 OF 28

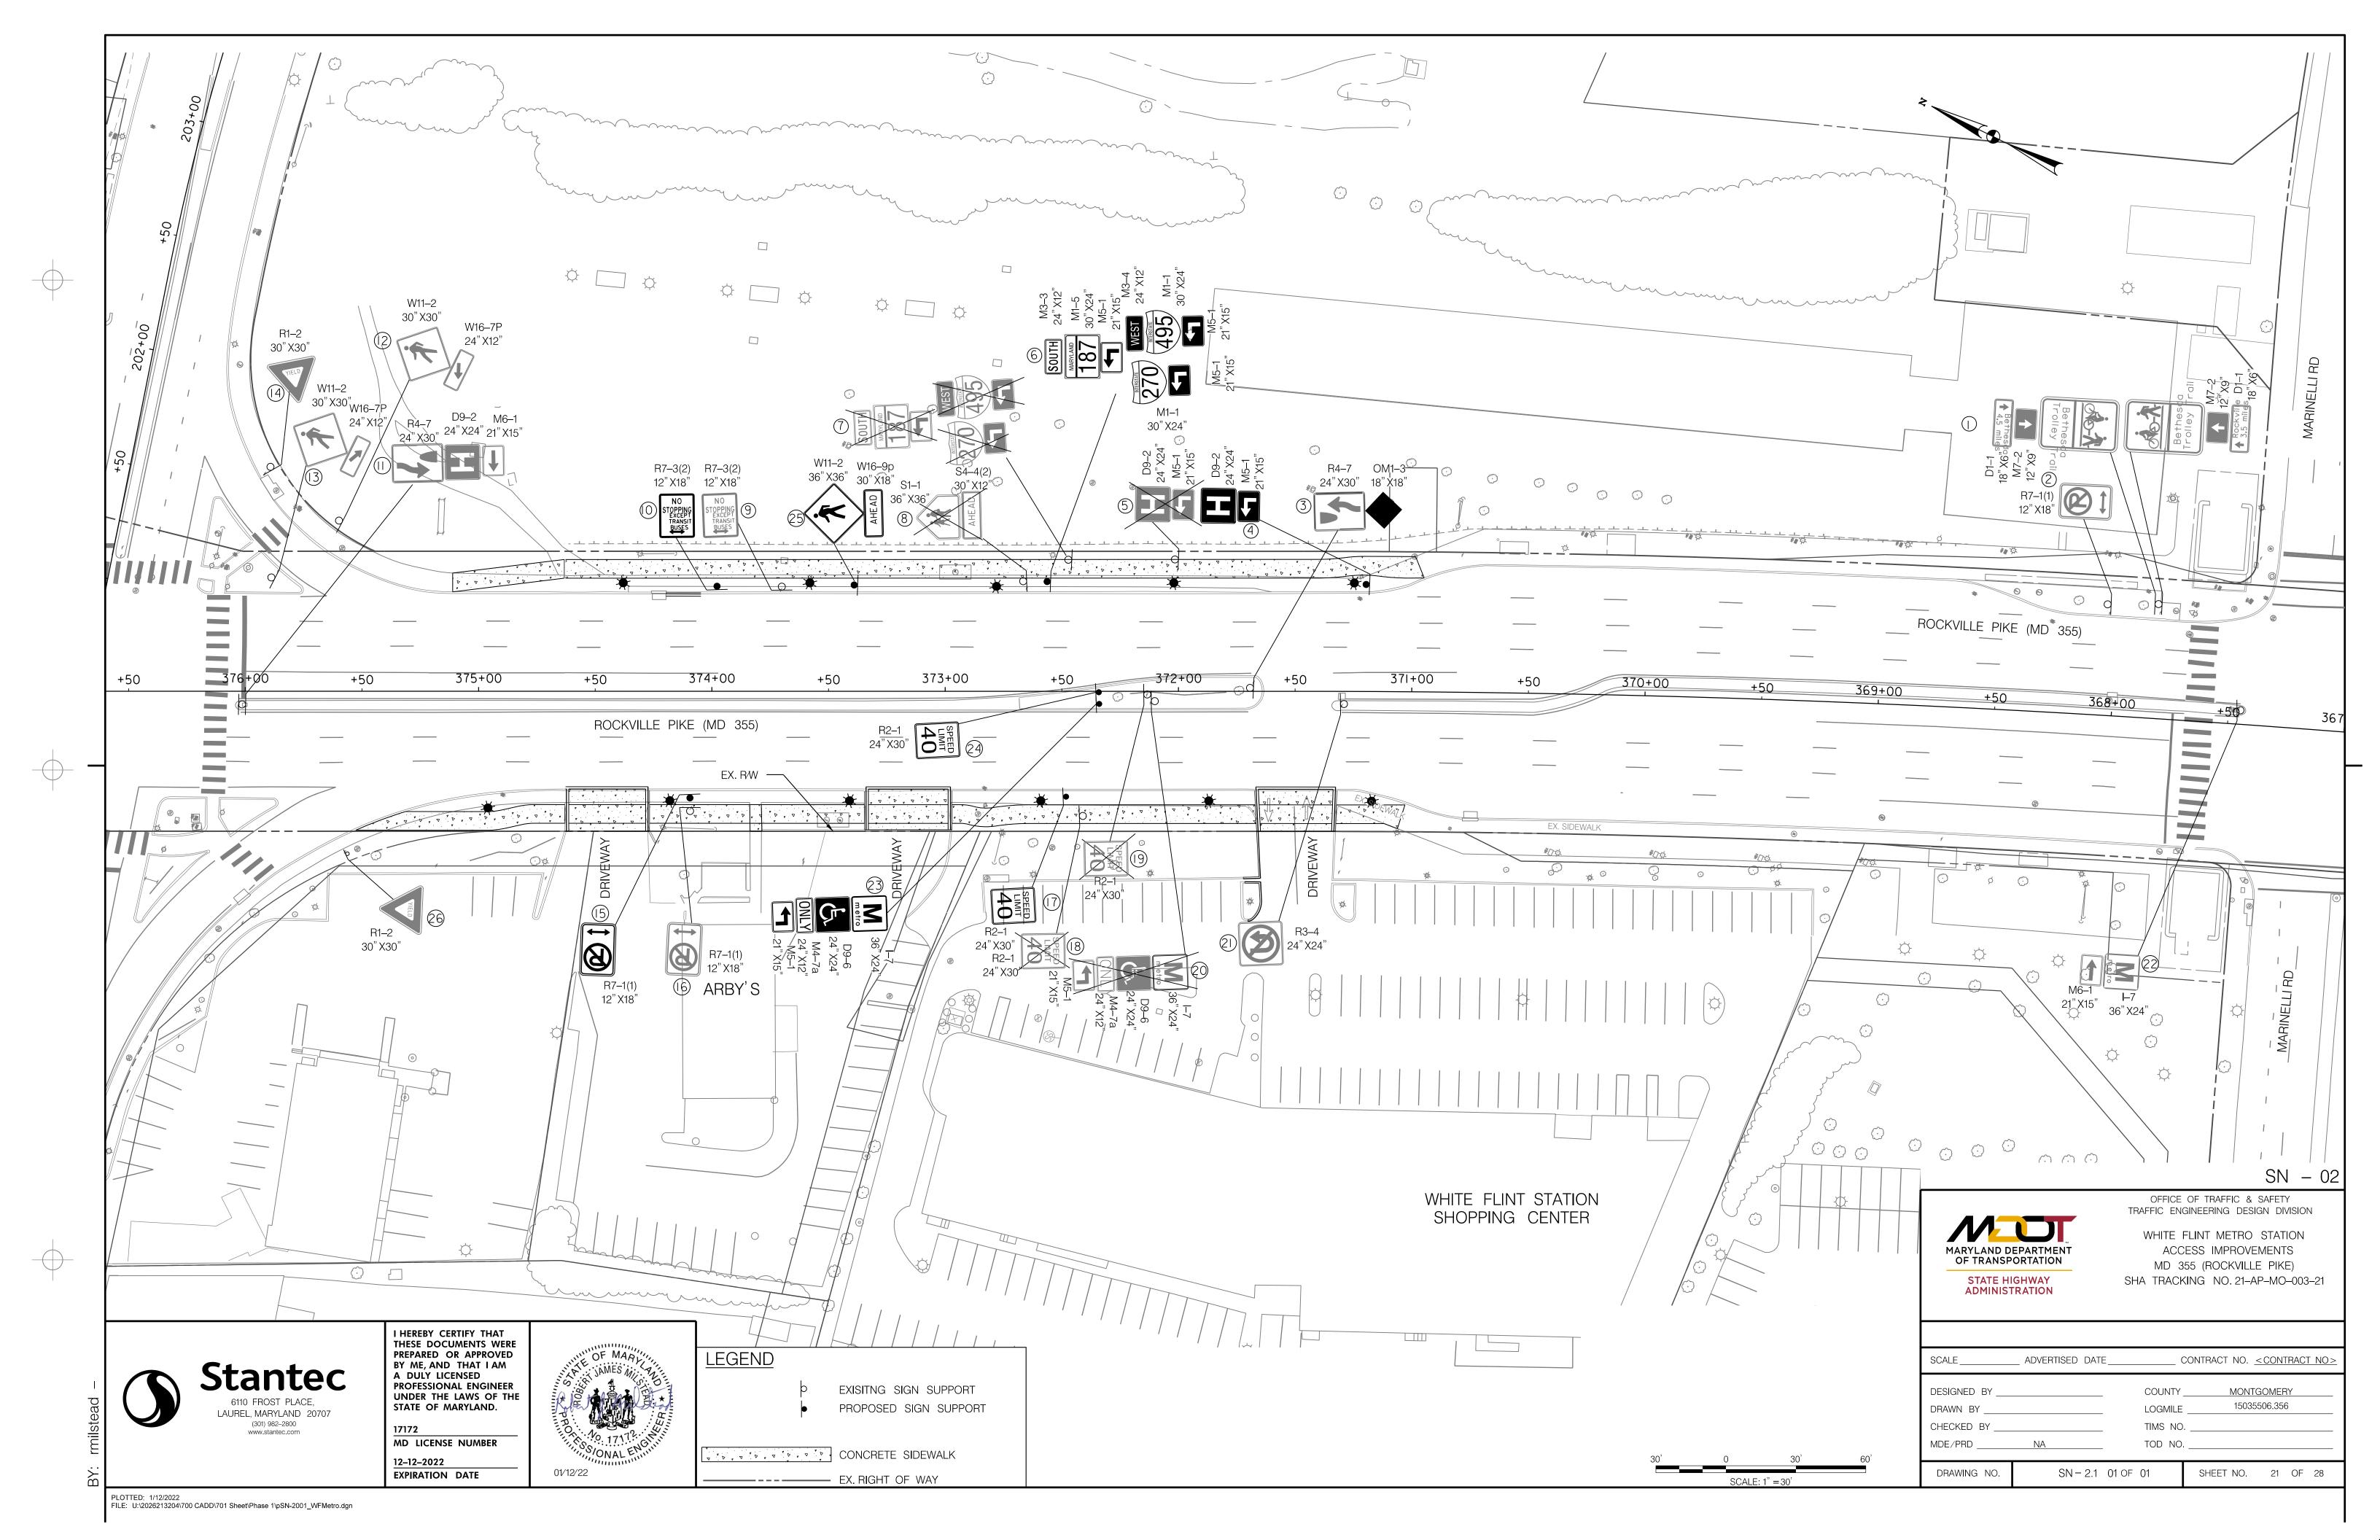

CODE NUMBERS * REMARKS NO. 10 19 20 11 | 12 13 14 15 16 SN-02 Bethesda Trolley Trail (18"X24"), M7-2 (12"X9"), DI-I (18"X6"), Bethesda Trolley Trail (18"X24"), M7-2 (12"X9"), DI-I (18"X6") EXISTING R7-I(I) (I2"XI8") EXISTING EXISTING R4-7 (24"X30") D9-2 (24"X24"), M5-I (21"XI5") I- PERFORATED TUBULAR STEEL POST EXISTING TO BE REMOVED 6.2 D9-2 (24"X24"), M5-I (21"XI5") M3-3 (24"X12"), MI-5 (30"X24"), M5-I(21"X15") M3-4 (24"X12"), MI-I(30"X24"), M5-I(21"X15"), MI-I(30"X24"), M5-I(21"X15") IBREAKWAY- 6" X8" WOOD POST 25.6 22 EXISTING TO BE REMOVED 25.6 M3-3 (24"XI2"), MI-5 (30"X24"), M5-I (21"XI5"), M3-4 (24"XI2"), MI-I (30"X24"), M5-I (21"XI5"), MI-I (30"X24"), M5-I (21"XI5") EXISTING TO BE REMOVED 11.5 SI-I (36"X36"), S4-4(2) (30"XI2") EXISTING TO BE REMOVED 1.5 R7-3(2) (12"X18") I- PERFORATED TUBULAR STEEL POST 1.5 R7-3(2) (I2"XI8") D9-2 (24"X24"), M6-I (21"XI5"), R4-7 (24"X30") EXISTING $WII-2 (30" \times 30"), WI6-7P (24" XI2")$ EXISTING EXISTING WII-2 (30"×30"), WI6-7P (24"XI2") RI-2 (30"X30") EXISTING R7-I(I) (I2"XI8") I- PERFORATED TUBULAR STEEL POST 1.5 R7-I(I) (I2"XI8") EXISTING TO BE REMOVED 1.5 I- PERFORATED TUBULAR STEEL POST 5.0 R2-I (24"X30") R2-I (24"X30") EXISTING TO BE REMOVED 5.0 EXISTING TO BE REMOVED R2-I (24"X30") 5.0 EXISTING TO BE REMOVED I-7 (36"x24"), D9-6 (24"X24"), M4-7a (24"XI2"), M5-I (21"XI5") 14.2 R3-4 (24"X24") EXISTING EXISTING I-7 (36"X24"), M6-I (21"XI5") I-7 (36"×24"), D9-6 (24"X24"), M4-7a (24"XI2"), M5-I (2I"XI5") I- PERFORATED TUBULAR STEEL POST 14.2 I- PERFORATED TUBULAR STEEL POST R2-I (24"X30") I- PERFORATED TUBULAR STEEL POST 12.8 WII-2 (36"X36"), WI6-9p (30"XI8") RI-2 (30"X30") EXISTING 71.8 70.5 22 TOTAL

UNIT

S.F.

S.F.

L.F.

E.A.

E.A.

* CODE NUMBER DESCRIPTION & UNIT

REMOVE EXISTING GROUND MOUNTED SIGN AND SUPPORTS

F&ISHEET ALUMINUM SIGNS

BREAKWAY WOOD SIGN SUPPORTS 6"X8"

F&ISQUARE PERFORATED TUBULAR STEEL POST

DESCRIPTION

F&IANCHOR BASES FOR SQUARE PERFORATED TUBULAR STEEL POST

SN - 03



OFFICE OF TRAFFIC & SAFETY TRAFFIC ENGINEERING DESIGN DIVISION

WHITE FLINT METRO STATION ACCESS IMPROVEMENTS MD 355 (ROCKVILLE PIKE) SHA TRACKING NO. 21-AP-MO-003-21

ADMINISTRATION


INDEX OF QUANTITIES REVISIONS ADVERTISED DATE___ COUNTY ___ MONTGOMERY LOGMILE

__ CONTRACT NO. <u>< CONTRACT NO ></u> TIMS NO. _ TOD NO. ____ SN - 11 01 OF 01 SHEET NO. 22 OF 28 DRAWING NO.


LAUREL, MARYLAND 20707 (301) 982-2800

I HEREBY CERTIFY THAT THESE DOCUMENTS WERE PREPARED OR APPROVED BY ME, AND THAT I AM A DULY LICENSED PROFESSIONAL ENGINEER UNDER THE LAWS OF THE STATE OF MARYLAND.

MD LICENSE NUMBER 12-12-2022 **EXPIRATION DATE**

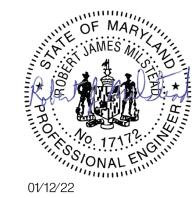

CODE NUMBERS

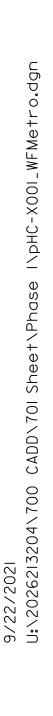

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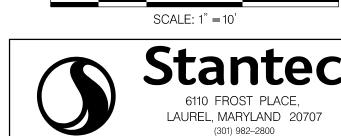
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1. CONTRACTOR SHALL VERIFY ALL EXISTING UNDERGROUND UTILITIES PRIOR TO CONSTRUCTION.

THERE ARE SHALLOW STORM DRAIN PIPES WITHIN THE PROJECT LIMITS.

PROFESSIONAL CERTIFICATION:
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370+75.0000

B CONSTRUCTION MD 355

EX. 15" STORM

B CONSTRUCTION MD 355

371+00.0000

371+25.0000

				RECOMMENDED FOR APPROVAL
NO.	REVISION	DATE	BY	
				Chief, Design Section
				APPROVED
				Chief, Division of Transportation Engineering
				Designed by : Drawn by :

GAITHERSBURG, MARYLAND MMENDED FOR APPROVAL • Design Section • Division of Transportation Engineering

Checked by : _

MONTGOMERY COUNTY DEPARTMENT OF TRANSPORTATION DIVISION OF TRANSPORTATION ENGINEERING

ROADWAY CROSS SECTIONS

WHITE FLINT STATION
PEDESTRIAN ACCESS IMPROVEMENTS

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SHA TRACKING NO. 21-AP-MO-003-21

DATE: SEPT 2021 SCALE : 1" = 10'

SHEET 23 of 28 Project No. : 502106


(301) 982–2800 www.stantec.com

EX. 18" STORM

EX. 18" STORM

LICENSE NO: 28255 EXPIRATION DATE: 6-30-2022



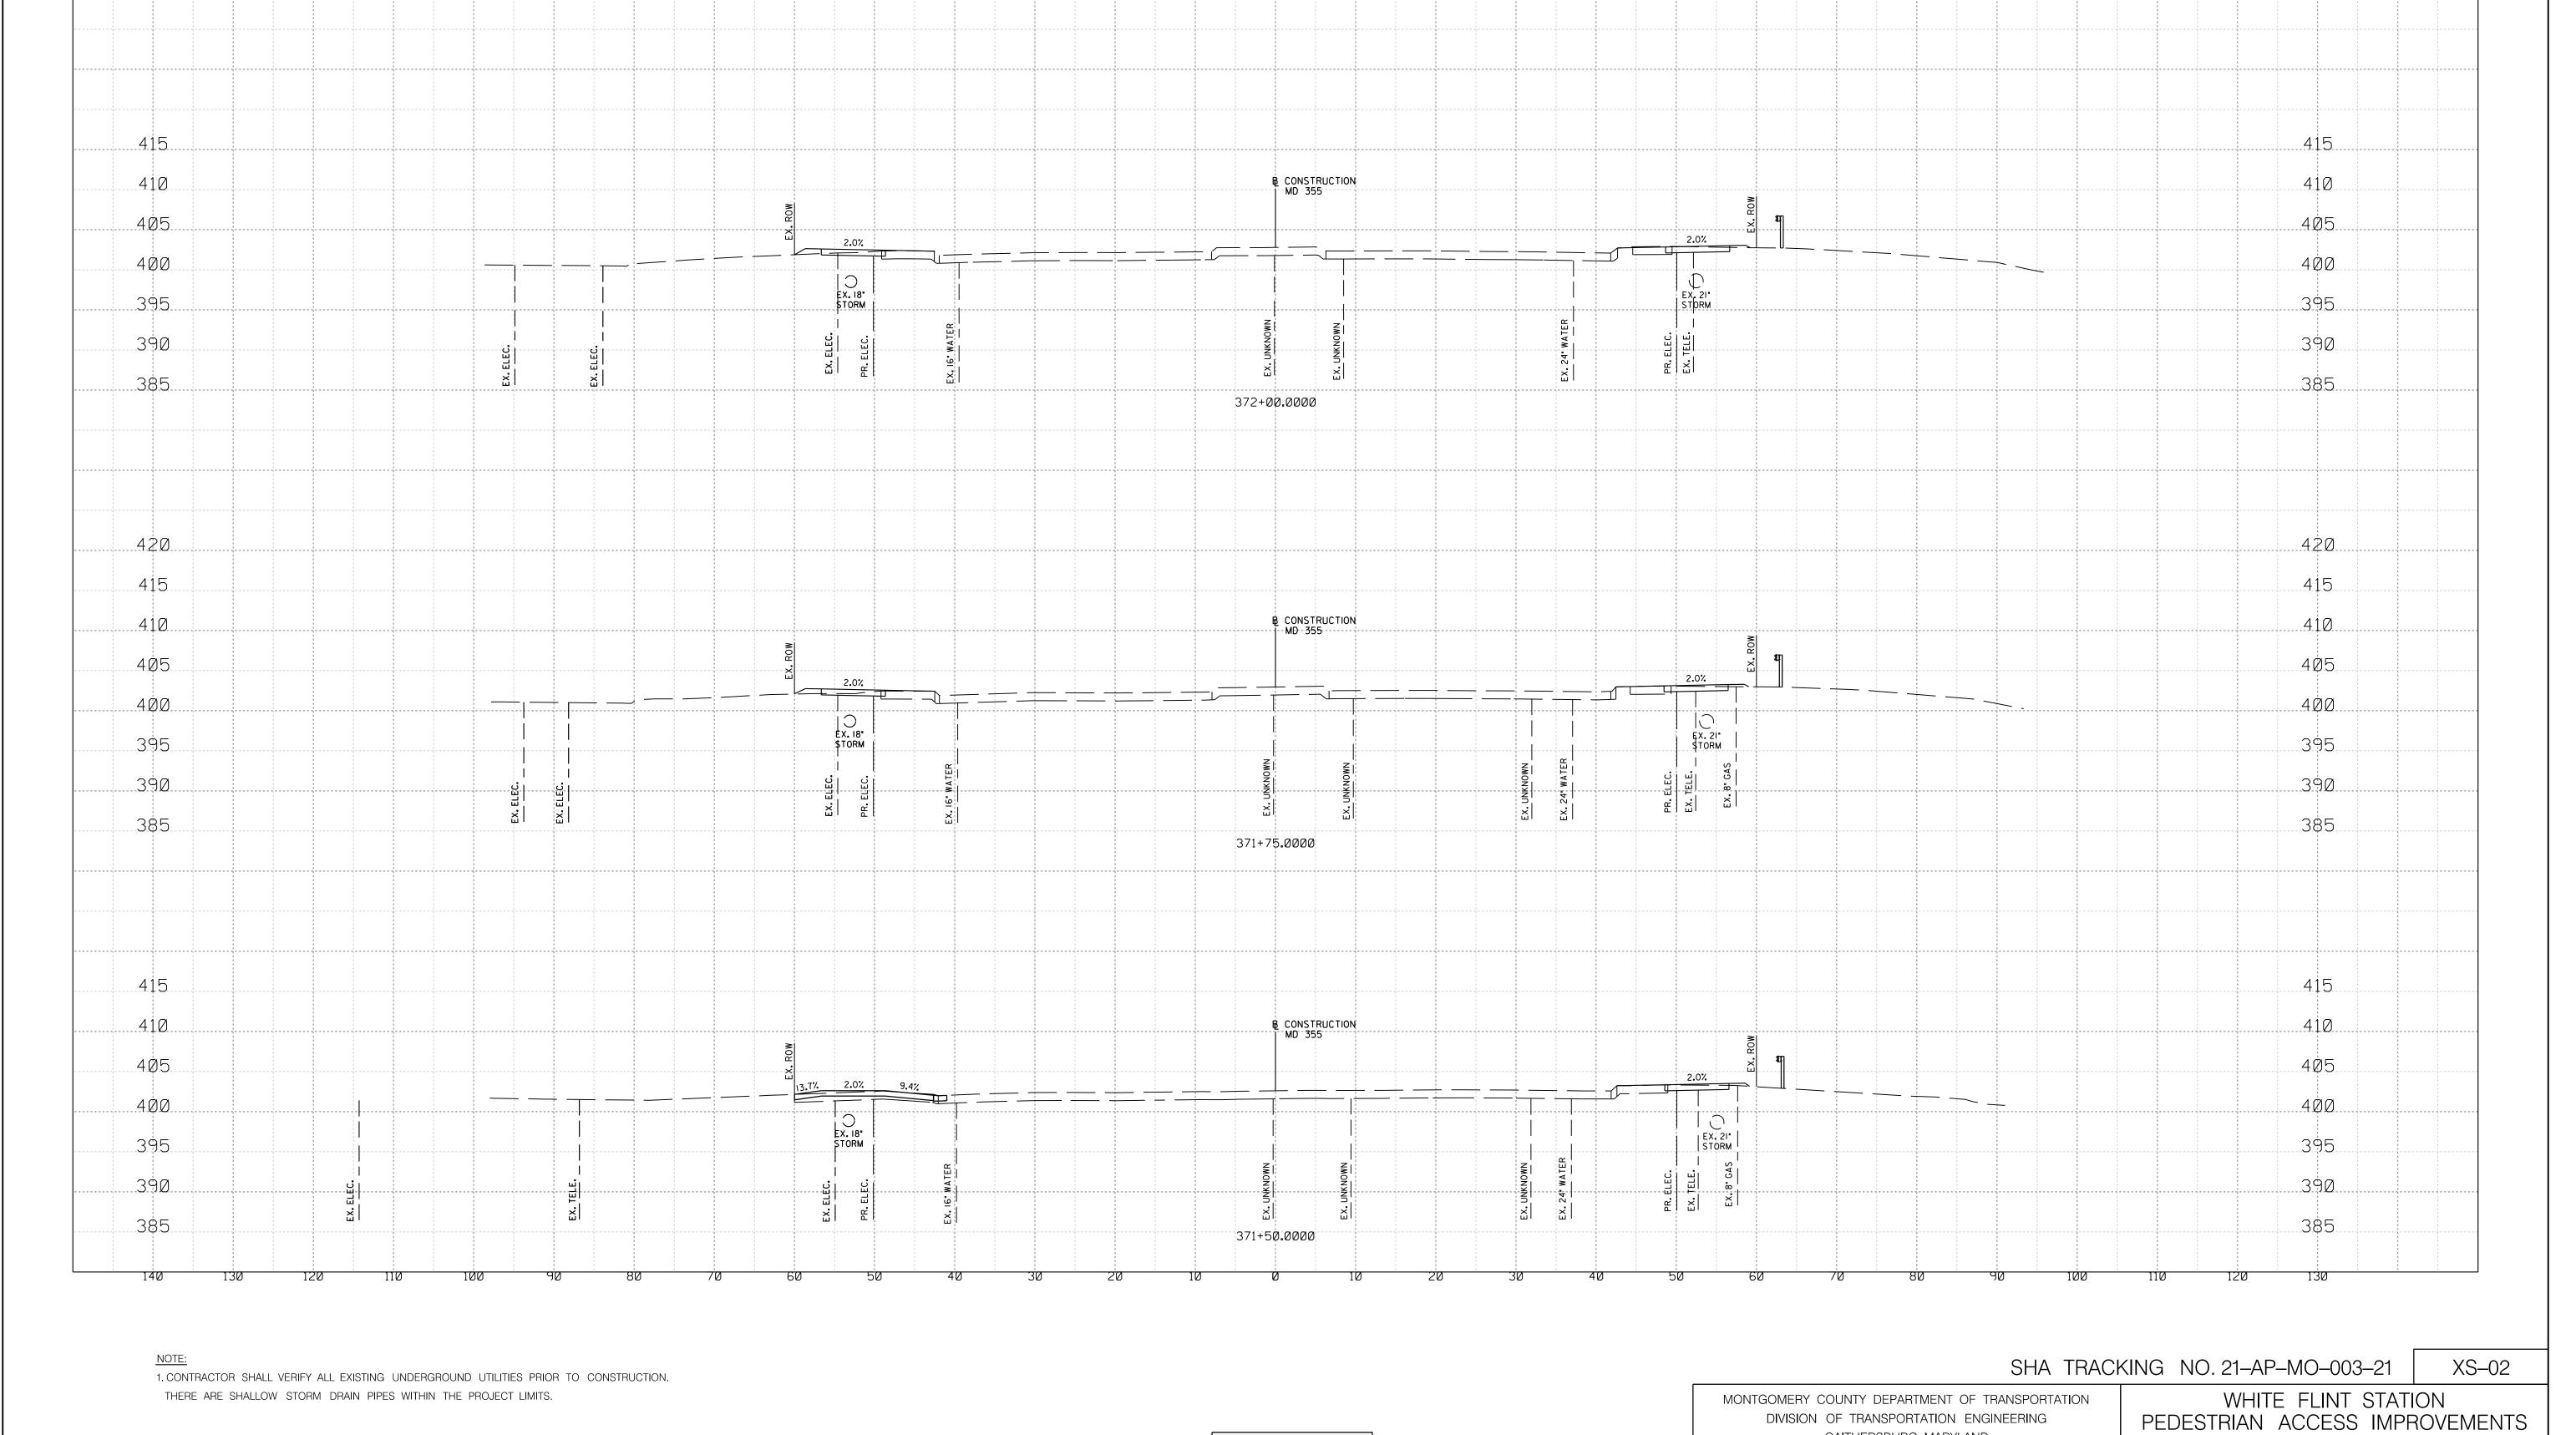

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OR APPROVED BY ME, AND THAT I AM A DULY LICENSED
PROFESSIONAL ENGINEER UNDER THE LAWS OF THE STATE

LICENSE NO: 28255 EXPIRATION DATE: 6-30-2022

OF MARYLAND.

6110 FROST PLACE, LAUREL, MARYLAND 20707

(301) 982–2800 www.stantec.com GAITHERSBURG, MARYLAND

Drawn by :____

Checked by : _

RECOMMENDED FOR APPROVAL

Chief, Design Section

Designed by :_____

Chief, Division of Transportation Engineering

APPROVED

DATE BY

REVISION


ROADWAY CROSS SECTIONS

SCALE : 1" = 10'

Project No. : 502106

DATE: SEPT 2021

SHEET 24 of 28

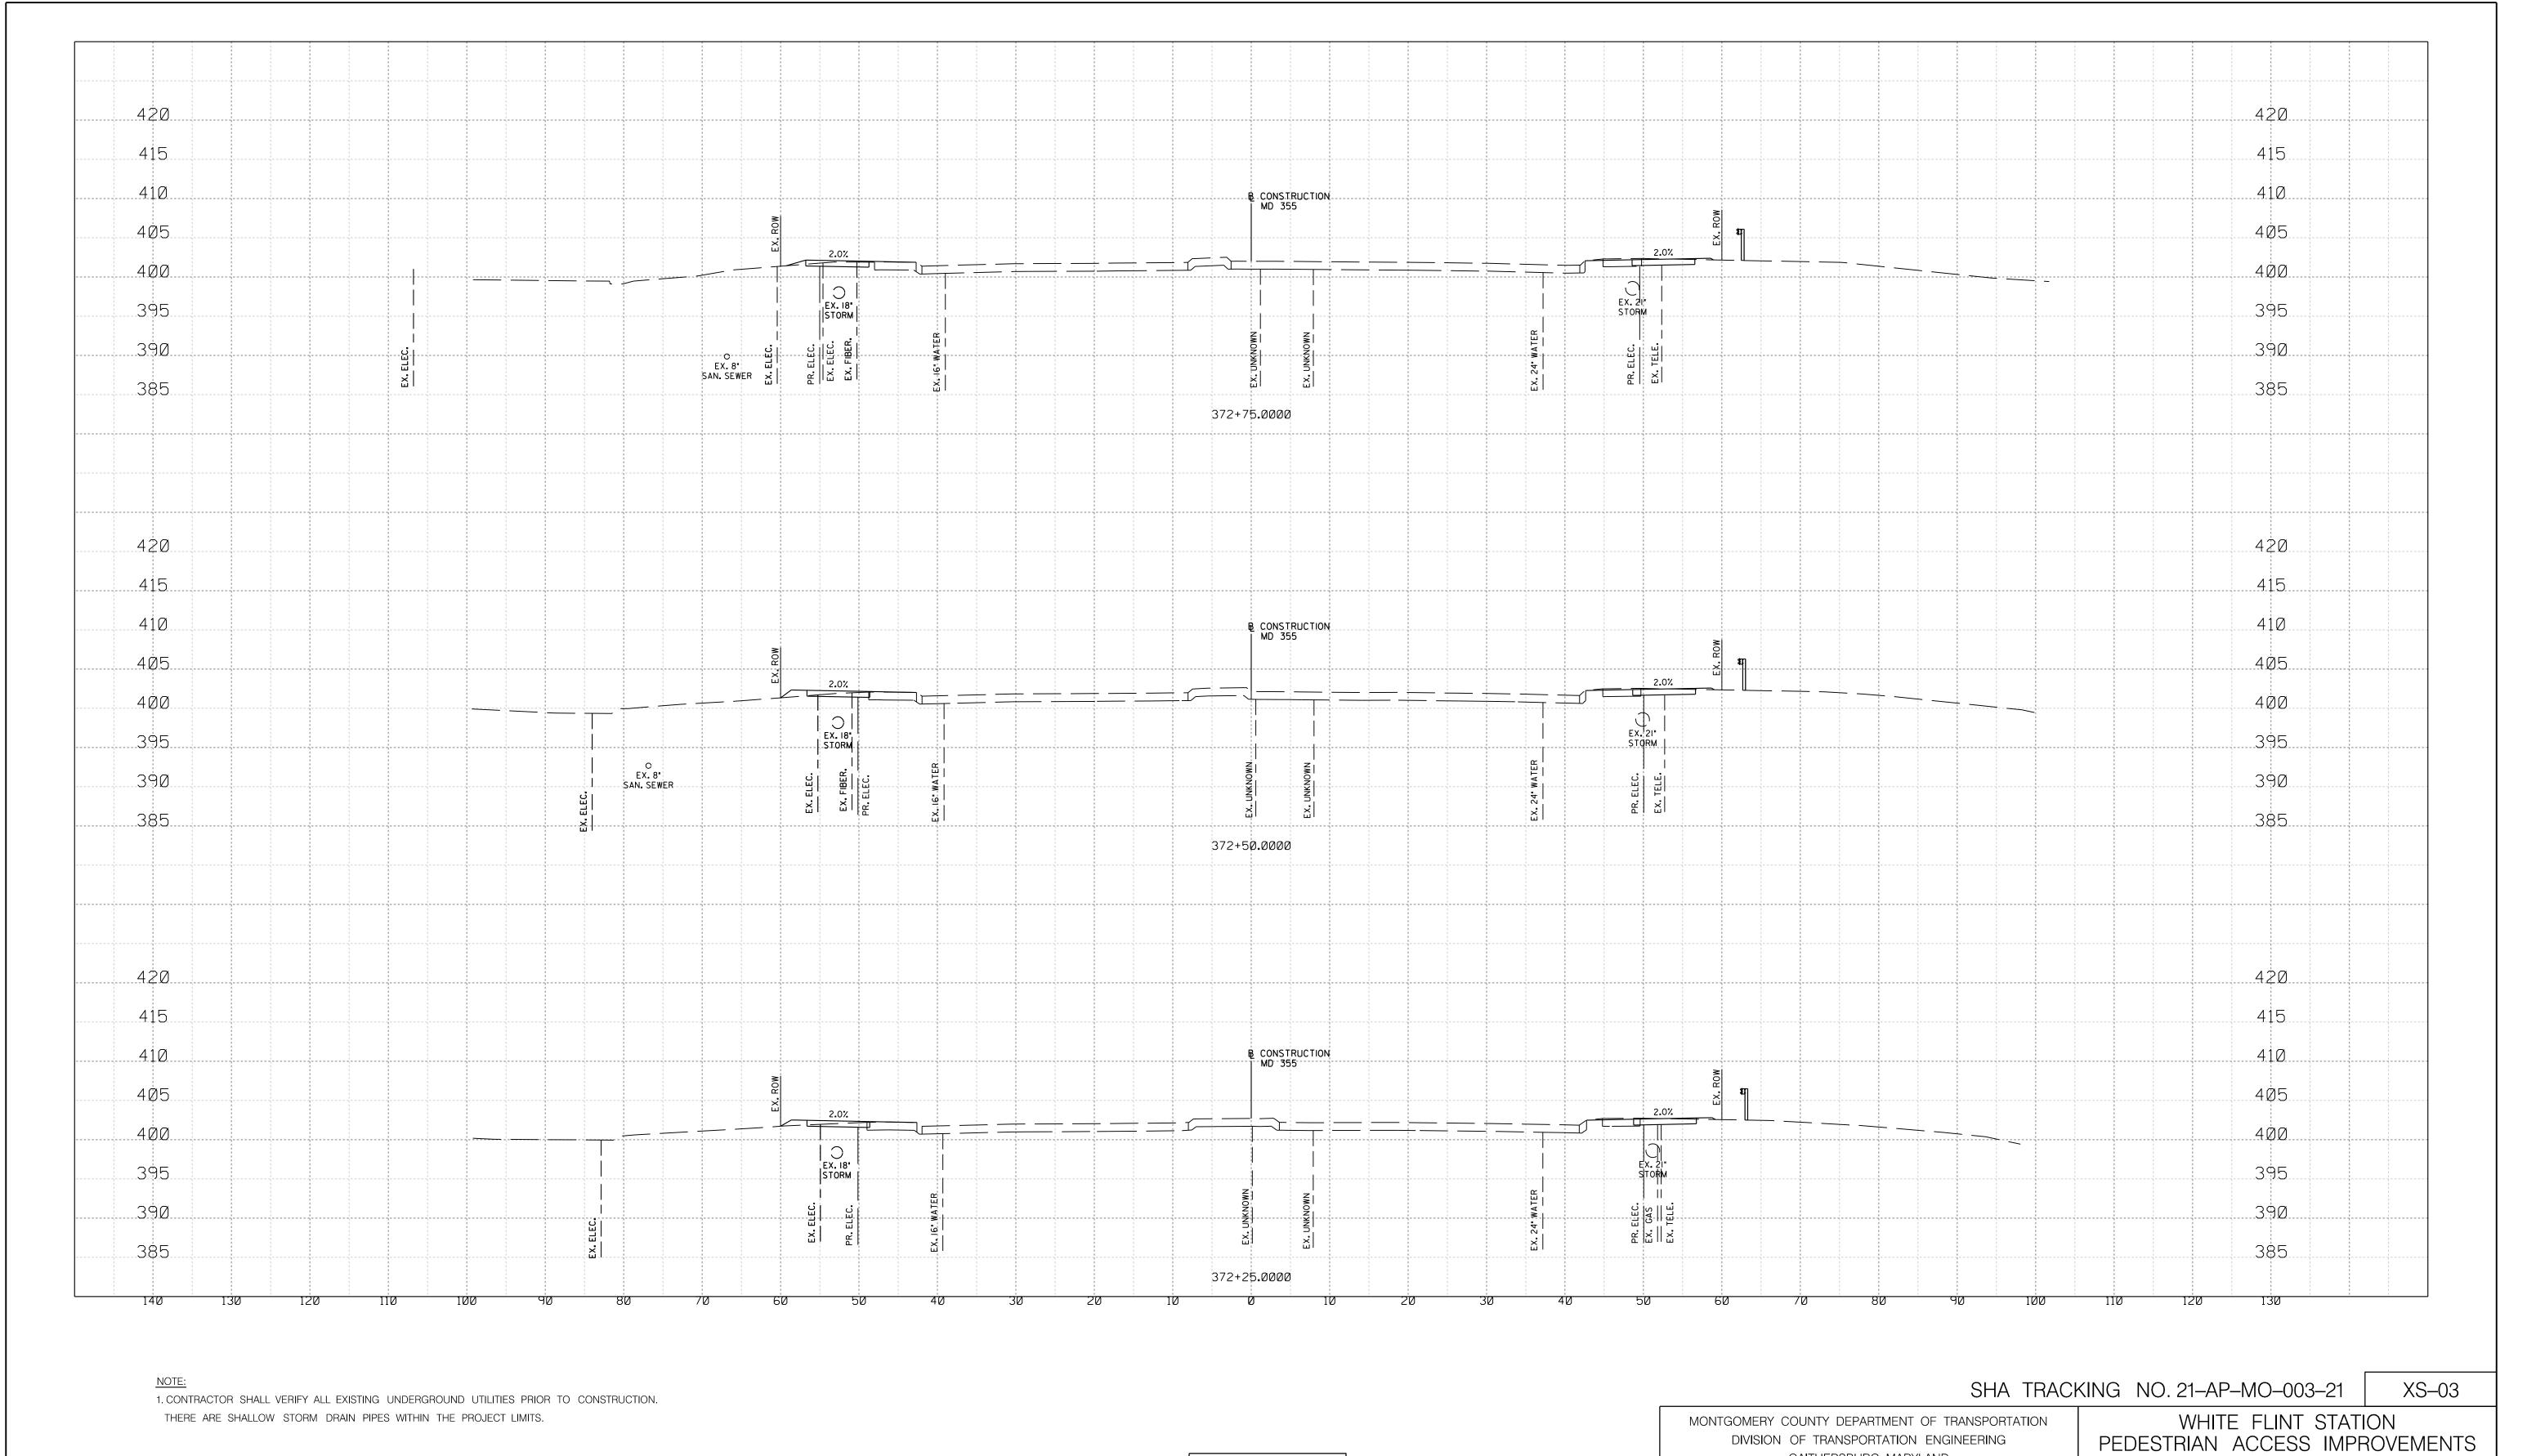

Stantec 6110 FROST PLACE, LAUREL, MARYLAND 20707 (301) 982–2800 www.stantec.com

PROFESSIONAL CERTIFICATION:
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PROFESSIONAL ENGINEER UNDER THE LAWS OF THE STATE OF MARYLAND. LICENSE NO: 28255 EXPIRATION DATE: 6-30-2022

					RECOMMENDED FOR APPROVAL		
	NO.	REVISION	DATE	BY			
					Chief, Design Section		
					APPROVED		
					Chief, Division of Transportation Engineering		
					Designed by : Drawn by :		

GAITHERSBURG, MARYLAND

Checked by : _

ROADWAY CROSS SECTIONS

DATE: SEPT 2021 SCALE : 1" = 10'

Project No. : 502106

SHEET <u>25</u> of <u>28</u>



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6110 FROST PLACE, LAUREL, MARYLAND 20707 (301) 982–2800 www.stantec.com

EX.8" SAN. SEWER

O EX. 18" STORM

1. CONTRACTOR SHALL VERIFY ALL EXISTING UNDERGROUND UTILITIES PRIOR TO CONSTRUCTION.

THERE ARE SHALLOW STORM DRAIN PIPES WITHIN THE PROJECT LIMITS.

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B-CONSTRUCTION-MD 355

-B -CONSTRUCTION-| MD 355

NO.	REVISION	DATE	ВҮ	
				Chief.
				APPROVE
				Chief,
				Design

EX. 21" STORM

GAITHERSBURG, MARYLAND MMENDED FOR APPROVAL • Design Section • Division of Transportation Engineering gned by :_____ Drawn by :____ Checked by : _

MONTGOMERY COUNTY DEPARTMENT OF TRANSPORTATION DIVISION OF TRANSPORTATION ENGINEERING

ROADWAY CROSS SECTIONS

WHITE FLINT STATION
PEDESTRIAN ACCESS IMPROVEMENTS

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SHA TRACKING NO. 21-AP-MO-003-21

DATE: SEPT 2021 SCALE : 1" = 10'Project No. : 502106 SHEET 26 of 28

LICENSE NO: 28255 EXPIRATION DATE: 6-30-2022

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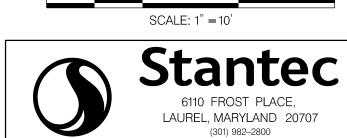
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1. CONTRACTOR SHALL VERIFY ALL EXISTING UNDERGROUND UTILITIES PRIOR TO CONSTRUCTION.

THERE ARE SHALLOW STORM DRAIN PIPES WITHIN THE PROJECT LIMITS.



O EX.8" SAN.SEWER

PROFESSIONAL CERTIFICATION:
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PROFESSIONAL ENGINEER UNDER THE LAWS OF THE STATE OF MARYLAND.

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B CONSTRUCTION MD 355

CONSTRUCTION MD 355

				RECOMM
NO.	REVISION	DATE	BY	
				Chief.
				APPROVE
				Chief.
				Design

EX. 18" STORM

EX. 21" EX. 15" STORM STORM

EX. 15" STORM

EX. 21" STORM

WHITE FLINT STATION
PEDESTRIAN ACCESS IMPROVEMENTS GAITHERSBURG, MARYLAND MMENDED FOR APPROVAL • Design Section

Checked by : _

MONTGOMERY COUNTY DEPARTMENT OF TRANSPORTATION DIVISION OF TRANSPORTATION ENGINEERING

ROADWAY CROSS SECTIONS

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DATE: SEPT 2021 SCALE : 1" = 10'

• Division of Transportation Engineering gned by :_____ Drawn by :____


Project No. : 502106

SHA TRACKING NO. 21-AP-MO-003-21

SHEET 27 of 28

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LICENSE NO: 28255 EXPIRATION DATE: 6-30-2022

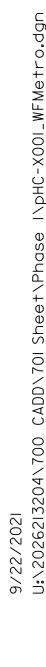

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1. CONTRACTOR SHALL VERIFY ALL EXISTING UNDERGROUND UTILITIES PRIOR TO CONSTRUCTION.

THERE ARE SHALLOW STORM DRAIN PIPES WITHIN THE PROJECT LIMITS.

6110 FROST PLACE, LAUREL, MARYLAND 20707

C EX. 8" SAN. SEWER

PROFESSIONAL CERTIFICATION:
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OR APPROVED BY ME, AND THAT I AM A DULY LICENSED
PROFESSIONAL ENGINEER UNDER THE LAWS OF THE STATE OF MARYLAND.

374+50.0000

374+75.0000

B CONSTRUCTION | MD 355

					RECOMME
	NO.	REVISION	DATE	BY	
					Chief.
					APPROVE
					Chief.
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_					

RECOMMENDED FOR APPROVAL Design Section • Division of Transportation Engineering

MONTGOMERY COUNTY DEPARTMENT OF TRANSPORTATION DIVISION OF TRANSPORTATION ENGINEERING GAITHERSBURG, MARYLAND

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ROADWAY CROSS SECTIONS

WHITE FLINT STATION
PEDESTRIAN ACCESS IMPROVEMENTS

XS-06

DATE: SEPT 2021 SCALE : 1" = 10'

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LICENSE NO: 28255 EXPIRATION DATE: 6-30-2022

gned by :_____ Drawn by :____

EX. 18"

EX. 18" STORM

Project No. : 502106 Checked by : _

SHA TRACKING NO. 21-AP-MO-003-21

SHEET 28 of 28