THE FOLLOWING MARYLAND STANDARD (CONSTRUCTION AND TEMPORARY TRAFFIC CONTROL) DETAILS ARE REQUIRED FOR THE PROJECT:

- MD 104.03-02 SHOULDER WORK/MULTILANE UNDIV. EQUAL/LESS THAN 40 MPH MD 104.05-15 - STANDARD RAMP
- MD 381.01 STANDARD YARD INLET
- MD 580.03 NEW COMBINATION CURB AND GUTTER PLACEMENT ALONG EXISTING
- MD 620.02-01 STANDARD TYPES C AND D CONCRETE CURB AND COMBINATION CONCRETE CURB & GUTTER
- MD 630.02 -STANDARD ENTRANCE CONSTRUCTION RESIDENTIAL
- AND COMMERCIAL, METHOD NO. 2 MD 655.40 - DETECTABLE WARNING SURFACES

FOR ALL STANDARDS REFERRED TO ON THE PLANS. THE CONTRACTOR MUST GO TO THE BOOK OF STANDARDS WHICH WILL HAVE THE MOST CURRENT VERSION. THE BOOK OF STANDARDS CAN BE ACCESSED AT: https://apps.roads.maryland.gov/BusinessWithSHA/ bizStdsSpecs/desManualStdPub/publicationsonline/ohd/bookstd/index.asp. ALL ITEMS ARE TO BE CONSTRUCTED IN ACCORDANCE WITH THE CURRENT VERSION OF THE REFERENCED STANDARD AT THE TIME OF CONSTRUCTION.

		INDEX OF CHEETS
		INDEX OF SHEETS
SHEET NO.	DRAWING NO.	SHEET NAME
	TI-OI	TITLE SHEET
2	GN-OI	GENERAL NOTES, STANDARD SYMBOLS, & ABBREVIATIONS
2 3	GS-OI	GEOMETRIC LAYOUT
	TS-0I	TYPICAL SECTION & PAVING DETAILS
5 6	PS-0I	ROADWAY PLAN
6	PR-01	ROADWAY PROFILE
7	GR-01	GRADING PLAN
8	LN-01	LANDSCAPING PLAN
9	LN-02	LANDSCAPING NOTES & DETAILS
10	LT-OI	LIGHTING PLAN
II	LT-02	LIGHTING NOTES & DETAILS
12	MT-OI	MAINTENANCE OF TRAFFIC GENERAL NOTES
13	MT-02	MAINTENANCE OF TRAFFIC PLAN
14	MT-03	MAINTENANCE OF TRAFFIC PLAN
15	MT-04	MAINTENANCE OF TRAFFIC PLAN
16	MT-05	MAINTENANCE OF TRAFFIC PLAN
17	MT-06	MAINTENANCE OF TRAFFIC PLAN
18	MT-07	MAINTENANCE OF TRAFFIC PLAN
19	MT-08	MAINTENANCE OF TRAFFIC PLAN
20	SN-00	SIGNING & PAVEMENT MARKING NOTES
21	SN-01	SIGNING & PAVEMENT MARKING PLAN
22	SN-02	SIGNING & PAVEMENT QUANTITIES
23	XS-01	ROADWAY CROSS SECTIONS
24	XS-02	ROADWAY CROSS SECTIONS
25	XS-03	ROADWAY CROSS SECTIONS
26	XS-04	ROADWAY CROSS SECTIONS
27	XS-05	ROADWAY CROSS SECTIONS
28	XS-06	ROADWAY CROSS SECTIONS

OWNER'S CERTIFICATION

I HEREBY CERTIFY THAT ALL CLEARING, GRADING, CONSTRUCTION AND/OR DEVELOPMENT WILL BE DONE PURSUANT TO THIS PLAN AND THAT ANY RESPONSIBLE PERSONNEL INVOLVED IN THE CONSTRUCTION PROJECT WILL HAVE A CERTIFICATE OF ATTENDANCE AT A DEPARTMENT OF NATURAL RESOURCES APPROVED TRAINING PROGRAM FOR THE CONTROL OF SEDIMENT AND EROSION BEFORE BEGINNING THE PROJECT.

DATE

TIMOTHY H. CUPPLES, P.E. CHIEF, DIVISION OF TRANSPORTATION ENGINEERING

DESIGN CERTIFICATION

I HEREBY CERTIFY THAT THIS PLAN HAS BEEN PREPARED IN ACCORDANCE WITH THE "2011 MARYLAND STANDARDS AND SPECIFICATIONS FOR SOIL EROSION AND SEDIMENT CONTROL", MONTGOMERY COUNTY DEPARTMENT OF PERMITTING SERVICES EXECUTIVE REGULATIONS 5-90, 7-02AM AND 36-90, AND MONTGOMERY COUNTY DEPARTMENT OF TRANSPORTATION "STORM DRAIN DESIGN CRITERIA" DATED AUGUST 1988.

I FURTHER CERTIFY THAT THE ESTIMATED TOTAL AMOUNTS OF EXCAVATION AND FILL AS SHOWN ON THESE PLANS HAS BEEN COMPUTED TO BE 342 CUBIC YARDS OF EXCAVATION AND 200 CUBIC YARDS OF FILL AND THAT THE TOTAL AREA TO BE DISTURBED AS SHOWN ON THESE PLANS HAS BEEN DETERMINED TO BE 17,947 SQUARE FEET.

2021-09-22


DATE

LORI R. ADGATE, P.E.

MD. REGISTRATION NO.28255

MONTGOMERY COUNTY, MARYLAND DEPARTMENT OF TRANSPORTATION WHITE FLINT METRO STATION ACCESS IMPROVEMENTS

PHASE 1 – SIDEWALK RECONSTRUCTION C. I. P. PROJECT NO. 502106 SHA TRACKING NO. 21-AP-MO-003-21

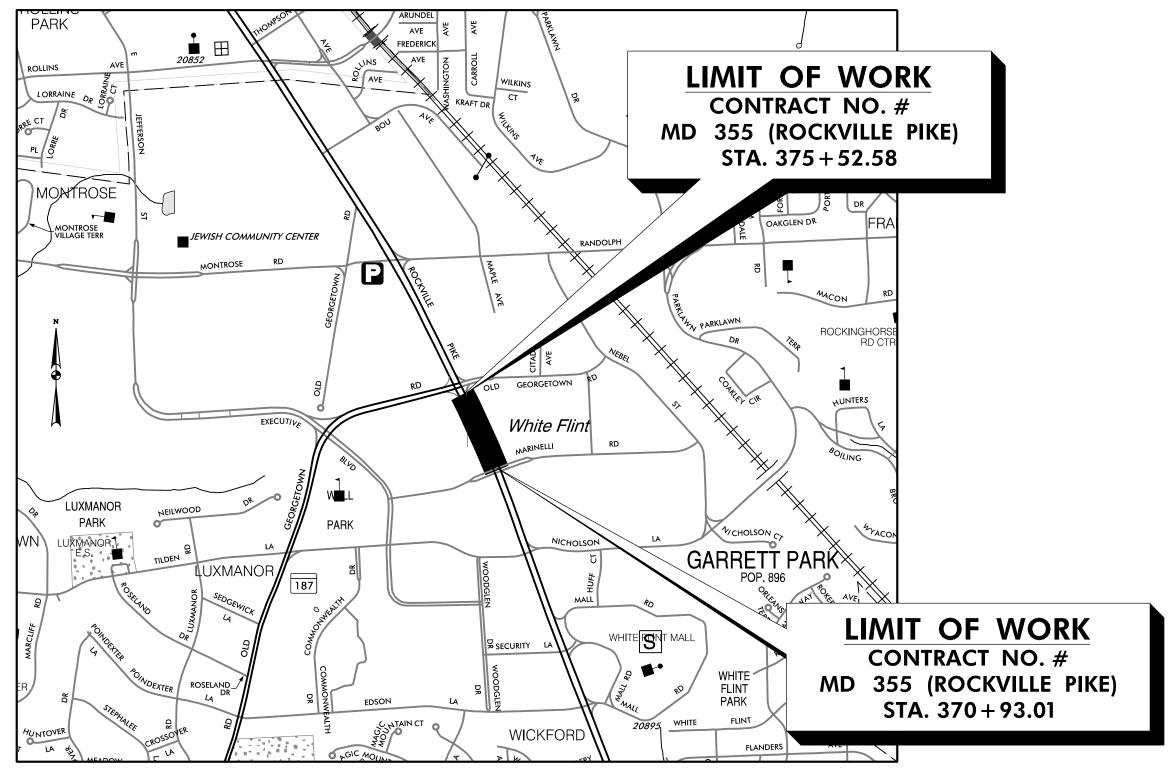

VICINITY MAP SCALE: 1'' = 1000'

PS&E SUBMITTAL SEPT 2021

RELATED REQUIRED PERMITS IT IS THE RESPONSIBILTY OF PERMITTEE/OWNER OF THIS SITE TO OBTAIN ALL REQUIRED PERMITS PRIOR TO ISSUANCE OF THE APPROVED SEDIMENT CONTROL PERMIT

PERMIT #

XXXXXX

XXXXX

* A copy of the Roadside Trees Protection Plan must be delivered to the sediment control inspector at the preconstruction meeting. OWNER/PERMIT APPLICANT INFORMATION

Χ

MONTGOMERY COUNTY DEPARTMENT OF TRANSPORTATION

100 EDISON PARK DRIVE, GAITHERSBURG, MD 20878

<u>(240)</u> 777-7209

CONTACT PERSON: TIMOTHY H. CUPPLES, P.E.

Floodplain District

WATERWAYS/WETLAND(S):

Corps of Engineers

MDE Dam Safety

*DPS Roadside Trees

N.P.D.E.S. NOTICE OF INTENT

FEMA LOMR

(Required Post Construction

OTHERS:

DPS Erosion

PHONE NUMBER:

MDE

XPRIATION WORK
DATE RESTRICTION DATES

APPROVALS:		
TRAFFIC CONTROL PLANS	SIGNATURE	DATE
LIGHTING PLANS	SIGNATURE	DATE
SIGNING & PAVEMENT MARKING PLANS	SIGNATURE	DATE
TRAFFIC SIGNAL PLANS	SIGNATURE	DATE

TI-01

ALL AREAS OF SHA PROPERTY AND
PROPERTY TO BE DEDICATED TO SHA
SHALL BE RESTORED IN CONFORMANCE WITH
SHA STANDARD SPECIFICATIONS, EXCEPT AS
NECESSARY FOR WORK FOR WHICH THERE
ARE NO SHA STANDARD SPECIFICATIONS

PRIOR TO VEGETATIVE STABILIZATION, ALL DISTURBED AREAS MUST BE TOPSOILED PER THE MONTGOMERY COUNTY "STANDARDS AND SPECIFICATIONS FOR TOPSOIL"

PROFESSIONAL CERTIFICATION: I HEREBY CERTIFY THAT THESE DOCUMENTS WERE PREPARED OR APPROVED BY ME, AND THAT I AM A DULY LICENSED PROFESSIONAL ENGINEER UNDER THE LAWS OF THE STATE OF MARYLAND.

LICENSE NO: 28255 EXPIRATION DATE: 6-30-2022

PROJECT MANAGER

Gaithersburg, MD 20878

100 Edison Park Drive, 4th Floor

rebecca.park@montgomerycountymd.gov

REBECCA PARK

240-777-7263

MAN				
ADG PA	NO.	REVISION	DATE	BY
Marke				
5				
L ENGIN				
L L				

MONTGOMERY COUNTY DEPARTMENT OF TRANSPORTATION				
DIVISION OF TRANSPORTATION ENGINEERING				
GAITHERSBURG, MARYLAND				
RECOMMENDED FOR APPROVAL				

Drawn by :___

Chief, Design Section

Designed by :___

Chief. Division of Transportation Engineering

APPROVED

TITLE SHEET

Checked by :

WHITE FLINT METRO STATION

ACCESS IMPROVEMENTS

DATE: SEPT 2021 SCALE: N.T.S. SHEET 01 of 28 Project No. : 502106

Stantec 6110 FROST PLACE, LAUREL, MARYLAND 20707 (301) 982-2800

GENERAL NOTES

- I. THE SPECIFICATIONS FOR THIS CONTRACT WILL BE THOSE OF THE MARYLAND STATE HIGHWAY ADMINISTRATION DATED JULY 2020, ALL ERATA AND ADDENDA THERETO. THE MARYLAND STATE HIGHWAY ADMINISTRATION BOOK OF STANDARDS FOR HIGHWAY AND INCIDENTAL STRUCTURES, AND SOIL CONSERVATION SERVICE POND CONSTRUCTION SPECIFICATIONS FOR MARYLAND.
- 2. FOR CONSTRUCTION, HORIZONTAL SHALL BE BASED ON NAD 83/91DATUM AND VERTICAL SHALL BE BASED ON NAVD 1988 DATUM.
- 3. INFORMATION CONCERNING UNDERGROUND UTILITIES WAS OBTAINED FROM AVAILABLE RECORDS, BUT THE CONTRACTOR MUST DETERMINE THE EXACT LOCATIONS AND ELEVATIONS OF THE LINES BY DIGGING TEST PITS BY HAND AT ALL UTILITY CROSSINGS, WELL IN ADVANCE OF TRENCHING. IF CLEARANCES ARE LESS THAN SHOWN OR SIX (6) INCHES, WHICHEVER IS LESS, CONTACT MONTGOMERY COUNTY DEPARTMENT OF TRANSPORTATION'S PROJECT INSPECTOR AND THE APPROPRIATE UTILITY OWNER BEFORE PROCEEDING WITH CONSTRUCTION.
- 4. REPAIRS TO UTILITIES OR PROPERTY DAMAGE AS A RESULT OF THE CONTRACTOR'S NEGLIGENCE OR METHOD OF OPERATION MUST BE MADE AT THE CONTRACTOR'S EXPENSE BEFORE PROCEEDING WITH CONSTRUCTION.
- 5. CALL "MISS UTILITY" AT 1-800-257-7777 FORTY-EIGHT (48) HOURS PRIOR TO BEGINNING EXCAVATION TO DETERMINE THE EXACT LOCATION OF EXISTING UTILITIES.
- 6. CLEARING IS TO BE LIMITED TO THE "LIMIT OF DISTURBANCE" AS SHOWN ON THE PLANS.
- 7. ALL GRADING SHALL BE DONE IN SUCH A MANNER AS TO PROVIDE POSITIVE DRAINAGE.
- 8. THE CONTRACTOR SHALL OBTAIN A ROADSIDE TREE PERMIT FOR ANY MAINTENANCE, TREATMENT, PLANTING, REMOVAL, OR ROOT CUTTING ON TREES WITHIN THE PUBLIC RIGHT OF WAY. PERMIT REQUIREMENTS MAY BE OBTAINED FROM THE DEPARTMENT OF NATURAL RESOURCES, MARYLAND FOREST, PARK AND WILDLIFE SERVICE, TELEPHONE 301-854-6060.
- 9. THE LOCATION OF RIGHT-OF-WAY AND EASEMENT LINES SHOWN ON THE PLANS ARE FOR INFORMATION AND GUIDANCE ONLY. NO GUARANTEE IS MADE AS TO THE ACCURACY OF SAID LOCATIONS. PLEASE REFER TO THE APPROPRATE RIGHT-OF-WAY PLATS.
- IO. THE CONTRACTOR SHALL INSTALL PEDESTRIAN DETECTABLE WARNING SURFACES AT ALL SIDEWALK & PEDESTRIAN CROSSINGS. LOCATIONS AS DIRECTED BY THE ENGINEER. THE WARNING SURFACES SHALL BE IN CONFORMANCE WITH ADA REQUIREMENTS AND THE PROJECT SPECIAL PROVISION.
- II. THE DESIGN FOR THIS PROJECT HAS INCORPORATED FACILITIES FOR THE ELDERLY AND HANDICAPPED IN COMPLIANCE WITH STATE AND FEDERAL LEGISLATION.

AB	BREV	IATIONS
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A.A.S.H.T.O American Association of State	EEast	L.L. Liquid Limit	PROPProposed	STDStandard
Highway Transportation Officials	EElectric	LODLimit of Disturbance	PRCPoint of Reverse Curve	STAStation
ABANAbandoned	e External Distance	LONG. Longitudinal	PTPoint	STIFFStiffener
ABUTAbutment	EAEach	L.PLight Pole	PTPoint of Tangency	SOSingle Opening
ADT Average Daily Traffic	E.BEastbound	LTLeft	PVCPoint of Vertical Curve	S.YSquare Yards
AHD Ahead	E.JExpansion Joint	MAC Macadam	P.V.C Polyvinyl Chloride	SWMStormwater Management
APPROX Approximate	EL. or ELEV Elevation	MAX Maximum	PVIPoint of Vertical Intersection	TTangent
B or B∕LBaseline	E.R.C.C.P Elliptical Reinforced Cement	MBMicro Bio	PVRC Point of Vertical Reverse Curve	TTelephone
BKBack /Book	Concrete Pipe	MC Moisture Content	PVTPoint of Vertical Tangency	T.CTop of Cover
BITBituminous	ESEnd Section	MDD Maximum Dry Content	R Radius	TEMPTemporary
B.CBituminous Concrete	EX. or EXIST Existing	MOD Modified	REINF Reinforcement	T.GTop of Grate
B.MBench Mark	FTFeet	MIN Minimum	REQ'DRequired	T.B.R To Be Removed
B.O.F Bottom of Footing	F or FL Flowline	MN Managed Roadway	R.F Rock Fragments	T or TLTraverse Line
BOTBottom	F.B.D Flat Bottom Ditch	M.S.E Mechanically Stablilized Earth	RTRight	T.M Top of Manhole
BRGBearing	F.HFire Hydrant	N North	RW or R/W Right of Way	T.O.FTop of Footing
C.C Center of Curve	F.OFiber Optic	NB Northbound	R.C.P Reinforced Cement Pipe	TRAV Traverse
CATV Cable Television	F.SFull Super Elevation	NE Northeast	R.C.C.P Reinforced Cement Concrete Pipe	TSTemporary Swale
C.B.RCalifornia Bearing Ratio	FWD Forward	NO Number	R.Q.DRock Quality Desgnation	T.STop of Slab
C.JContraction Joint	GGas	NPNon-Plastic	R.MRootmat	T.STopsoil
C _I or C/L Centerline	GLGutterline	N.T.SNot To Scale	S South	TYPTypical
CĒClass or Clear	GP General Purpose Roadway	O.COn Center	SANSanitary Sewer	U.DUnder Drain
CLFChainlink Fence	G.V Gas Valve	OHOverhead	SB or S/B Southbound	U.GUnderground
CMP Corrugated Metal Pipe	H.B Handbox	OMCOptimum Moisture	S.DStorm Drain	U.O.N Unless Otherwise Noted
C.OCleanout	H.D.PHigh Density Polyetheylene	PAV'TPavement	S.D.DSurface Drain Ditch	U.PUtility Pole
COMBCombination	HDWL Headwall	PC Point of Curvature	SESuper Elevation	USC Unified Soil Classification
CONC Concrete	H.E.R.C.P Horizontal Elliptical Reinforced	PCC Point of Compound Curvature	SFSilt Fence	USDAUnited States Department of Agriculture
CONSTRConstruction	Concrete Pipe	P/CPoint of Crown	S.FSquare Feet	VCLVertical Clearance
CORCorner	H.PHigh Point	P/GE Profile Grade Elevation	SHLDR Shoulder	V.C.LVertical Curve Length
CORRCorrection	H.S.D Headlight Sight Distance	P.G.L. Profile Grade Line	SHAState Highway Administration	WWater
C.YCubic Yard	INInch	P/GL Profile Ground Line	SHA MBState Highway Administration Micro Bio	WWest
DC Degree of Curve	I.S.TInlet Sediment Trap	PPlate	SHTSheet	W.B Westbound
D.H.V Design Hourly Volume	INVInvert	P/RPoint of Rotation	S.P.PStructural Plate Pipe	WBWetland Buffer
D.I Drop Inlet	J.BJunction Box	P.I Plasticity Index	S.P.TStandard Penetration Testing	W.M Water Meter
DIA Diameter	KK Inlet	P.I Point of Intersection	S.SStainless Steel	W.SWrapped Steel
D.O Double Opening	LLength	POC Point On Curve	SSDStopping Sight Distance	
D.SDesign Speed	L.FLinear Feet	POTPoint On Tangent	SSFSuper Silt Fence	

SYMBOLS

EXISTING RIGHT OF WAY LINE		LIMIT OF DISTURBANCE	100
PROPOSED RIGHT OF WAY LINE		SILT FENCE	
PROPOSED TRAFFIC BARRIER	······		
EXISTING TRAFFIC BARRIER		SUPER SILT FENCE	
EXISTING WOOD FENCE LINE		DIVERSION FENCE	DF
EXISTING CHAIN LINK FENCE LINE		STONE CHECK DAM	CD
BASE OR SURVEY LINE	+50	TEMPORARY STONE OUTLET STRUCTURE	TSOS
EXISTING FIRE HYDRANT		TEMPORARY GABION OUTLET STRUCTURE	TGOS
	<u></u>	AT-GRADE INLET PROTECTION	[
PROPOSED STORM DRAIN IN ET		CURB INLET PROTECTION	
PROPOSED STORM DRAIN INLET	[0]	MEDIAN INLET PROTECTION	
PROPOSED STORM DRAIN MANHOLE		STANDARD INLET PROTECTION	
EXISTING STORM DRAIN		COMBINATION INLET PROTECTION	<u></u>
EXISTING INLET			COIF
EXISTING UTILITY POLE	-	STABILIZED CONSTRUCTION ENTRANCE	SESCE
EXISTING TREE	1 3	PROPOSED UTILITY POLE	
EXISTING TREE LINE		PROPOSED UTILITY CONDUIT	
CUT SLOPE		PROPOSED UTILITY VAULT	
FILL SLOPE		EXISTING GAS	
STREET LIGHT	·	EXISTING WATER	
STREET LIGHT HANDBOX	<u> </u>	EXISTING WATER	
STREET LIGHT CONDUIT	(11)		
EXISTING CONTOUR (MINOR)		EXISTING FIBER OPTIC	F0 —

SHA TRACKING NO. 21-AP-MO-003-21

GN-01

R. ADG 7 7 N

NO. REVISION

RECOMMENDED FOR APPROVAL

SEE TITLE SHEET FOR SIGNATURES Chief, Design Section

APPROVED

EXISTING CONTOUR (MAJOR) __

WHITE FLINT METRO STATION ACCESS IMPROVEMENTS

GENERAL NOTES, SYMBOLS AND ABBREVIATIONS

Stantec

6110 FROST PLACE,
LAUREL, MARYLAND 20707

(301) 982–2800

PROFESSIONAL CERTIFICATION:
I HEREBY CERTIFY THAT THESE DOCUMENTS WERE PREPARED
OR APPROVED BY ME, AND THAT I AM A DULY LICENSED
PROFESSIONAL ENGINEER UNDER THE LAWS OF THE STATE
OF MARYLAND.

LICENSE NO: 28255 EXPIRATION DATE: 6-30-2022

DWG. Drawing

SEE TITLE SHEET FOR SIGNATURES
Chief, Division of Transportation Engineering

Designed by:______ Drawn by:_____

Date

Drawn by:_____ Checked by:____

MONTGOMERY COUNTY DEPARTMENT OF TRANSPORTATION


DIVISION OF TRANSPORTATION ENGINEERING
GAITHERSBURG, MARYLAND


SCALE : NO=SCALE

Project No. : 502106

DATE : SEPT 2021

SHEET 02 of 28

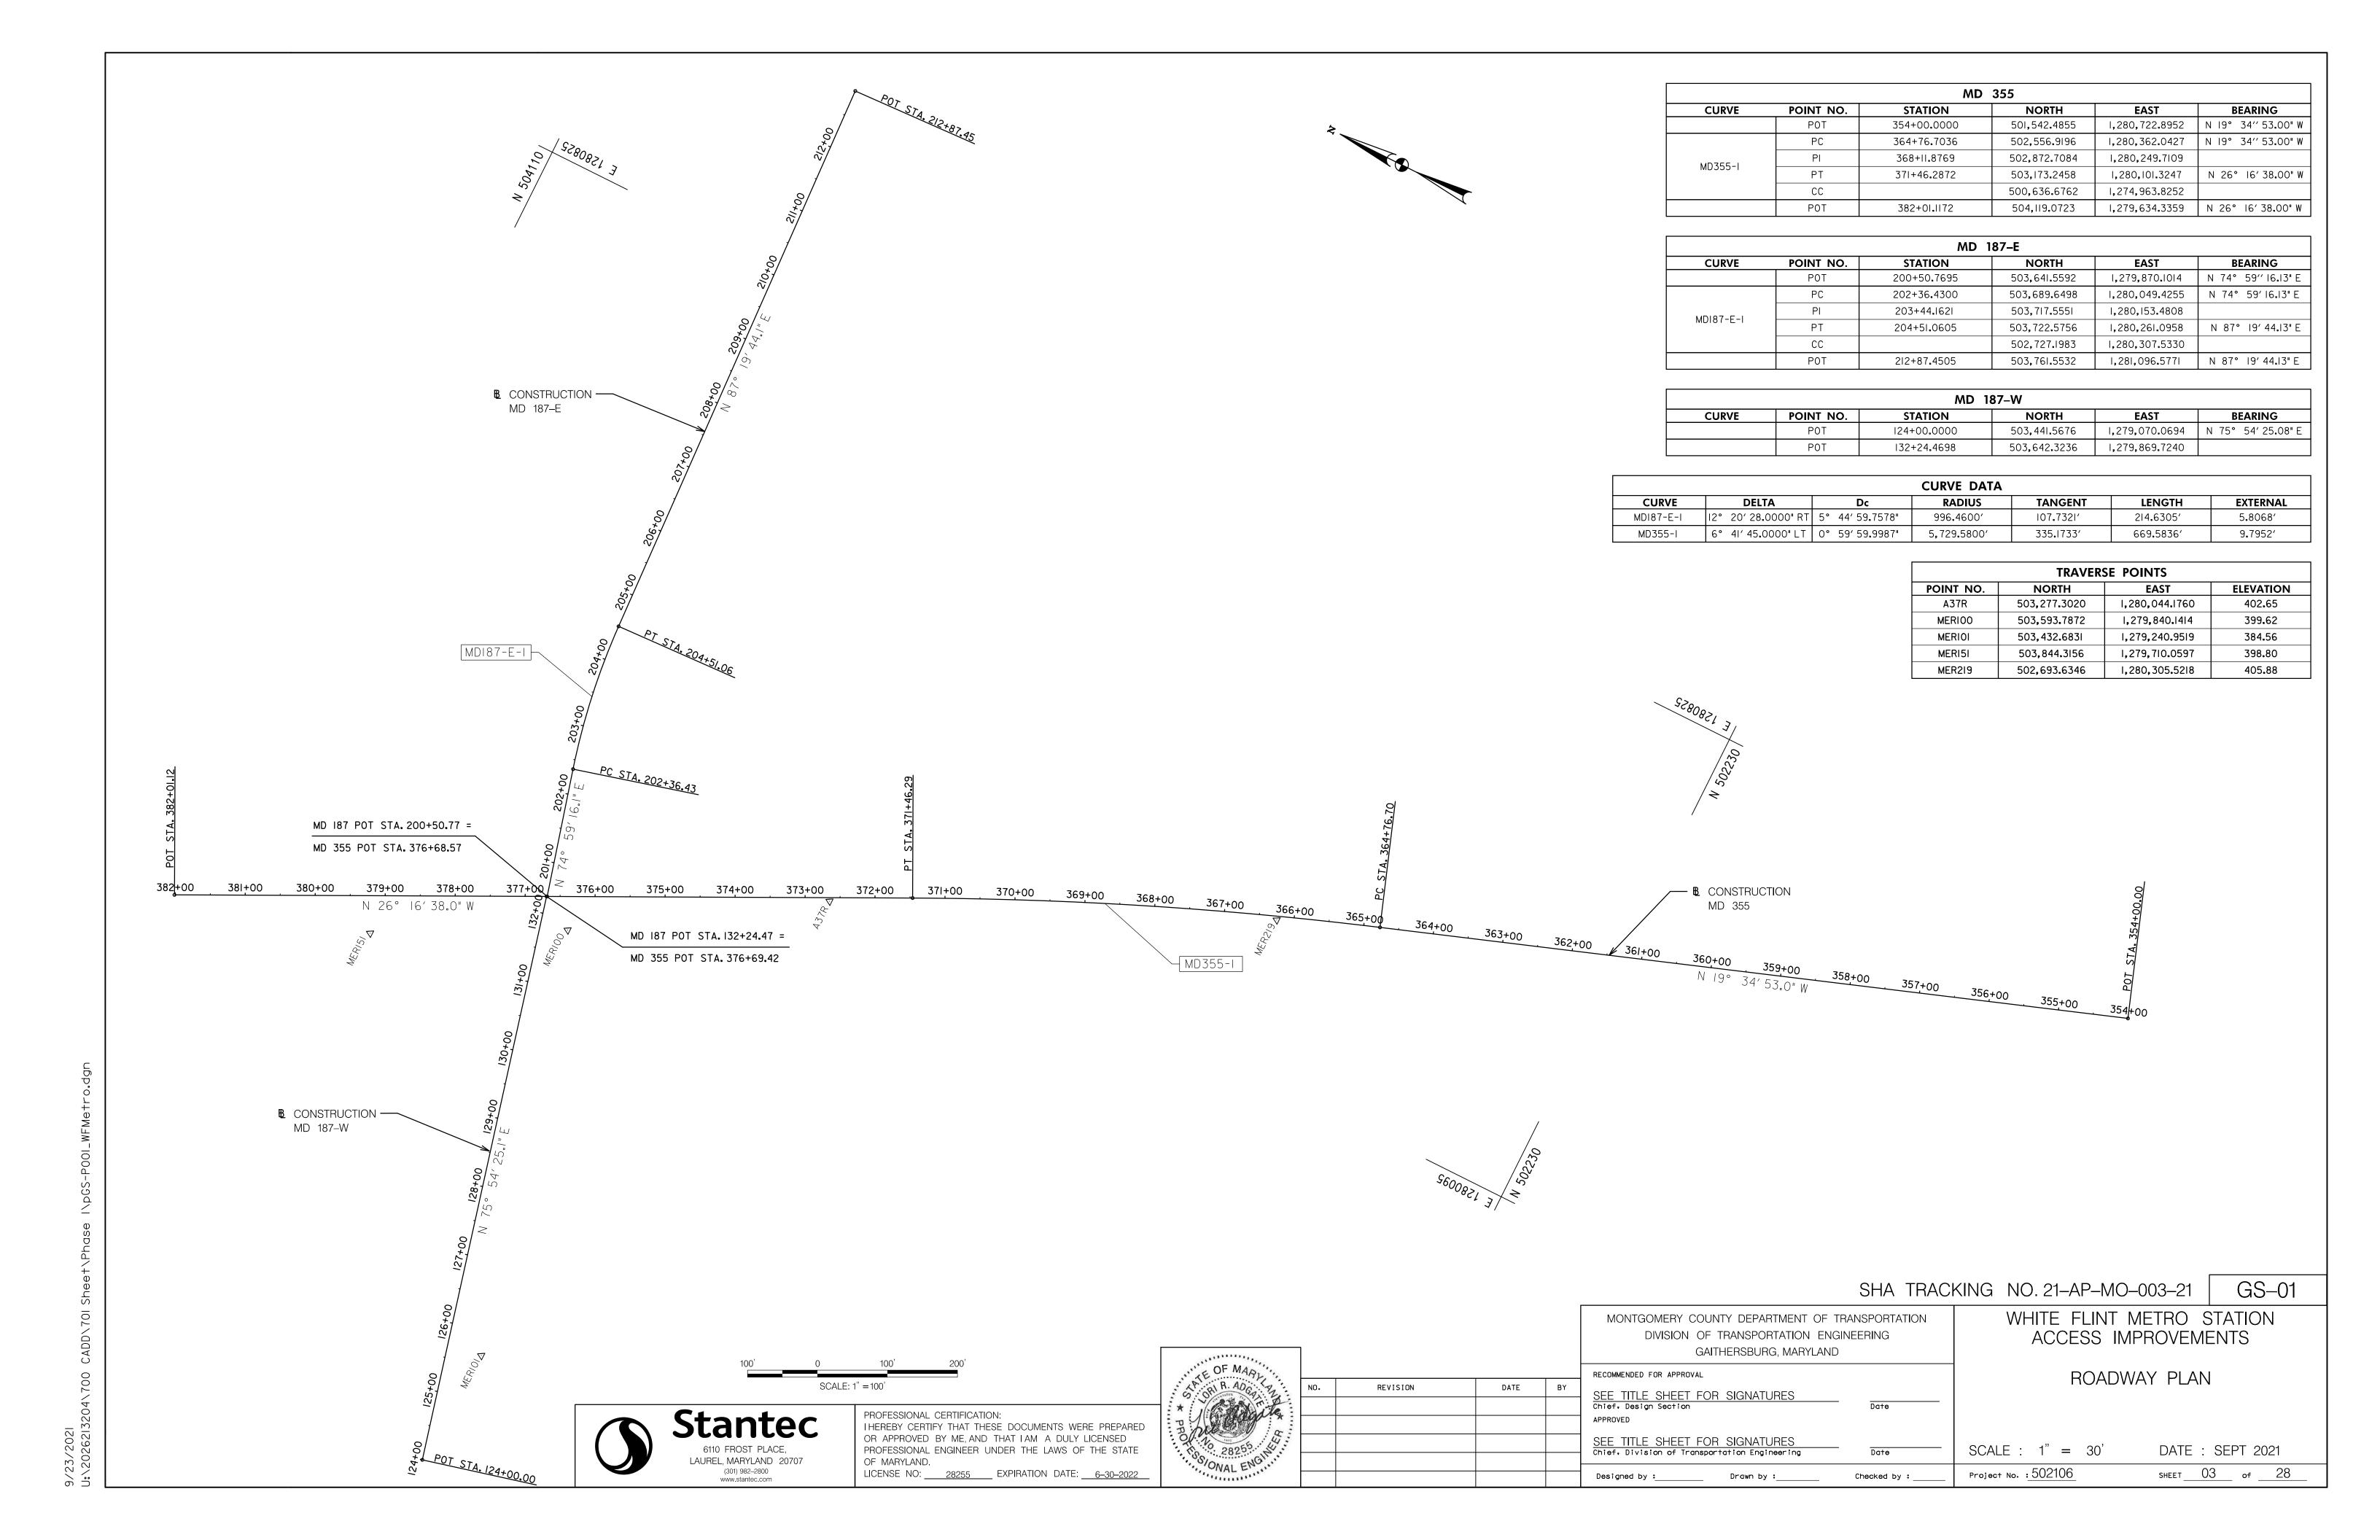

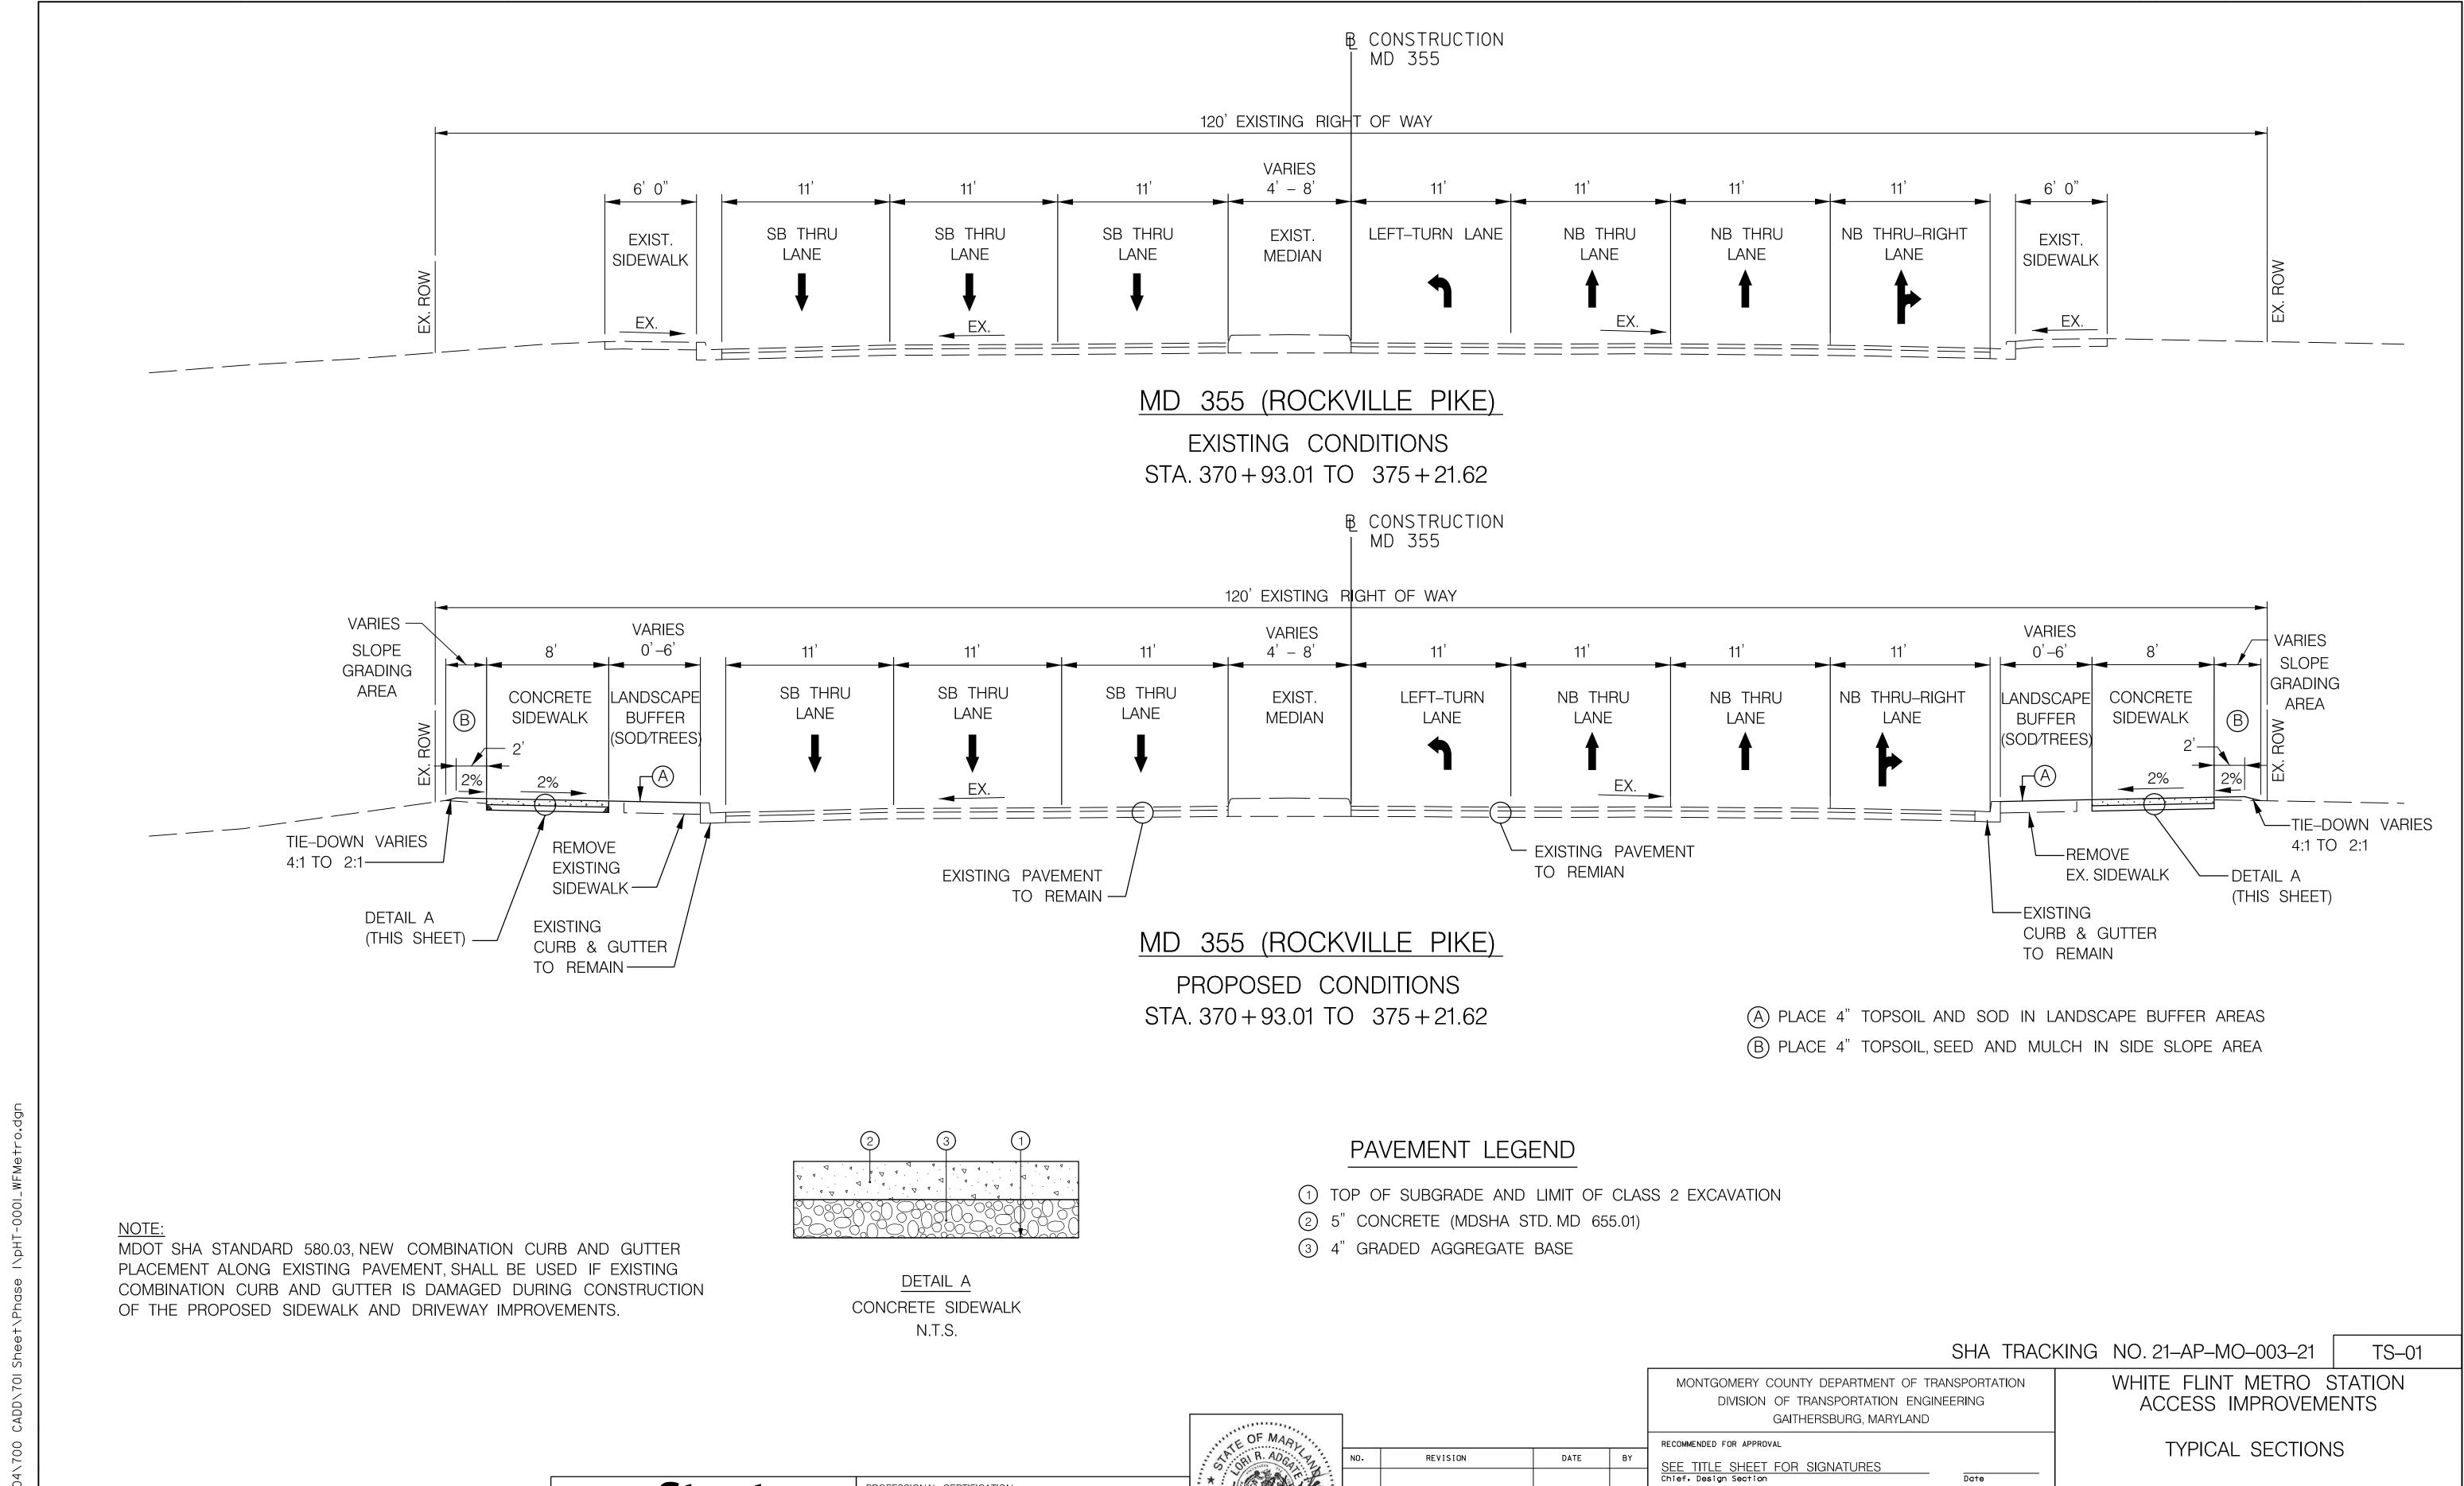

SEE TITLE SHEET FOR SIGNATURES
Chief, Division of Transportation Engineering

Drawn by:_

Checked by :

SCALE : 1" = 5"

Project No. : 502106

DATE: SEPT 2021

SHEET 04 of 28

Stantec

LAUREL, MARYLAND 20707


SCALE: 1'' = 5'

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PROFESSIONAL ENGINEER UNDER THE LAWS OF THE STATE

LICENSE NO: 28255 EXPIRATION DATE: 6-30-2022




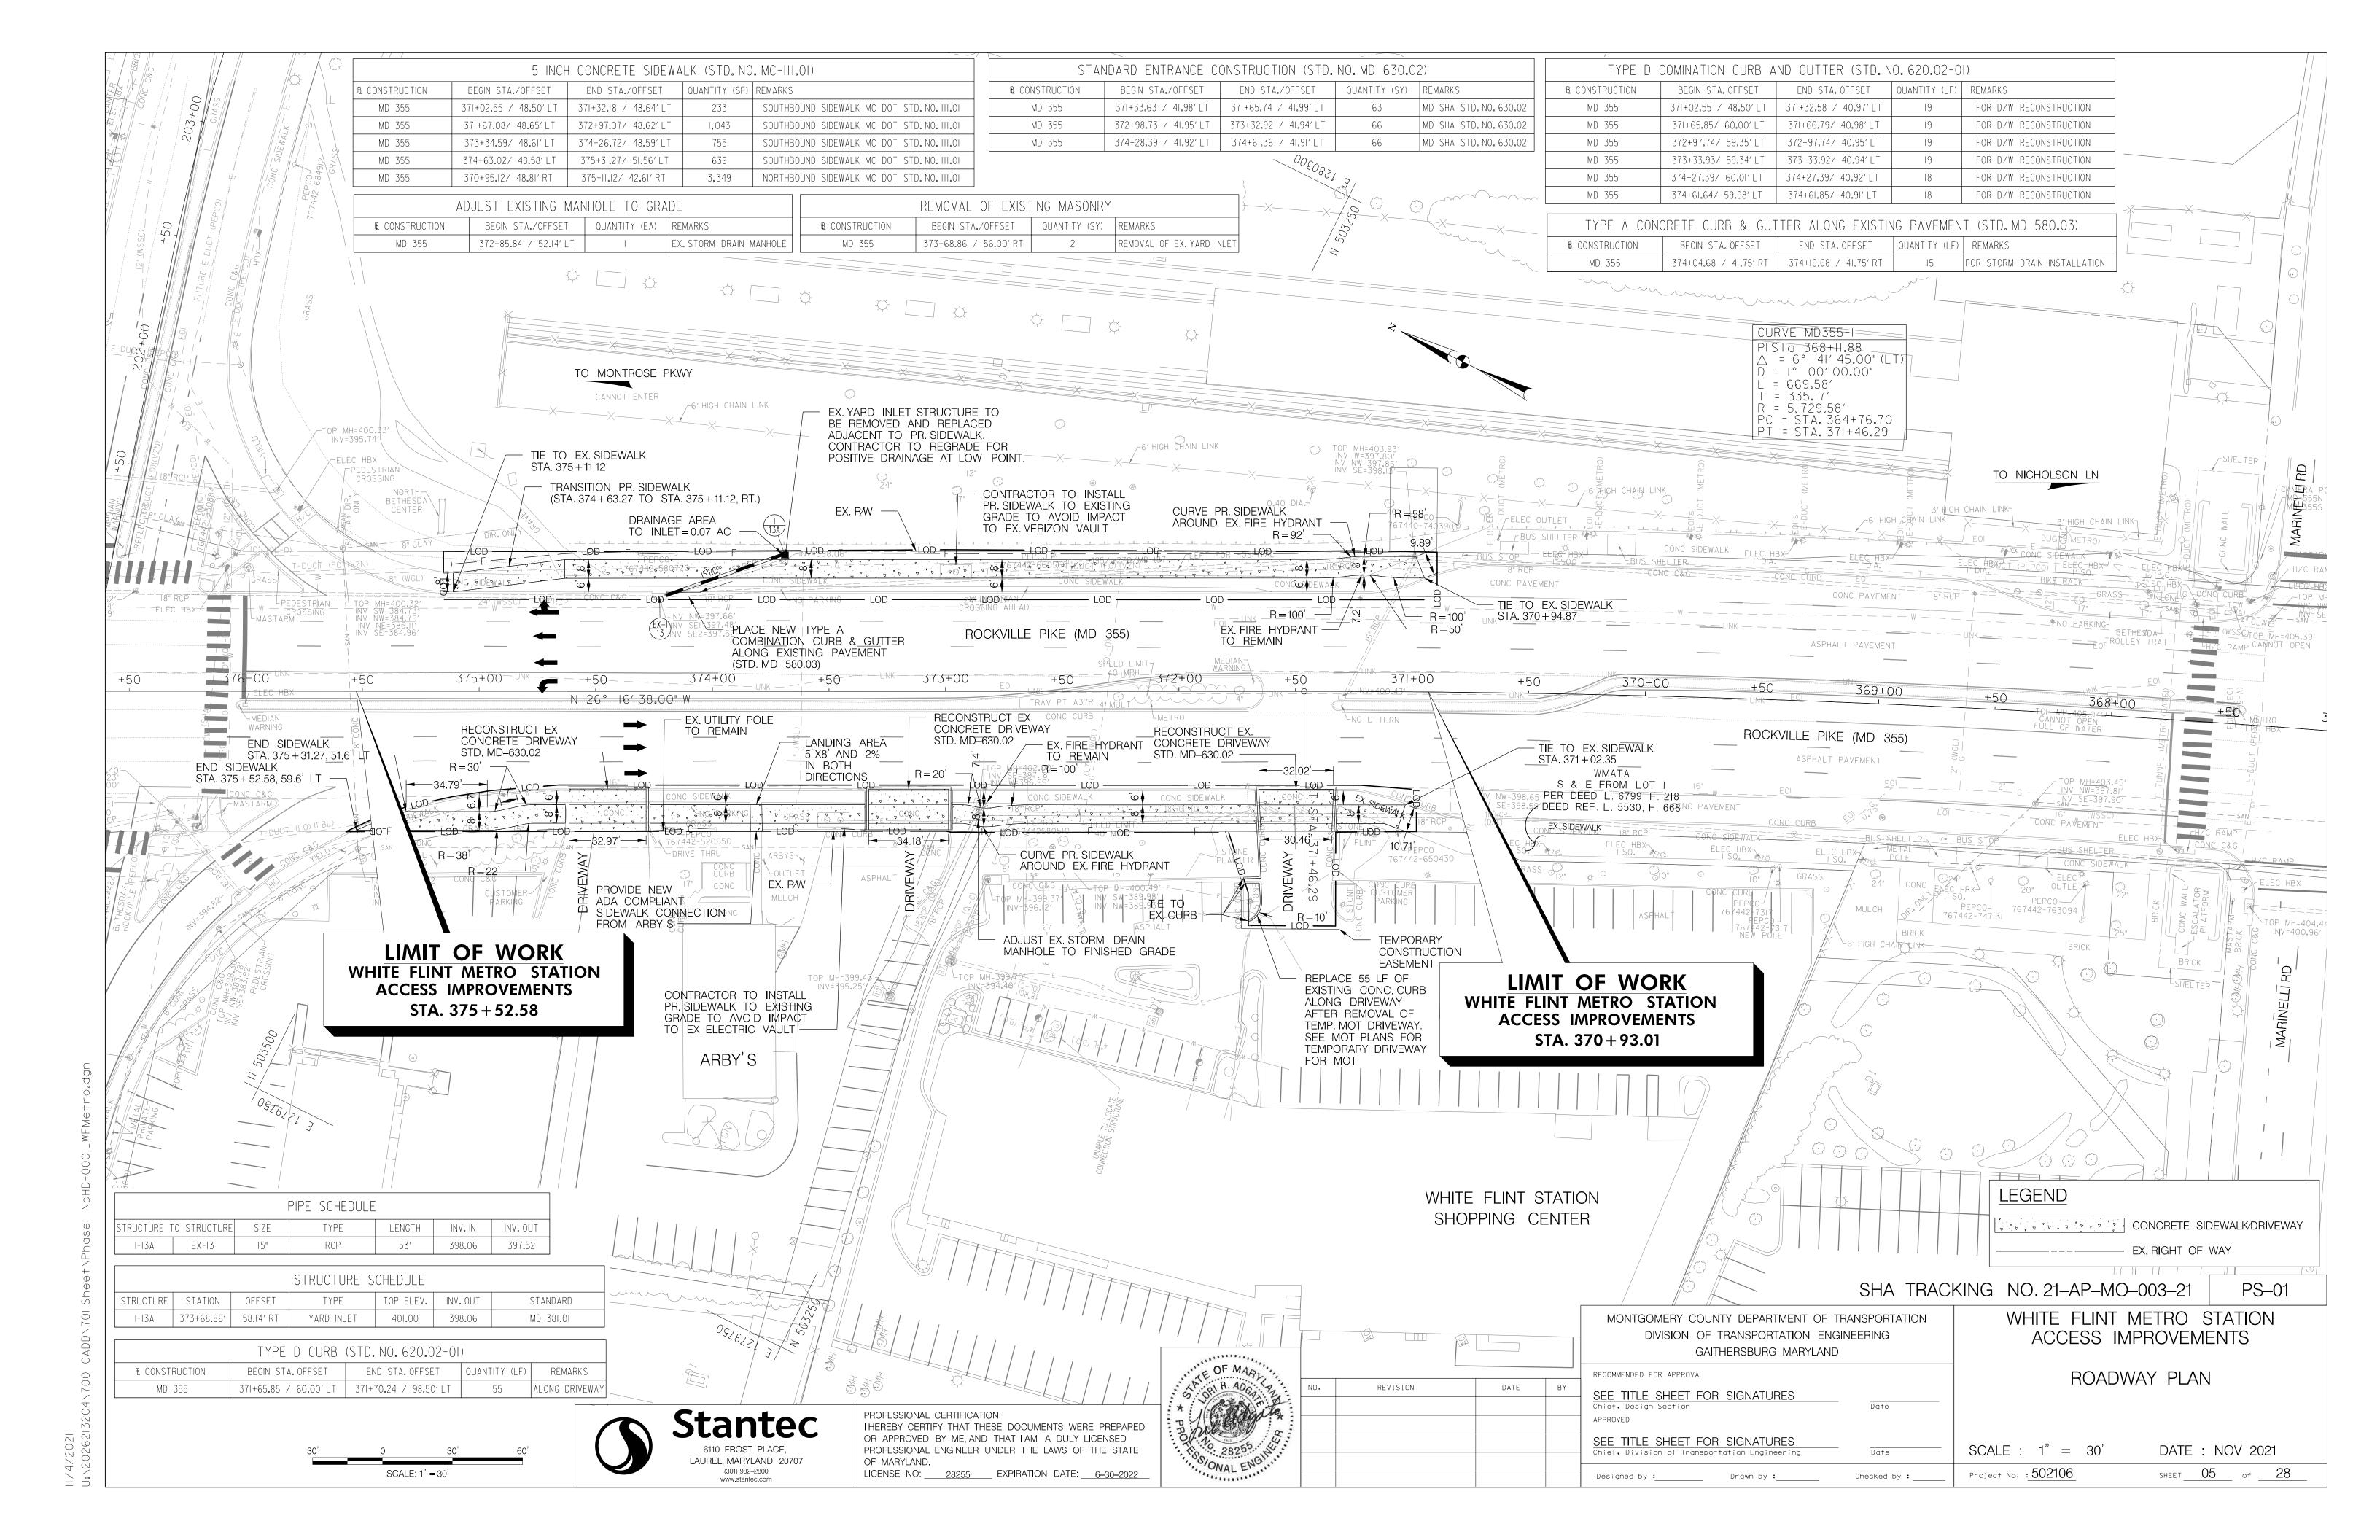

VERTICAL SCALE: 1" = 6' HORIZONTAL SCALE: 1" = 30'



PROFESSIONAL CERTIFICATION:
I HEREBY CERTIFY THAT THESE DOCUMENTS WERE PREPARED
OR APPROVED BY ME, AND THAT I AM A DULY LICENSED PROFESSIONAL ENGINEER UNDER THE LAWS OF THE STATE OF MARYLAND. LICENSE NO: 28255 EXPIRATION DATE: 6-30-2022

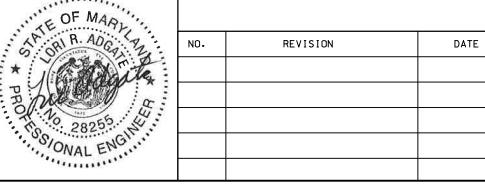

				RECOMME
NO.	REVISION	DATE	BY	SEE -
				SEE Chief,
				APPROVI
				SEE Chief,
				Chief,
				Design

MENDED FOR APPROVAL TITLE SHEET FOR SIGNATURES

- Design Section SCALE : H 1" = 30'; V 1" = 6' DATE : SEPT 2021 Project No. : 502106 gned by :_____ Drawn by :___ Checked by : _

ROADWAY CENTERLINE PROFILE

SHEET 06 of 28


GAITHERSBURG, MARYLAND


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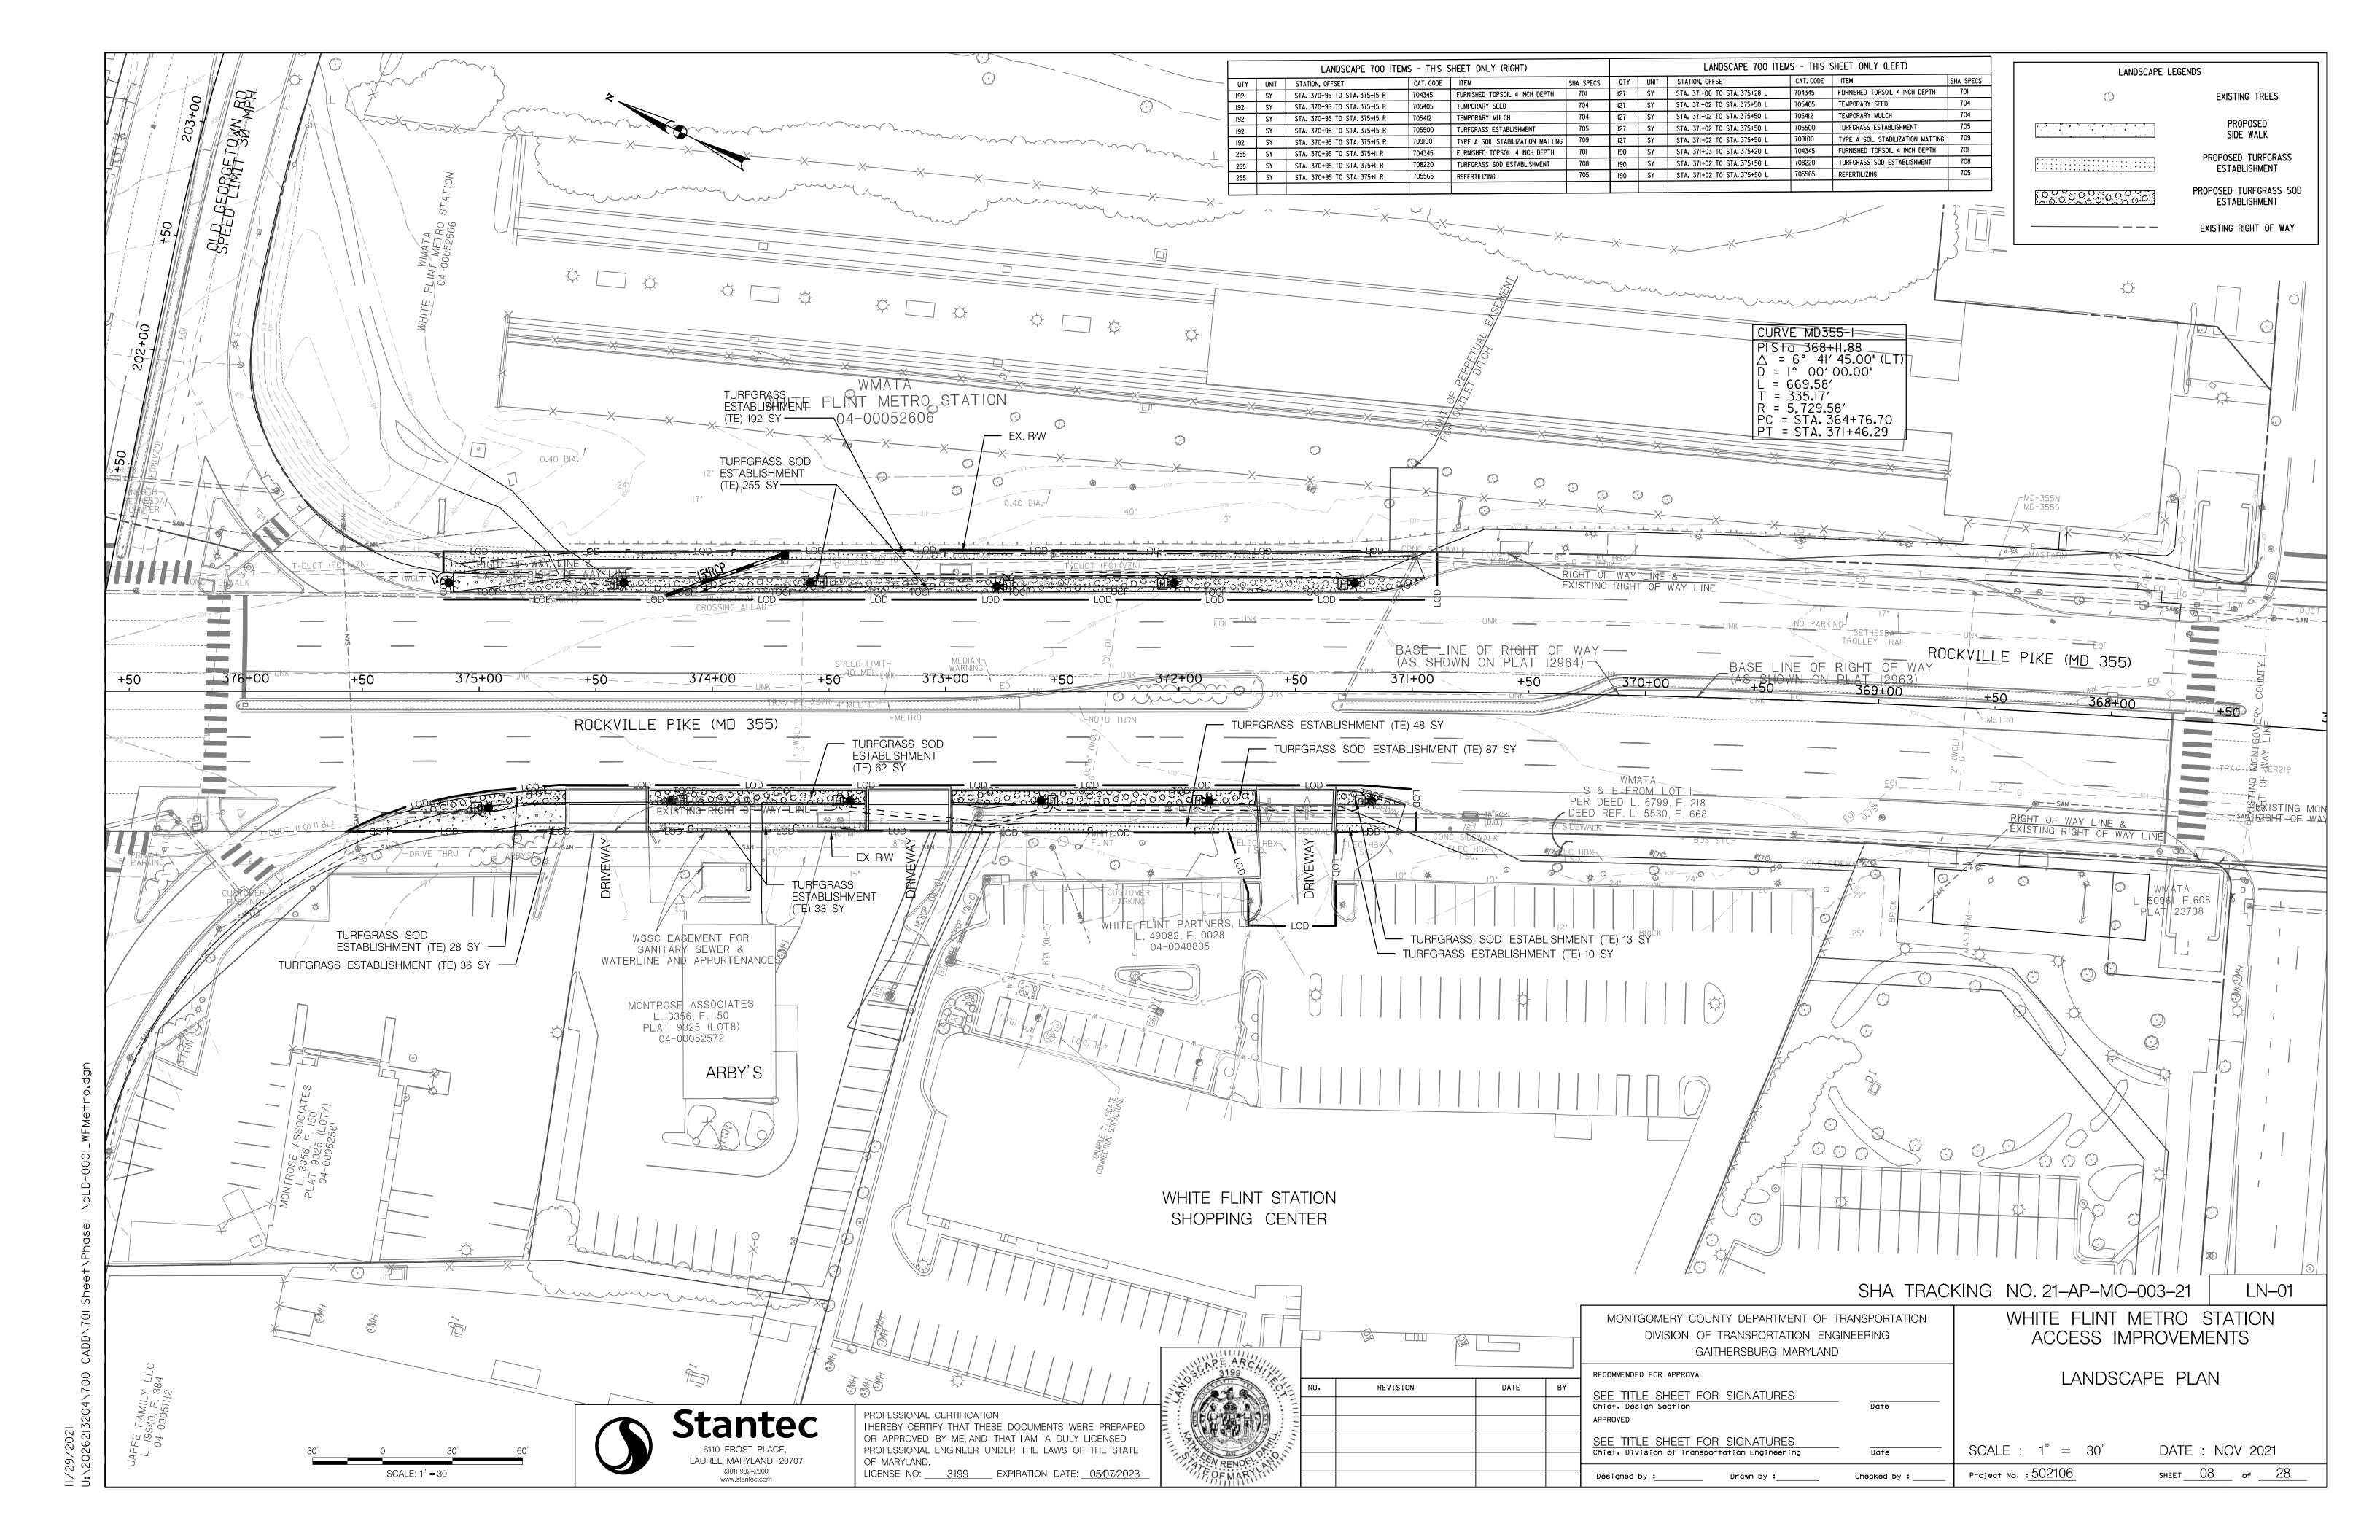
DIVISION OF TRANSPORTATION ENGINEERING

SHA TRACKING NO. 21-AP-MO-003-21 PR-01 WHITE FLINT METRO STATION

MONTGOMERY COUNTY DEPARTMENT OF TRANSPORTATION



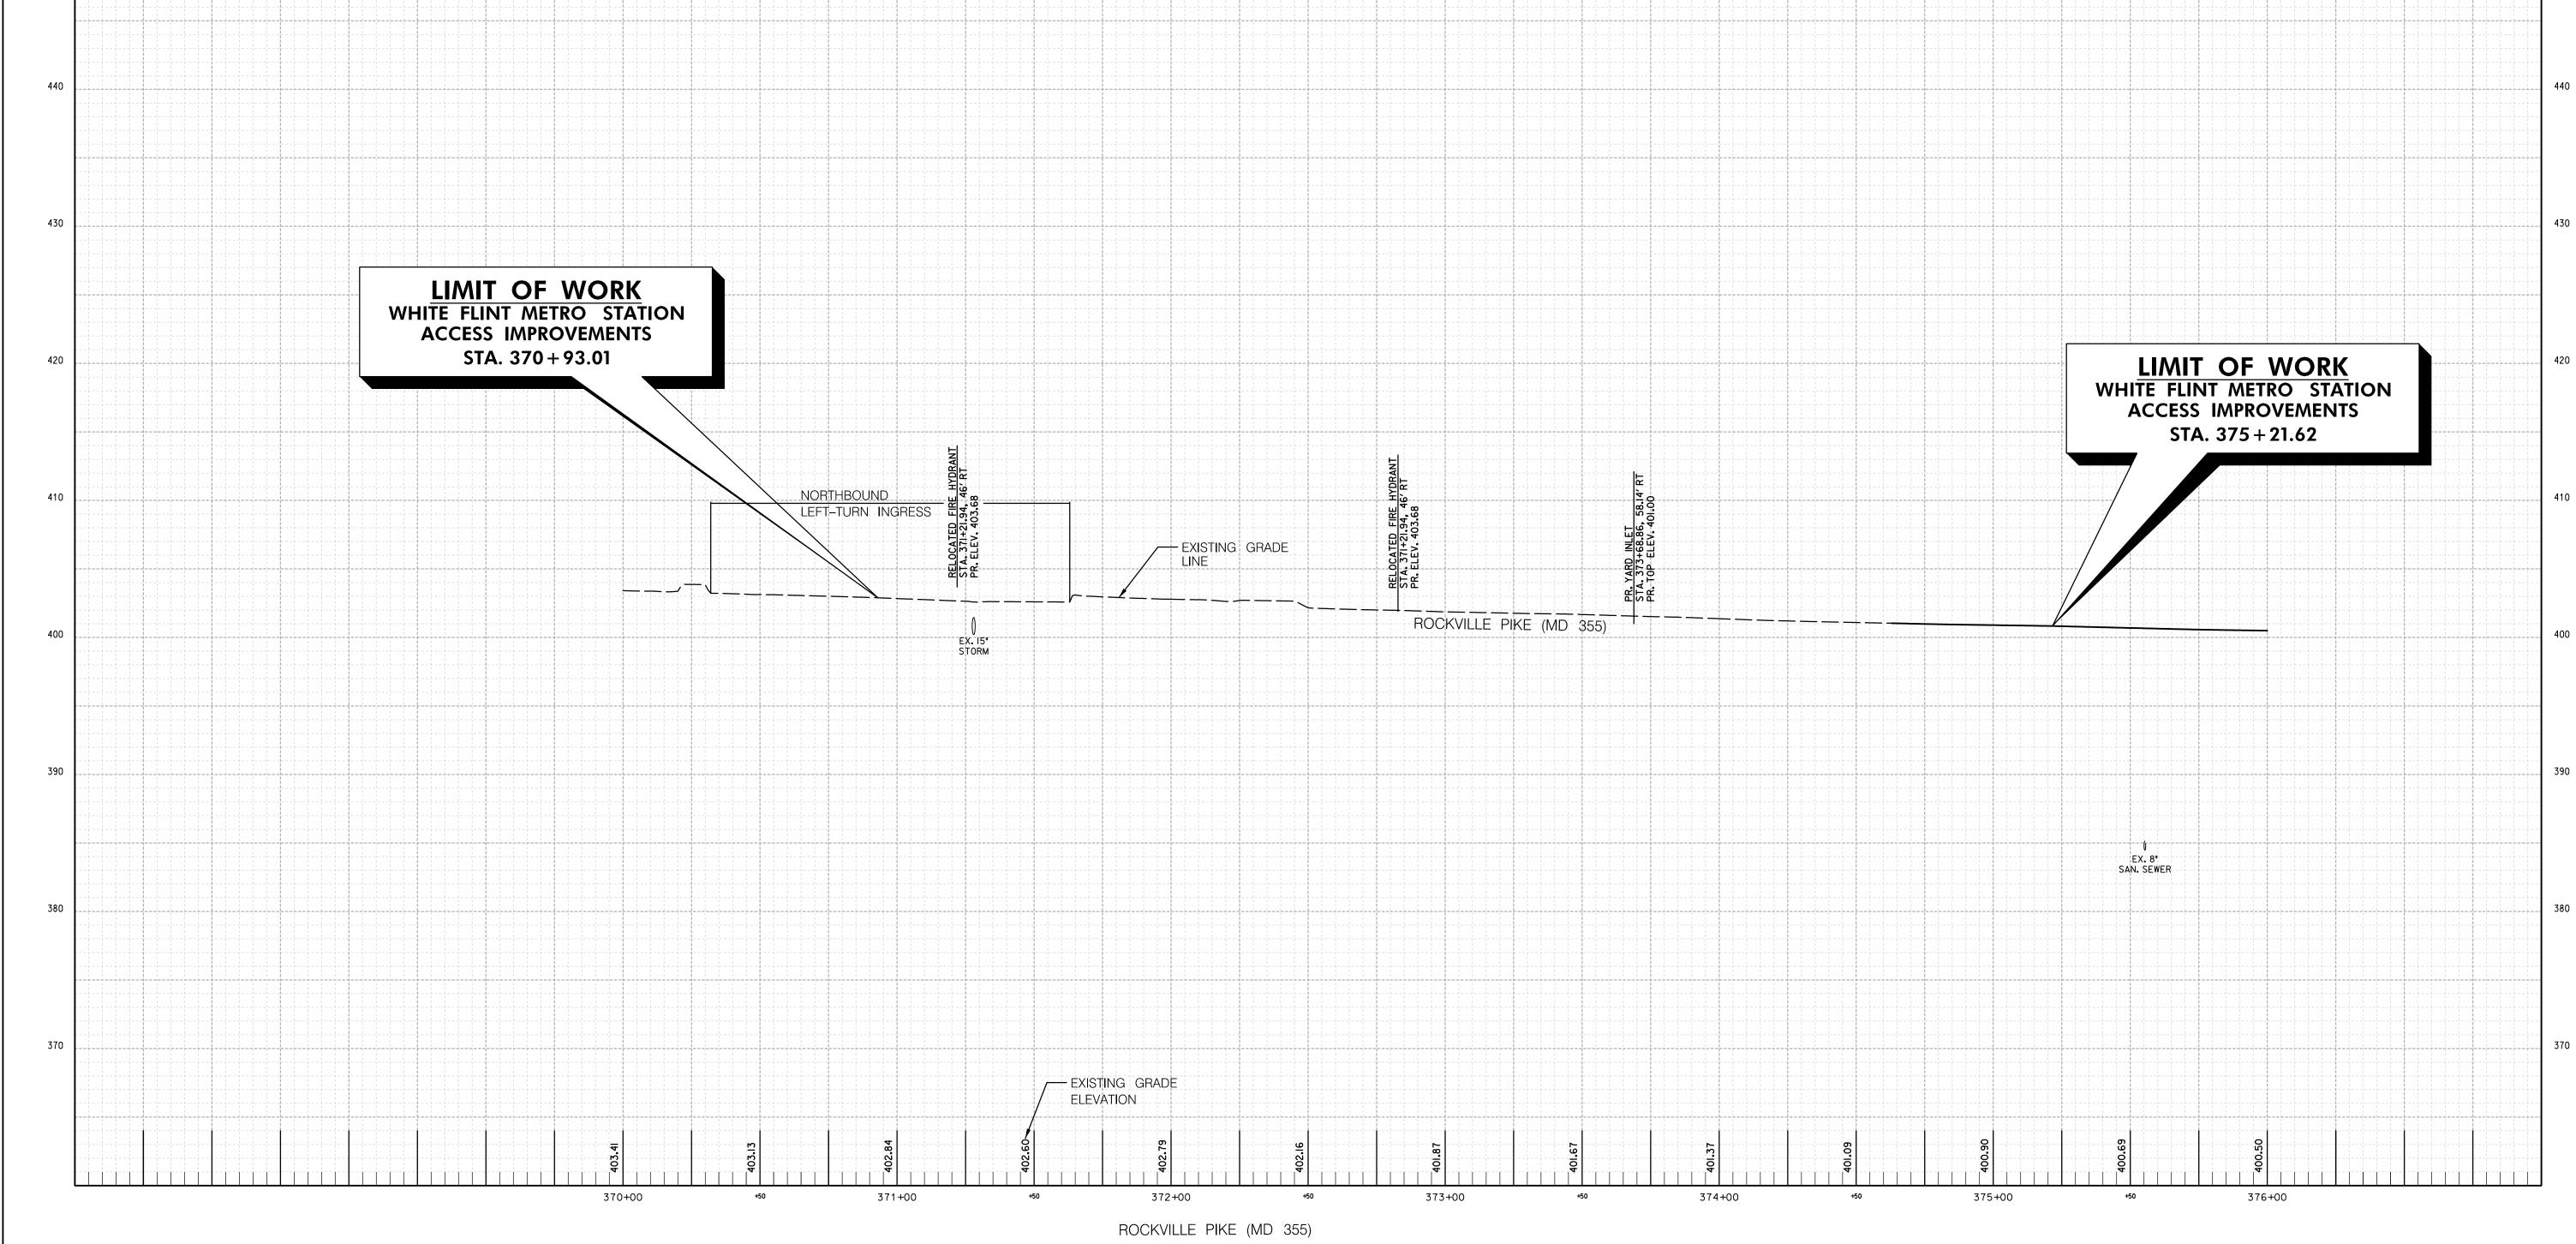

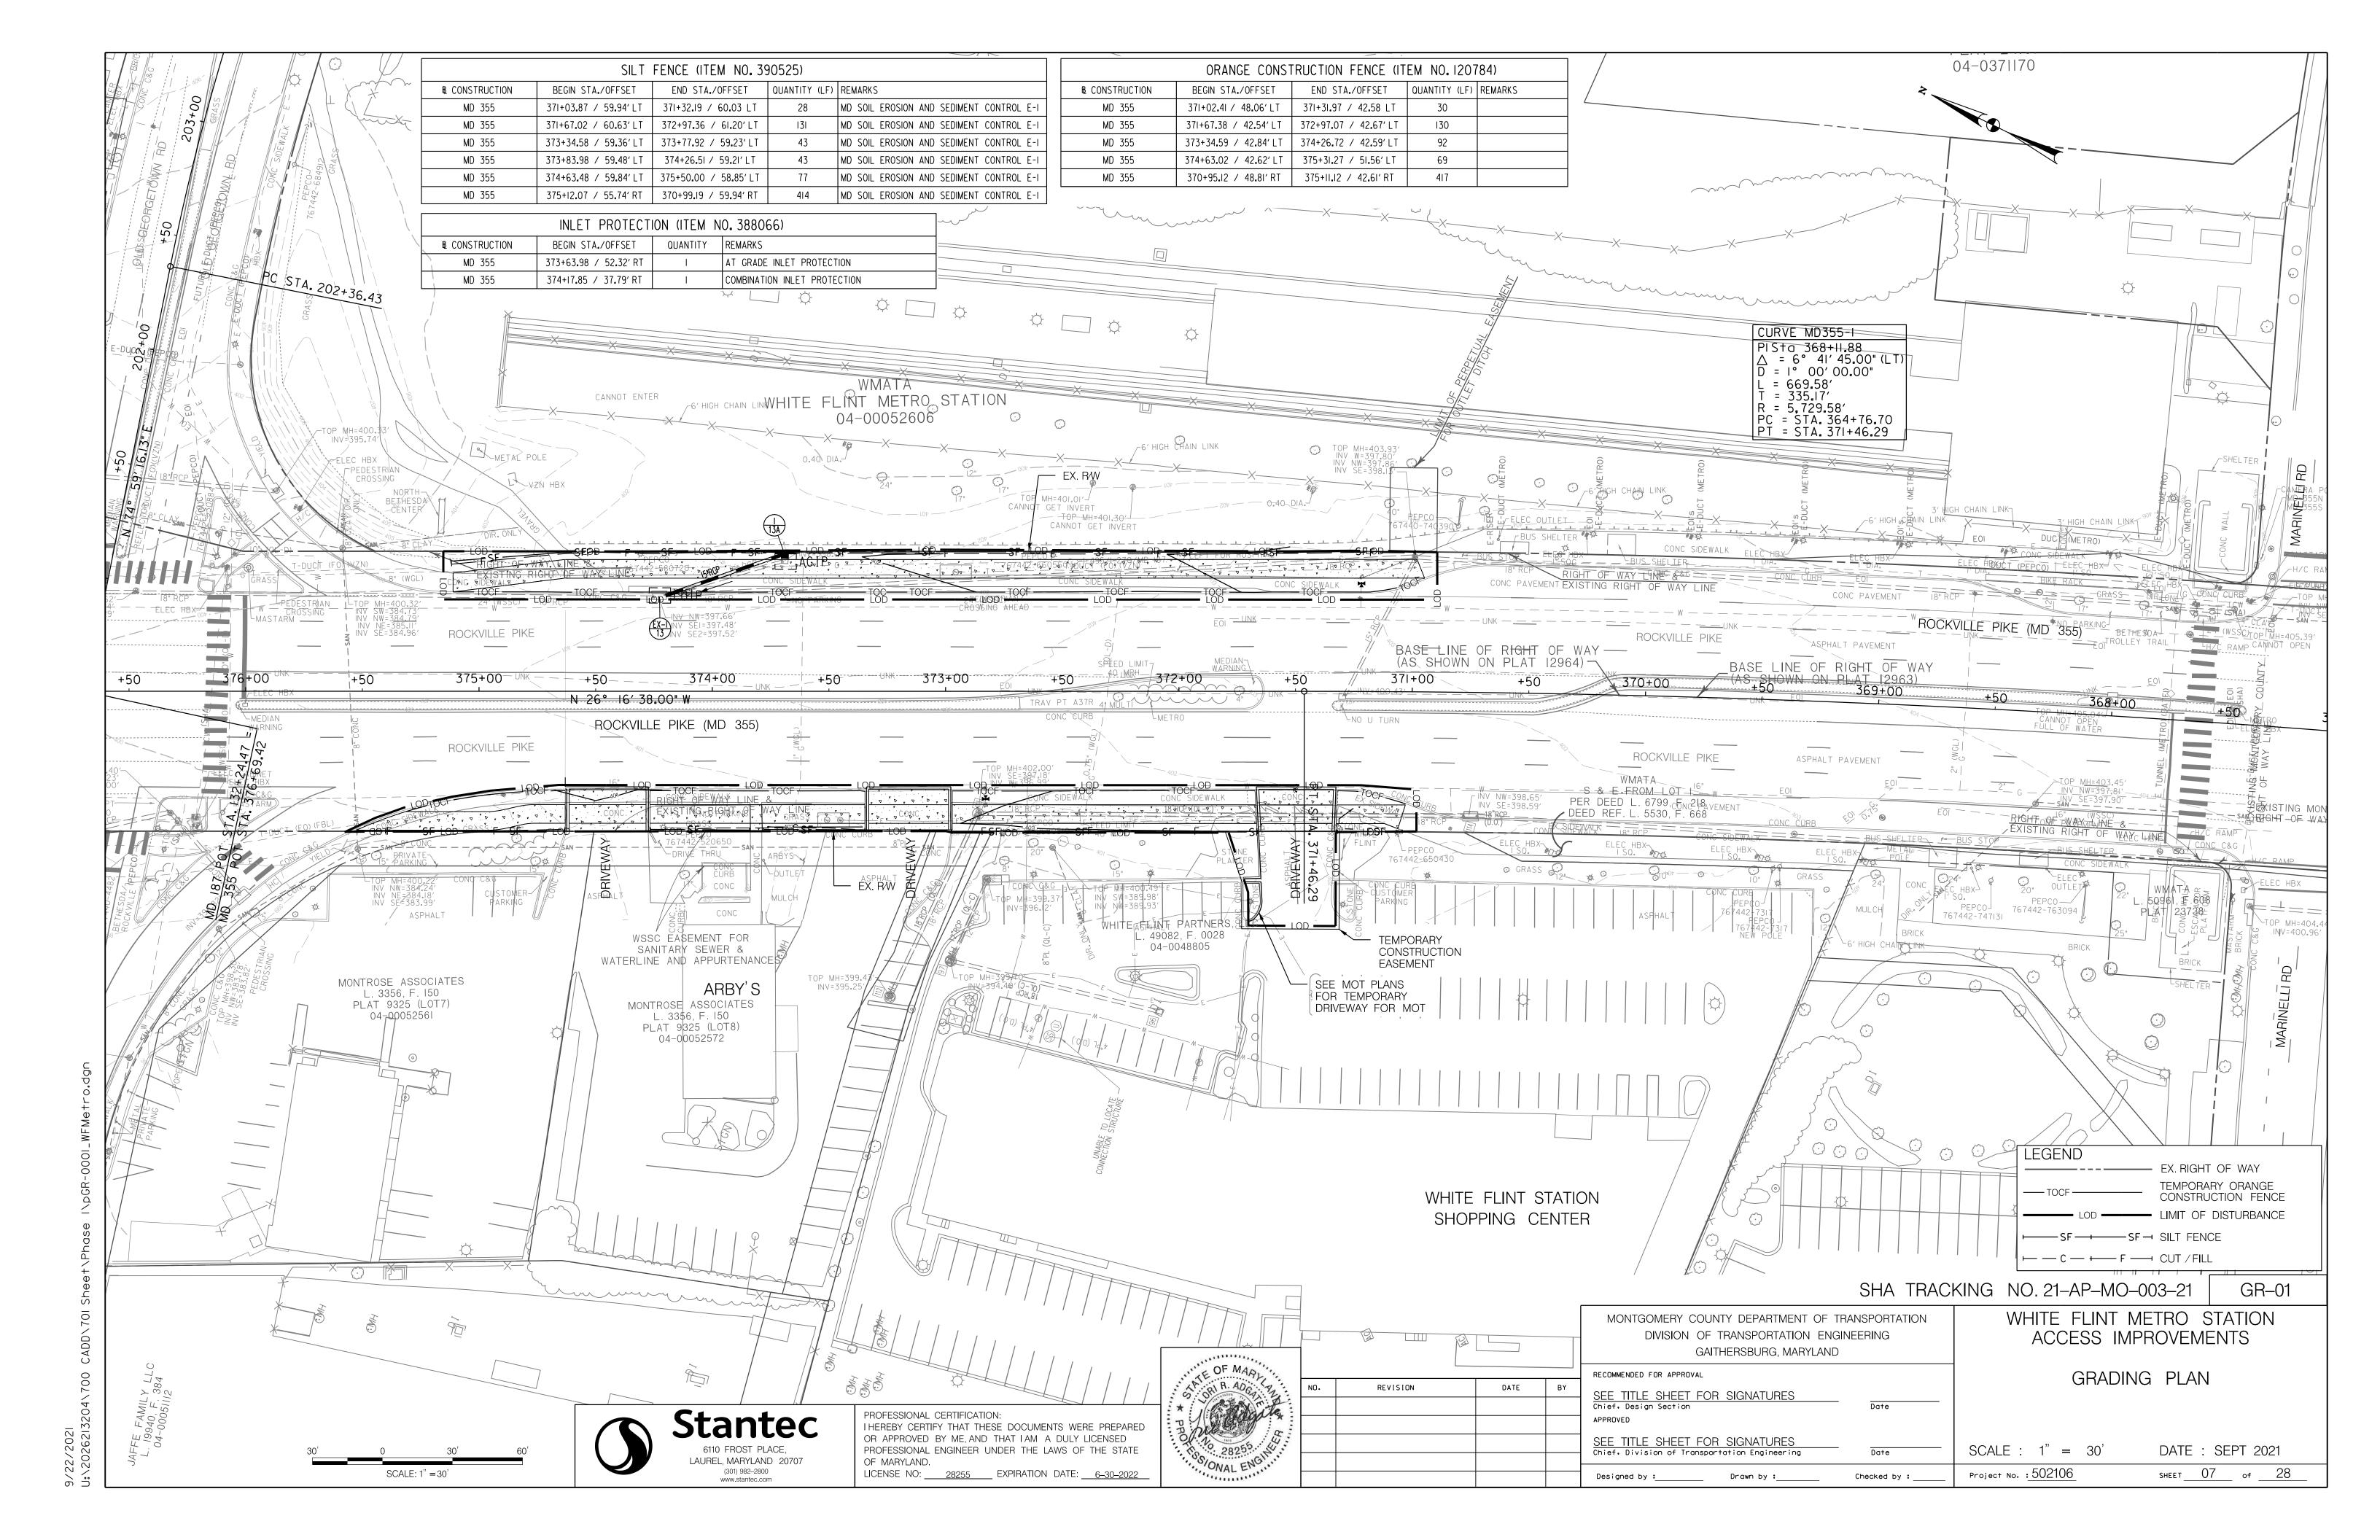

7.2 SHA STANDARD SPECIFICATIONS. LANDSCAPE CONSTRUCTION SHALL CONFORM TO SECTIONS 701 THROUGH 716, AND LANDSCAPE MATERIALS SHALL CONFORM TO SECTION 920 OF THE MOST RECENT REVISION OF SHA STANDARD SPECIFICATIONS FOR CONSTRUCTION AND MATERIALS, INCLUDING ALL REVISIONS AND SUPPLEMENTS, AND AS SPECIFIED IN THESE NOTES. THESE REQUIREMENTS SHALL SUPERSEDE ALL OTHER SPECIFICATIONS FOR WORK ON SHA PROPERTY. ALL SHA SPECIFICATIONS FOR LANDSCAPING AND LANDSCAPE MATERIALS PUBLISHED IN 2008 HAVE BEEN REPLACED. CURRENT SPECIFICATIONS ARE A HTTP://WWW.ROADS.MARYLAND.GOV/INDEX.ASPX?PAGEID=44

7.3 EROSION AND SEDIMENT CONTROL MANAGER (ESCM). SOIL DISTURBANCE SUCH AS GRADING, EXCAVATION, SOIL PLACEMENT OR OTHER ACTIVITIES THAT INVOLVE SOIL DISTURBANCE SHALL BE SUPERVISED BY AN ESCM MANAGER WITH A VALID "SHA YELLOW CARD" IN CONFORMANCE WITH SHA STANDARD SPECIFICATIONS AND ANY APPLICABLE EROSION AND SEDIMENT CONTROL PERMIT.

SHA STANDARD DETAILS FOR TREES, SHRUBS AND PLANTING BEDS. THE INSTALLATION OF TREES, SHRUBS, PLANTING BEDS AND OTHER LANDSCAPE CONSTRUCTION RELATED TO SECTION 710 OF THE SHA STANDARD SPECIFICATIONS SHALL CONFORM TO THE "SHA BOOK OF STANDARDS FOR HIGHWAY & INCIDENTAL STRUCTURES -CATEGORY 7" AT

HTTP://APPS.ROADS.MARYLAND.GOV/BUSINESSWITHSHA/BIZSTDSSPECS/DESMANUALSTDPUB /PUBLICATIONSONLINE/OHD/BOOKSTD/TOCCAT7.ASP

7.5 TEMPORARY STABILIZATION SHALL BE INSTALLED IN CONFORMANCE WITH SECTION 704 TO ENSURE THAT AREAS OF SOIL DISTURBANCE ARE PROTECTED FROM WIND, RAINFALL AND FLOWING WATER UNTIL PERMANENT STABILIZATION IS INSTALLED.

7.6 ROADWAY PAVEMENT REMOVAL. AREAS OF ROADWAY REMOVAL SHALL BE EXCAVATED TO REMOVED PAVEMENTS, AGGREGATE BASE, AND COMPACTED SOIL TO A MINIMUM DEPTH OF 10 INCHES BELOW THE PAVEMENT SURFACE OR AS NECESSARY TO REMOVE ALL MATERIAL UNSUITABLE FOR LANDSCAPING. THE EXCAVATION AREAS SHALL BE RESTORED WITH SUBSOIL AND TOPSOIL AS PART OF SOIL RESTORATION.

TEMPORARY MULCH, EITHER AS TEMPORARY STRAW MULCH OR TEMPORARY MATTING MULCH, SHALL BE INSTALLED AT THE END OF EACH WORKING DAY TO PROVIDE "SAME DAY STABILIZATION" UNLESS OTHER APPROVED STABILIZATION IS INSTALLED.

TEMPORARY STRAW MULCH SHALL BE INSTALLED ON AREAS AND SLOPES FLATTER THAN 4:1 TEMPORARY MATTING MULCH SHALL BE APPLIED ON SLOPES 4:1 AND STEEPER, AND TO AREAS WITIN CHANNELS. TEMPORARY SEED SHALL BE INSTALLED IN LIEU OF TEMPORARY MULCH WHEN SOIL REDISTURBANCE IS EXPECTED MORE THAN 30 DAYS AFTER SOIL DISTURBANCE. THE REQUIRED APPLICATION RATE SHALL BE 100 LBS PER ACRE OF 37-0-0 (SCU) FERTILIZER.

7.7 EXCAVATION AND DEBRIS REMOVAL. DEBRIS RELATED TO THE DEMOLITION OF SIDEWALKS, DRIVEWAYS CURBS, TREES, STUMPS, ROOTS, FENCING, PIPES, AND OTHER MATERIALS THAT MAY INTERFERE WITH LANDSCAPE INSTALLATION OR FUTURE MAINTENANCE SHALL BE EXCAVATED AS NECESSARY FOR THEIR COMPLETE REMOVAL AND DISPOSAL.

7.8 SOIL RESTORATION. AREAS OF PAVEMENT REMOVAL, EXCAVATION OR DRILLING IN LANDSCAPED AREAS SHALL REMOVE EXCAVATED DEBRIS AND RESTORE THE SUBGRADE WITH APPROVED SUBSOIL AND TOPSOIL PLACED IN CONFORMANCE WITH SECTION 701 OF THE SHA STANDARD SPECIFICATIONS.

1. A LAYER OF APPROVED TOPSOIL AT LEAST 4 INCH DEPTH SHALL BE PLACED ON ALL DISTURBED AREAS FLATTER THAN 2:1 AND IN ALL CHANNELS PRIOR TO SEEDING, SODDING OR OTHER LANDSCAPING, UNLESS OTHERWISE SPECIFIED.

2. A LAYER OF APPROVED TOPSOIL AT LEAST 2 INCH DEPTH SHALL BE PLACED ON ALL DISTURBED AREAS 2:1 AND STEEPER PRIOR TO SEEDING, SODDING OR OTHER LANDSCAPING, UNLESS OTHERWISE SPECIFIED. 3. BIORETENTION SOIL MIX (BSM) AND OTHER MATERIALS INSTALLED IN CONJUNCTION WITH SPI 316 STORMWATER FILTRATION FACILITIES AND SHA STORMWATER DETAILS SHALL BE INSTALLED IN CONFORMANCE WITH THE SHA LANDSCAPE NOTES AND LANDSCAPE PLANS. PLANT MATERIALS AND MULCH SHALL BE INSTALLED IN BSM IN CONFORMANCE WITH STORMWATER DETAILS, SECTION 710 OR OTHER SHA SPECIFICATIONS.

7.9 TURFGRASS SOD ESTABLISHMENT SHALL BE PERFORMED IN ALL DISTURBED AREAS, OR WITHIN THE AREAS INDICATED IN THE PLANS, IN CONFORMANCE WITH SECTION 708 OF THE SHA STANDARD SPECIFICATIONS. THE REQUIRED APPLICATION RATE OF 20-16-12 FERTILIZER SHALL BE 200 LBS PER ACRE, AND NO FERTILIZER SHALL BE APPLIED FROM NOVEMBER 15 TO MARCH 1.

7.10 TURFGRASS ESTABLISHMENT SHALL BE PERFORMED IN ALL DISTURED AREAS, OR WITHIN THE AREAS INDICATED IN THE PLANS, IN CONFORMANCE WITH SECTION 705 OF THE SHA STANDARD SPECIFICATIONS. THE REQUIRED APPLICATION RATE OF 20-16-12 FERTILIZER SHALL BE 200 LBS PER ACRE, AND NO FERTILIZER SHALL BE APPLIED FROM NOVEMBER 15 TO MARCH 1.

7.11 SOIL STABILIZATION MATTING SHALL BE INSTALLED IN CONFORMANCE WITH SECTION 709 OF THE SHA STANDARD SPECIFICATIONS, IN CONJUCTION WITH TRUFGRASS ESTABLISHMENT PER SECTION 705 OR MEADOW ESTABLISHMENT PER SECTION 707 AS FOLLOWS:

1. AREAS FLATTER THAN 6:1. TYPE A OR TYPE E MATTING MAY BE INSTALLED IN LIEU OF STRAW MULCH AND HYDROMULCH BINDER IN CONJUCTION WITH TURFGRASS ESTABLISHMENT. 2. AREAS STEEEPER THAN 6:1 AND FLATTER THAN 4:1. TYPE A OR TYPE E MATTING SHALL BE INSTALLED IN LIEU OF STRAW MULCH AND HYDORMULCH BINDER IN CONJUCTION WITH TURFGRASS ESTABLISHMENT, UNLESS

DELINEATED AND NOTED OTHERWISE. 3. CHANNELS, STORMWATER MANAGEMENT FACILITIES, AND SLOPES 4:1 AND STEEPER TYPE A SOIL STABILIZATION MATTING SHALL BE INSTALLED IN LIEU OF STRAW MULCH AND HYDROMULCH BINDR IN CONJUCTION WITH TURFGRASS ESTABLISHMENT, UNLESS DELINEATED AND NOTED OTHERWISE.

7.14 ROADSIDE TREE PERMIT. TREE REMOVAL, TREE INSTALLATION, TREE ROOT AND BRANCH PRUNING, AND OTHER REGULATED IMPACTS TO TREES IN THE SHA RIGHT OF WAY SHALL CONFORM TO THE REQUIREMENTS OF THE ROADSIDE TREE PERMIT (RTP) OF THE MARYLAND DEPARTMENT OF NATURAL RESOURCES, OR THE APPROVED FOREST CONSERVATION ACT PLAN OF THE LOCAL AUTHORITY.

1. A COPY OF THE RTP OR FCP SHALL BE SUBMITTED TO THE SHA OFFICE OF ENVIRONMENTAL DESIGN BEFORE WORK IS PERFORMED, AND A COPY OF THE RTP OR FCP SHALL BE REPRODUCED IN THE PLANS OR BE IN POSSESSION OF THE APPLICANT AT THE PROJECT SITE WHEN THE PERMITTED WORK IS PERFORMED.

2. A MARYLAND LICENSED TREE EXPERT SHALL PERFORM THE SPECIFIED TREE OPERATIONS IN CONFORMANCE WITH THE SHA STANDARD SPECIFICATIONS AND ANSI A300 STANDARDS FOR TREE CARE OPERATIONS.

7.15 TREES AND OTHER PLANT MATERIAL INSTALLATION. TREES, SHRUBS, PERENNIALS, ANNUALS, BULBS. LANDSCAPE BEDS, BARK MULCH AND SIMILAR MATERIALS SHALL BE INSTALLED IN CONFORMANCE WITH SECTION 710 AND 711 OF THE SHA STANDARD SPECIFICATIONS. TREE AND SHRUBS SHALL BE PRUNED AT THE TIME OF INSTALLATION TO ENSURE SIDEWALK CLEARANCE FOR PEDESTRIANS IS MAINTAINED TO A HEIGHT OF 8 FEET. NO TREE OR SHRUB SHALL BE INSTALLED WITHIN 3 FEET OF CURBS, SIDEWALKS, OR PAVEMENT EDGES.

	MAS	TER LAI	NDSCAPE 7	00 ITEMS	
	QTY	UNIT	CAT. CODE	ITEM	SHA SPECS
	764	SY	704345	FURNISHED TOPSOIL 4 INCH DEPTH	701
	319	SY	705405	TEMPORARY SEED	704
	319	SY	705500	TURFGRASS ESTABLISHMENT	705
	319	SY	709100	TYPE A SOIL STABILIZATION MATTING	709
	445	SY	708220	TURFGRASS SOD ESTABLISHMENT	708
	319	SY	705412	TEMPORARY MULCH	704
	445	SY	705565	REFERTILIZING	705
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SHA TRACKING NO. 21-AP-MO-003-21

LN-02

Stantec 6110 FROST PLACE, LAUREL, MARYLAND 20707 (301) 982-2800

PROFESSIONAL CERTIFICATION: I HEREBY CERTIFY THAT THESE DOCUMENTS WERE PREPARED OR APPROVED BY ME, AND THAT I AM A DULY LICENSED PROFESSIONAL ENGINEER UNDER THE LAWS OF THE STATE OF MARYLAND. LICENSE NO: 3199 EXPIRATION DATE: 05/07/2023



					RECOMMENDED FOR APPROVAL
-	NO.	REVISION	DATE	ВҮ	SEE TITLE SHEET FOR SIGNATURES
=					Chief, Design Section
Ξ					APPROVED
111/					SEE TITLE SHEET FOR SIGNATURES Chief, Division of Transportation Engineering
					, , ,
					Designed by : Drawn by :


WHITE FLINT METRO STATION MONTGOMERY COUNTY DEPARTMENT OF TRANSPORTATION ACCESS IMPROVEMENTS DIVISION OF TRANSPORTATION ENGINEERING GAITHERSBURG, MARYLAND

Checked by :

LANDSCAPE NOTES & DETAILS

SCALE : 1" = 30"DATE: NOV 2021

Project No. : 502106 SHEET 09 of 28

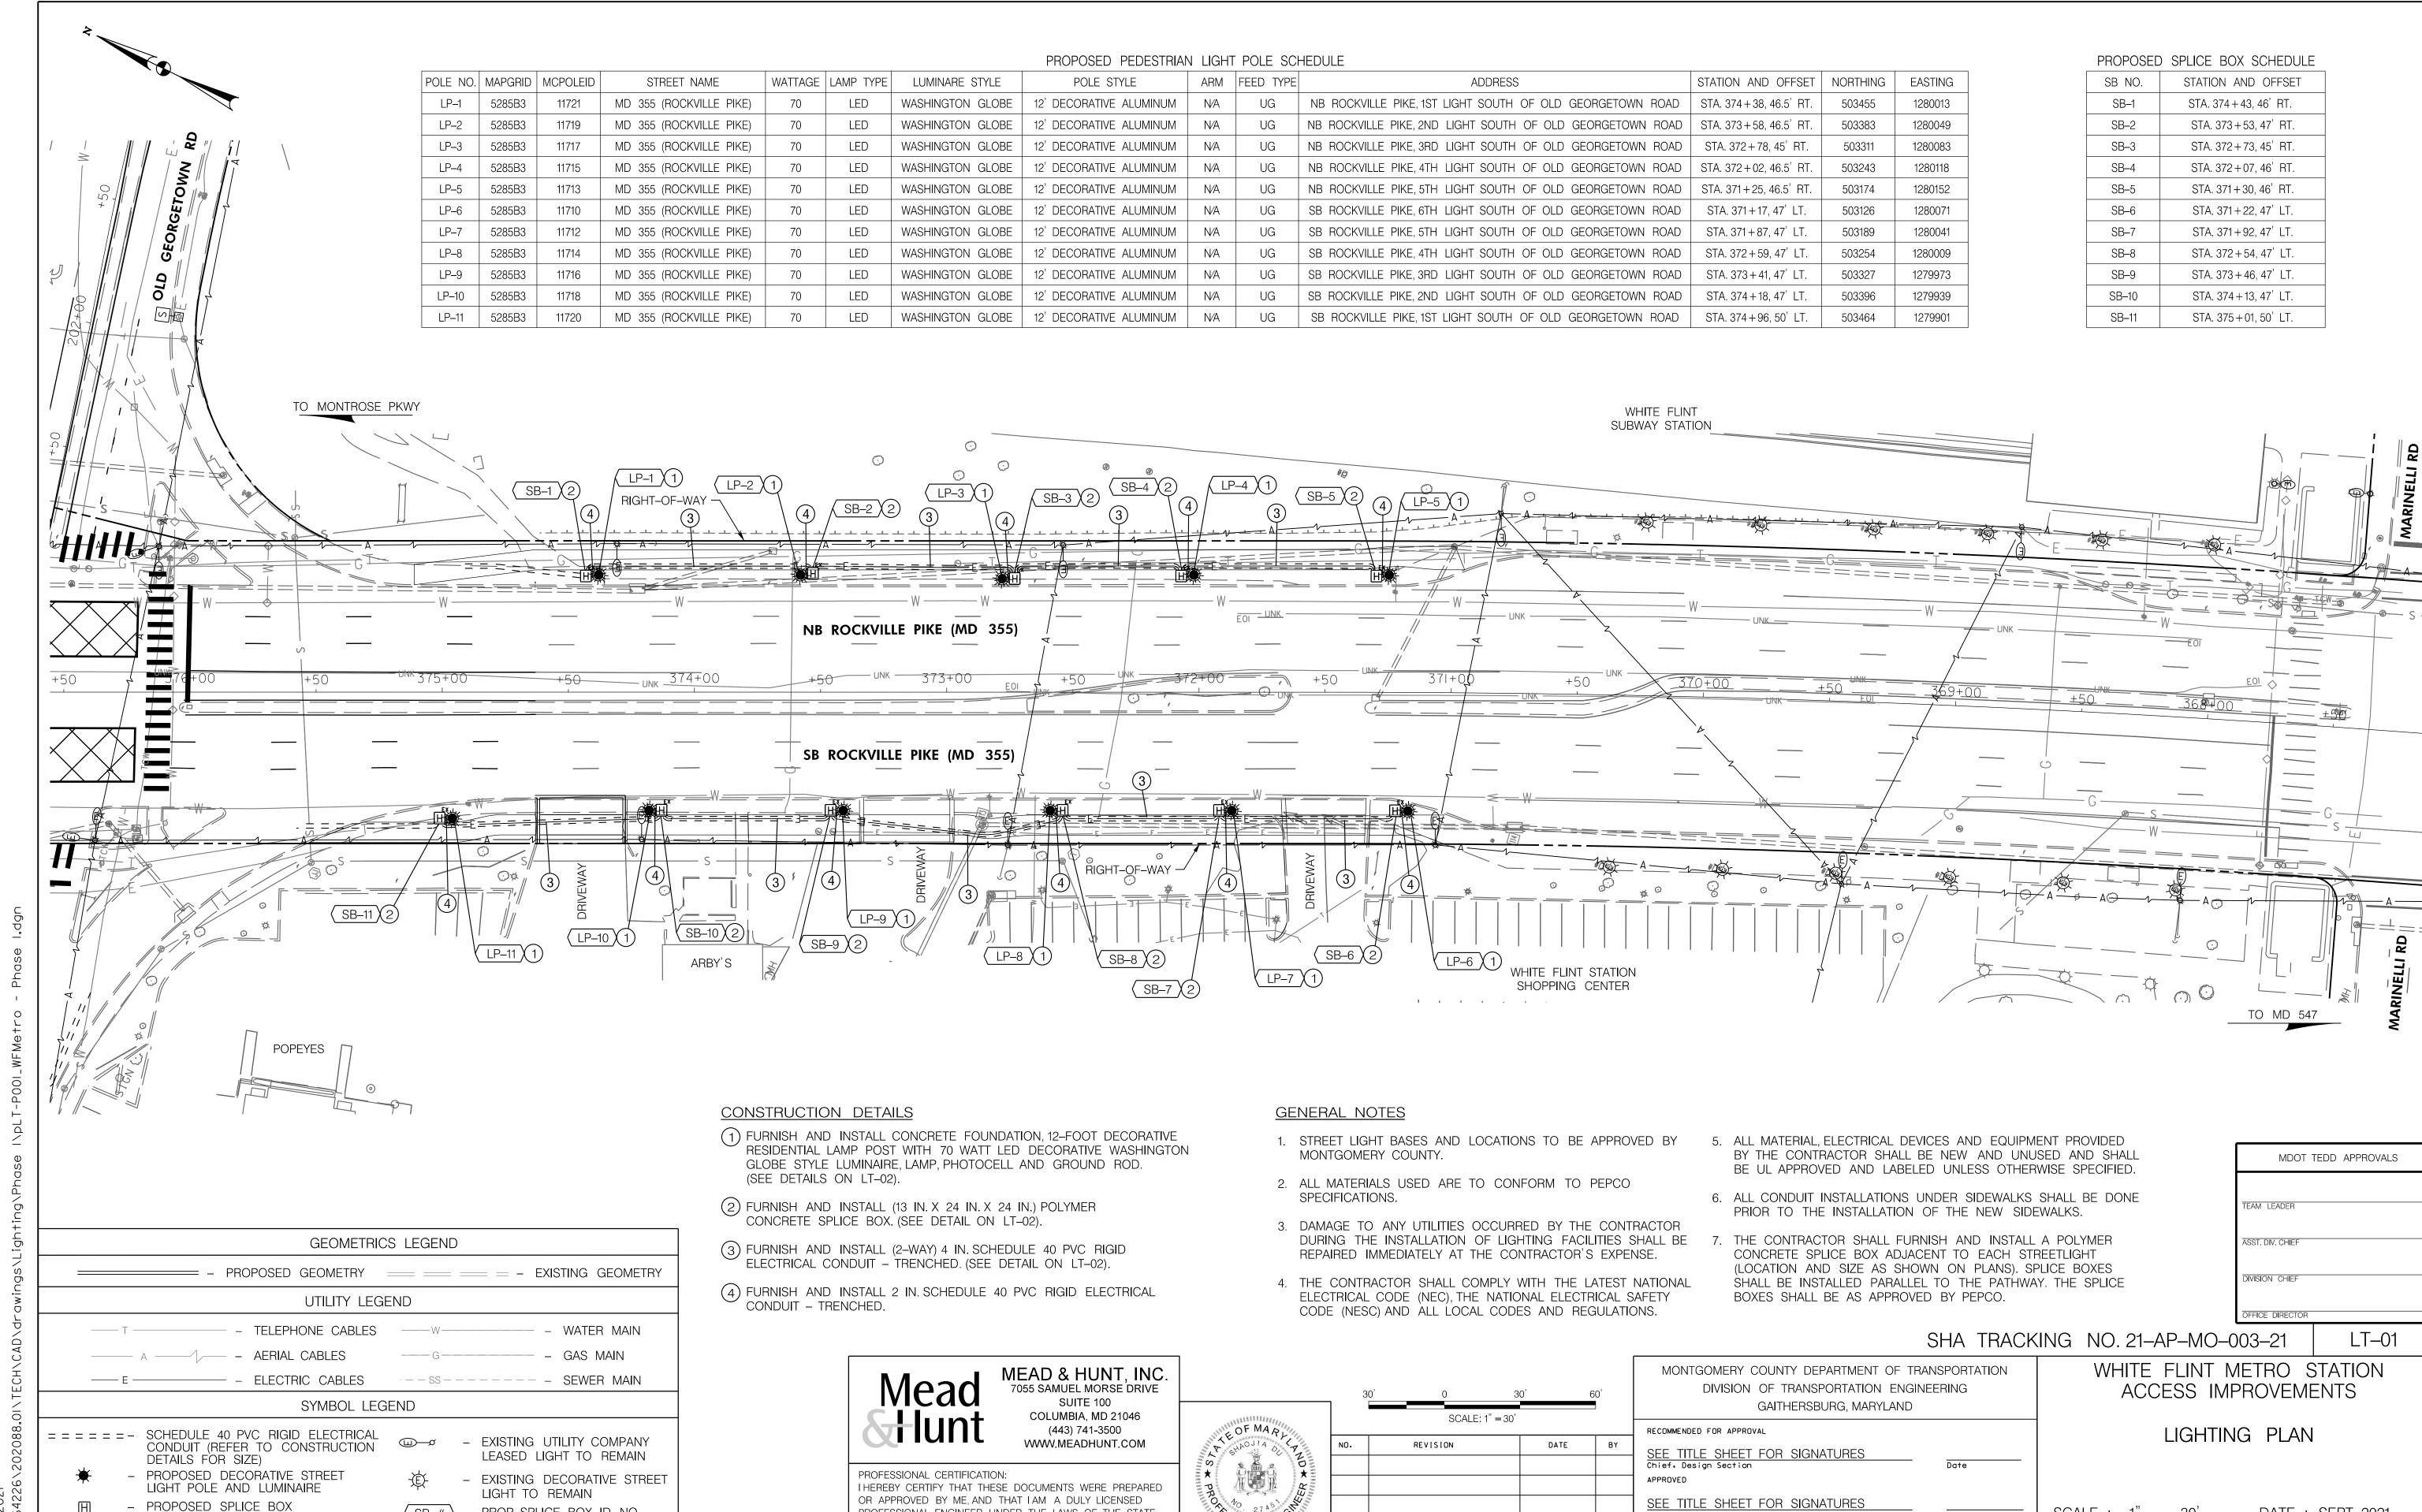

SONAL EN

Date: 2021:09:24 18:44:49-04'00' Digitally signed by Shaojia Du

PROFESSIONAL ENGINEER UNDER THE LAWS OF THE STATE

LICENSE NO: 27451 EXPIRATION DATE: 1/23/2022

OF MARYLAND.

SCALE : 1" = 30"

Project No. : 502106

Checked by :

Chief, Division of Transportation Engineering

Drawn by :__

Designed by :____

DATE: SEPT 2021

SHEET 10 of 28

12/17/2021

- PROP. SPLICE BOX ID NO.

- PROP. LIGHT POLE ID NO.

SB-#


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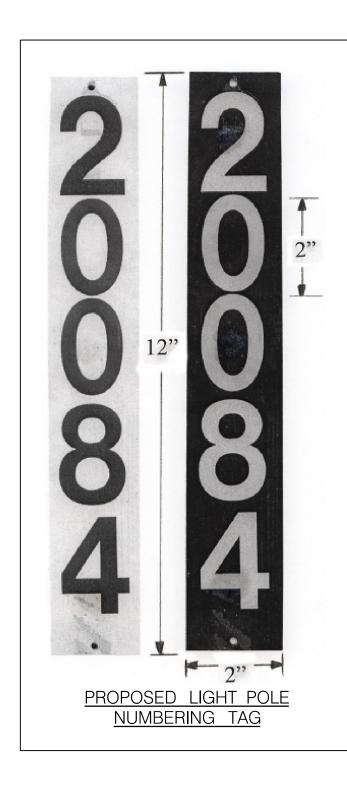
EXISTING STREET LIGHT TO


REMAIN

STREETLIGHT CONDUIT INSTALLATION CHECKLIST


- 1. 2-WAY FOUR INCH (4"), SCHEDULE 40, PVC CONDUIT TO BE INSTALLED BY THE CONTRACTOR CONNECTING EACH SPLICEBOX IN A CONTINUOUS RUN.
- 2. TWO INCH (2"), SCHEDULE 40, PVC CONDUIT TO BE INSTALLED BY THE CONTRACTOR CONNECTING THE SPLICEBOX TO THE STREET LIGHT FOOTING.
- 3. CONTRACTOR TO PROVIDE AND INSTALL PHOTOCELLS FOR EACH STREET LIGHT LUMINAIRE.
- 4. STREETLIGHT AND POST ERECTED BY THE CONTRACTOR ARE TO BE WIRED WITH #10 AWG (MIN.) COPPER WITH A THREE FOOT MINIMUM LOOP OF SLACK IN THE SPLICEBOX FOR ATTACHMENT BY PEPCO.
- 5. STREETLIGHT POSTS ARE TO HAVE A GROUNDING LUG ATTACHED TO THE BASE OF THE POST WITH A MINIMUM THREE FOOT LOOP OF SLACK IN THE SPLICEBOX OF #6 AWG BARE COPPER WIRE ATTACHED.
- 6. ALL SWEEPBENDS TO BE MINIMUM OF 24 INCHES RADIUS.
- 7. 1/4" NYLON PULL-LINES IS TO BE INSTALLED IN EACH CONDUIT DUCT.
- 8. CONTRACTOR TO INSTALL MARKING TAPE ONE FOOT (1") ABOVE EACH CONDUIT
- 9. NO MORE THAN 180 DEGREES OF BENDS IN A CONDUIT RUN.
- 10. CONDUIT IS TO HAVE THREE (3) FEET (MINIMUM) OF COVER OVER IT.
- 11. INSTALLATION OF ALL UNDERGROUND LIGHTING FACILITIES ARE ALSO SUBJECT TO PEPCO INSPECTION AND WRITTEN APPROVAL BEFORE CONCEALMENT. FAILURE TO OBTAIN SUCH INSPECTION WILL RESULT IN THE UNCOVERING OF FACILITIES AT THE CONTRACTOR'S EXPENSE. CALL (202) 388-2137 7:00 TO 9:00 AM OR 3:00 TO 4:00 PM TWO WORKING DAYS IN ADVANCE TO ARRANGE INSPECTION.
- 12. ALL STREETLIGHT EQUIPMENT AND MATERIALS SHALL BE SUBMITTED TO MONTGOMERY COUNTY FOR APPROVAL PRIOR TO BEING INSTALLED ON THE PROJECT. SEE SPECIAL PROVISIONS FOR STREETLIGHT SPECIFICATIONS.
- 13. ALL STREETLIGHTS SHALL BE INSTALLED 2'-6" BEHIND THE FACE OF THE CURB (EXCEPT AS NOTED ON PLANS).
- 14. CONTRACTOR SHALL SUBMIT SHOP DRAWINGS / CATALOG CUTS FOR ALL LIGHTING EQUIPMENT TO MONTGOMERY COUNTY TRAFFIC OPERATIONS DIVISION FOR APPROVAL PRIOR TO INSTALLATION.




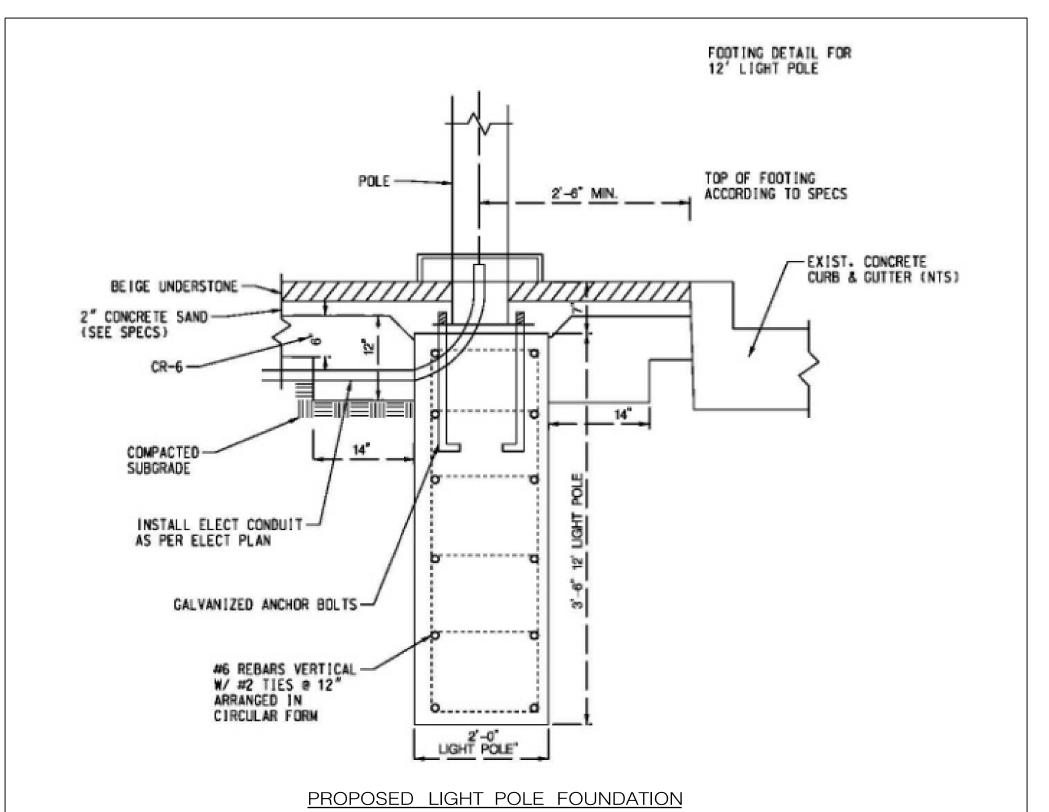

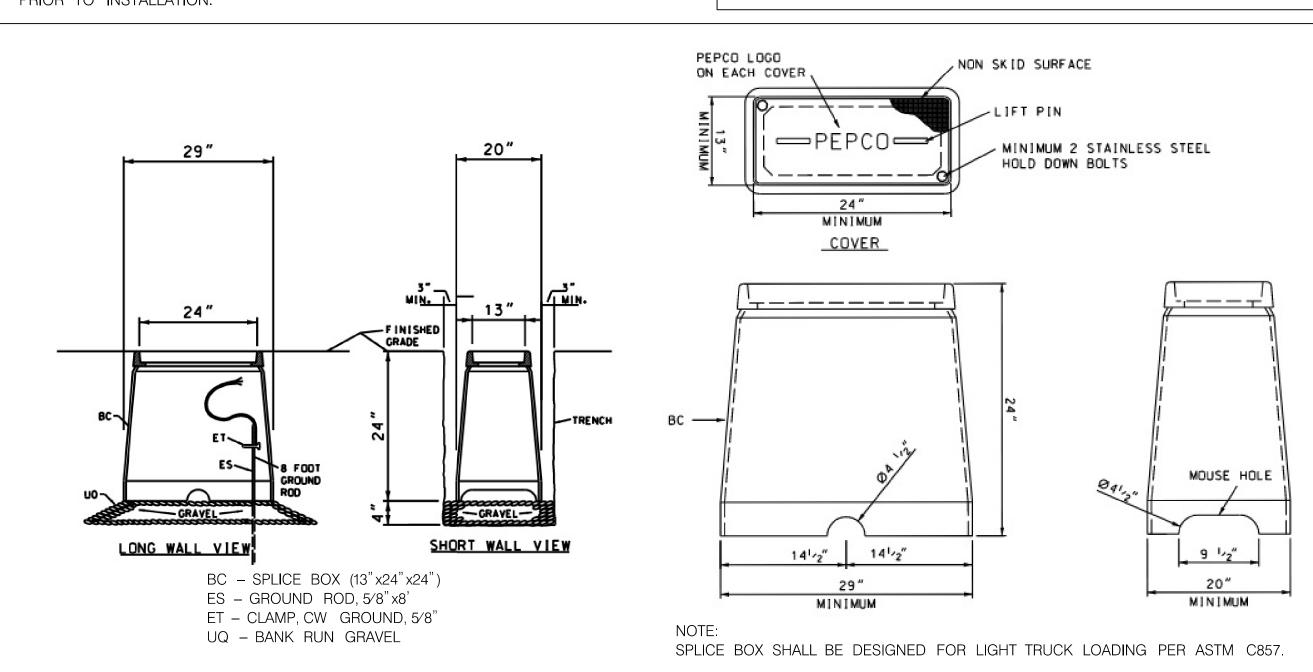

PROPOSED (13"x24"x24") STREETLIGHT SPLICE BOX

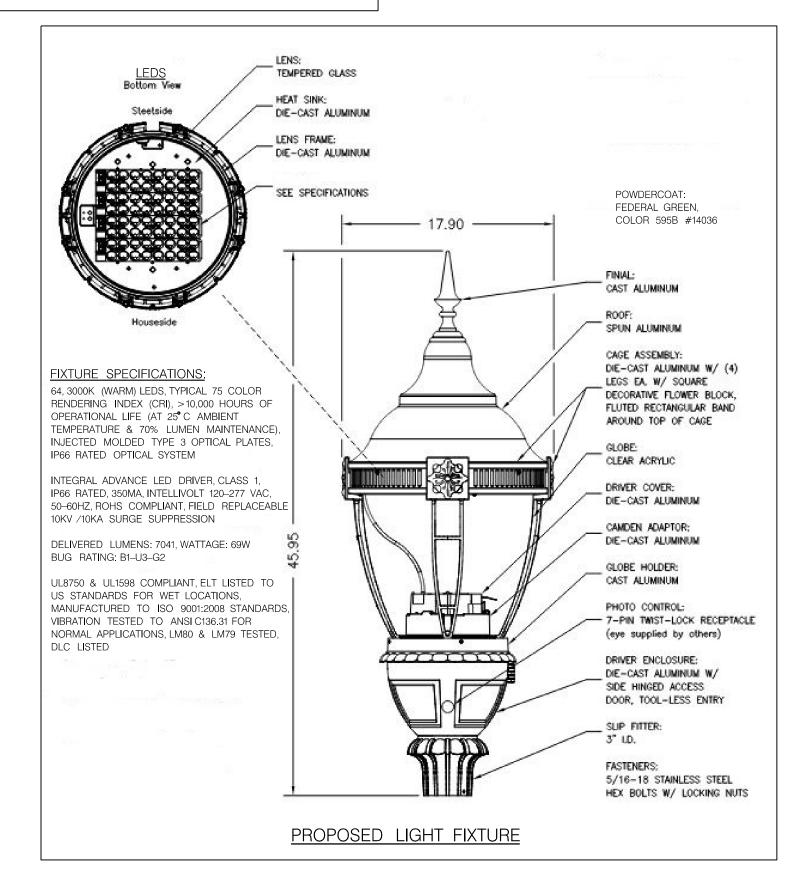

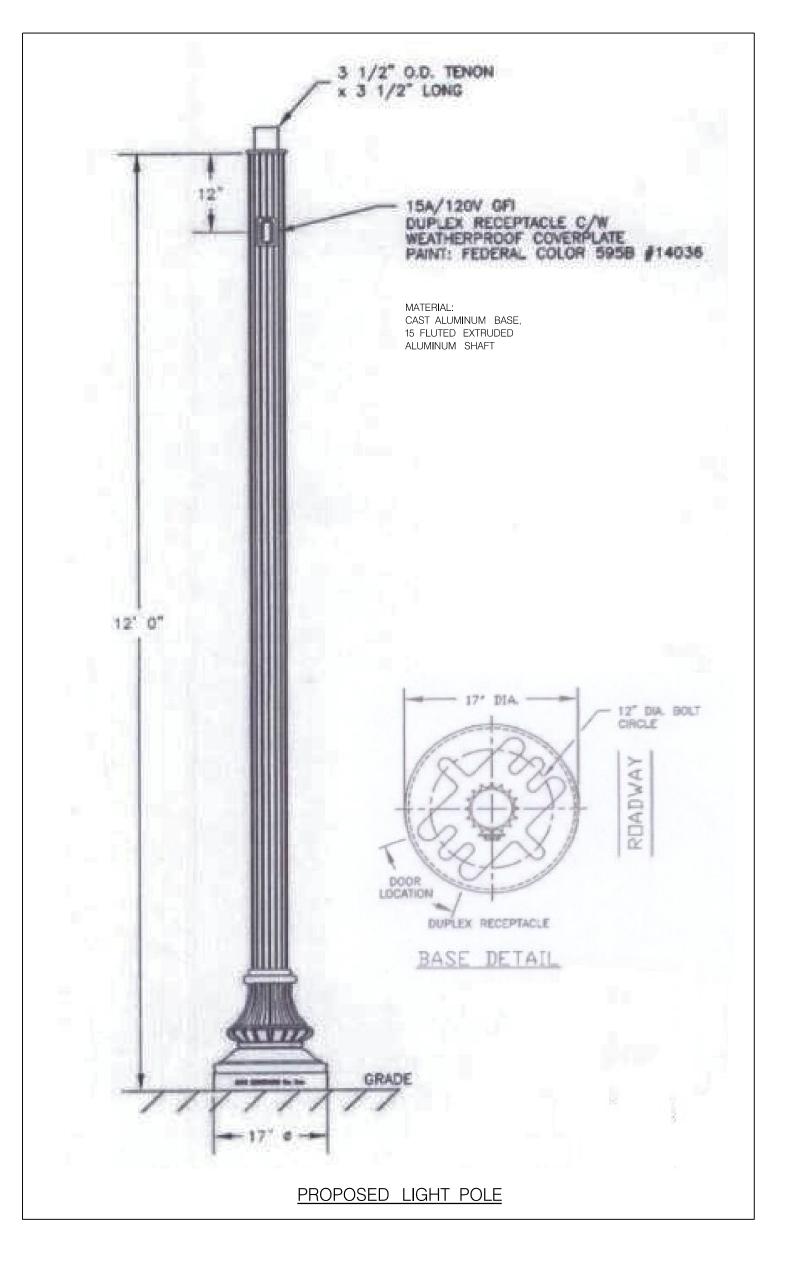

NOTES:

- 4" CONDUITS

1. THE CONTRACTOR SHALL TERMINATE THE CONDUITS WITH COUPLINGS AND PLUGS.

2. ONLY STANDARD WEIGHT READY MIX CONCRETE WILL BE APPROVED FOR ENCASEMENT.

3. NO METALLIC MATERIALS (REBARS, HOLD DOWN WIRES, ETC.) SHALL BE PERMITTED IN SPACES BETWEEN LOW VOLTAGE DUCTS.

4. PEPCO CONDUIT INSPECTOR SHOULD BE CONTACTED 48 HOURS (2 WORK DAYS) PRIOR TO ENCASEMENT OF CONDUIT FOR SCHEDULING TRANSMISSION AND DISTRIBUTION CONSTRUCTION INSPECTION AND APPROVAL.

CONCRETE ENCASED CONDUIT DUCT LINE CONFIGURATION



MEAD & HUNT, INC. 7055 SAMUEL MORSE DRIVE SUITE 100 COLUMBIA, MD 21046 (443) 741-3500 WWW.MEADHUNT.COM

PROFESSIONAL CERTIFICATION: I HEREBY CERTIFY THAT THESE DOCUMENTS WERE PREPARED OR APPROVED BY ME, AND THAT I AM A DULY LICENSED PROFESSIONAL ENGINEER UNDER THE LAWS OF THE STATE OF MARYLAND. LICENSE NO: ____27451 EXPIRATION DATE: 1/23/2022



]				GAITHERSBURG, MARYLAND	
NO.	REVISION	DATE	ВҮ	RECOMMENDED FOR APPROVAL	
				SEE TITLE SHEET FOR SIGNATURES Chief, Design Section APPROVED	Date
				SEE TITLE SHEET FOR SIGNATURES Chief, Division of Transportation Engineering	Date
				Designed by : Drawn by :	Checked by :

MONTGOMERY COUNTY DEPARTMENT OF TRANSPORTATION

DIVISION OF TRANSPORTATION ENGINEERING

SHA TRACKING NO. 21-AP-MO-003-21

LT-02

WHITE FLINT METRO STATION ACCESS IMPROVEMENTS

LIGHTING NOTES AND DETAILS

DATE: SEPT 2021 SCALE : NONE

SHEET 11 of 28

2W(V)

Project No. : 502106

I. THE PERMITTEE SHALL REFER TO THE ATTACHED TEMPORARY TRAFFIC CONTROL PLAN (TTCP) DRAWINGS. WORK ZONE SITUATIONS WHICH ARE NOT ADDRESSED IN THE ATTACHED TTCP SHALL CONFORM TO THE GUIDELINES SET FORTH IN SECTION 6 OF THE 2011 "MARYLAND MANUAL ON UNIFORM TRAFFIC CONTROL DEVICES FOR STREETS AND HIGHWAYS" (MDMUTCD), MOST RECENT EDITION.

2. THE PERMITTEE MUST HAVE A CERTIFIED TRAFFIC CONTROL MANAGER ON SITE DURING ALL PHASES OF INSPECTION AND CONSTRUCTION AT ALL TIMES.

3. EACH PHASE OF INSPECTION AND CONSTRUCTION, INCLUDING THE FOLLOW UP RESTORATION OPERATIONS, SHALL BE PROVIDED WITH APPROPRIATE WORK ZONE TRAFFIC CONTROLS.

4. ANY WORK WITHIN THE TRAVELED PORTION OF ROADWAYS SHALL BE RESTRICTED TO THE HOURS LISTED IN THE SPECIFICATIONS, MONDAY THROUGH FRIDAY. WORK ON HOLIDAYS AND WEEKENDS SHALL NOT OCCUR UNLESS AN EXEMPTION IS GRANTED IN WRITING BY THE COUNTY'S INSPECTOR.

5. CONSTRUCTION ACTIVITY. LOADING OR UNLOADING OF EQUIPMENT SHALL NOT BLOCK ANY TRAFFIC LANE OTHER THAN THOSE DELINEATED WITHIN THE WORK ZONE.

6. EXCLUSIVE OF EMERGENCY WORK, THE PERMITTEE SHALL CONTACT OCCUPANTS OF ALL ADJOINING PROPERTIES AND INFORM THEM OF THE SCOPE AND THE TIMING OF CONSTRUCTION. A MINIMUM OF 24 HOURS NOTIFICATION SHALL BE REQUIRED PRIOR TO THE COMMENCEMENT OF ANY ACTIVITY ON THE SITE.

7. ACCESS SHALL BE MAINTAINED TO ALL DRIVEWAYS UNLESS PERMISSION FOR CLOSURE IS GRANTED BY THE PROPERTY OWNER/MANAGER. HOWEVER, ACCESSIBILITY FOR EMERGENCY VEHICLES SHALL BE MAINTAINED AT ALL TIMES.

8. ALL TEMPORARY TRAFFIC CONTROL DEVICES SHALL CONFORM TO THE MOST RECENT EDITION OF THE 2011 MDMUTCD. ALL SIGNS, TRAFFIC DRUMS AND CONES SHALL BE FULLY REFLECTORIZED WITH HIGH INTENSITY, REFLECTIVE SHEETING AS PER THE MUTCD. TEMPORARY SIGNS SHALL BE FLUORESCENT ORANGE.

9. ALL WARNING SIGNS, UNLESS OTHERWISE SPECIFIED, SHALL BE A MINIMUM OF 48" X 48", BLACK SYMBOL OR LEGEND ON FLUORESCENT ORANGE BACKGROUND AND DIAMOND SHAPED.ALL WARNING SIGNS NOT APPLICABLE TO THE ACTUAL SITUATION SHALL BE REMOVED OR COVERED DURING NON-APPLICABLE PERIODS. ALL PORTABLE SIGNS SHALL BE MOUNTED A MINIMUM OF ONE (1) FOOT ABOVE THE LEVEL OF THE ROADWAY, WITH HIGHER MOUNTING HEIGHTS DESIRABLE.

IO.IF ANY TEMPORARY TRAFFIC CONTROL SIGNS ARE TO BE PLACED ALONG A MDOT SHA ROADWAY OR WITHIN THE LIMITS OF AN INCORPORATED AREA, THE PERMITTEE SHALL NOTIFY THE APPROPRIATE AGENCY OF SIGNAGE TO BE INSTALLED.

II.DURING NIGHTTIME OPERATIONS REFLECTORIZED TRAFFIC DRUMS SHALL BE USED.HOWEVER, FOR EMERGENCY WORK ACTIVITIES WHERE TRAFFIC DRUMS ARE NOT AVAILABLE, REFLECTORIZED TRAFFIC CONES THAT ARE A MINIMUM OF TWENTY EIGHT (28) INCHES IN HEIGHT AND HAVING SIX (6) INCH AND FOUR (4) INCH REFLECTIVE COLLARS WITHIN THE TOP SIXTEEN (16) INCHES OF THE CONE MAY BE USED. ALL WORK AREAS LEFT UNATTENDED AT NIGHT SHALL BE DELINEATED WITH REFLECTORIZED TRAFFIC DRUMS.

12. THE PERMITEE SHALL OBTAIN A TEMPORARY NOISE WAIVER FROM THE MONTGOMERY COUNTY DEPARTMENT OF ENVIRONMENTAL PROTECTION FOR ALL NIGHTTIME CONSTRUCTION ACTIVITIES.

SEQUENCE OF CONSTRUCTION FOR MAINTENANCE OF TRAFFIC

PHASE I

- I. INSTALL MAINTENANCE OF TRAFFIC CONTROL DEVICES FOR PHASE I, (SB MD 355).
- 2. CONSTRUCT TEMPORARY DRIVEWAY FOR WHITE FLINT STATION SHOPPING CENTER.
- 3. SHIFT TRAFFIC TO TEMPORARY DRIVEWAY.
- 4. CONSTRUCT SB MD 355 FROM STA 371+54 TO 370+93.
- 5. SHIFT TRAFFIC TO NEW DRIVEWAY.
- 6. CONSTRUCT SOUTHBOUND MD 355 FROM 375+52 TO 371+54.

PHASE 2

- I. INSTALL MAINTENANCE OF TRAFFIC CONTROL DEVICES FOR PHASE 2.
- 2. CONSTRUCT NORTHBOUND MD 355.

PROFESSIONAL CERTIFICATION:

PROFESSIONAL ENGINEER UNDER THE LAWS OF THE STATE OF MARYLAND,

LICENSE NO: ____17172 ____ EXPIRATION DATE: __12-_12-_2022

S/ONAL ENC

INSPECTOR AUTHORITY

I. THE COUNTY'S DEPARTMENT OF PERMITTING SERVICES (DPS) INSPECTOR HAS THE AUTHORITY TO MODIFY THE TTCP AS DEEMED NECESSARY. THE INSPECTOR HAS THE AUTHORITY TO ORDER THE PERMITTEE TO STOP WORK AND VACATE THE PUBLIC RIGHT-OF-WAY IF THE TTCP IS NOT COMPLIED WITH.

2. THE IMPLEMENTATION DATE AND CONTINUANCE OF WORK ACTIVITIES MAY BE ALTERED AT THE DISCRETION OF THE COUNTY'S INSPECTOR IN THE EVENT OF CONFLICTS WITH PREVIOUSLY APPROVED OR EMERGENCY ACTIVITIES.

<u>MISCELLANEOUS</u>

I. THE PERMITTEE WILL BE SOLELY RESPONSIBLE FOR ALL ACCIDENTS AND/OR DAMAGE TO PERSONS AND/OR PROPERTY DAMAGE RESULTING FROM HIS OPERATIONS.

2. HAZARDOUS MATERIALS SHALL NOT BE STORED WITHIN PUBLIC RIGHT-OF-WAY. NO MATERIALS OR EQUIPMENT SHALL BE STORED ON THE ROADWAY SURFACE OR SIDEWALK DURING NON-WORK PERIODS. ALL STORED MATERIALS AND EQUIPMENT SHALL BE SET BACK AT LEAST SIX (6) FEET BEHIND THE CURB ALONG A CLOSED SECTION ROADWAY AND AT LEAST TWELVE (12) FEET FROM THE EDGE OF AN OPEN SECTION ROADWAY.

3. ALL TEMPORARY TRAFFIC CONTROL (TTC) DEVICES SHALL BE REMOVED AS SOON AS PRACTICAL WHEN THEY ARE NO LONGER NEEDED. WHEN WORK IS SUSPENDED FOR SHORT PERIODS OF TIME, TTC DEVICES THAT ARE NO LONGER APPROPRIATE SHALL BE REMOVED OR COVERED.

4. AT THE COMPLETION OF WORK ACTIVITIES, CONDITIONS WITHIN THE PUBLIC SPACE SHALL BE FULLY RESTORED TO THOSE THAT EXISTED PRIOR TO THE WORK ACTIVITY.

CONTACT INFORMATION

I.THE CONTRACTOR SHALL ARRANGE AND HOST A PRE-PHASE TRAFFIC SWITCH MEETING AT LEAST TWO WEEKS PRIOR TO SWITCHING TRAFFIC. THE FOLLOWING OFFICES SHALL BE NOTIFIED OF THIS MEETING AND OF THE IMPENDING TRAFFIC SWITCH:

- * MONTGOMERY COUNTY DIVISION OF TRAFFIC ENGINEERING AND OPERATIONS AT 240-777-6000
- * MONTGOMERY COUNTY TRANSPORTATION SYSTEMS ENGINEEERING TEAM AT 240-777-2100
- * MONTGOMERY COUNTY TRANSIT AT 240-777-5800
- * MONTGOMERY COUNTY PUBLIC SCHOOLS, LOCAL DEPOT MANAGER
- * MONTGOMERY COUNTY FIRE AND RESCUE, LOCAL FIRE DEPARTMENT CAPTAIN
- * MONTGOMERY COUNTY POLICE, LOCAL TRAFFIC SERGEANT
- * MONTGOMERY COUNTY DEPARTMENT OF PERMITTING SERVICES, PERMIT INSPECTION SECTION AT 240-777-6300

2. PRIOR TO ROAD CLOSURES, THE CONTRACTOR SHALL NOTIFY THE FOLLOWING OFFICES A MINIMUM OF SEVENTY-TWO (72) HOURS IN ADVANCE:

- * MONTGOMERY COUNTY DIVISION OF TRAFFIC ENGINEERING AND OPERATIONS AT 240-777-6000
- * MONTGOMERY COUNTY EMERGENCY OPERATIONS CENTER AT 240-777-0751
- * MONTGOMERY COUNTY POLICE, LOCAL TRAFFIC SERGEANT
- * MONTGOMERY COUNTY TRANSPORTATION MANAGEMENT CENTER AT 240-777-2100
- * MONTGOMERY COUNTY FIRE AND RESCUE, LOCAL FIRE DEPARTMENT CAPTAIN
- * MONTGOMERY COUNTY PUBLIC SCHOOLS, LOCAL DEPOT MANAGER

3. FIELD ASSISTANCE BY THE MCDOT, DIVISION OF TRAFFIC ENGINEERING AND OPERATIONS IS AVAILABLE UPON REQUEST. CONTACT TRAFFIC ENGINEERING & OPERATIONS SECTION AT 240-777-6000.

MONTGOMERY COUNTY DEPARTMENT OF TRANSPORTATION

Drawn by: WH

Checked by :

SHA TRACKING NO. 21-AP-MO-003-21

MT - 01

DIVISION OF TRANSPORTATION ENGINEERING GAITHERSBURG, MARYLAND RECOMMENDED FOR APPROVAL REVISION DATE SEE TITLE SHEET FOR SIGNATURES Chief, Design Section APPROVED SEE TITLE SHEET FOR SIGNATURES
Chief, Division of Transportation Engineering

Designed by : RJM

ACCESS IMPROVEMENTS MAINTENANCE OF TRAFFIC PLAN GENERAL NOTES


WHITE FLINT METRO STATION

SCALE : 1" = 30"DATE: SEPT 2021

SHEET 12 of 28 Project No. : 502106



THEREBY CERTIFY THAT THESE DOCUMENTS WERE PREPARED OR APPROVED BY ME, AND THAT I AM A DULY LICENSED

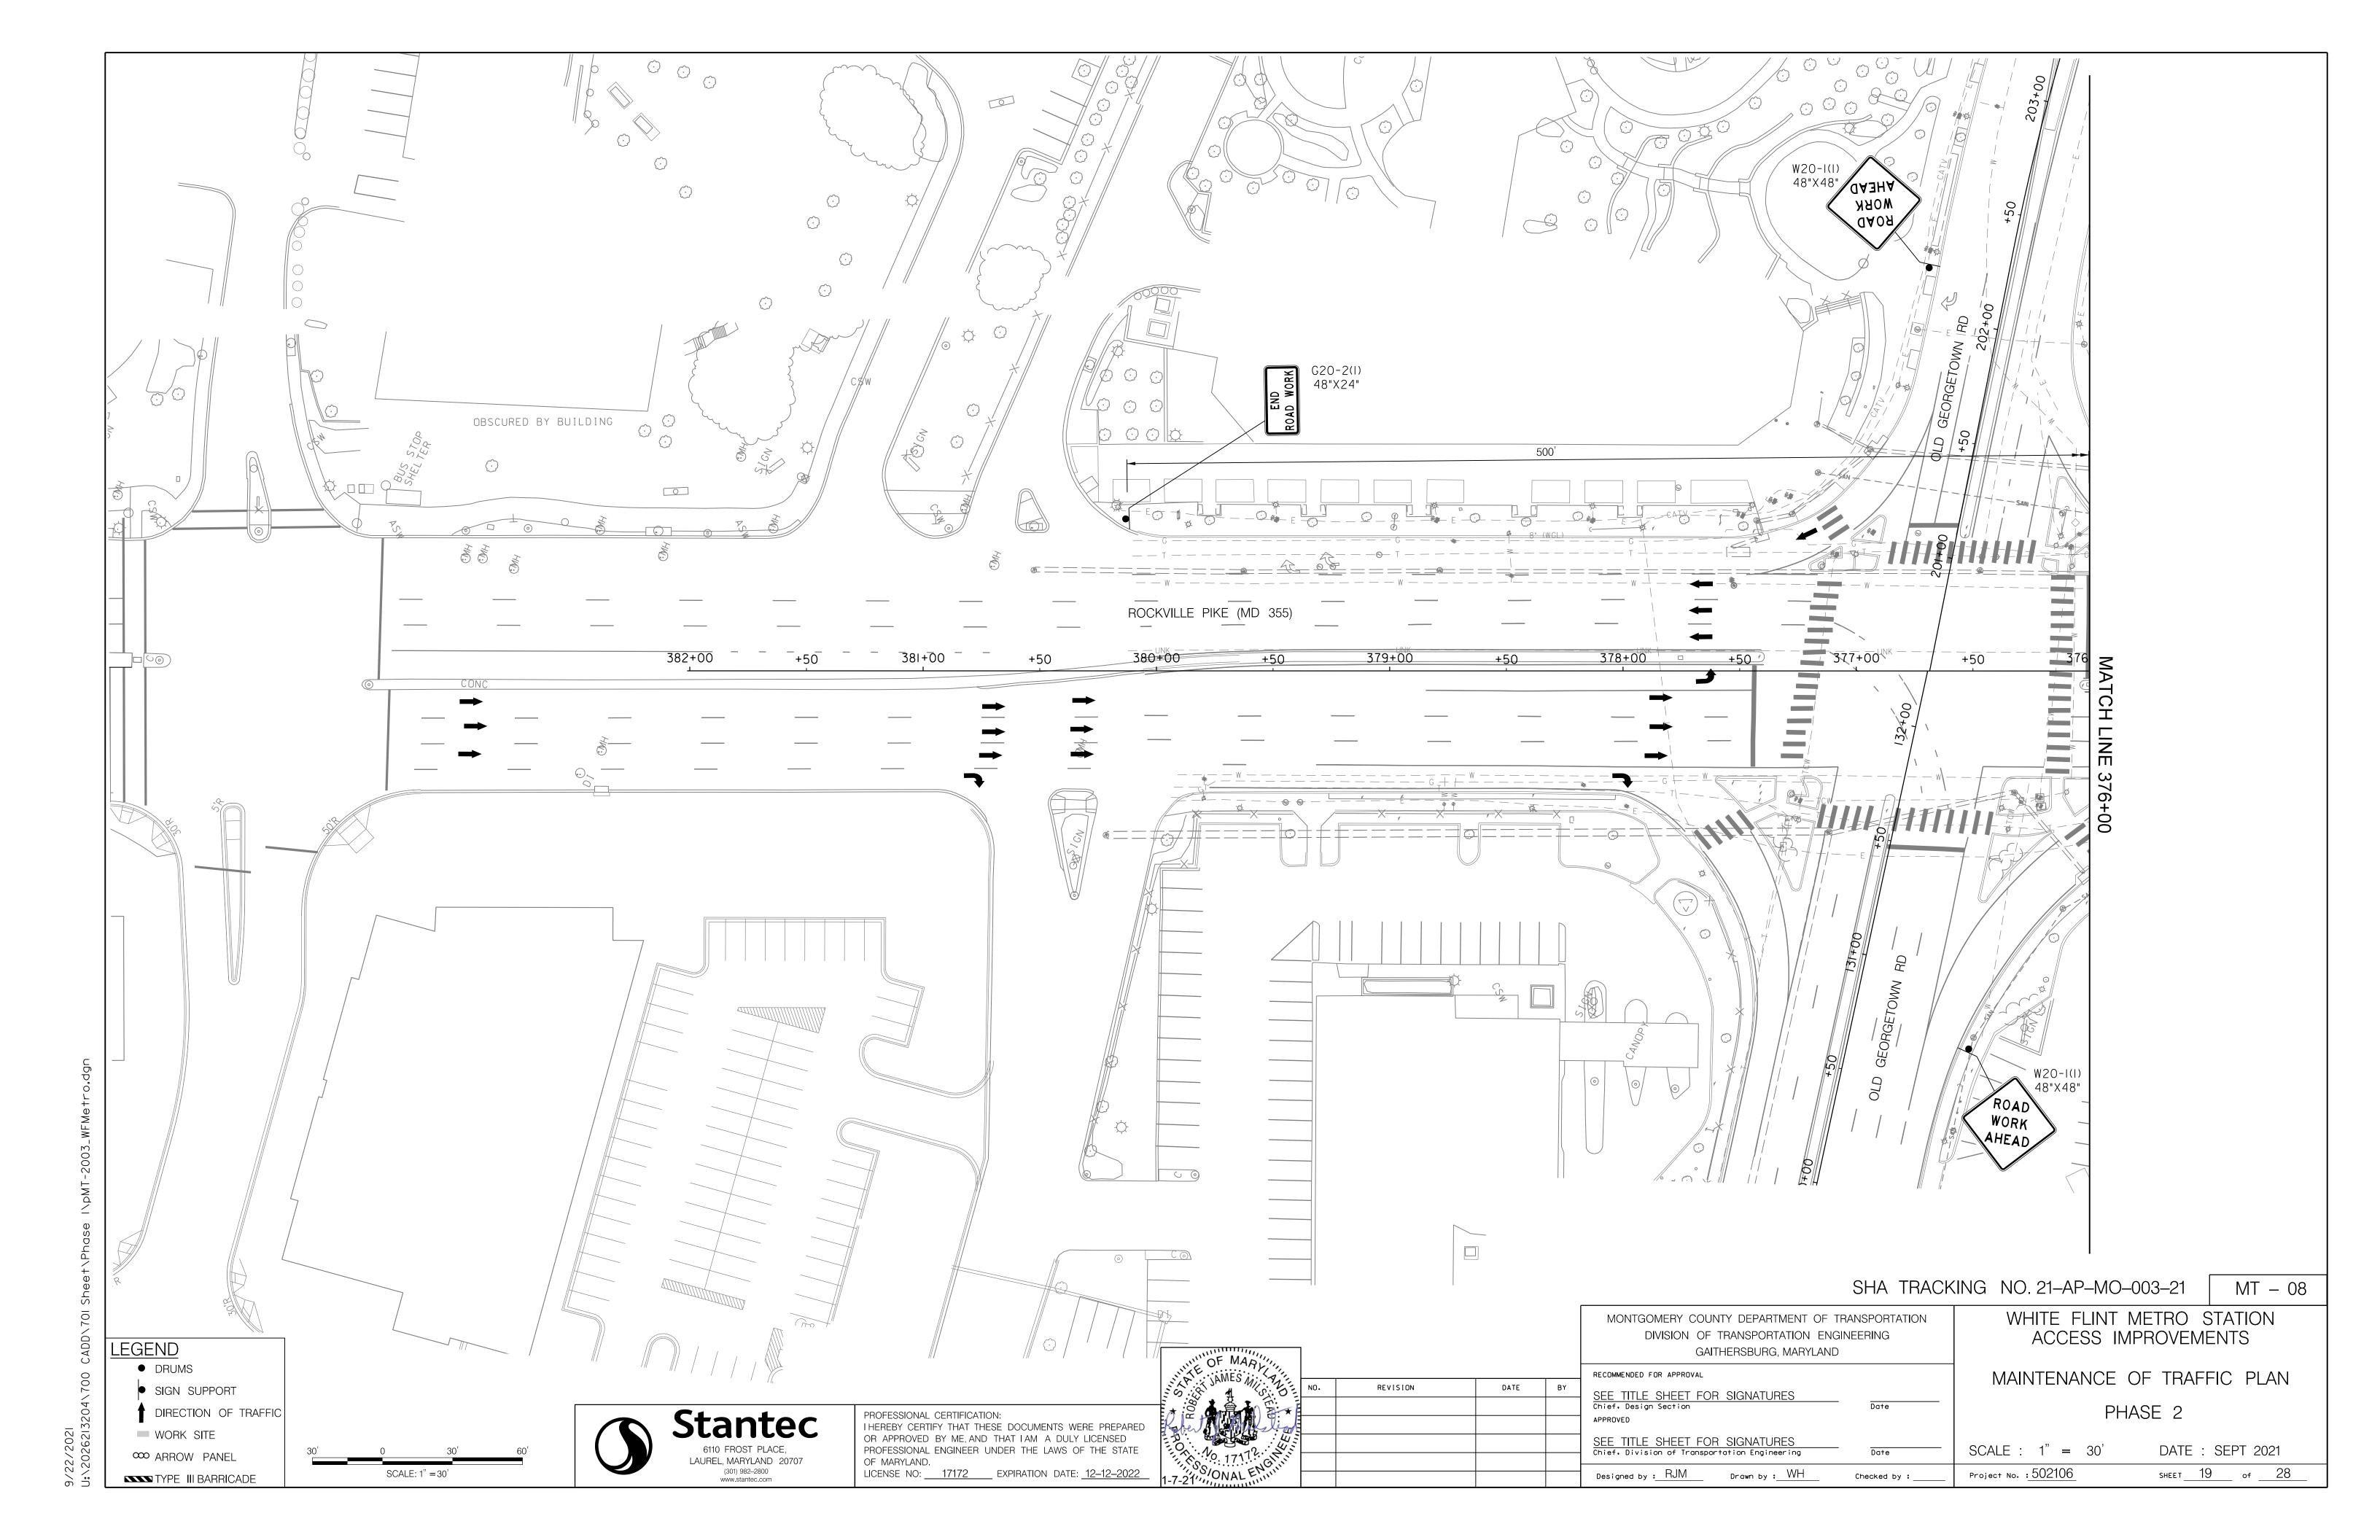

CRITERIA

THE CONTRACTOR SHALL BE GOVERNED BY THE STANDARDS AND REQUIREMENTS OF THE FOLLOWING PUBLICATIONS. EXCEPT AS MODIFIED BY THE SPECIAL PROVISIONS OF THIS CONTRACT:

<u>DESIGN</u>

MDSHA - "MARYLAND MANUAL ON UNIFORM TRAFFIC CONTROL DEVICES", 2011 EDITION AND SUBSEQUENT REVISIONS. (MdMUTCD)

A A S H T O - "HIGHWAY SAFETY DESIGN AND OPERATIONS GUIDE" -1997

A A S H T O - "STANDARD SPECIFICATIONS FOR STRUCTURAL SUPPORTS FOR HIGHWAY SIGNS LUMINAIRES AND TRAFFIC SIGNALS". 2001 EDITION (CATEGORY II FOR ALL OVERHEAD AND CANTILEVER SIGN STRUCTURES).

MATERIALS AND CONSTRUCTION

MDSHA - "STANDARD SPECIFICATIONS FOR CONSTRUCTION & MATERIALS", 2008 EDITION AND SUBSEQUENT SUPPLEMENTS.

DESIGN WIND

100 MPH - WOOD SUPPORTS IO YEAR RECURRENCE INTERVAL

100 MPH - GROUND MOUNT SIGN STEEL SUPPORTS IO YEAR RECURRENCE INTERVAL

100 MPH - OVERHEAD AND CANTILEVER STRUCTURES 50 YEAR RECURRENCE INTERVAL

DESIGN STRESS

SOIL BEARING PRESSURE - S = 3,000 P.S.F. (ASSUMED) SEE MATERIAL & CONSTRUCTION ABOVE AND SPECIAL PROVISIONS FOR DESIGN STRESSES FOR STRUCTURAL STEEL, ALUMINUM, REINFORCING STEEL AND CONCRETE.

CHAMFER

ALL EXPOSED EDGES OF CONCRETE SHALL HAVE A 3/4" X 3/4" CHAMFER.

CLASSIFICATION OF SIGNS

SIGNS ARE DIVIDED INTO TWO (2) GENERAL CATEGORIES.

I. GUIDE SIGNS

A) STRUCTURAL TYPES

OH - OVERHEAD C - CANTILEVER

GM - GROUND MOUNT, BREAKAWAY

OR NON-BREAKWAY BM - BRIDGE MOUNTED

I) HIGH INTENSITY (NEW SIGNS AND

B) PANELS

ALL DISTRICTS

2. STANDARD SIGNS (REGULATORY, WARNING, ETC.)

B) PANELS

MATERIAL - SHEET ALUMINUM COPY - DIRECT APPLIED

MATERIAL - EXTRUDED ALUMINUM

REVISIONS TO EXISTING SIGNS)

COPY - DIRECT APPLIED

IDENTIFICATION OF SIGNS AND PANELS

A) STRUCTURAL TYPES

SQUARE TUBE

WOOD SUPPORTS

EACH GUIDE SIGN IS IDENTIFIED BY A SIGN NUMBER ON THE PLANS AND IN THE TABULATIONS.(GM-I, GM-2, GM-3, etc)

SIGNS ON STRUCTURES ARE IDENTIFIED WITH A NUMBER AND WHERE VARIATIONS OCCUR. A LOWER CASE LETTER, (OH-Ig, OH-Ib, OH-Ic)

STANDARD SIGNS

STANDARD SIGNS ARE IDENTIFIED BY PANEL NUMBERS AND ARE CLASSIFIED AS FOLLOWS

- R REGULATORY
- W WARNING
- M ROUTE MARKERS AND ACCESSORIES
- D DESTINATION AND MILEAGE PANELS
- S SCHOOL

PANELS SHALL BE DESIGNATED TO AGREE WITH MARYLAND STANDARD SIGN BOOK. EACH STANDARD SIGN IS IDENTIFIED FIRST BY THE SHEET NUMBER. THEN BY THE NUMERICAL ORDER OF THE SIGN AS IT APPEARS ON THE PLAN. FOR EXAMPLE SHEET SN 2.1-101,102,103, ETC. SHEET SN 2.2-201,202,203,ETC.

PANEL LAYOUT AND ALPHABETS


I. GUIDE SIGN PANEL LAYOUTS ARE BASED ON THE A.A.S.H.T.O. MANUALS NOTED ABOVE. 2. STANDARD SIGN PANEL LAYOUTS ARE BASED ON THE MdMUTCD WITH SPECIFICATIONS DETAILED IN THE MARYLAND STATE HIGHWAY ADMINISTRATION PUBLICATION, "STANDARD SIGN BOOK", AVAILABLE ONLINE @ https:/www.marylandroads.com/businesswithsha/ bizStdsSpecs/desManualStdPub/publicationsonline/oots/internet_signbook.asp

REFLECTORIZATION


BACKGROUNDS, BORDERS, TEXTS AND ALL OTHER ELEMENTS OF SIGN PANELS SHALL BE REFLECTORIZED EXCEPT WHERE NOTED. REFER TO PROJECT REQUIREMENTS FOR MORE DETAIL.



PROFESSIONAL CERTIFICATION: HEREBY CERTIFY THAT THESE DOCUMENTS WERE PREPARED OR APPROVED BY ME, AND THAT I AM A DULY LICENSED PROFESSIONAL ENGINEER UNDER THE LAWS OF THE STATE OF MARYLAND. LICENSE NO: <u>17172</u> EXPIRATION DATE: <u>12-12-2022</u>

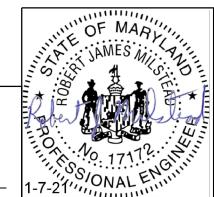

ORIENTATION OF SIGN FACES

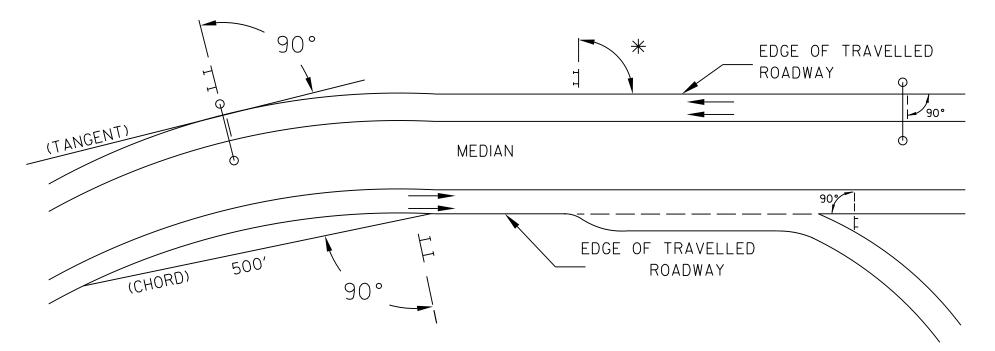

* UNDER 30 FEET FROM TRAVELLED ROADWAY TO NEAR EDGE OF SIGN - 93° AWAY FROM THE ROAD TO AVOID SPECULAR REFLECTION AS INDICATED IN 813.03 OF THE MARYLAND STANDARD SPECIFICATIONS FOR CONSTRUCTION AND MATERIALS.

OVER 30 FEET FROM TRAVELLED ROADWAY TO NEAR EDGE OF SIGN - 90°

SIGN LOCATIONS

I. GUIDE SIGNS ARE LOCATED ON THE PLANS BY DIMENSION TO SURVEY STATIONS. OR WHEN NECESSARY. TO IDENTIFIABLE PHYSICAL FEATURES.

2. ALL CHANGES IN THE LOCATIONS OF SIGNS AS SHOWN ON THE PLAN SHALL HAVE THE PRIOR APPROVAL OF THE ENGINEER.

EXISTING UTILITIES

THE ENGINEER DOES NOT WARRANT OR GUARANTEE THE ACCURACY OR COMPLETENESS OF UTILITY INFORMATION SHOWN ON THE PLAN. IT SHALL BE THE RESPONSIBILITY OF THE CONTRACTOR TO LOCATE AND PROTECT ALL EXISTING FACILITIES WHICH MIGHT BE AFFECTED BY THIS WORK OR HIS OPERATION.

ROADSIDE SIGNS

I. VERTICAL ALIGNMENT

POSITION PANEL SO FACE IS PLUMB.

2. HORIZONTAL ALIGNMENT (SEE DIAGRAM ABOVE)

NORMAL EDGE OF THE MAINLINE ROADWAY.

A) ON STRAIGHT ROADWAY SECTIONS, ANGLE OF SIGN FACE TO ROADWAY VARIES WITH DISTANCE FROM TRAVELLED ROADWAY TO NEAR EDGE OF SIGN - SEE DIAGRAM.

B) ON THE INSIDE OF HORIZONTAL CURVES, POSITION SIGN SO FACE OF PANEL MAKES AN ANGLE OF 90° WITH A CHORD BETWEEN A POINT ON NEAR EDGE OF PAVEMENT AT SIGN LOCATION AND A POINT ON EDGE OF PAVEMENT 500' IN ADVANCE OF SIGN.

C) ON THE OUTSIDE OF HORIZONTAL CURVES, POSITION SIGN SO FACE OF PANEL IS AT RIGHT ANGLES TO THE TANGENT OF THE CURVE AT THE SIGN LOCATION. D) POSITIONING OF SIGNS AT GORES AND RAMP SEPARATIONS IS REFERRED TO THE

OVERHEAD SIGNS

I. VERTICAL ALIGNMENT

POSITION PANELS FOR ALL OVERHEAD STRUCTURES SO THAT PANEL FACE IS PLUMB. 2. OVERHEAD SIGN STRUCTURES SHALL NOT BE ERECTED WITHOUT ATTACHING LUMINAIRES.

SUPPORTS, AND/OR SIGNS.

3. HORIZONTAL ALIGNMENT

A) POSITION ALL OVERHEAD SIGNS SO THAT THE FACE OF THE PANEL IS AT RIGHT ANGLES TO THE NORMAL EDGE OF ROADWAY, IF ON A STRAIGHT ROADWAY SECTION.

B) POSITION ALL OVERHEAD SIGNS SO THAT THE FACE OF THE PANEL IS AT RIGHT ANGLES TO THE TANGENT OF THE CURVE AT SIGN LOCATION, IF ON A HORIZONTAL CURVE.

C) POSITIONING OF SIGNS AT GORES AND RAMP SEPARATIONS IS REFERRED TO THE NORMAL EDGE OF THE MAINLINE ROADWAY.

4. VERTICAL CLEARANCE

A) OVERHEAD SIGNS SHALL HAVE A MINIMUM VERTICAL CLEARANCE OF 17'-9" FROM ROADWAY TO THE BOTTOM OF LIGHT FIXTURES. ALL LIGHT FIXTURES ARE TO BE AT THE SAME ELEVATION. B) IF THE CONTRACTOR CANNOT OBTAIN 17'-9" (SEE 3A) CLEARANCE, HE IS TO CEASE WORK

AND CONTACT THE PROJECT ENGINEER FOR FURTHER INSTRUCTIONS. THE PROJECT ENGINEER MAY CONTACT THE TRAFFIC ENGINEERING DESIGN DIVISION FOR ASSISTANCE.

PROJECT REQUIREMENTS

ALL NEW SIGNS ON THIS PROJECT SHALL BE FABRICATED FROM SHEETING WHICH MEETS ALL OF THE FOLLOWING REQUIREMENTS, UNLESS OTHERWISE SPECIFIED IN THE CONTRACT DOCUMENTS, OR AS DIRECTED BY THE ENGINEER:

C) ON ALL OVERHEAD SIGNS, THE MINIMUM CLEARANCE TO BOTTOM OF SIGN: 20'-9".

I. SHEETING SHALL MEET THE REQUIREMENTS OF SECTIONS 813 AND 950.03 OF MDSHA'S STANDARD SPECIFICATIONS FOR CONSTRUCTION AND MATERIALS (JULY 2008) AND SUBSEQUENT REVISIONS

2. LISTED ON MDSHA OFFICE OF TRAFFIC AND SAFETY'S QUALIFIED PRODUCTS LIST (QPL)

PROJECT REQUIREMENTS CONT'D

3. THE FOLLOWING TYPES OF SHEETING SHALL BE USED FOR THE SPECIFIED SIGN CLASSIFICATIONS

A) GUIDE. EXIT GORE. AND GENERAL INFORMATION SIGNS- RETROREFLECTIVE SHEETING FOR GUIDE SIGNS, EXIT GORE, AND GENERAL INFORMATION (INCLUDES WHITE ON GREEN, WHITE ON BLUE. WHITE ON BROWN AND THE REVERSE OF THESE COLORS) SHALL MEET OR EXCEED THE REQUIREMENTS FOR ASTM TYPE IX LEGEND ON ASTM TYPE IX BACKGROUND. REGULATORY AND WARNING MESSAGES WITHIN GUIDE SIGNS SHALL BE NON-REFLECTIVE BLACK LEGEND ON BACKGROUND SHEETING WHICH MEETS OR EXCEEDS THE REQUIREMENTS FOR ASTM TYPE IX SHEETING.

B) WARNING SIGNS - RETROREFLECTIVE SHEETING FOR BLACK ON FLUORESCENT YELLOW WARNING SIGNS SHALL BE NON-REFLECTIVE BLACK LEGEND ON BACKGROUND SHEETING WHICH MEETS OR EXCEEDS THE REQUIREMENTS FOR ASTM TYPE IX SHEETING. REGULATORY MESSAGES WITHIN WARNING SIGNS SHALL FOLLOW THE GUIDELINES FOR REGULATORY SIGNS.

C) SCHOOL SIGNS - RETROREFLECTIVE SHEETING FOR SCHOOL SIGNS (BLACK ON FLUORESCENT YELLOW AND BLACK ON FLUORESCENT YELLOW GREEN) SHALL BE NON-REFLECTIVE BLACK LEGEND ON BACKGROUND SHEETING WHICH MEETS OR EXCEEDS THE REQUIREMENTS FOR ASTM TYPE IX SHEETING. REGULATORY MESSAGES WITHIN SCHOOL SIGNS SHALL FOLLOW THE REQUIREMENTS FOR REGULATORY SIGNS.

D) REGULATORY SIGNS - FALL INTO THREE SUBCATEGORIES:

i. "RED" REGULATORY SIGNS (STOP, YIELD, DO NOT ENTER AND WRONG WAY) RETROREFLECTIVE SHEETING FOR THESE SIGNS AND THEIR SUPPLEMENTAL PANELS (INCLUDES WHITE ON RED AND RED ON WHITE) SHALL MEET OR EXCEED THE REQUIREMENTS FOR ASTM TYPE IX SHEETING.

ii. ALL R7 AND R8 SERIES PARKING RELATED SIGNS AND THEIR SUPPLEMENTAL PANELS. NO TRESPASSING SIGNS, AND SIGNS DIRECTED AT PEDESTRIANS AND BICYCLISTS ONLY (INCLUDES RED ON WHITE, GREEN ON WHITE, BLUE ON WHITE, BLACK ON WHITE AND THE REVERSE OF THESE COLORS) SHALL BE ASTM TYPE I LEGEND ON ASTM TYPE I BACKGROUND.

iii. ALL OTHER REGULATORY SIGNS - RETROREFLECTIVE SHEETING FOR THESE SIGNS AND THEIR SUPPLEMENTAL PANELS (INCLUDES BLACK ON WHITE) SHALL BE NON-REFLECTIVE BLACK LEGEND ON ASTM TYPE IV BACKGROUND. WHERE RED IS SPECIFIED, OR WHERE THE COLOR OF THE SIGN IS WHITE ON BLACK, THE LEGEND SHALL BE ASTM TYPE IV RETROREFLECTIVE SHEETING ON NON-REFLECTIVE BLACK BACKGROUND. WARNING MESSAGES WITHIN REGULATORY SIGNS SHALL FOLLOW THE GUIDELINES FOR WARNING

E) ROUTE MARKERS - RETROREFLECTIVE SHEETING FOR ROUTE MARKERS (INCLUDES BLACK ON WHITE, GREEN ON WHITE, WHITE ON GREEN, WHITE ON RED/BLUE) SHALL MEET THE REQUIREMENTS OF GUIDE SIGNS ABOVE WHEN SPECIFIED AS THE LEGEND OF A GUIDE SIGN. RETROREFLECTIVE SHEETING FOR ALL INDEPENDENT ROUTE MARKERS AND THEIR AUXILIARY PANELS SHALL BE ASTM TYPE IV AND/OR NON-REFLECTIVE BLACK LEGEND ON ASTM TYPE IV BACKGROUND.

F) LOGOS AND/OR GRAPHICS - WITHIN SIGNS SHALL FOLLOW THE GUIDELINES FOR THE RESPECTIVE SIGN CLASSIFICATION UNLESS OTHERWISE SPECIFIED IN THE CONTRACT DOCUMENTS, OR AS DIRECTED BY THE ENGINEER.

G) CIVIL DEFENSE SIGNS AND OTHER SIGNS - NOT SPECIFICALLY FALLING INTO ONE OF THE CATEGORIES ABOVE. SHALL FOLLOW THE GUIDELINES FOR THE SIGN CLASSIFICATION THAT MOST CLOSELY MATCHES THE COLOR(S) OF THE PROPOSED SIGN.

4. THE FOLLOWING MINIMUM THICKNESS SHALL BE USED FOR THE APPROPRIATE WIDTH OF SHEET ALUMINUM BLANKS.

LONGEST DIMENSION MINIMUM THICKNESS UP TO 12".... ..0.040" GREATER THAN 12" TO 24"... ..0.063" GREATER THAN 24" TO 36"... ...0.80.0. GREATER THAN 36" TO 48".... ..0.100" OVFR 48" ..0.125"

SHA TRACKING NO. 21-AP-MO-003-21

OFFICE OF TRAFFIC & SAFETY TRAFFIC ENGINEERING DESIGN DIVISION MARYLAND DEPARTMENT OF TRANSPORTATION

MD 355 (ROCKVILLE PIKE) AND MD 187 (OLD GEORGETOWN RD)


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GENERAL NOTES AND PROPOSALS APPROVALS **REVISIONS** SCALE ADVERTISED DATE CONTRACT NO. COUNTY DESIGNED BY MONTGOMERY

STATE HIGHWAY

ADMINISTRATION

EAM LEADER DRAWN BY LOGMILE 15035506.356 SST. DIV. CHIEF TIMS NO. CHECKED BY MDE/PRD TOD NO. DIVISION CHIEF SN-1 1 of 1 SHEET NO. 20 OF 28 DRAWING NO. OFFICE DIRECTOR

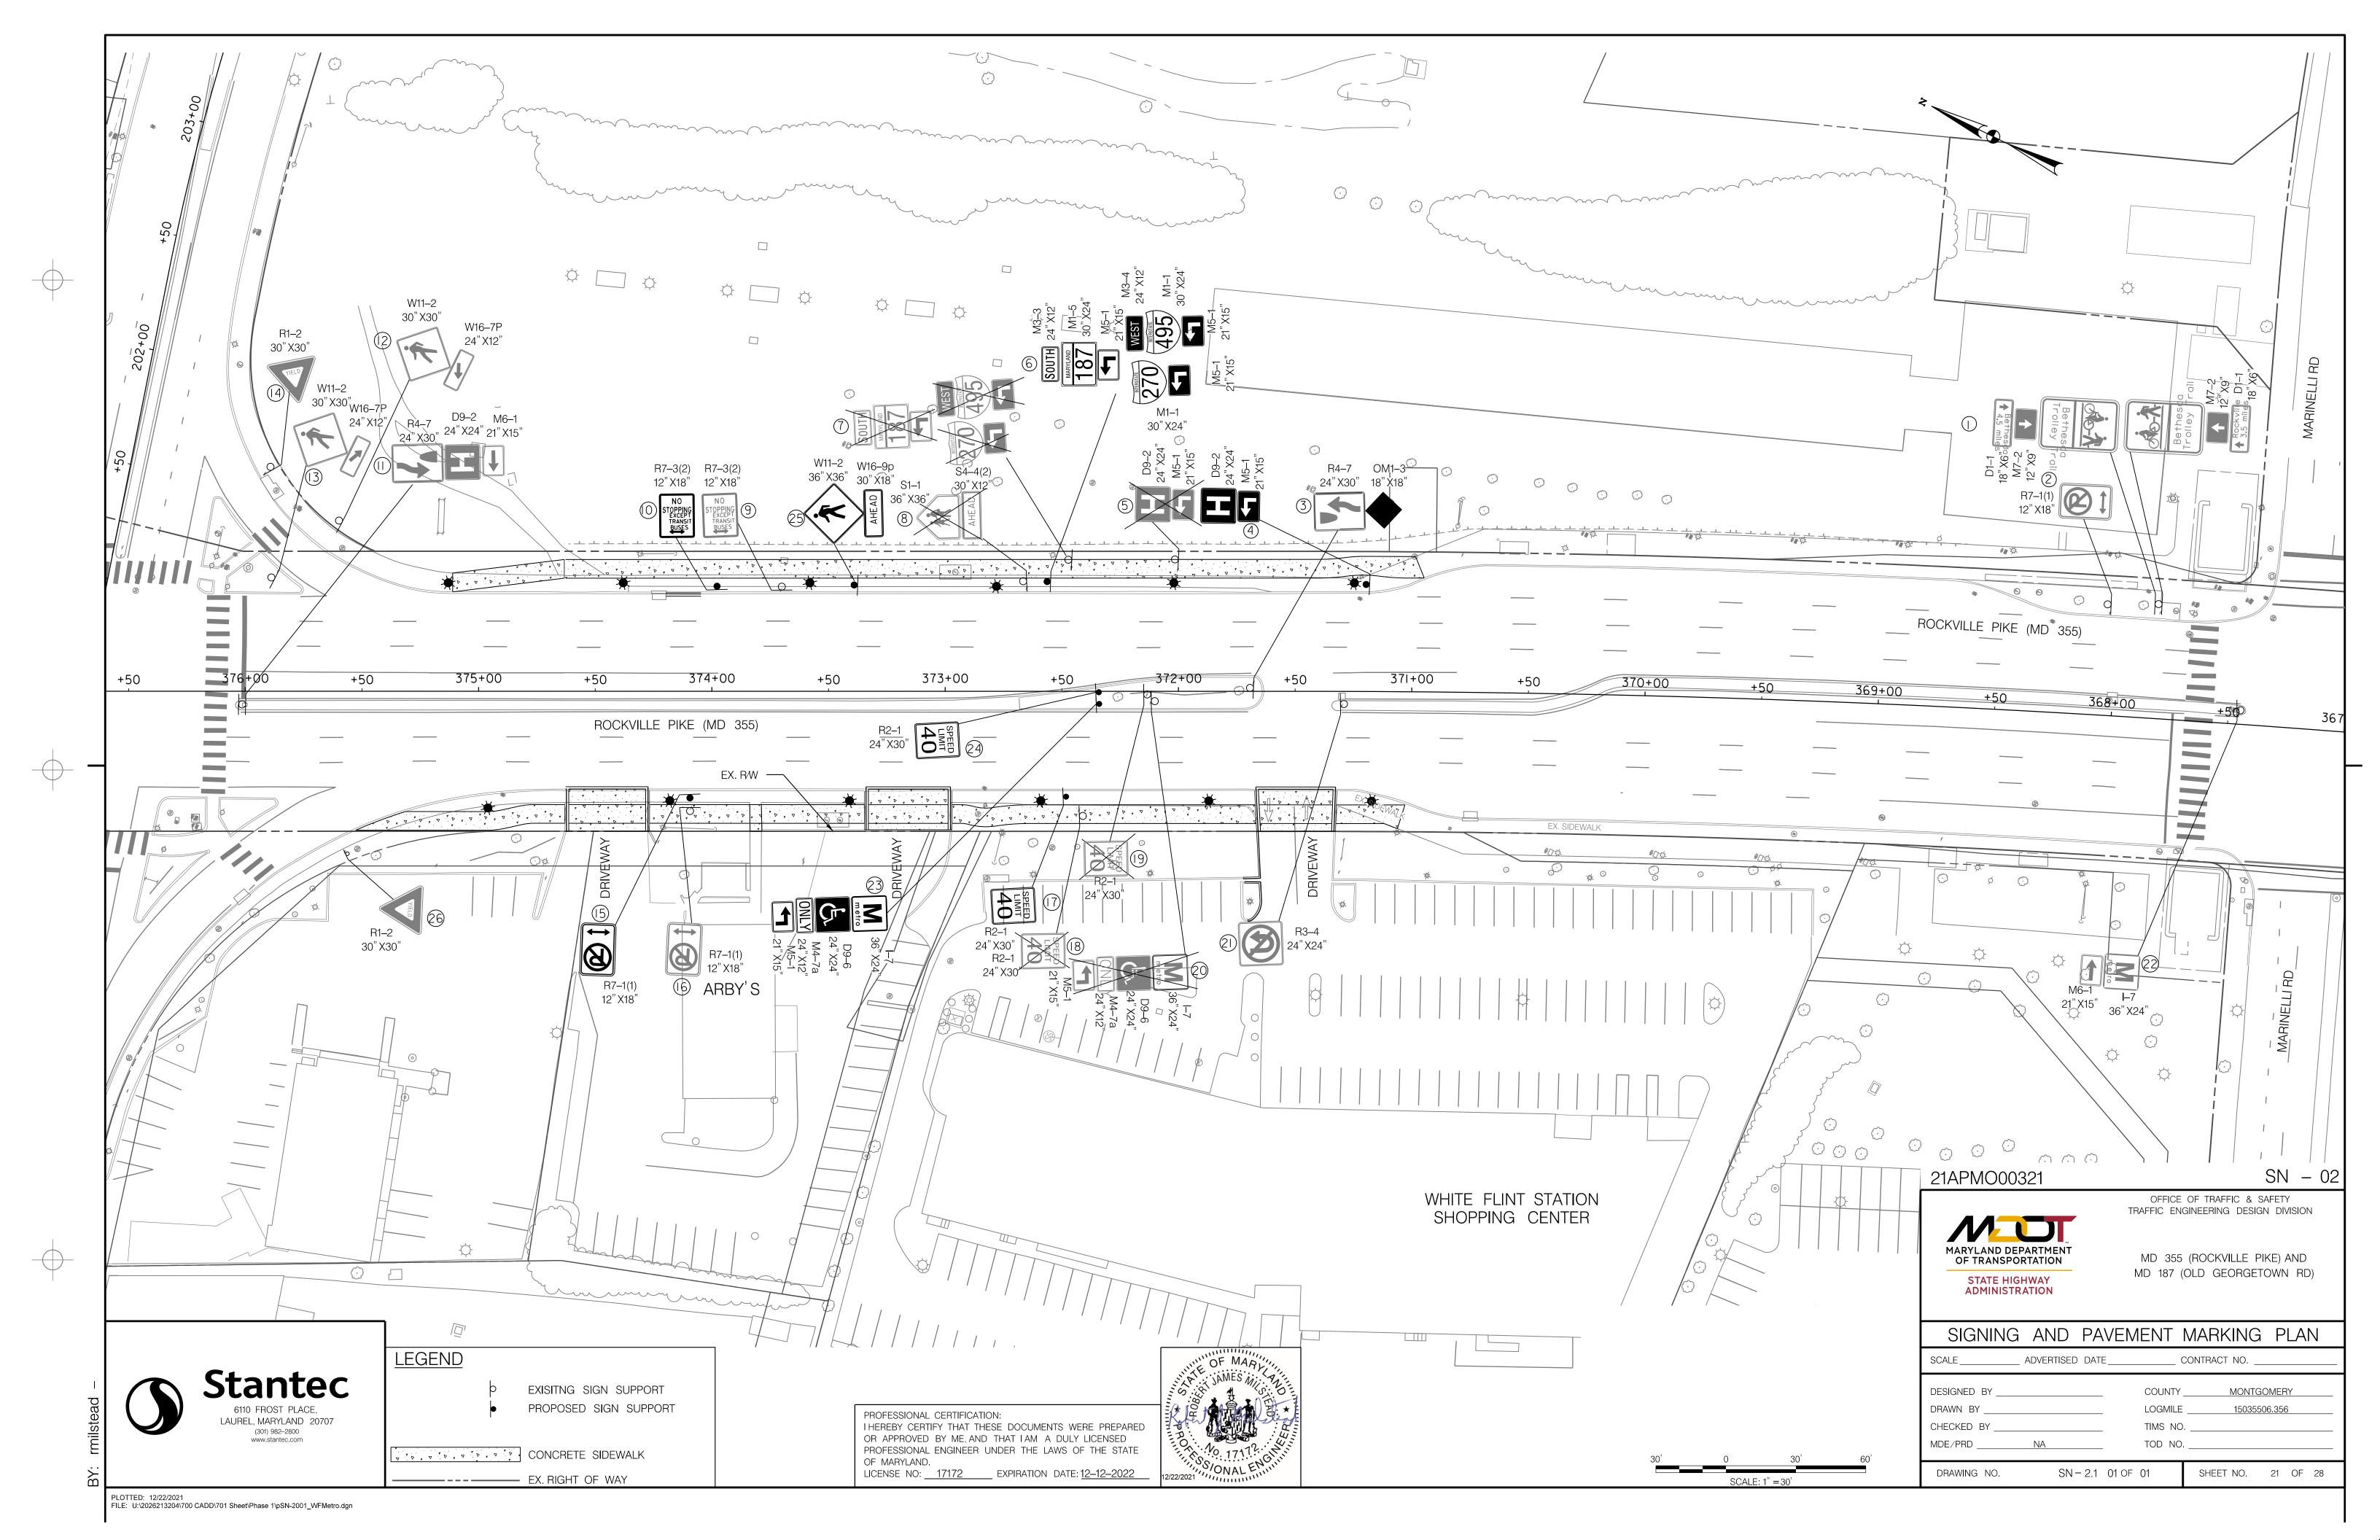

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MD 187 (OLD GEORGETOWN RD)

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FESSIONAL ENGINEER UNDER THE LAWS OF THE STATE MARYLAND.	17172 No. 17172 CK		MDE/PRD	NA	TOD NO.	
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I- PERFORATED TUBULAR STEEL POST

SHEET NO.

SN-02

R7-I(I) (I2"XI8")

R4-7 (24"X30")

R7-3(2) (12"X18")

R7-3(2) (I2"XI8")

RI-2 (30"X30")

R7-I(I) (I2"XI8")

R7-I(I) (I2"XI8")

R2-I (24"X30")

R2-I (24"X30")

R2-I (24"X30")

R3-4 (24"X24")

R2-I (24"X30")

RI-2 (30"X30")

TOTAL

I-7 (36"X24"), M6-I (21"XI5")

WII-2 (36"X36"), WI6-9p (30"XI8")

D9-2 (24"X24"), M5-I (21"XI5")

D9-2 (24"X24"), M5-I (21"XI5")

SI-I (36"X36"), S4-4(2) (30"XI2")

WII-2 (30"×30"), WI6-7P (24"XI2")

WII-2 (30"×30"), WI6-7P (24"XI2")

D9-2 (24"X24"), M6-I (21"XI5"), R4-7 (24"X30")

I-7 (36"×24"), D9-6 (24"X24"),M4-7a (24"XI2"), M5-I (2I"XI5")

I-7 (36"×24"), D9-6 (24"X24"), M4-7a (24"XI2"), M5-I (21"XI5")


REMARKS

M3-3 (24"X12"), MI-5 (30"X24"), M5-I (21"X15"), M3-4 (24"X12"), MI-I (30"X24"), M5-I (21"X15"), MI-I (30"X24"), M5-I (21"X15") | IBREAKWAY- 6" X8" WOOD POST | 25.6

Bethesda Trolley Trail (18"X24"), M7-2 (12"X9"), DI-I (18"X6"), Bethesda Trolley Trail (18"X24"), M7-2 (12"X9"), DI-I (18"X6")

M3-3 (24"X12"), MI-5 (30"X24"), M5-I (21"XI5"), M3-4 (24"XI2"), MI-I (30"X24"), M5-I (21"XI5"), MI-I (30"X24"), M5-I (21"XI5")

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1. CONTRACTOR SHALL VERIFY ALL EXISTING UNDERGROUND UTILITIES PRIOR TO CONSTRUCTION.

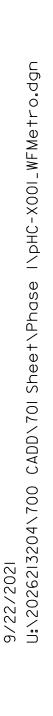THERE ARE SHALLOW STORM DRAIN PIPES WITHIN THE PROJECT LIMITS.

PROFESSIONAL CERTIFICATION:
I HEREBY CERTIFY THAT THESE DOCUMENTS WERE PREPARED
OR APPROVED BY ME, AND THAT I AM A DULY LICENSED
PROFESSIONAL ENGINEER UNDER THE LAWS OF THE STATE OF MARYLAND.

EX. 18" STORM

EX. 18" STORM

370+75.0000

B CONSTRUCTION MD 355

EX. 15" STORM

B CONSTRUCTION MD 355

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371+25.0000

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RECOMMENDED FOR APPROVAL Design Section Division of Transportation Engineering

ROADWAY CROSS SECTIONS

WHITE FLINT STATION
PEDESTRIAN ACCESS IMPROVEMENTS

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DATE: SEPT 2021 SCALE : 1'' = 10'

LICENSE NO: 28255 EXPIRATION DATE: 6-30-2022

ned by :_____ Drawn by :____ Checked by : _

MONTGOMERY COUNTY DEPARTMENT OF TRANSPORTATION DIVISION OF TRANSPORTATION ENGINEERING GAITHERSBURG, MARYLAND

Project No. : 502106

SHA TRACKING NO. 21-AP-MO-003-21

SHEET 23 of 28

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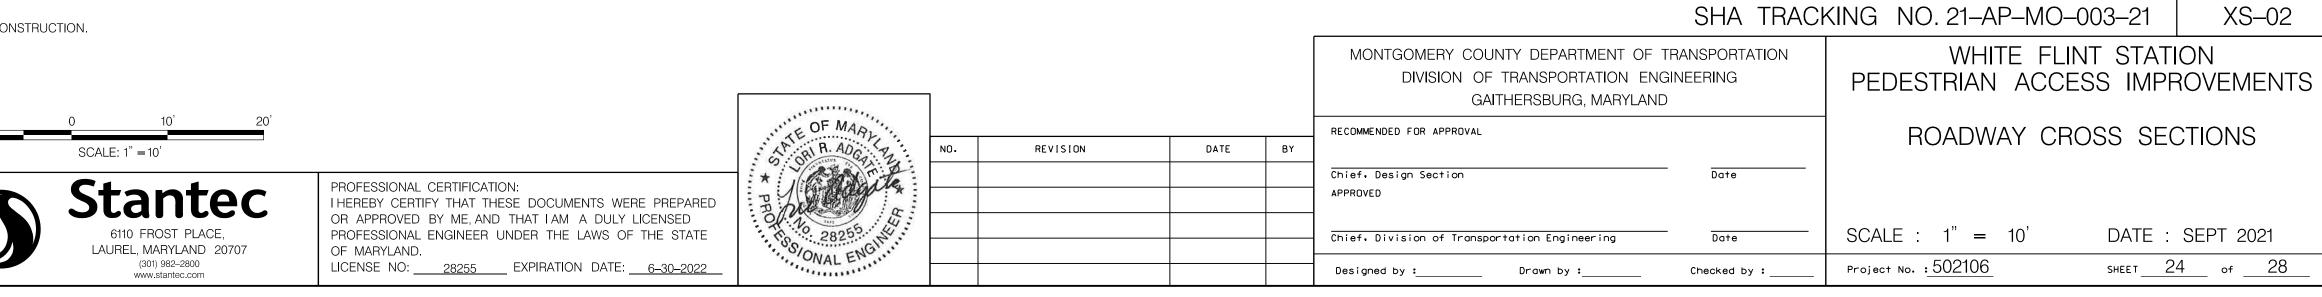
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B CONSTRUCTION MD 355

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B CONSTRUCTION MD 355

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EX. 21" STORM

EX. 21" STORM

EX. 21" | STORM

1. CONTRACTOR SHALL VERIFY ALL EXISTING UNDERGROUND UTILITIES PRIOR TO CONSTRUCTION. THERE ARE SHALLOW STORM DRAIN PIPES WITHIN THE PROJECT LIMITS.

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EX.18" STORM

EX. 18" STORM

EX. 18" STORM

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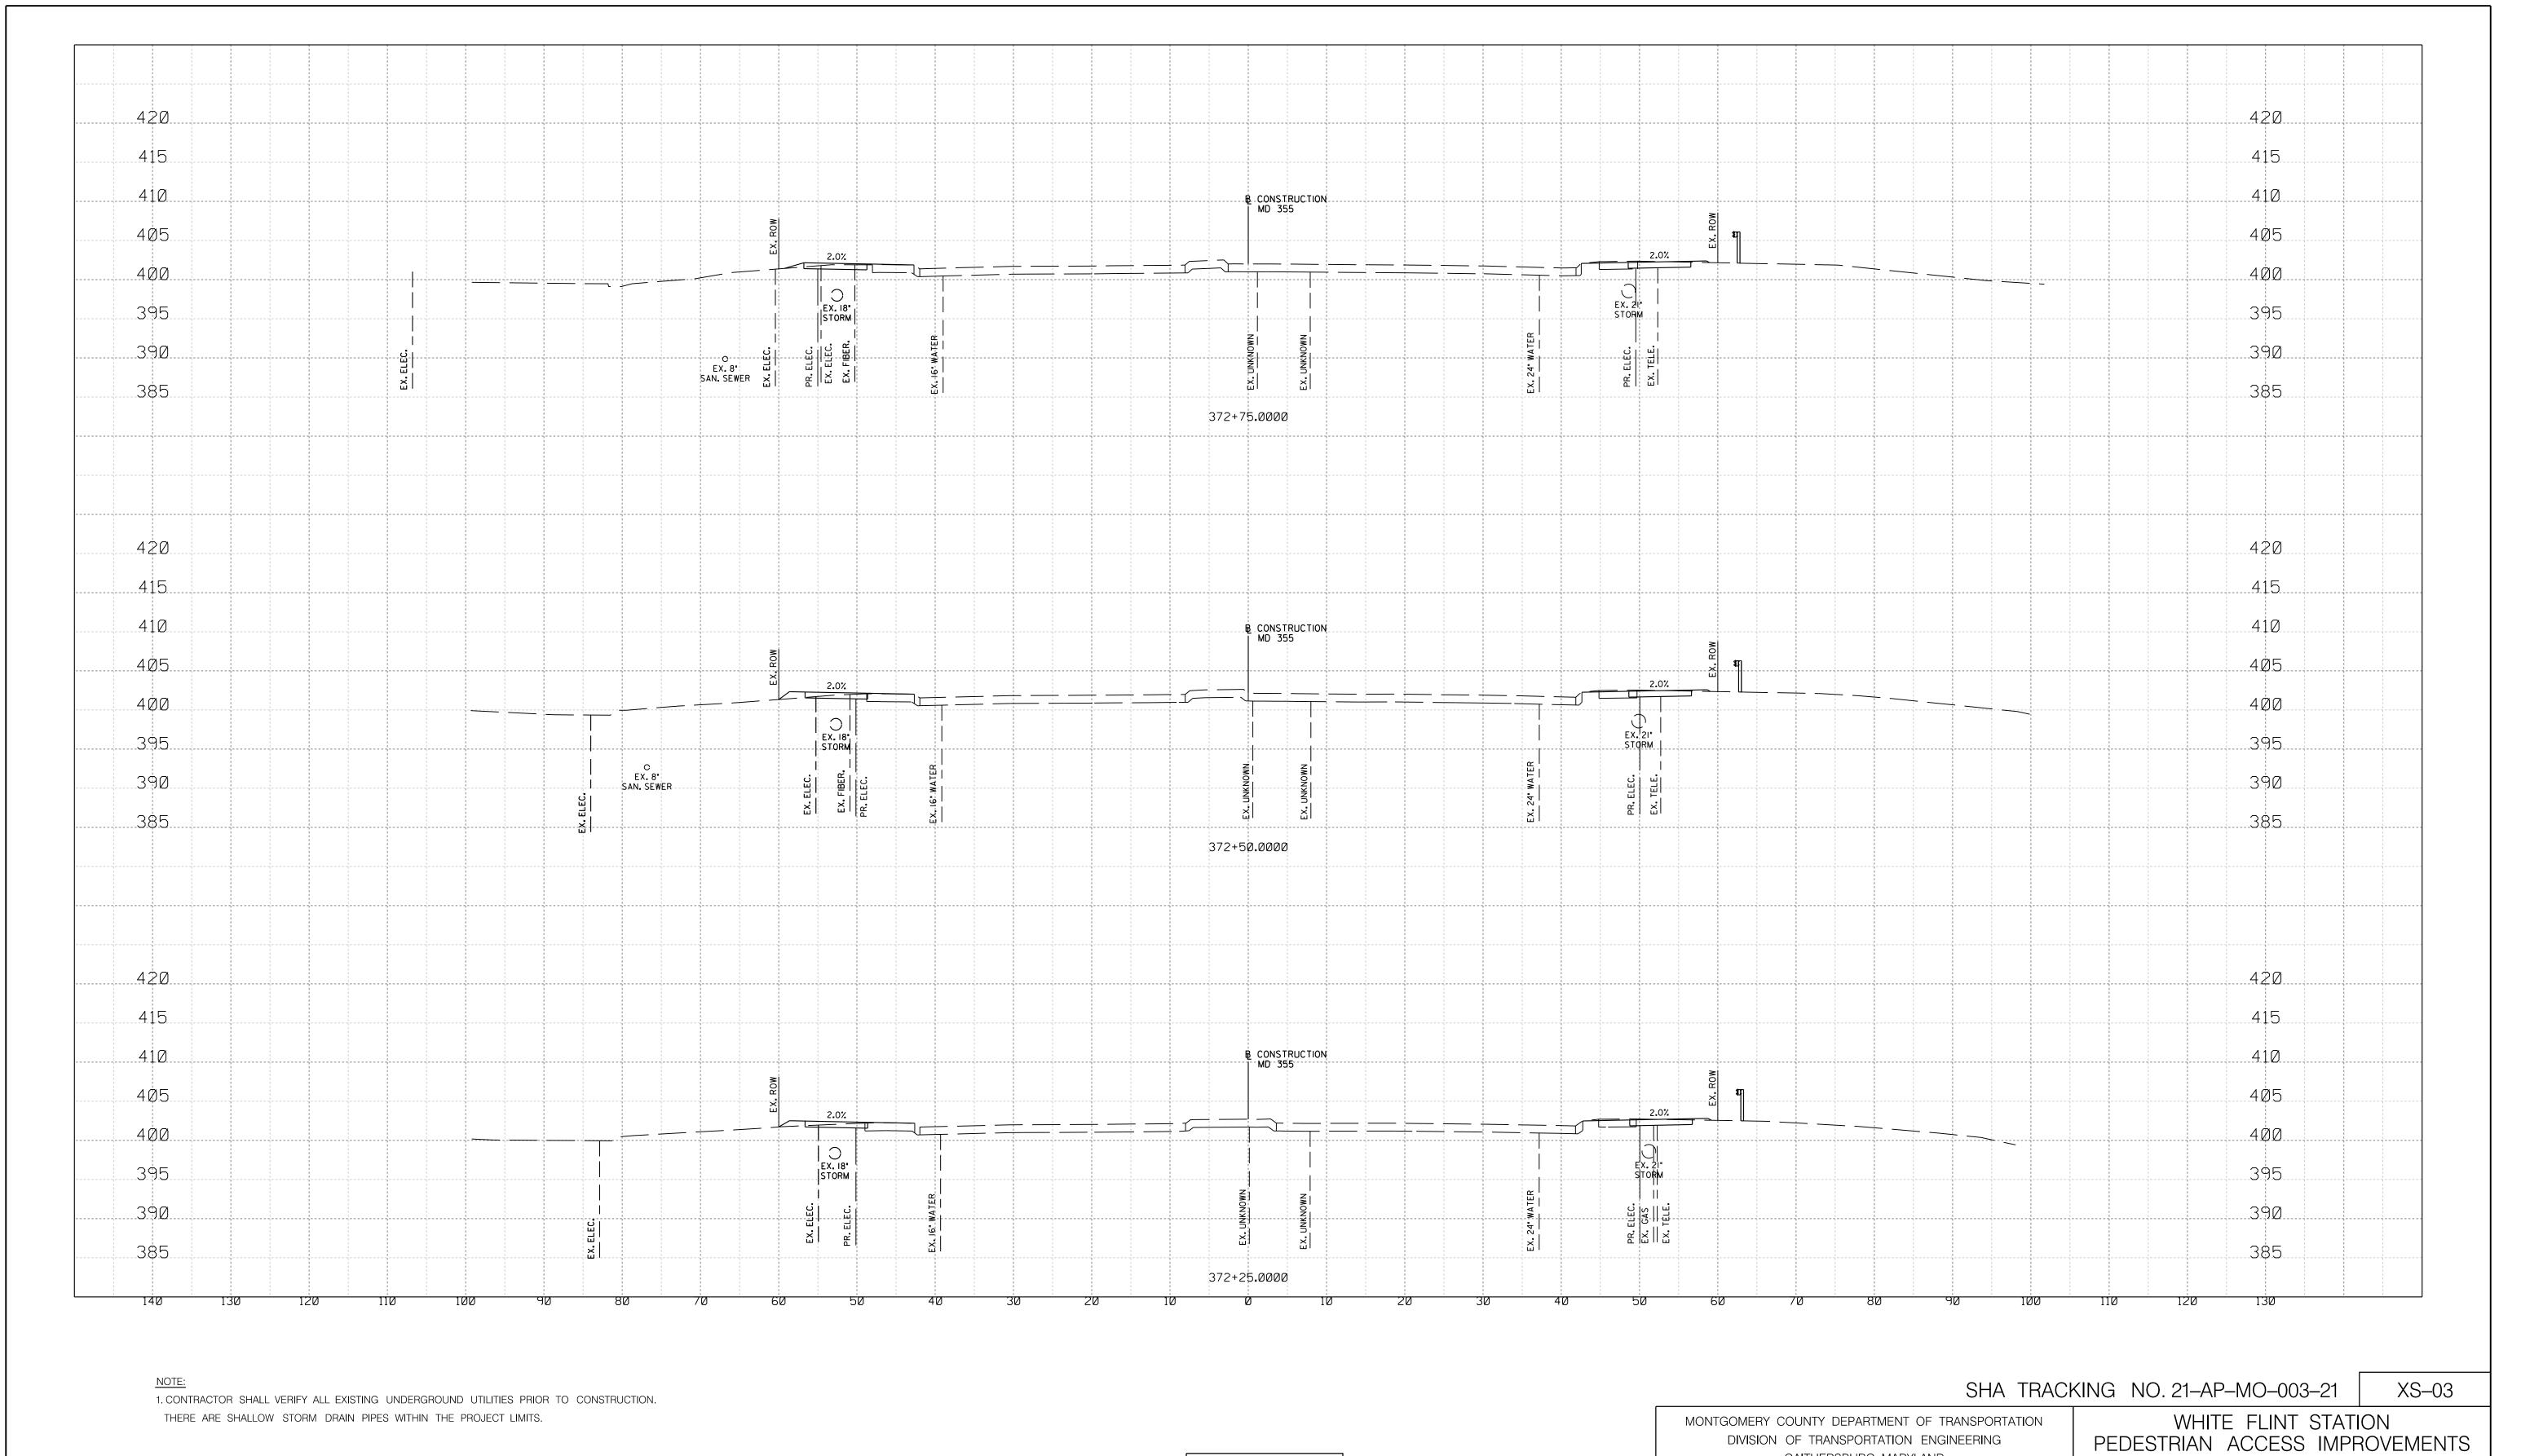
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DATE: SEPT 2021

SHEET 24 of 28



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PROFESSIONAL CERTIFICATION:
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PROFESSIONAL ENGINEER UNDER THE LAWS OF THE STATE OF MARYLAND.

DATE BY REVISION Chief, Design Section APPROVED Chief, Division of Transportation Engineering Designed by :_____

Checked by : _

DIVISION OF TRANSPORTATION ENGINEERING GAITHERSBURG, MARYLAND

Drawn by :____

RECOMMENDED FOR APPROVAL

ROADWAY CROSS SECTIONS

SCALE : 1'' = 10'

DATE: SEPT 2021 SHEET <u>25</u> of <u>28</u> Project No. : 502106

LICENSE NO: 28255 EXPIRATION DATE: 6-30-2022



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EX.8" SAN. SEWER

O EX. 18" STORM

1. CONTRACTOR SHALL VERIFY ALL EXISTING UNDERGROUND UTILITIES PRIOR TO CONSTRUCTION.

THERE ARE SHALLOW STORM DRAIN PIPES WITHIN THE PROJECT LIMITS.

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PROFESSIONAL ENGINEER UNDER THE LAWS OF THE STATE OF MARYLAND. LICENSE NO: 28255 EXPIRATION DATE: 6-30-2022

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EX. 21" STORM

GAITHERSBURG, MARYLAND MMENDED FOR APPROVAL • Design Section • Division of Transportation Engineering

MONTGOMERY COUNTY DEPARTMENT OF TRANSPORTATION DIVISION OF TRANSPORTATION ENGINEERING

ROADWAY CROSS SECTIONS

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WHITE FLINT STATION
PEDESTRIAN ACCESS IMPROVEMENTS

XS-04

DATE: SEPT 2021 SCALE : 1'' = 10'

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SHEET 26 of 28

Project No. : 502106

SHA TRACKING NO. 21-AP-MO-003-21



1. CONTRACTOR SHALL VERIFY ALL EXISTING UNDERGROUND UTILITIES PRIOR TO CONSTRUCTION.

THERE ARE SHALLOW STORM DRAIN PIPES WITHIN THE PROJECT LIMITS.

PROFESSIONAL CERTIFICATION:
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MONTGOMERY COUNTY DEPARTMENT OF TRANSPORTATION

DIVISION OF TRANSPORTATION ENGINEERING

ROADWAY CROSS SECTIONS

WHITE FLINT STATION

XS-05

DATE: SEPT 2021

SHEET 27 of 28

SCALE: 1'' = 10'Project No. : 502106 gned by :_____ Drawn by :____ Checked by : _

SHA TRACKING NO. 21-AP-MO-003-21

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1. CONTRACTOR SHALL VERIFY ALL EXISTING UNDERGROUND UTILITIES PRIOR TO CONSTRUCTION.

THERE ARE SHALLOW STORM DRAIN PIPES WITHIN THE PROJECT LIMITS.

6110 FROST PLACE, LAUREL, MARYLAND 20707

C EX. 8" SAN. SEWER

PROFESSIONAL CERTIFICATION:
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PROFESSIONAL ENGINEER UNDER THE LAWS OF THE STATE OF MARYLAND. LICENSE NO: 28255 EXPIRATION DATE: 6-30-2022

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EX. 18"

EX. 18" STORM

GAITHERSBURG, MARYLAND MENDED FOR APPROVAL Design Section Division of Transportation Engineering

MONTGOMERY COUNTY DEPARTMENT OF TRANSPORTATION DIVISION OF TRANSPORTATION ENGINEERING

WHITE FLINT STATION
PEDESTRIAN ACCESS IMPROVEMENTS

XS-06

ROADWAY CROSS SECTIONS

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SHA TRACKING NO. 21-AP-MO-003-21

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ned by :_____ Drawn by :____

Checked by : _

DATE: SEPT 2021 SCALE : 1'' = 10'Project No. : 502106 SHEET 28 of 28

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